CONSTRUCTION PLANS DOGWOOD FARMS III MARSHALL COUNTY, ALABAMA JANUARY 2025

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PROPERTY DEVELOPER
BRADCO HOME BUILDERS, L.L.C.
RANDALL PANKEY
P.O. BOX 853
BOAZ, ALABAMA 35957






CANYON ENGINEERING, LLC 404 1ST STREET EAST FORT PAYNE, ALABAMA 35967

TELEPHONE: 256.558.0773 EMAIL: chuck@canyonengineeringllc.com

PROJ. NO.: 242401

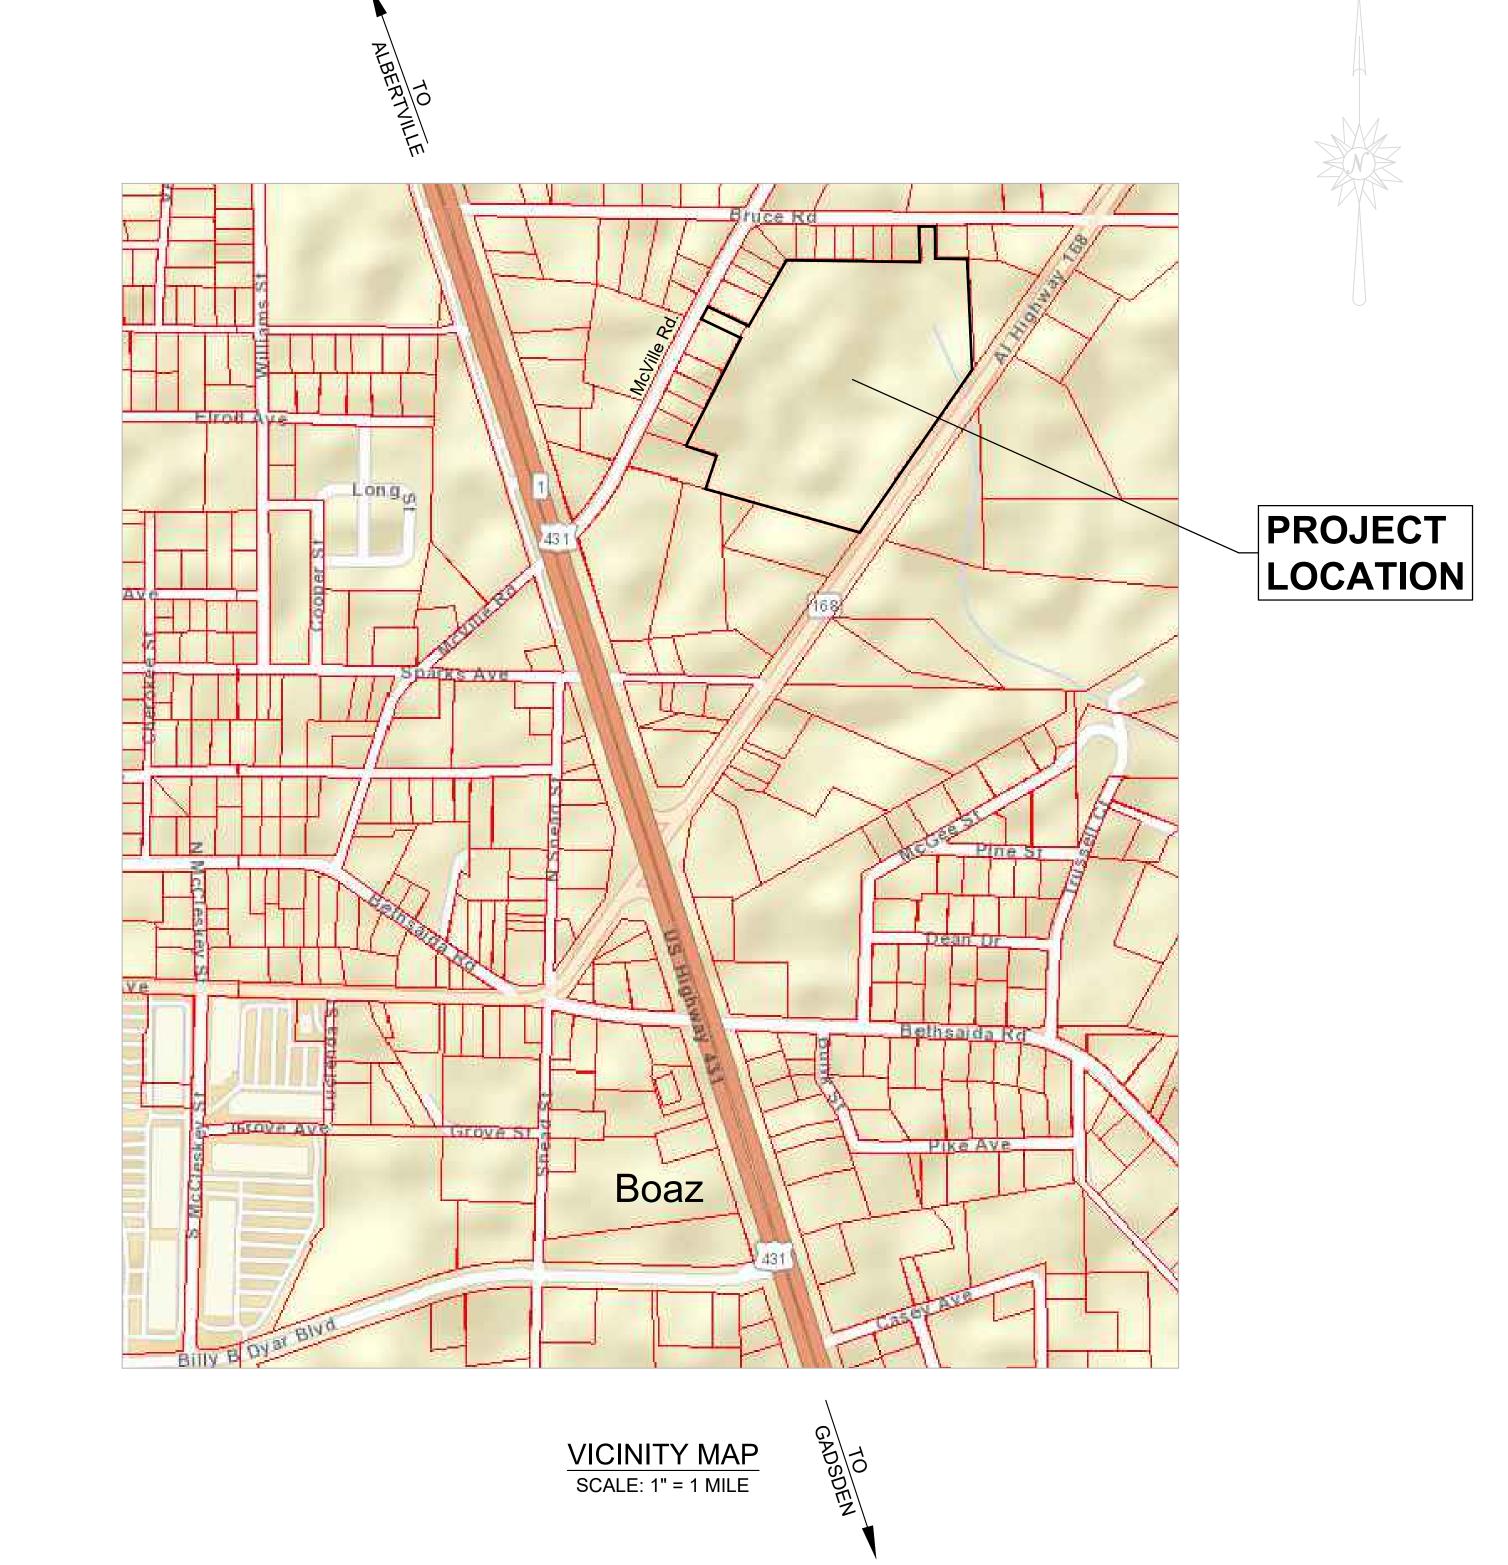



CONSTR DOGW

SCALE: NOTED

DATE:

JANUARY 2025 PROJ. NO.:

232301

DRAWN BY: CWJ

SHEET TITLE:

VICINITY

MAP/

LEGEND

SHEET NO.:


GENERAL NOTES

- 1. The Contractor shall document the pre-construction conditions of the site prior to starting any type of construction activities. One copy of the documentation shall be delivered to the Engineer and the Owner within 7 days of the start of construction.
- 2. The Contractor is responsible for all damages caused by his construction activities, including damages by sub-contractors and material suppliers. Damages shall be repaired at the Contractor's expense and to the satisfaction of the Engineer, Owner and Property Owner, if different from the Owner.
- 3. The Contractor shall purchase all licenses and permits as required by the city and/or county in which the work is taking place.
- 4. The Contractor is responsible for coordinating all construction activities, including work by sub-contractors, suppliers, state and local inspections, etc.
- The Contractor shall take all measures necessary to not disturb property corners, bench marks, right-of-way markers, and control points. The cost of re-establishing any of these markers shall be the responsibility of the Contractor.
- 6. The Contractor shall be responsible for providing and maintaining all necessary traffic control measures in accordance with Part 6 of the latest edition of the Manual of Uniform Traffic Control Devices.
- 7. The Contractor shall maintain access along all city, county and state roads at all times. In the event a temporary road closure is required, the Contractor shall coordinate with the Engineer, Owner, police departments with jurisdiction in the project area and emergency management agencies.
- 8. The Contractor shall not cut, block or damage any driveway unless approved by the Engineer. Driveways shall be accessible for the property owner to the greatest extent possible and no driveway shall be blocked overnight.
- 9. All driveways that are required to be open cut shall be saw-cut, backfilled with crushed stone, and replaced with like material.
- 10. Residents in the project area shall have uninterrupted mail service during all construction activities. Any mailbox damaged or temporarily moved shall be repaired or returned to the original location before the end of the day.
- 11. Unless otherwise noted, the extent and amount of underground rock within the project site has not been determined by the Owner and no rock clause has been included in the unit prices. Potential bidders may make their own investigation as to the extent of possible rock to be encountered.

- 12. The Contractor shall notify all impacted customers as well as the Owner and the Engineer of any disruption in utility services at least 3 days prior to the disruption. No customer shall be left without any utility service overnight.
- 13. The Contractor shall call 811 to request utility locations at least 5 days prior to the start of construction.
- 14. All existing utility locations have been derived from existing records and from location markings by Alabama One Call. The Owner and the Engineer do not guarantee the accuracy of the utility locations or that all utilities have been
- 15. The Contractor shall coordinate all excavations near existing utilities with the respective utility.
- 16. All ductile iron pipe shall be pressure Class 350 unless otherwise noted.
- 17. All pressure PVC pipe shall be Class 200 unless otherwise noted.
- 18. All underground pressure connections and pipe direction changes shall utilize mechanical joint restraint connections and concrete thrust blocks.

PROJECT SPECIFIC NOTES

- 19. An ADEM construction stormwater permit is required for this project, and the permit has been issued to the owner.
- 20. The Contractor shall install and maintain all erosion control measures for the duration of the construction phase. All control measures shall be checked and repaired as necessary to ensure that no sediment leaves the site.
- 21. Any pipe, ditch, creek, or water body that has an accumulation of sediment shall be immediately cleaned and the sediment disposed of off-site.
- 22. The Contractor is responsible for the cost associated with any fines or damages caused by the failure of any erosion control device or the discharge of sediments.
- 23. The erosion control measures shown on the plans are intended to prevent the loss of sediment from the site during construction. Additional measures may be required of the Contractor as the site conditions change.

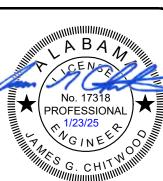



ALABAM

CONSTRUCTION PLANS
DOGWOOD FARMS III

SCALE: NA

JANUARY 2025

DATE:

PROJ. NO.:

DRAWN BY:

232301

CWJ

SHEET TITLE:

PROJECT

NOTES

SHEET NO.:

C-002

CANYON

LEGEND

8" HDPE INV. ELEV. = 1089.85'

8" HDPE

GRATE INLET

—TOP ELEV. = 1091.11'

SANITARY SEWER MANHOLE

(SOUTH) 8" CLAY INV. ELEV. = 1087.22'

(NORTH) 8" CLAY INV. ELEV. = 1087.04'

TOP ELEV. = 1092.54'

DOGWOOD FARMS III

T.B.M. (MAG NAIL) NORTHING = 1348646.57_

11491 ALABAMA HIGHWAY 168 BOAZ, AL. 35957 D.B. 6403 PG. 256

NOTES

INV. ELEV. = 1082.05'

BEING A REDIVISION OF PART OF TRACTS 5 AND 6 OF J.A. KILPATRICK LANDS AS RECORDED IN PLAT BOOK 2, PAGE 180, PROBATE OFFICE OF MARSHALL COUNTY ALABAMA. SECTION 31, TOWNSHIP 9 SOUTH, RANGE 5 EAST

STORMWATER COVENANT:

FACILITIES IS THE RESPONSIBILITY OF THE PROPERTY OWNERS WITHIN THE SUBDIVISION AND IS NOT THE RESPONSIBILITY OF THE CITY OF BOAZ.

	LINE DATA
LINE	BEARING & DISTANCE
L1	S89°23'40"E 63.35'
L2	N26°41'34"E 79.29'
L3	N26°41'25"E 80.00'
L4	N26°41'25"E 80.00'
L5	N26°41'25"E 82.77'
L6	N26°41'25"E 141.59'
L7	N26°41'25"E 62.02'
L8	S65°42'10"E 9.78'
L9	N29°38'40"E 114.92'
L10	N29°25'45"E 56.69'
L11	N29°25'45"E 70.00'
L12	N29°25'45"E 45.44'
L13	S89°23'40"E 38.14'
L14	S89°23'40"E 74.00'
L15	S89°23'40"E 74.00'
L16	S89°23'40"E 36.03'
L17	S89°23'40"E 37.97'
L18	S89°23'40"E 74.00'
L19	S89°23'40"E 74.00'
L20	S89°23'40"E 110.03'
L21	N65°44'33"W 110.90'
L22	S65°44'33"E 34.02'
L23	S65°44'33"E 117.45'
L24	S66°17'42"E 32.55'

	CURVE DATA						
CURVE	LENGTH	RADIUS	CHORD				
C1	18.69'	25.00'	N87°09'33"W 18.26'				
C2	47.58'	50.00'	N81°18'51"W 45.81'				
C3	64.37'	50.00'	N17°10'11"W 60.02'				
C4	50.00'	50.00'	N48°21'39"E 47.94'				
C5	69.89'	50.00'	S62°57'01"E 64.33'				
C6	18.69'	25.00'	S44°19'32"E 18.26'				
			·				





FOR

PRELIMINARY


***************************************	No. 31826 PROFESSIONAL LAND RVEYO	Anna Miller
CALE:		1" = 60'

"Minin					
SCALE:	1" = 60'				
DATE:	01/08/2025				
FIELD INFO: AT	A MDM 07-19-2023				
DRAWN BY:	BLA JNH				
CHECKED BY:					
QUALITY CHECK:					
APPROVED BY:					
REV	ISED:				
DWG:					
PROJECT NO.:	21-63				
SHEET NO.:	1 OF 1				









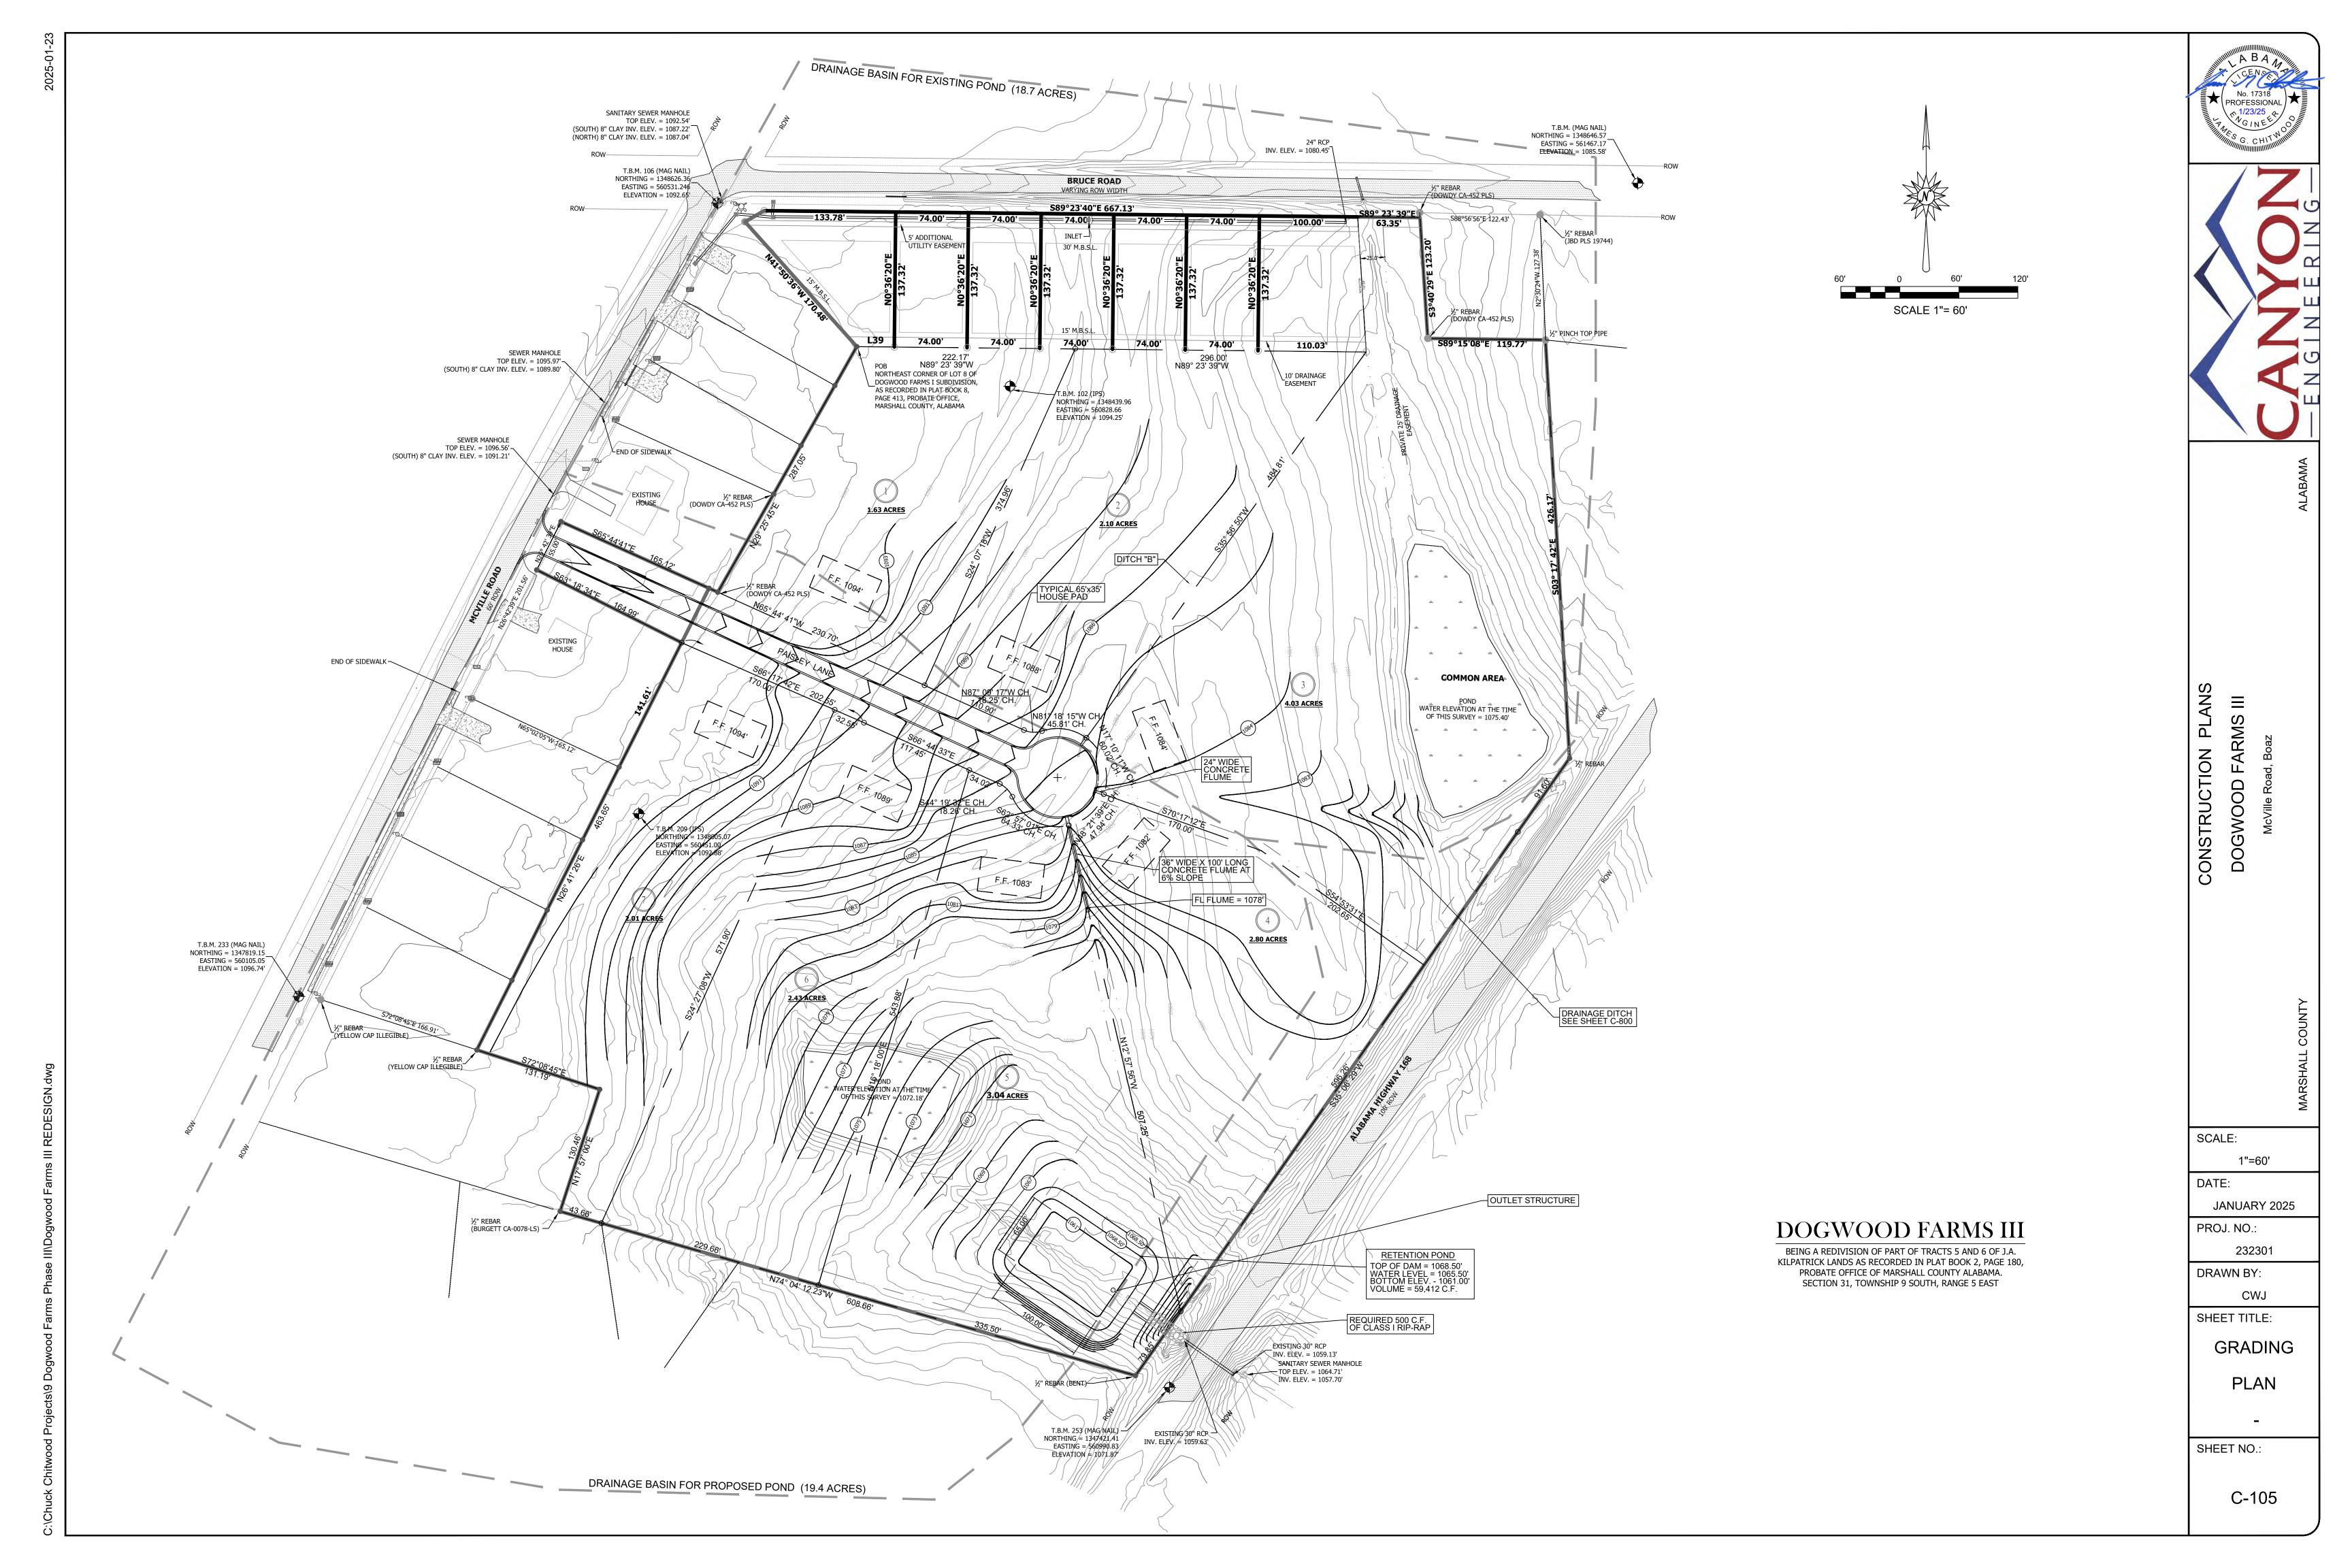



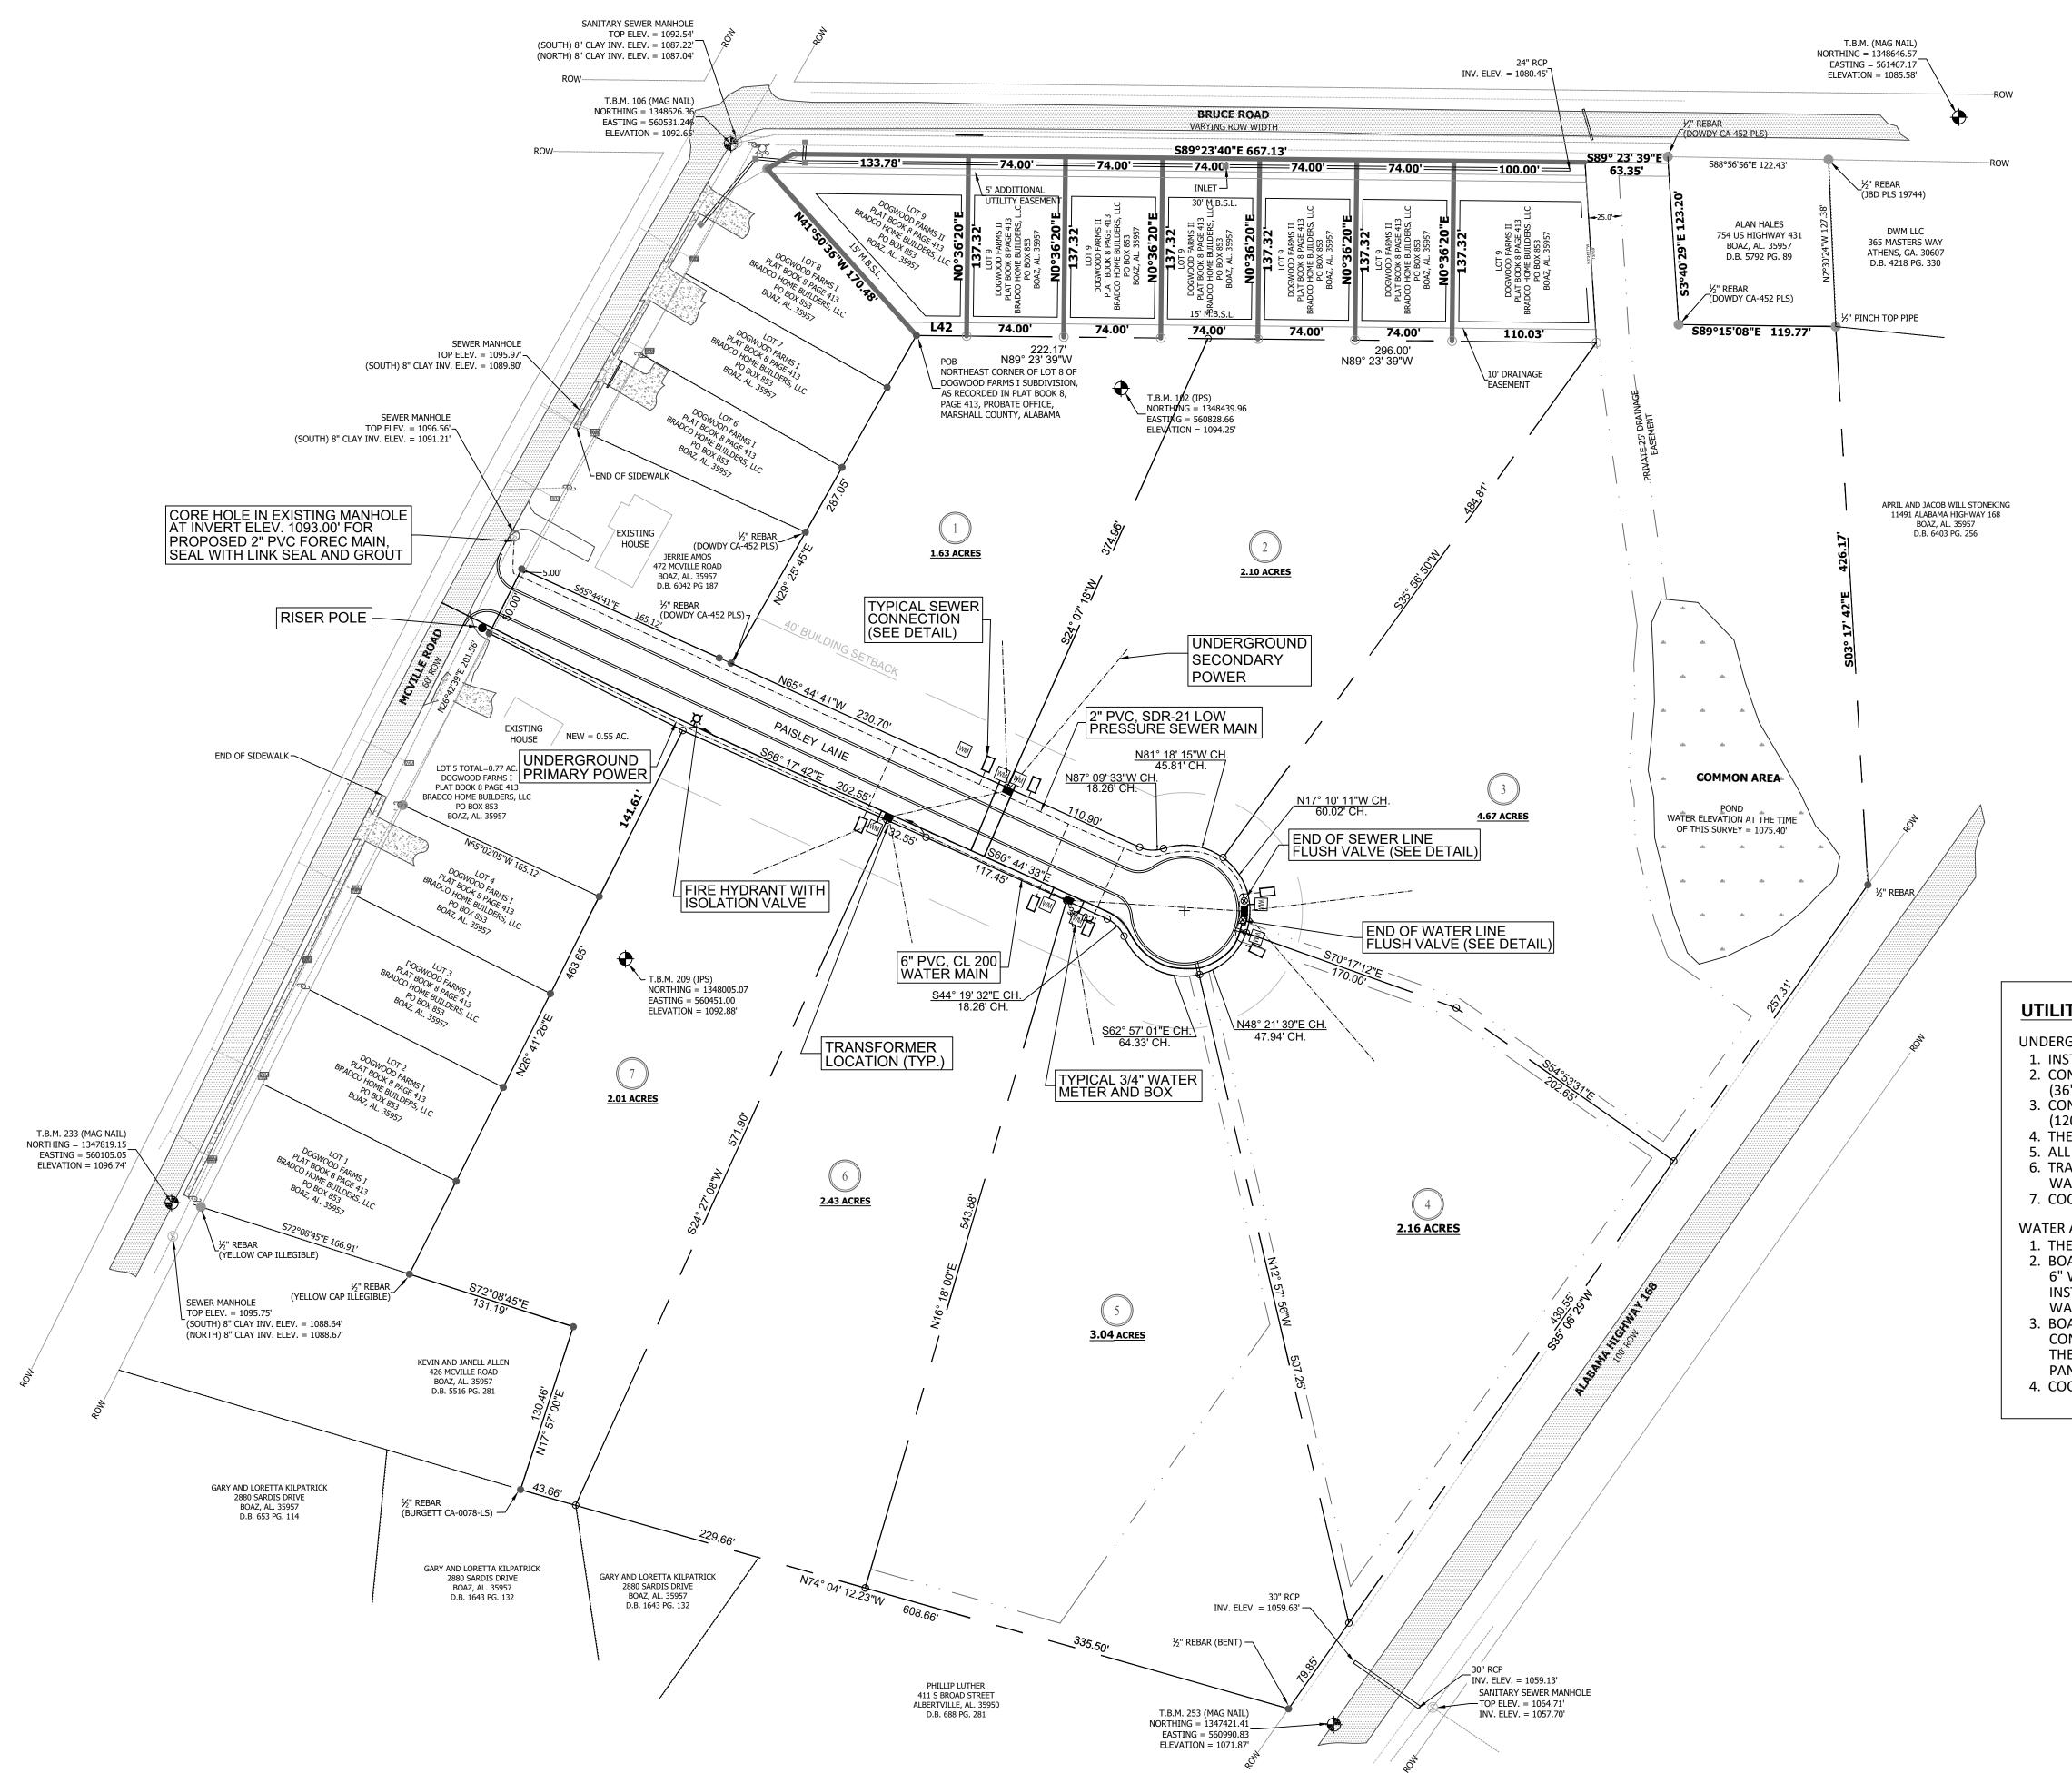

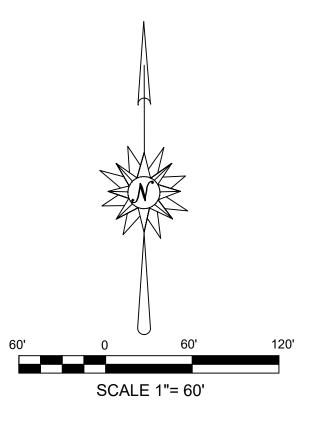

<u>LEGEND</u>

IRON PIN W/PLASTIC CAP (SET THIS SURVEY)	\circ
EXISTING MOUMENTS FOUND	
POINTS NOT RECOVERED OR MARKED	\triangle
PROPERTY LINE	
RIGHT-OF-WAY · · · · ·	R.O.W.
POWER POLE	O
POINT OF BEGINNING	P.O.B.


UTILITY NOTES:

UNDERGROUND POWER

- INSTALL UNDERGROUND POWER ON THE BACK 3' OF THE SOUTH RIGHT-OF-WAY LINE.
 CONTRACTOR TO INSTALL 3", SCH. 40 PVC CONDUIT WITH LONG SWEEPING ELBOWS
- (36" RADIUS) FOR THE PRIMARY SERVICE (7.2 kV).
- 3. CONTRACTOR TO INSTALL 2-1/2" SCH. 40 PVC CONDUIT FOR THE SECONDARY SERVICE (120/240V, 200 AMP.)
- 4. THE MAXIMUM DISTANCE FROM THE TRANSFORMER TO THE METER SHALL BE 200'.
 5. ALL TRANSFORMERS SHALL BE SET ON THE RIGHT-OF-WAY, WHERE SHOWN ON THIS PLAN.
- 6. TRANSFORMER BASES SHALL BE THE SINGLE PHASE BOX PAD BY NORDIC FIBERGLASS OF
- 7. COORDINATE ALL WORK WITH MARSHALL-DEKALB ELECTRIC COOPERATIVE (256) 593-4262.

WATER AND SEWER

- THE WATER MAIN SHALL BE LOCATED 5' FROM THE UNDERGROUND POWER.
 BOAZ WATER SHALL TAP THE EXISTING WATER MAIN AND CROSS McVILLE ROAD WITH A
- 6" WATER MAIN. CONTRACTOR SHALL CONNECT TO THE 6" MAIN AND CONTINUE INSTALLATION OF THE NEW WATER MAIN, FIRE HYDRANT, FLUSH VALVE, AND SET THE WATER SERVICE.
- 3. BOAZ SEWER SHALL CORE THE EXISTING MANHOLE AND STUB OUT THE 2" FORCE MAIN. CONTRACTOR SHALL CONNECT TO THE 2" STUB AND CONTINUE THE 2" FORCE MAIN, SET THE SERWER SERVICES, FLUSH VALVES, AND SET THE GRINDER PUMPS WITH CONTROL
- 4. COORDINATE ALL WORK WITH THE BOAZ WATER AND SEWER BOARD (256) 593-4711.

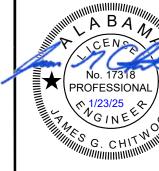



ALABAMA

CONSTRUCTION PLANS
DOGWOOD FARMS III

SCALE: 1"=60' DATE:

JANUARY 2025 PROJ. NO.:

232301

DRAWN BY:


CWJ

SHEET TITLE:

PLAN

UTILITY

SHEET NO.:

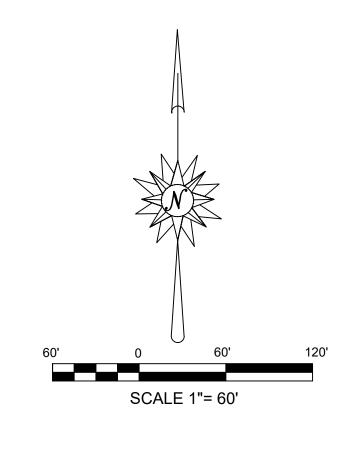

<u>LEGEND</u>

IRON PIN W/PLASTIC CAP (SET THIS SURVEY)	\circ
EXISTING MOUMENTS FOUND	
POINTS NOT RECOVERED OR MARKED	\triangle
PROPERTY LINE	
RIGHT-OF-WAY	R.O.W.
POWER POLE	O
POINT OF BEGINNING	P.O.B.

NOTES:

T.B.M. (MAG NAIL) NORTHING = 1348646.57 EASTING = 561467.17

ELEVATION = 1085.58'

INV. ELEV. = 1080.45'

STREET LIGHTS SHALL BE LEXINGTON LXF, 70 W, 120-277V LED FIXTURES BY COOPER LIGHTING SOLUTIONS. FIXTURES SHALL BE 27 1/2" TALL AND 15" WIDE, BLACK WITH PHOTOCONTROL. ORDER No. LXF-AF24-70-D-U-T3-10K-4-CL-BK

FIXTURES TO BE MOUNTED ON 19' TALL TAPERED ALUMINUM POLES, 0.125" WALL THICKNESS, 5" O.D. AT BASE, BLACK. INSTALLED POLE HEIGHT TO BE 16'. CONCRETE FOUNDATION FOR POLES TO BE AS RECOMMENDED BY MANUFACTURER.



CONSTRUCTION DOGWO

SCALE: 1"=60'

JANUARY 2025 PROJ. NO.:

232301

DATE:


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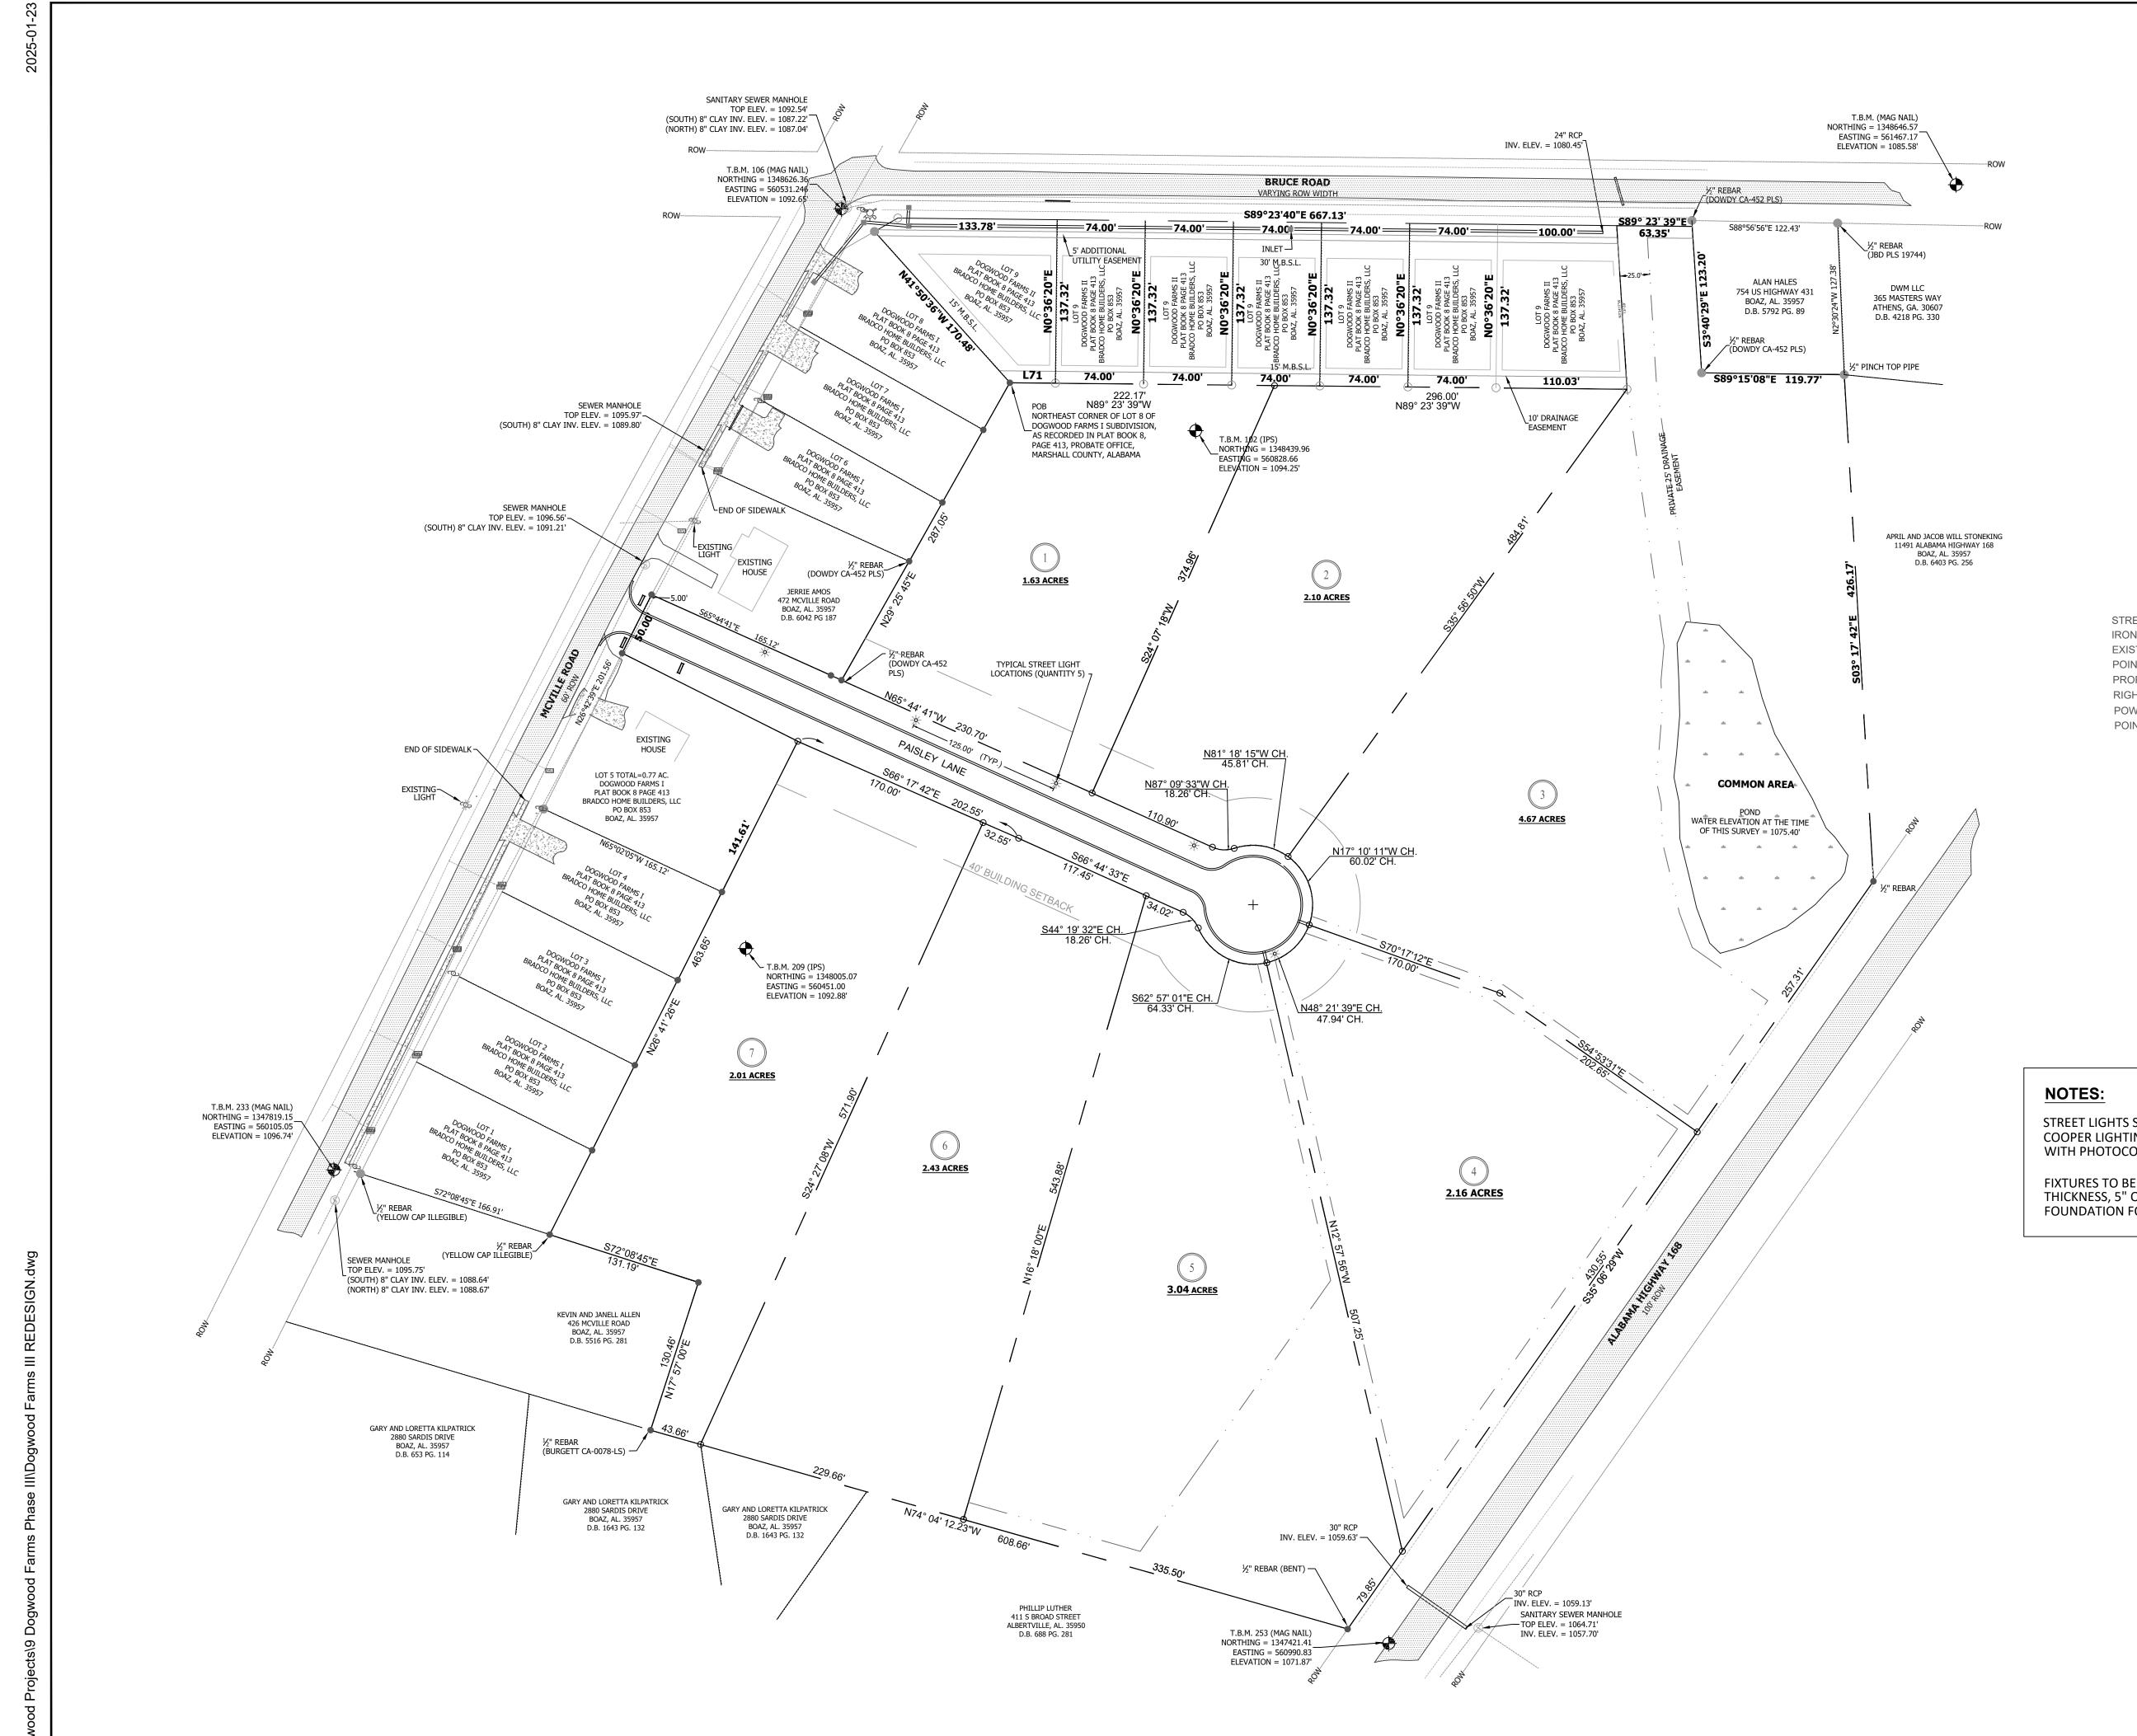
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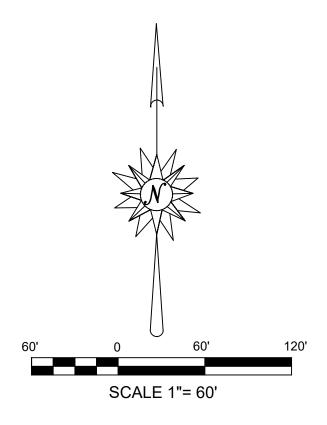
STREET

SIGNAGE

PLAN SHEET NO.:





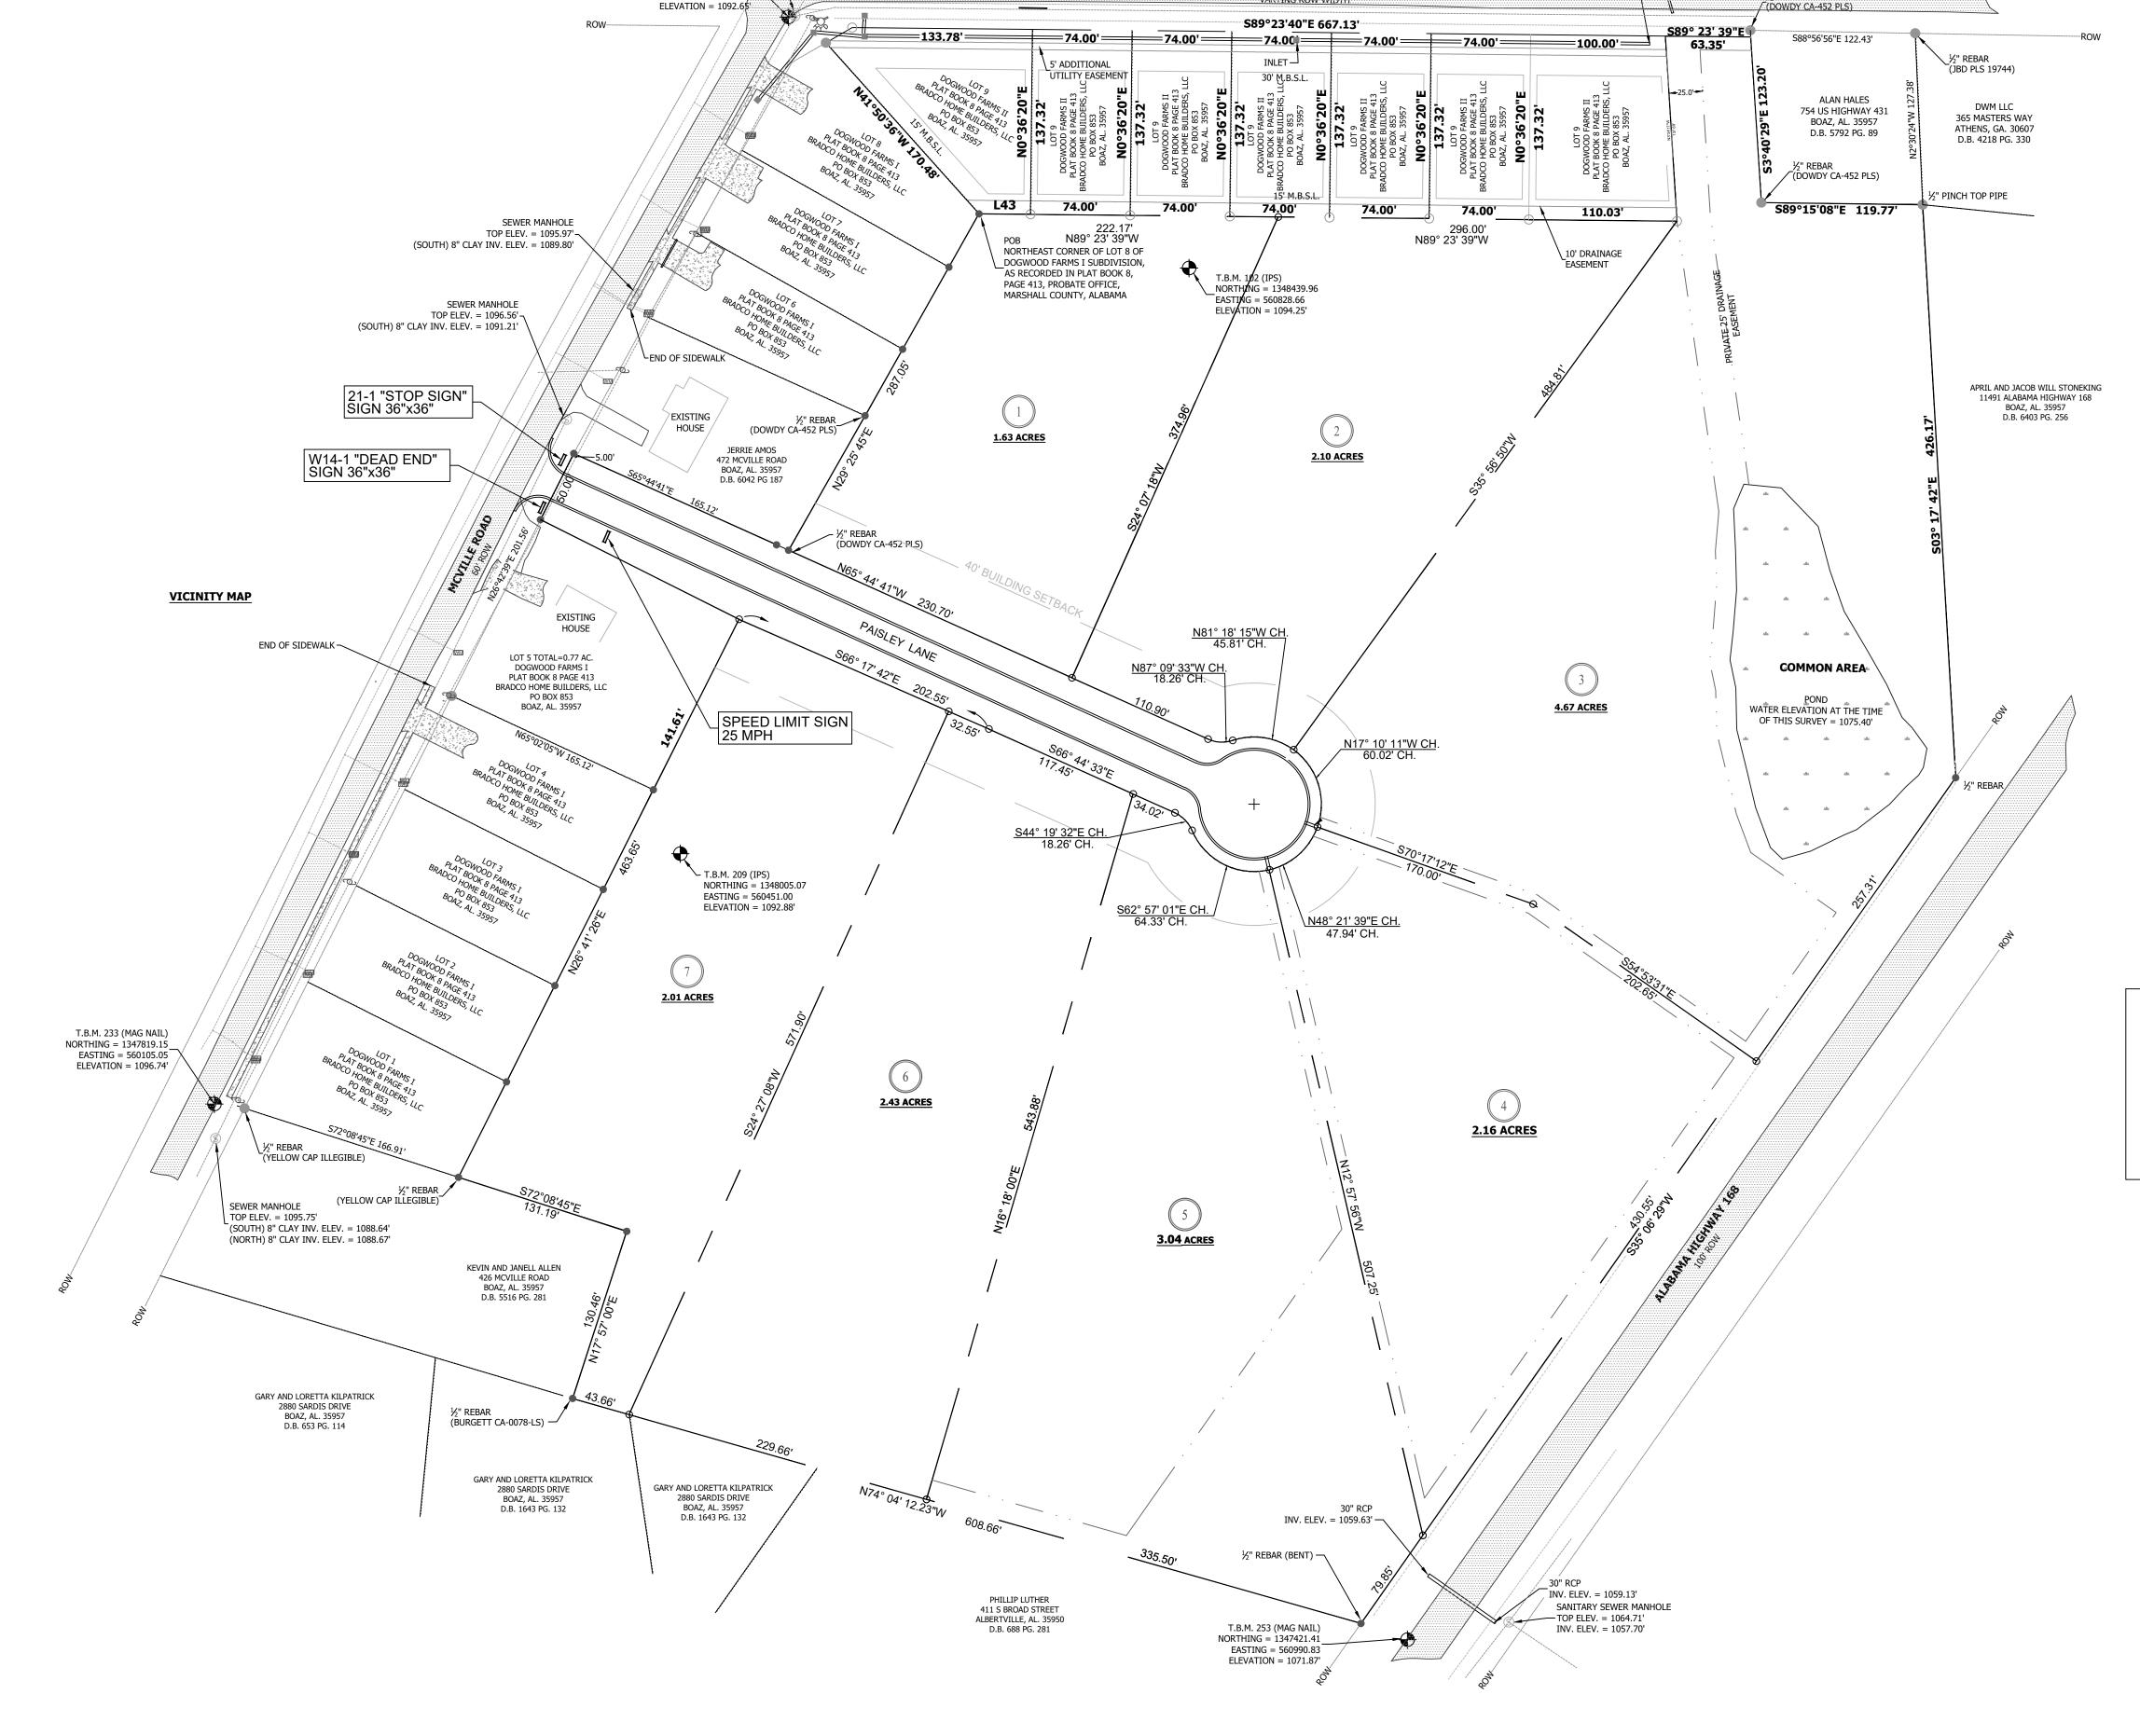

<u>LEGEND</u>

STREET LIGHT (SUBDIVISION)	*
IRON PIN W/PLASTIC CAP (SET THIS SURVEY)	C
EXISTING MOUMENTS FOUND	
POINTS NOT RECOVERED OR MARKED	Â
PROPERTY LINE	
RIGHT-OF-WAY	· R.O.
POWER POLE	\mathcal{O}
POINT OF BEGINNING	P.O.

STREET LIGHTS SHALL BE LEXINGTON LXF, 70 W, 120-277V LED FIXTURES BY COOPER LIGHTING SOLUTIONS. FIXTURES SHALL BE 27 1/2" TALL AND 15" WIDE, BLACK WITH PHOTOCONTROL. ORDER No. LXF-AF24-70-D-U-T3-10K-4-CL-BK

FIXTURES TO BE MOUNTED ON 19' TALL TAPERED ALUMINUM POLES, 0.125" WALL THICKNESS, 5" O.D. AT BASE, BLACK. INSTALLED POLE HEIGHT TO BE 16'. CONCRETE FOUNDATION FOR POLES TO BE AS RECOMMENDED BY MANUFACTURER.





ALABAN

CONSTRUCTION PLANS
DOGWOOD FARMS III

SCALE:
1"=60'

DATE:
JANUARY 2025

PROJ. NO.: 232301


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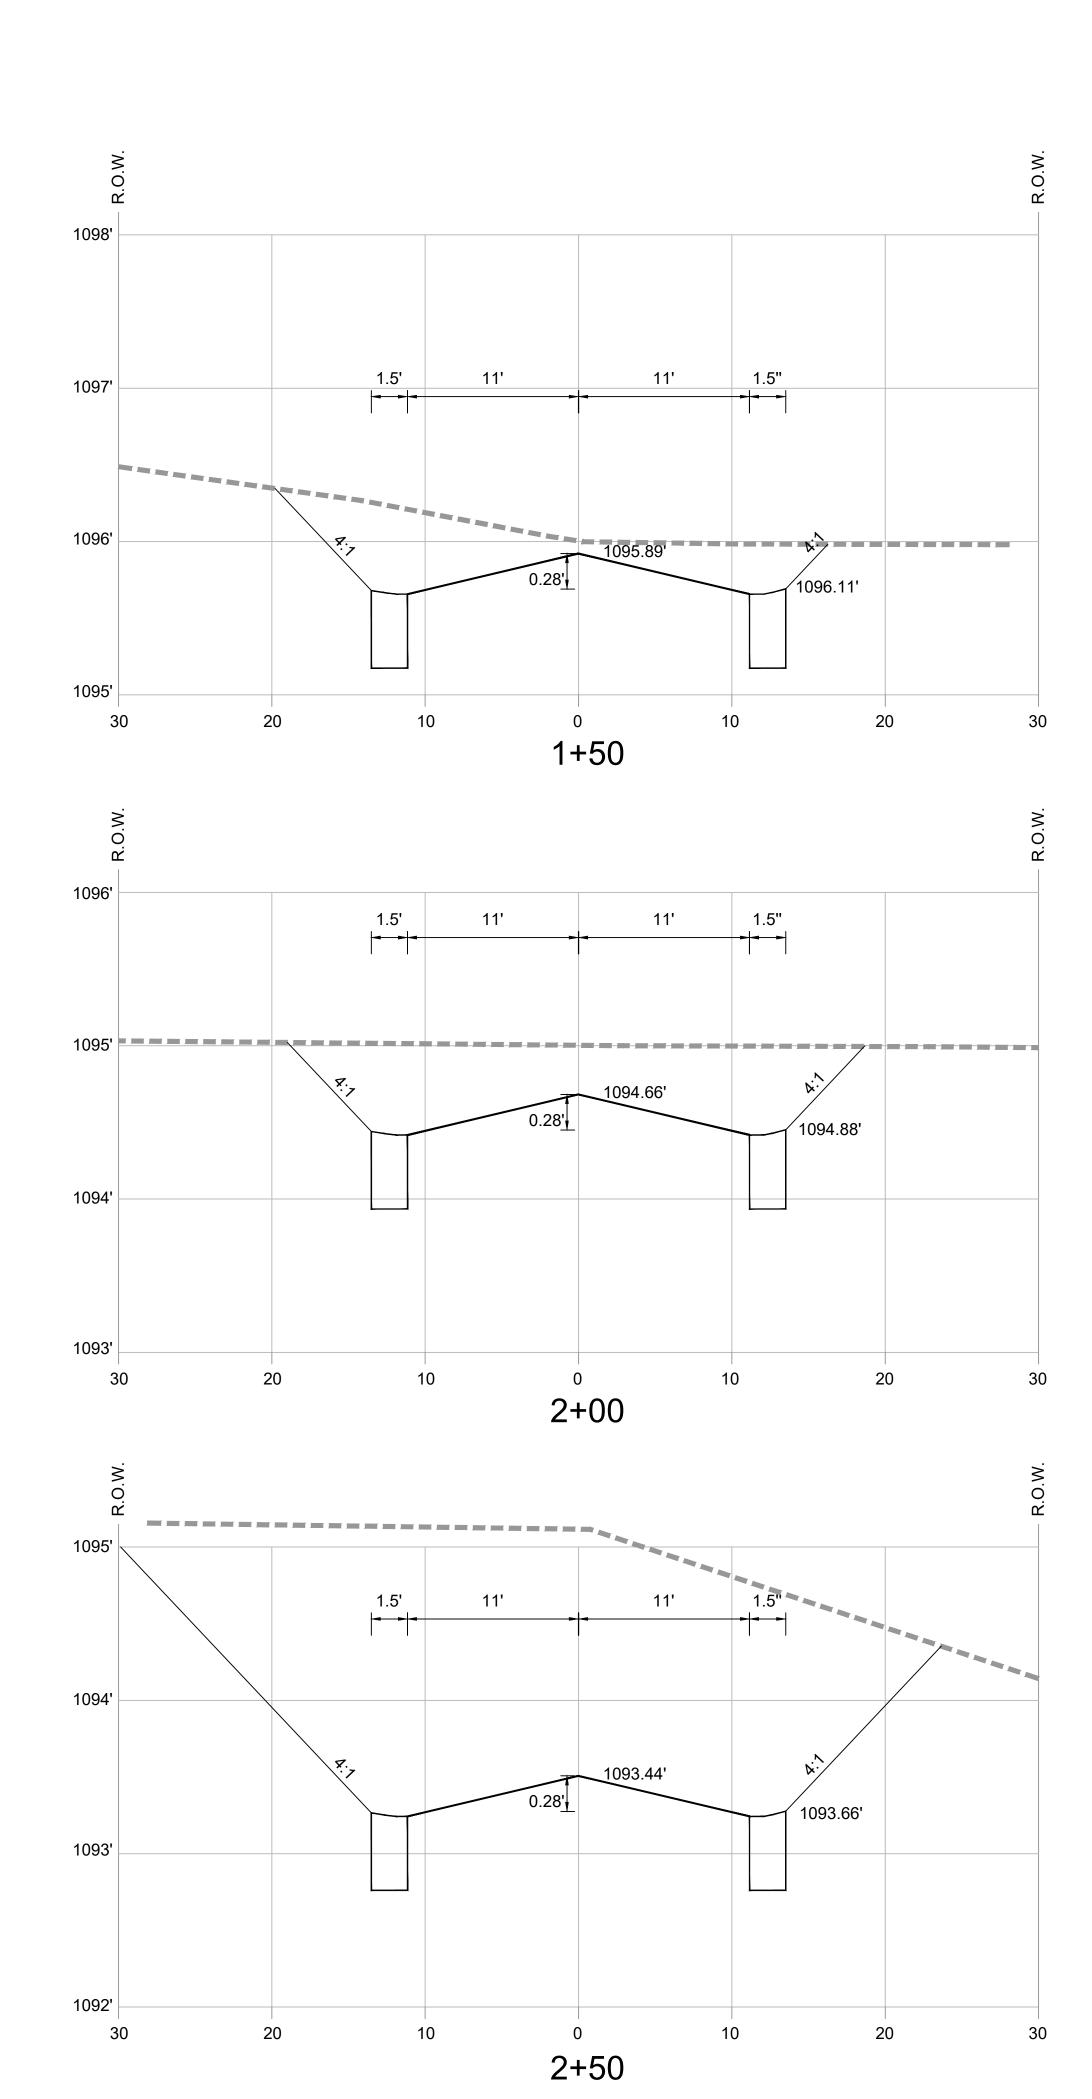
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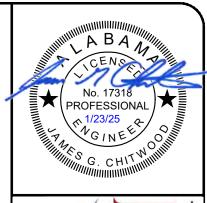
STREET

LIGHT PLAN

SHEET NO.:





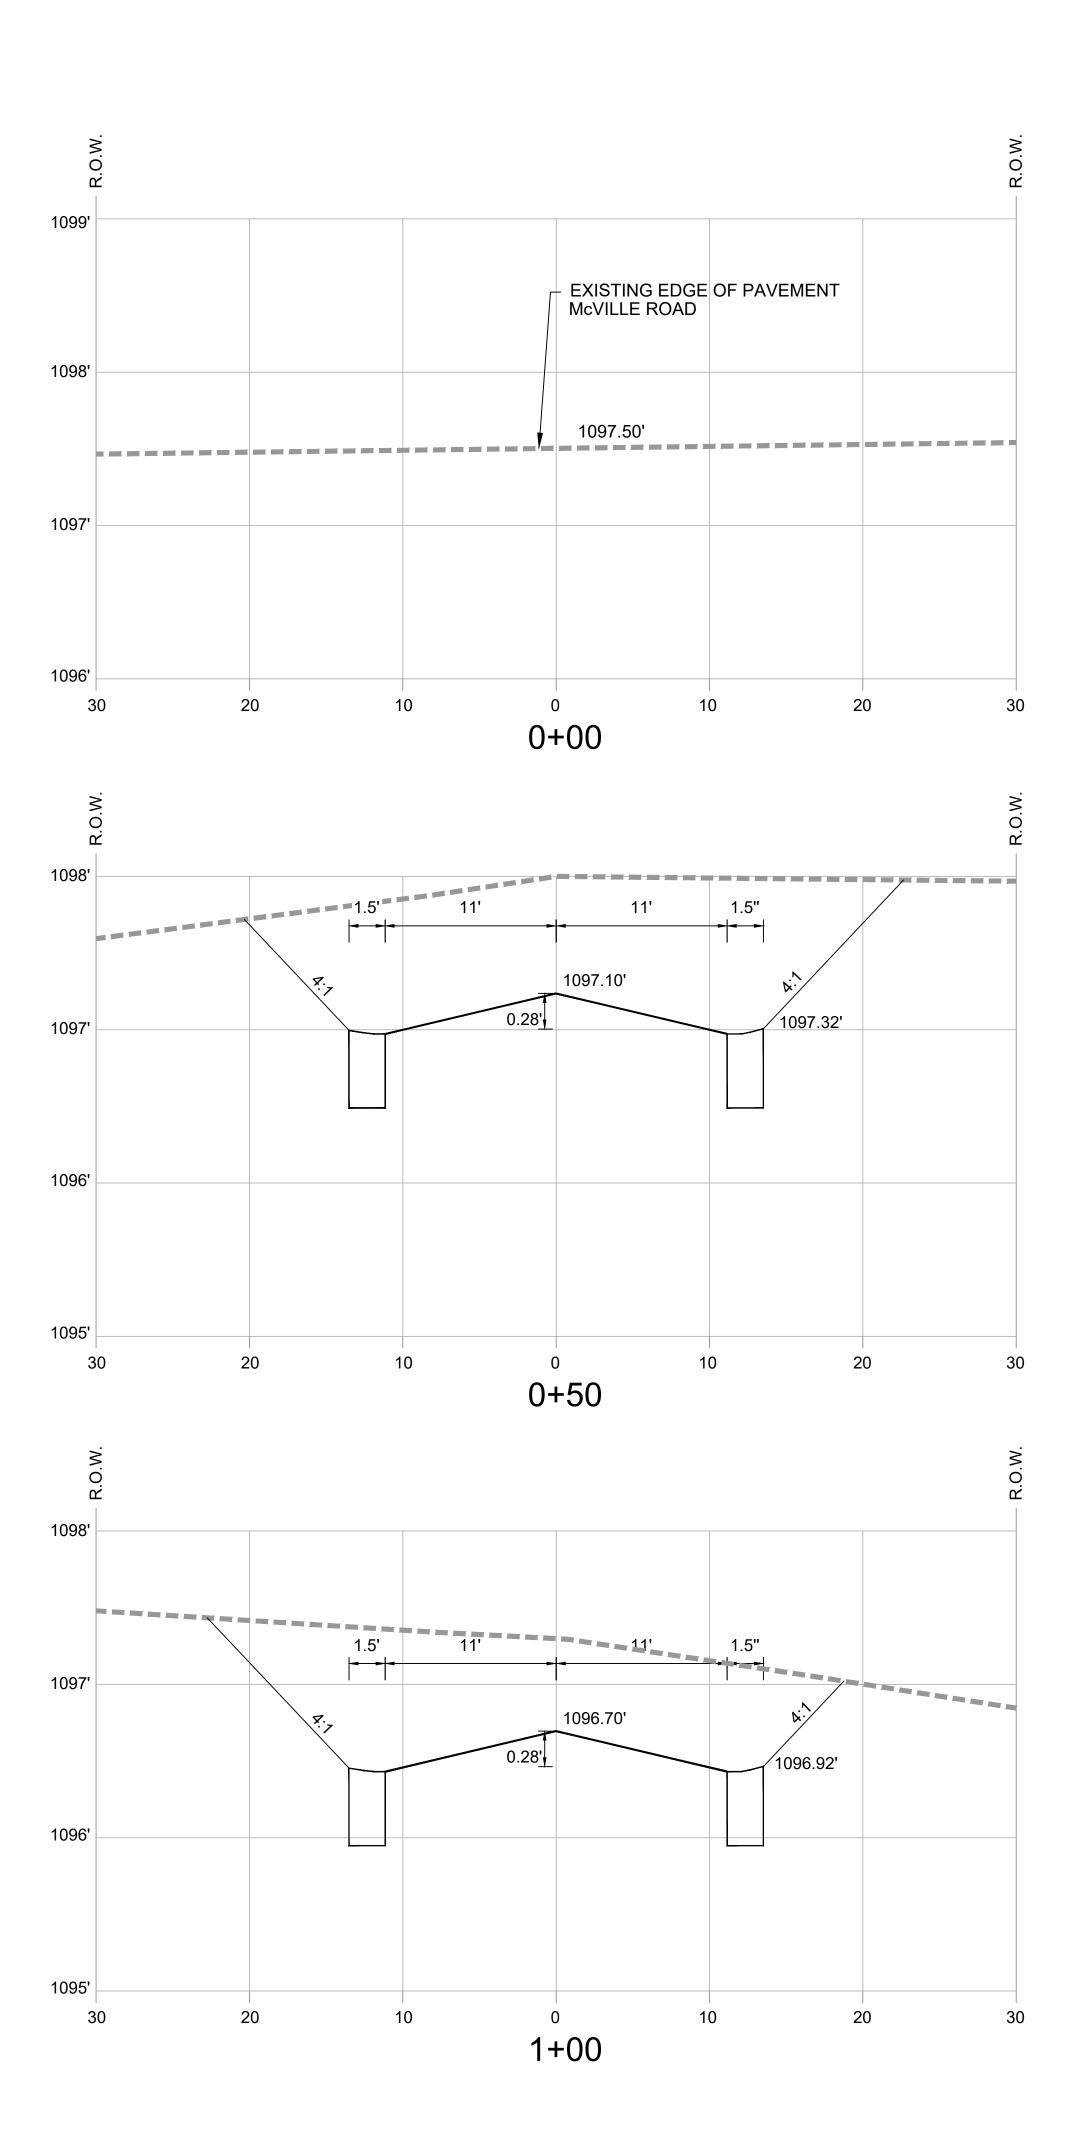



A IA

CONSTRUCTION PLANS
DOGWOOD FARMS III

MARSHALL COUNTY

SCALE: 1"=30' DATE: JANUARY 2025

PROJ. NO.: 232301


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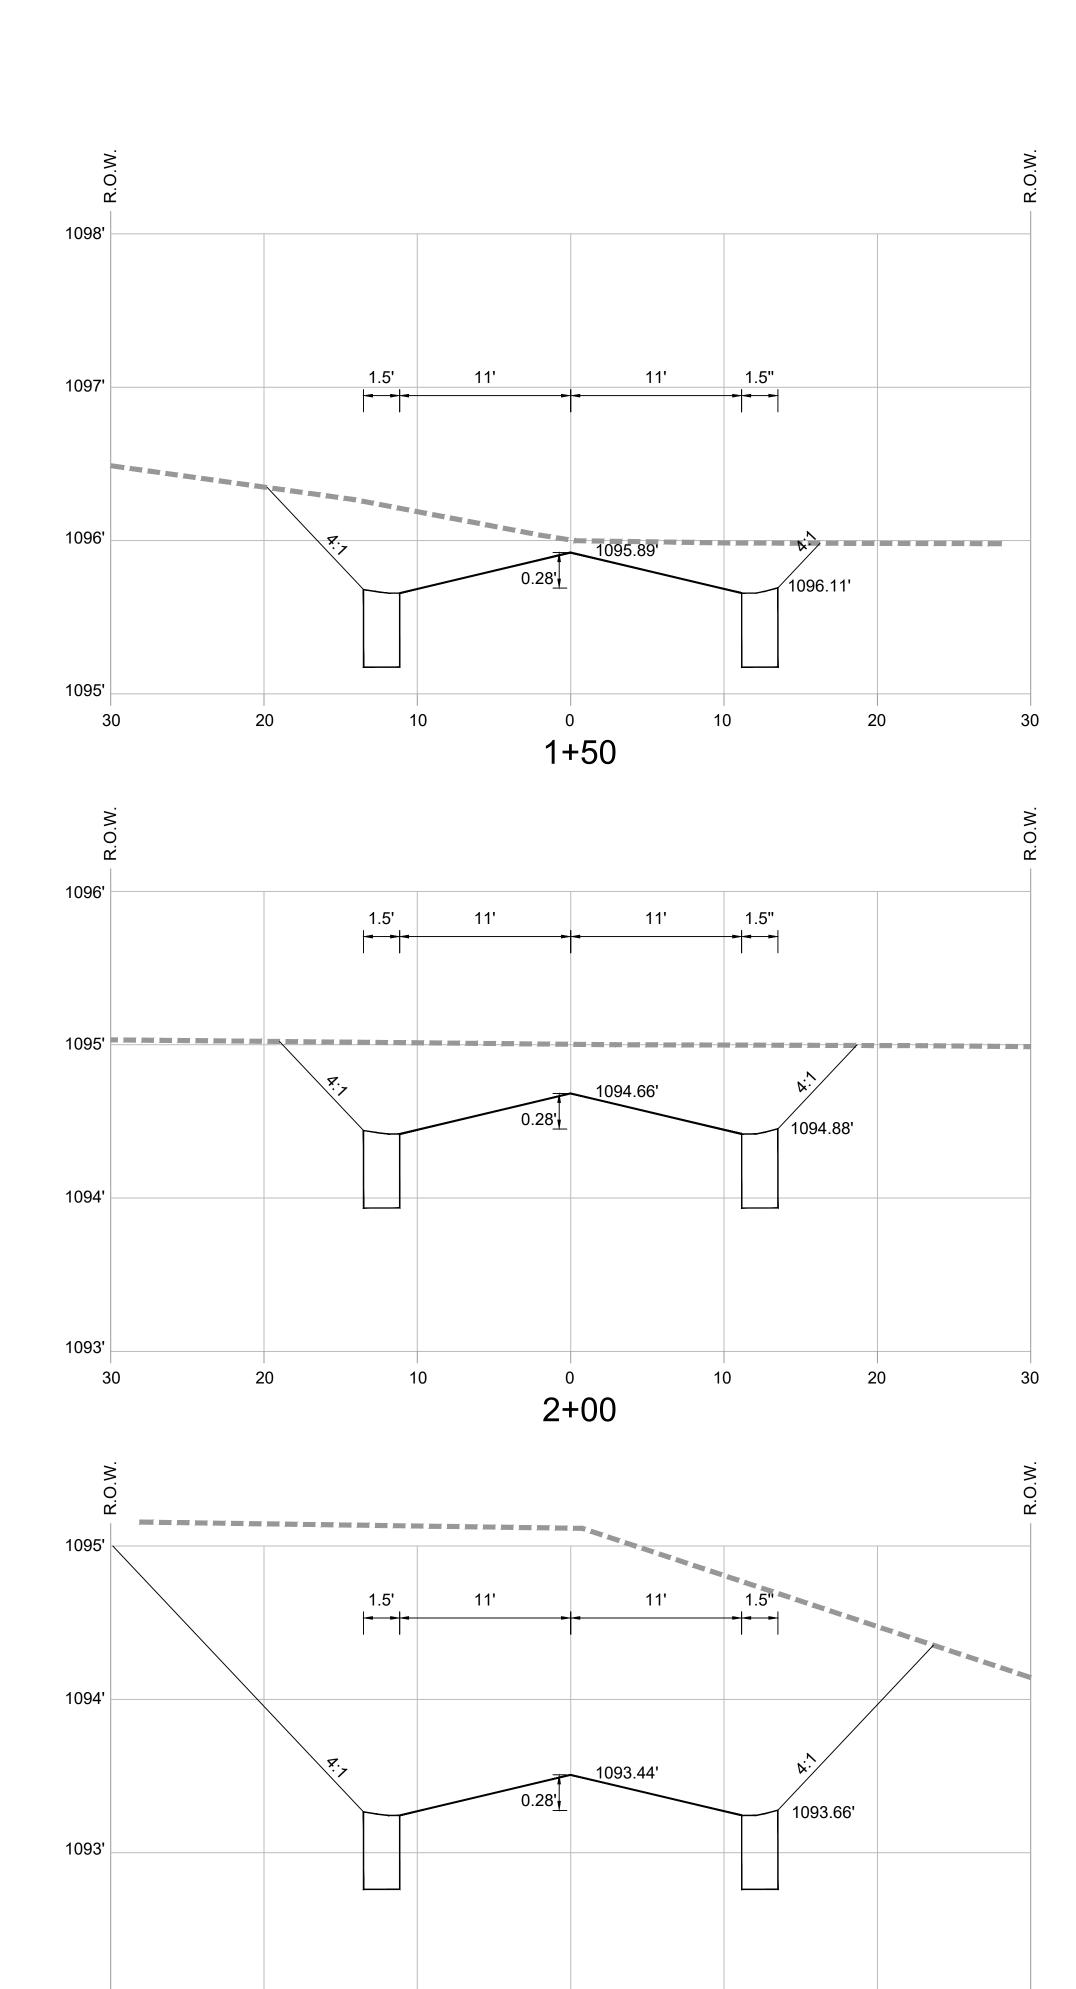
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ROAD

PROFILE

SHEET NO.:




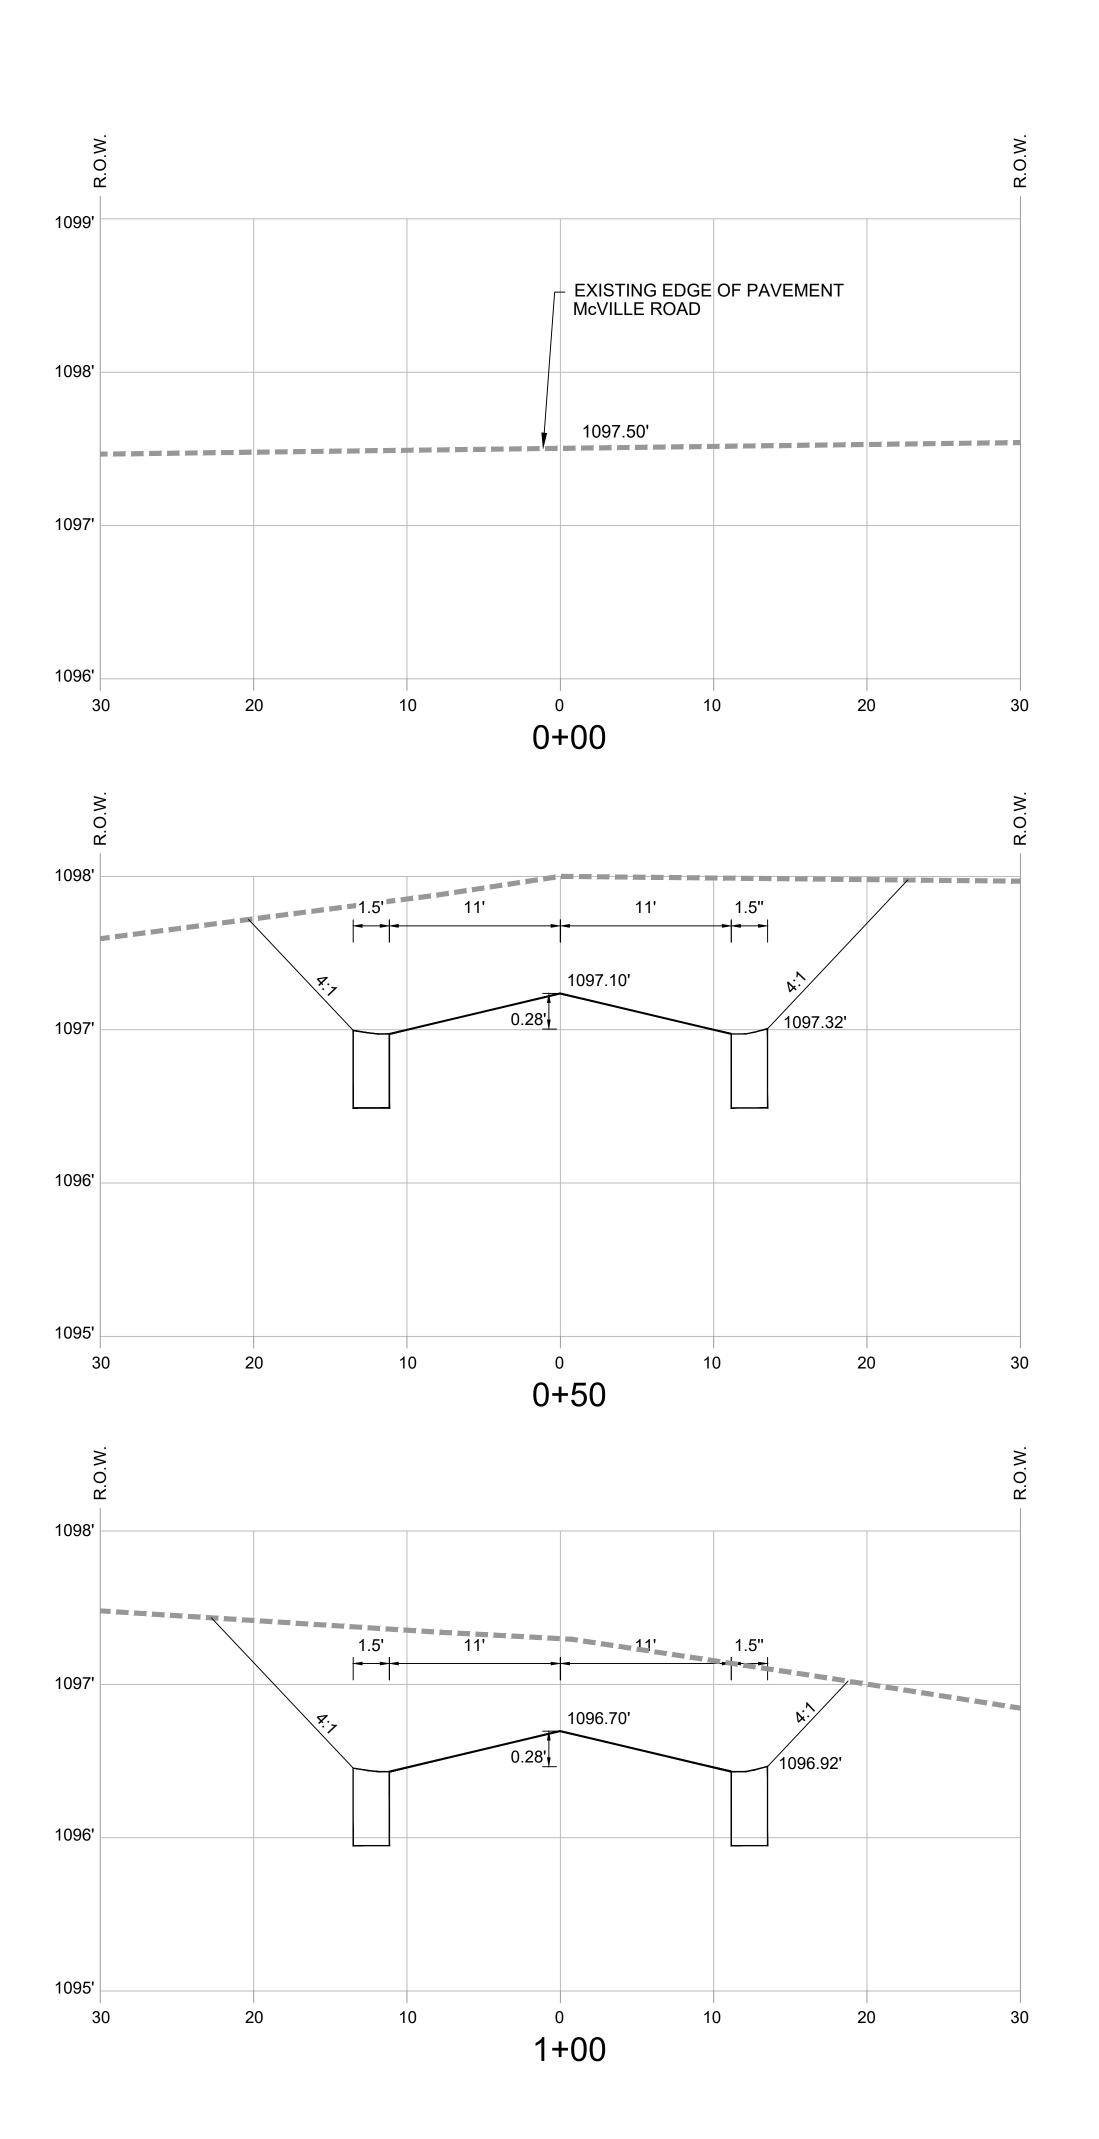

2+50

1092'

20

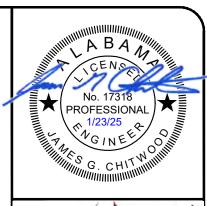



CONSTRUCTION PLANS DOGWOOD FARMS III

MARSHALL COUNTY

SCALE: 1"=30' DATE: JANUARY 2025

PROJ. NO.:


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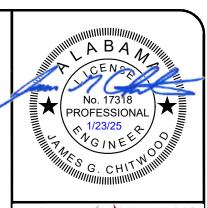
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SHEET TITLE:

ROAD

PROFILE

SHEET NO.:



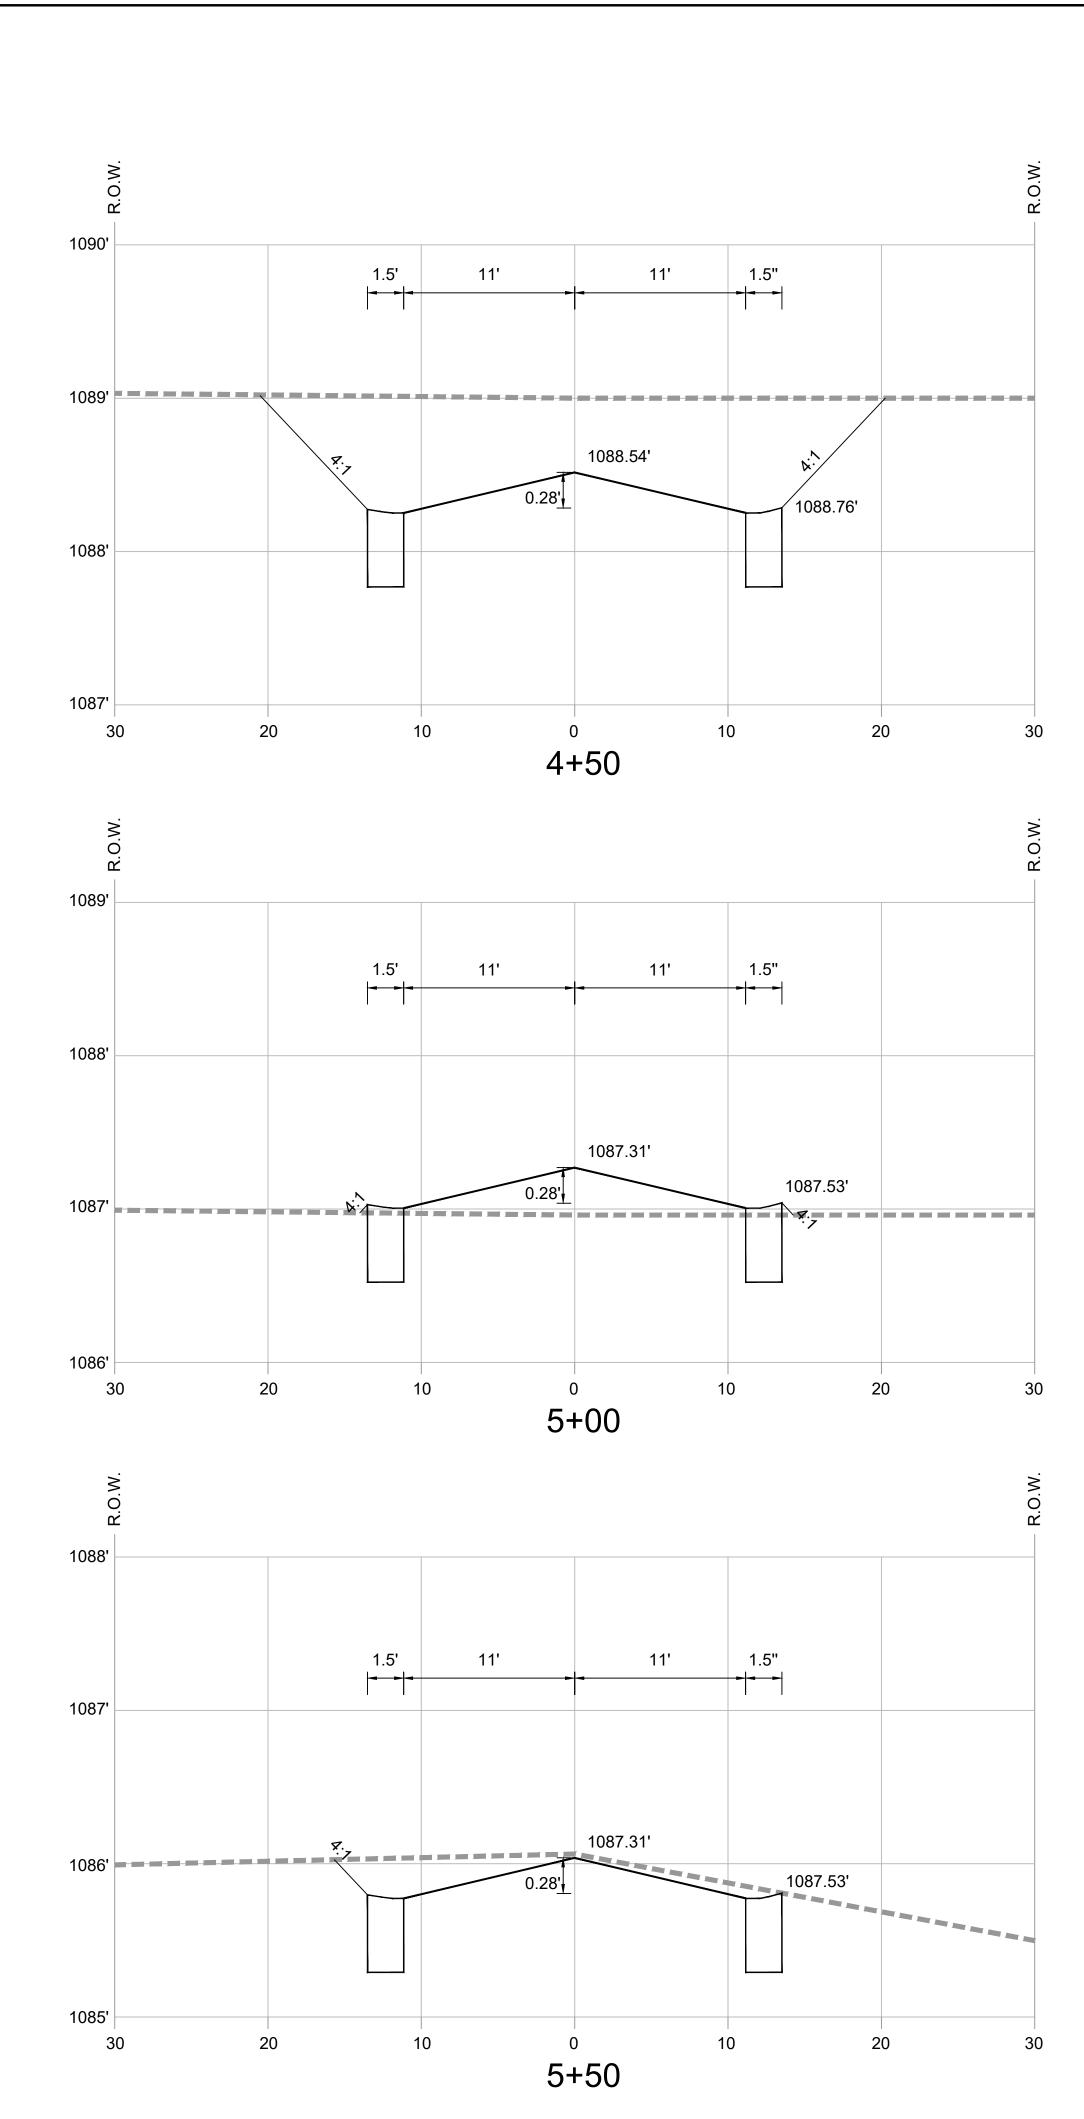



D FARMS III

CONSTRUCTION F DOGWOOD FARM

SCALE: 1"=30' DATE: JANUARY 2025

PROJ. NO.:

232301 DRAWN BY:

CWJ
SHEET TITLE:

ROAD

PROFILE

SHEET NO.:



CONSTRUCTION PLANS
DOGWOOD FARMS III

SCALE:

1"=30' DATE:

JANUARY 2025 PROJ. NO.:

232301 DRAWN BY:


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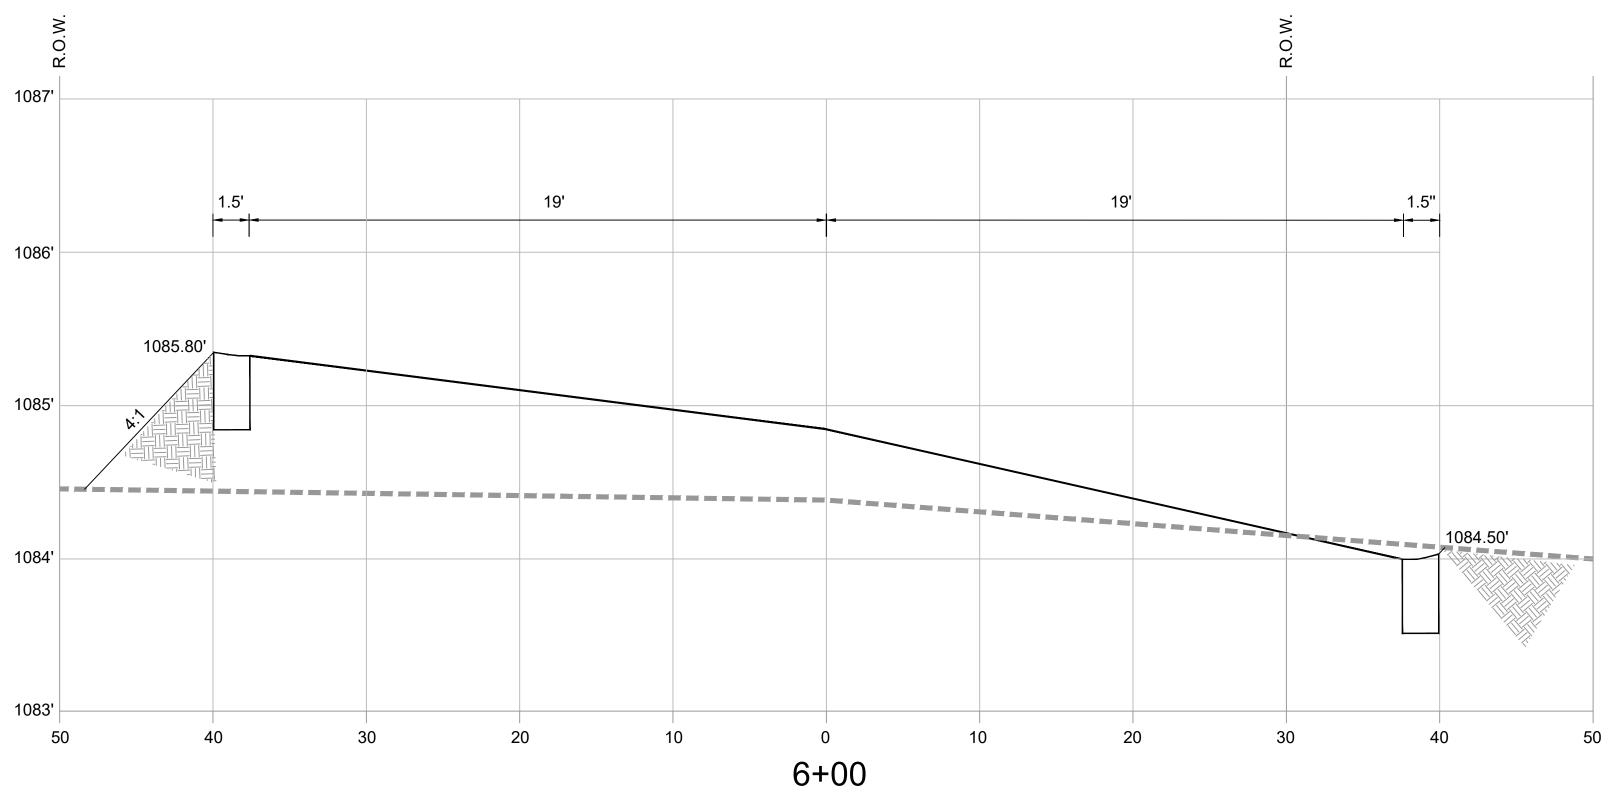
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SECTIONS

ROAD

SHEET NO.:



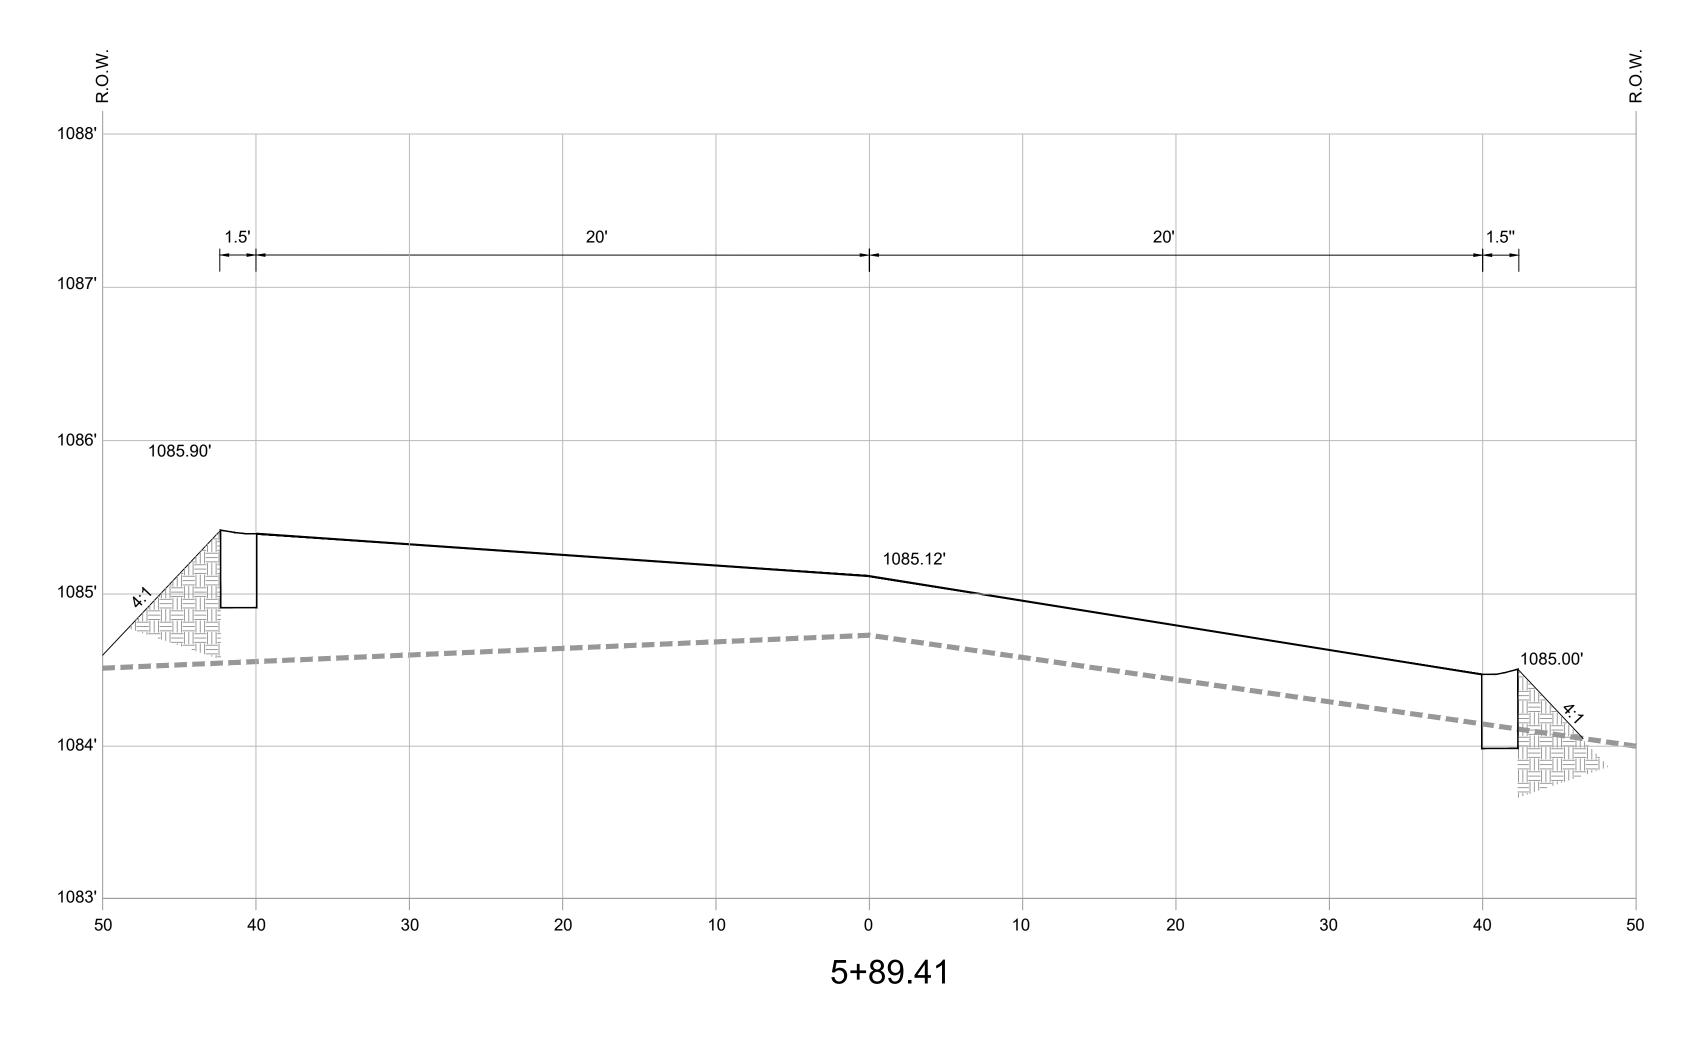

JANUARY 2025 PROJ. NO.:

232301


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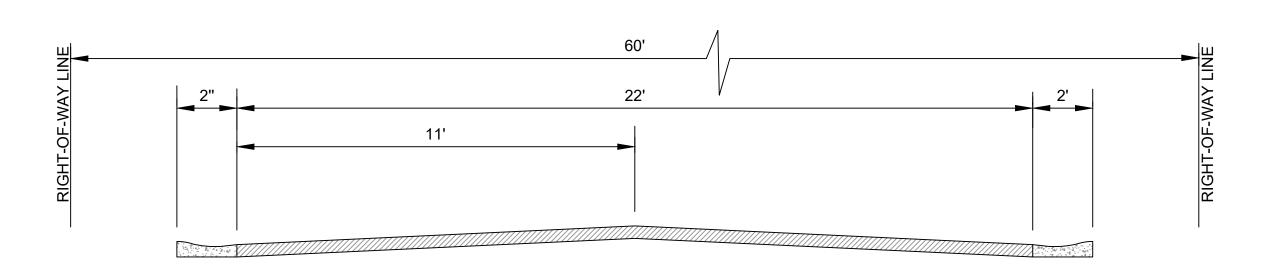
TYPICAL

DETAILS

SHEET NO.:




TYP. TRENCH DETAIL NON-PAVED AREAS NO SCALE

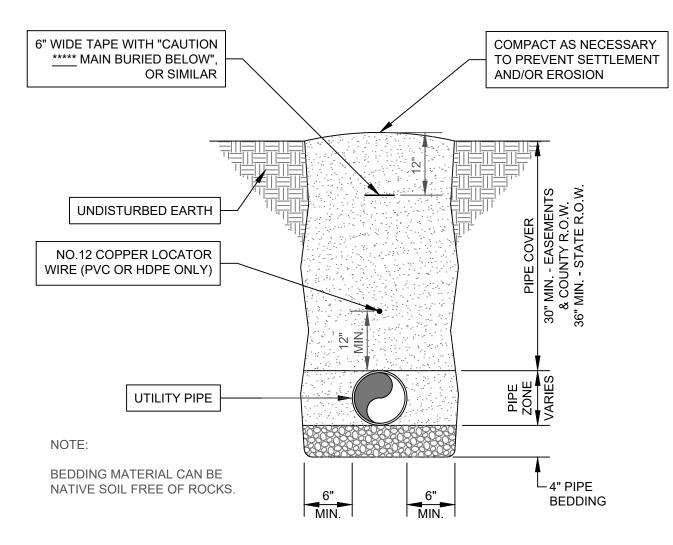


TYPICAL STREET SECTION NO SCALE


- BITUMINOUS CONCRETE WEARING SURFACE LAYER (APPROX. 165 LBS./S.Y.), TYPE 424A MAXIMUM AGGREGATE SIZE 1/2", ESAL RANGE A, AS PER ALDOT SSHC 2012 OR LATER.
- 2. BITUMINOUS CONCRETE UPPER BINDER LAYER (APPROX. 330 LBS./S.Y.), TYPE 424B, MAXIMUM AGGREGATE SIZE 1", ESAL RANGE A, AS PER ALDOT SSHC 2012 OR LATER.
- 3. CRUSHED AGGREGATE BASE COURSE, ALDOT 825, TYPE B, 6" COMPACTED THICKNESS, AS PER ALDOT SSHC 2012 OR LATER.
- 4. SUB-GRADE (COMPACTED 100% MODIFIED PROCTOR).

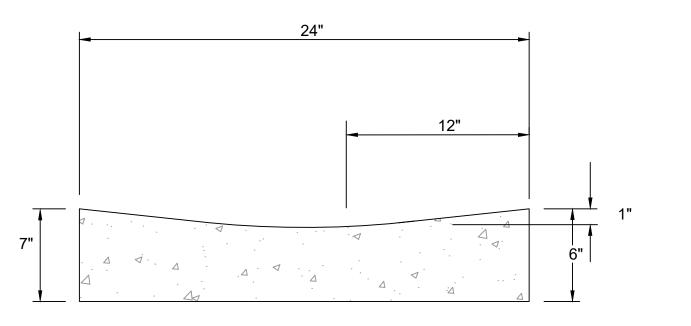


24" VALLEY CURB AND GUTTER NO SCALE

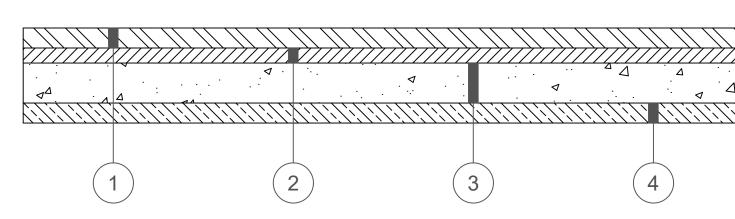

TYPICAL LIGHT DUTY **BITUMINOUS PAVING SECTION** NO SCALE

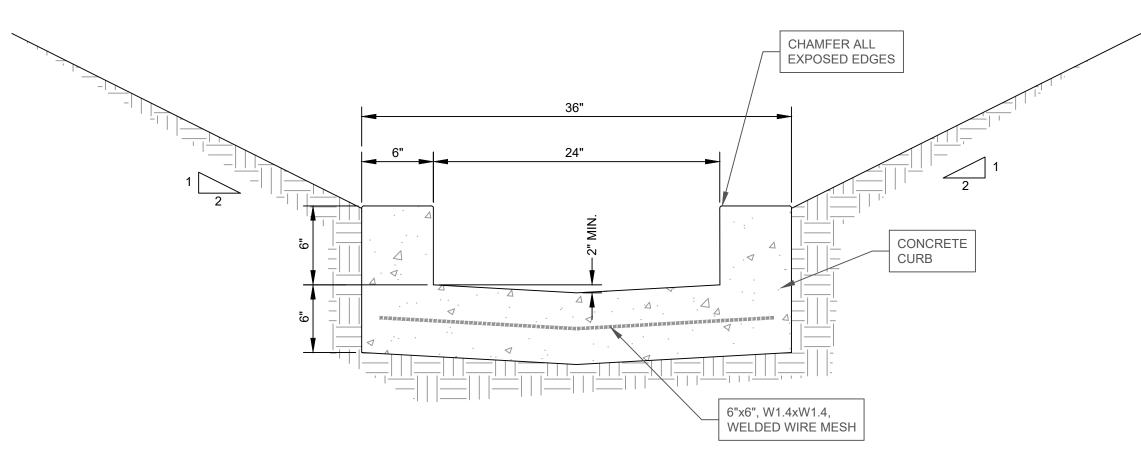


CONCRETE FLUME DETAIL NO SCALE

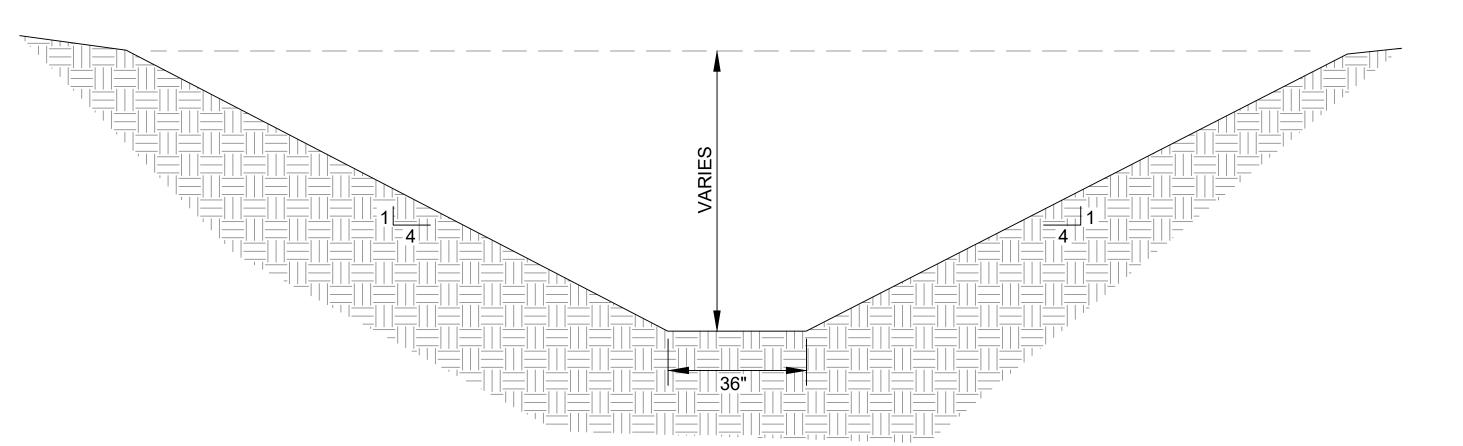


TYPICAL DITCH SECTION NO SCALE




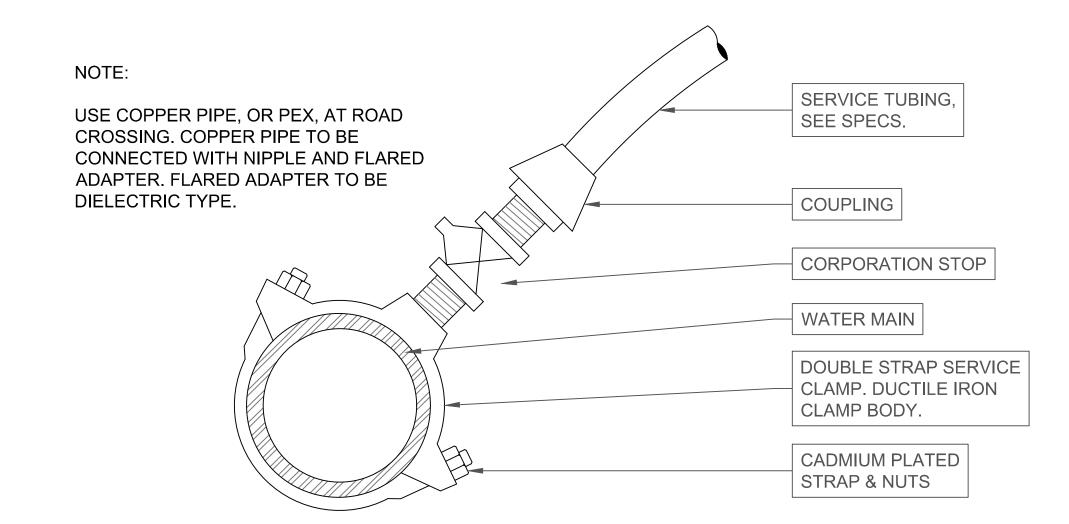

WATER SERVICE CONNECTION DETAIL
NO SCALE

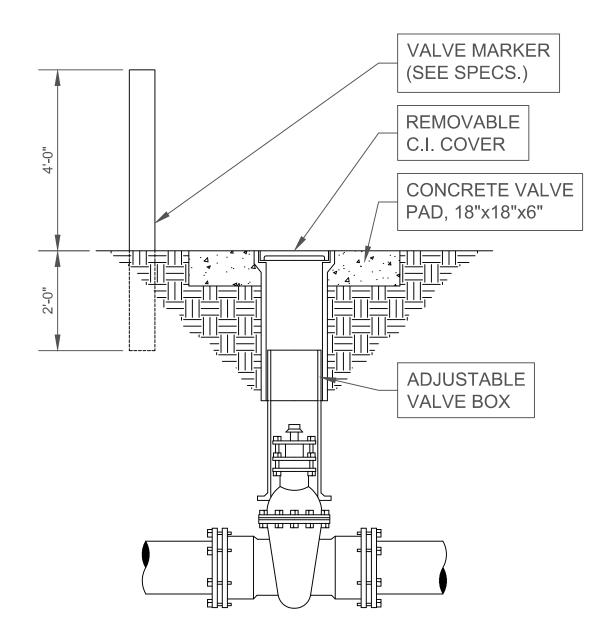

TYP. BURIED VALVE & BOX DETAIL
NO SCALE

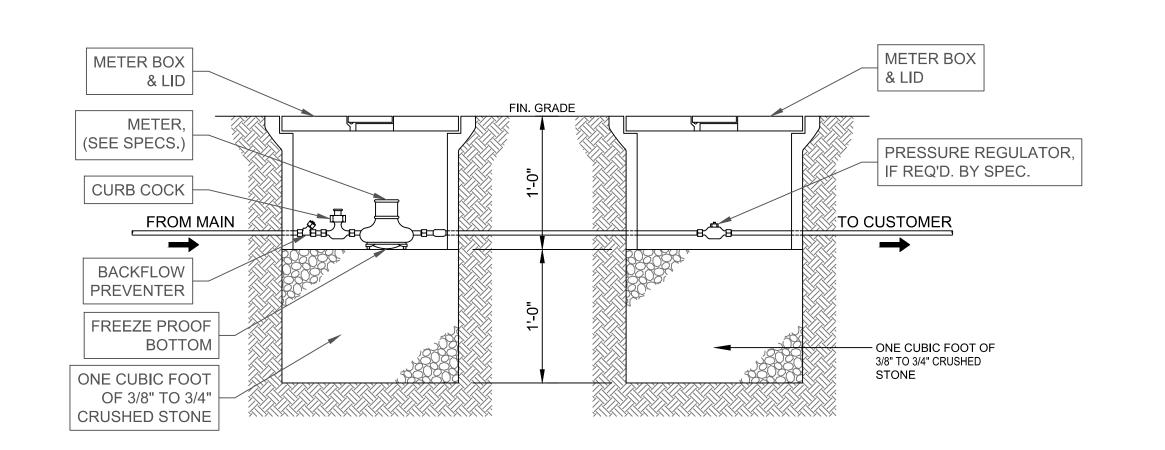

TYP. METER INSTALLATION

NO SCALE

JANUARY 2025 PROJ. NO.:

DATE:

232301 DRAWN BY:


CWJ SHEET TITLE:

TYPICAL

DETAILS

SHEET NO.:


FRONT ELEVATION

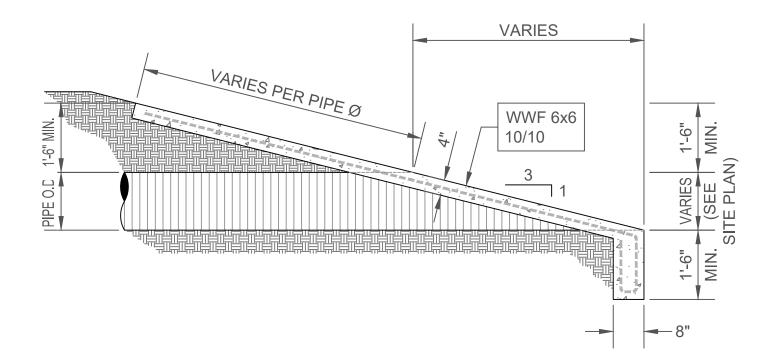

SIDE ELEVATION VIEW


SLOPED HEADWALL DETAIL

NO SCALE

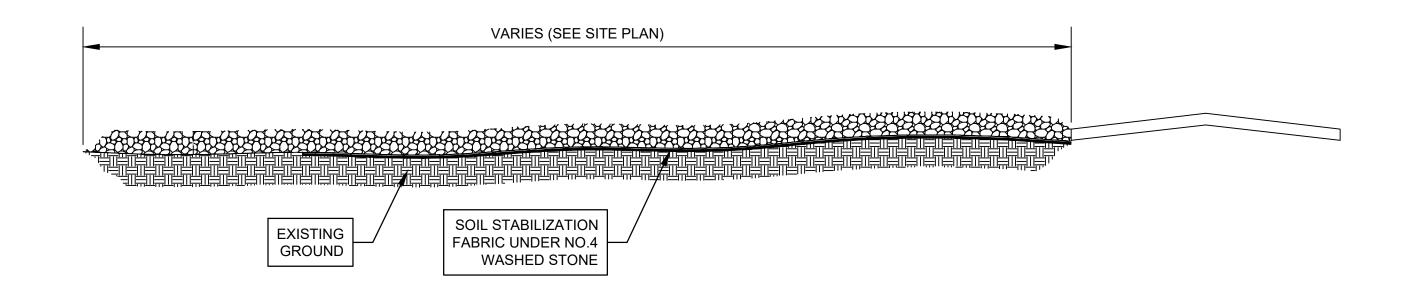

NOTES:

- 1. A STABILIZED ENTRANCE PAD OF #4 WASHED STONE, OR RAILROAD BALLAST, SHALL BE LOCATED WHERE TRAFFIC WILL ENTER OR LEAVE THE CONSTRUCTION SITE ONTO A PUBLIC STREET.
- 2. FILTER FABRIC, OR COMPACTED CRUSHER RUN STONE, SHALL BE USED AS A BASE FOR THE CONSTRUCTION ENTRANCE.
- 3. THE ENTRANCE SHALL BE MAINTAINED IN A CONDITION WHICH WILL PREVENT TRACKING, OR FLOWING, OF SEDIMENT ONTO PUBLIC STREETS OR EXISTING PAVEMENT. THIS MAY REQUIRE PERIODIC TOP DRESSING WITH ADDITIONAL STONE AS CONDITIONS WARRANT AND REPAIR, OR CLEANOUT, OF ANY MEASURES USED TO TRAP SEDIMENT.
- 4. ANY SEDIMENT SPILLED, DROPPED, WASHED, OR TRACKED ONTO PUBLIC STREETS MUST BE REMOVED DAILY.
- 5. WHEN APPROPRIATE, WHEELS MUST BE CLEANED TO REMOVE SEDIMENT PRIOR TO ENTERING A PUBLIC STREET. WHEN WASHING IS REQUIRED, IT SHALL BE DONE IN AN AREA STABILIZED WITH CRUSHED STONE WHICH DRAINS INTO AN APPROVED SEDIMENT BASIN.

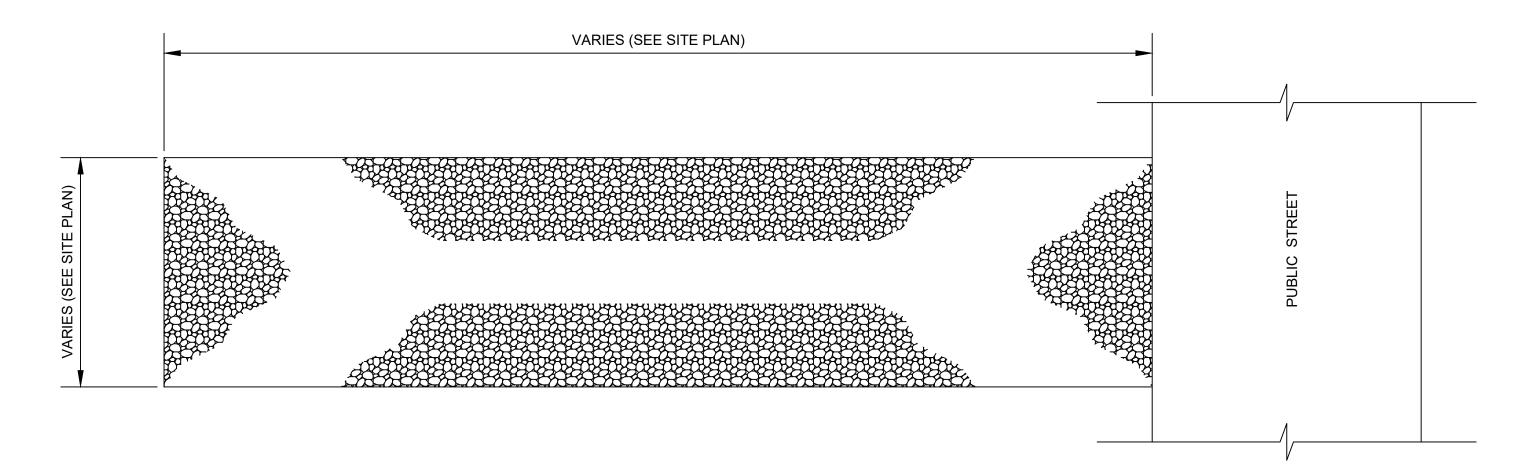


CONSTR


DOGW

C-802

WASHED GRAVEL CONSTRUCTION ENTRANCE NO SCALE

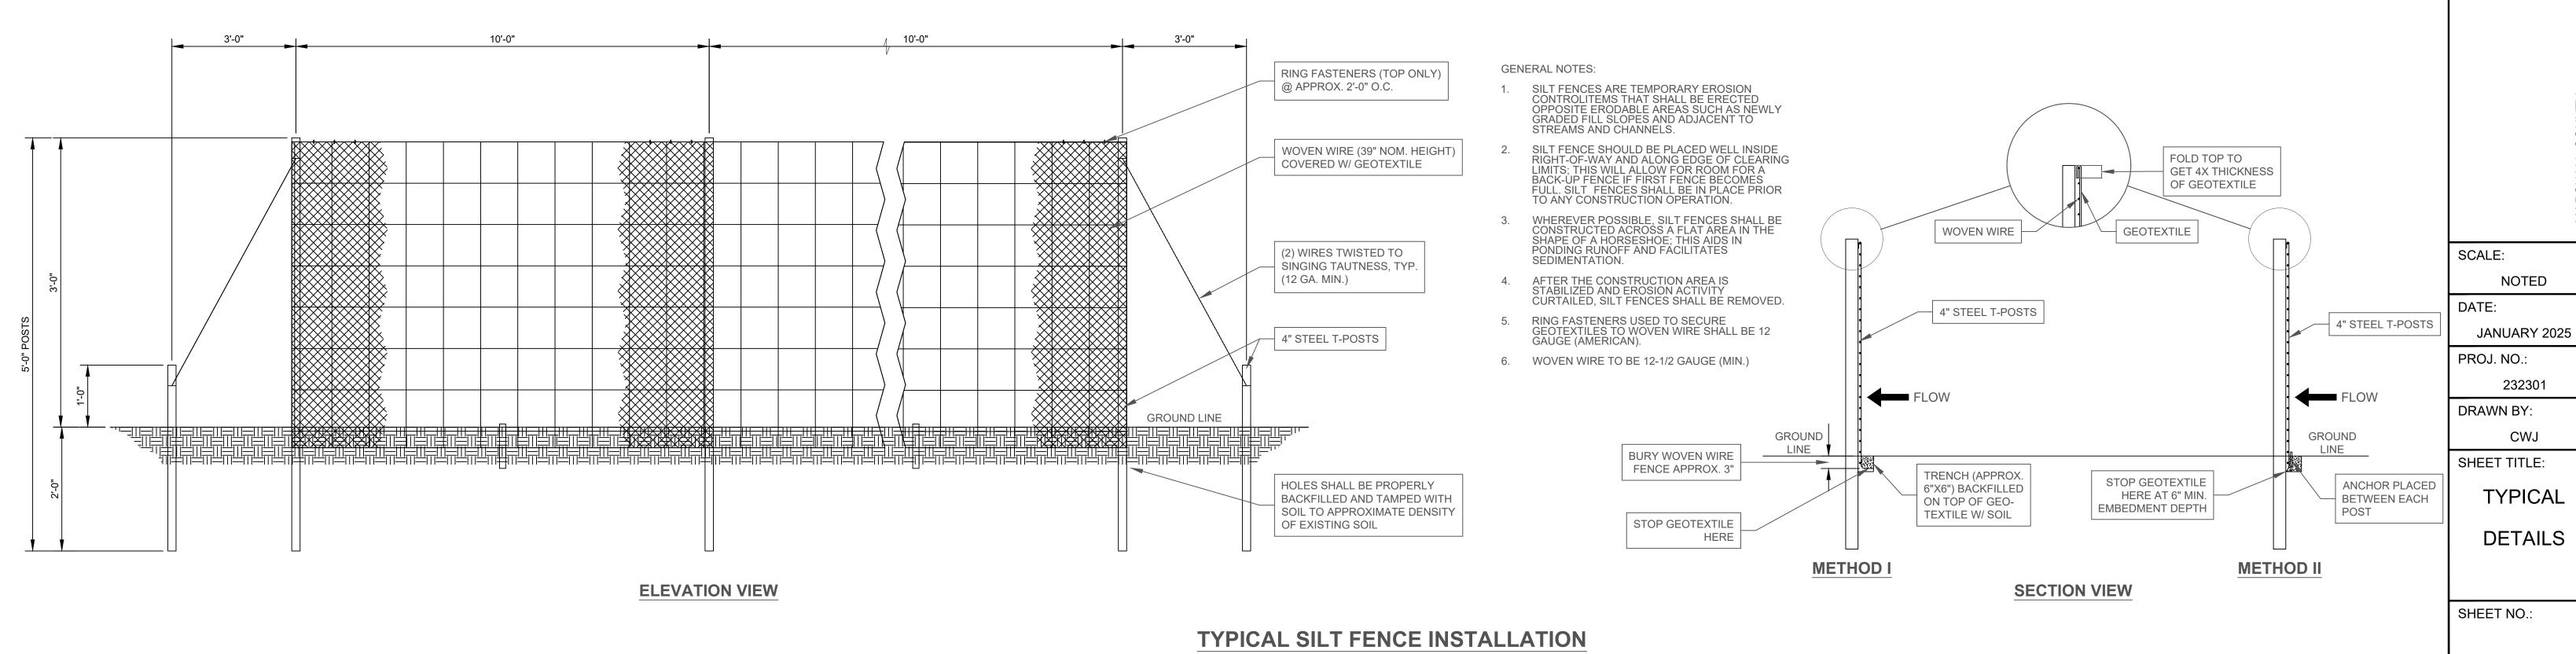


NOT TO SCALE

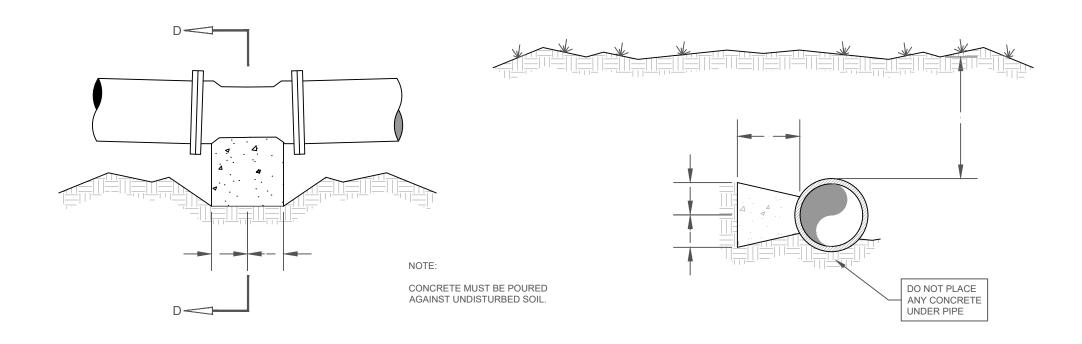

PLAN	SECTION "D"


	22 1/2°	BENDS			11 1/4°	BENDS	
PIPE DIA.	Н	W	D	Н	W	D	MIN. COVER
4"	6"	4"	1'-6"	6"	4"	1'-6"	2'-6"
6"	9"	6"	1'-6"	6"	6"	1'-6"	2'-6"
8"	1'-0"	9"	1'-6"	9"	6"	1'-6"	3'-0"
10"	1'-3"	1'-0"	1'-6"	9"	9"	1'-6"	3'-0"
12"	1'-6"	1'-3"	1'-6"	1'-0"	9"	1'-6"	4'-0"
14"	1'-6"	1'-6"	1'-6"	1'-3"	1'-0"	1'-6"	4'-0"
16"	2'-0"	1'-6"	1'-6"	1'-6"	1'-0"	1'-6"	4'-0"
18"	2'-3"	1'-9"	1'-6"	1'-9"	1'-0"	1'-6"	4'-0"
20"	2'-6"	1'-9"	1'-6"	1'-9"	1'-6"	1'-6"	5'-0"
24"	2'-9"	2'-0"	1'-6"	2'-0"	1'-6"	1'-6"	5'-0"

TYPICAL 11 1/4° & 22 1/2° BEND THRUST BLOCK

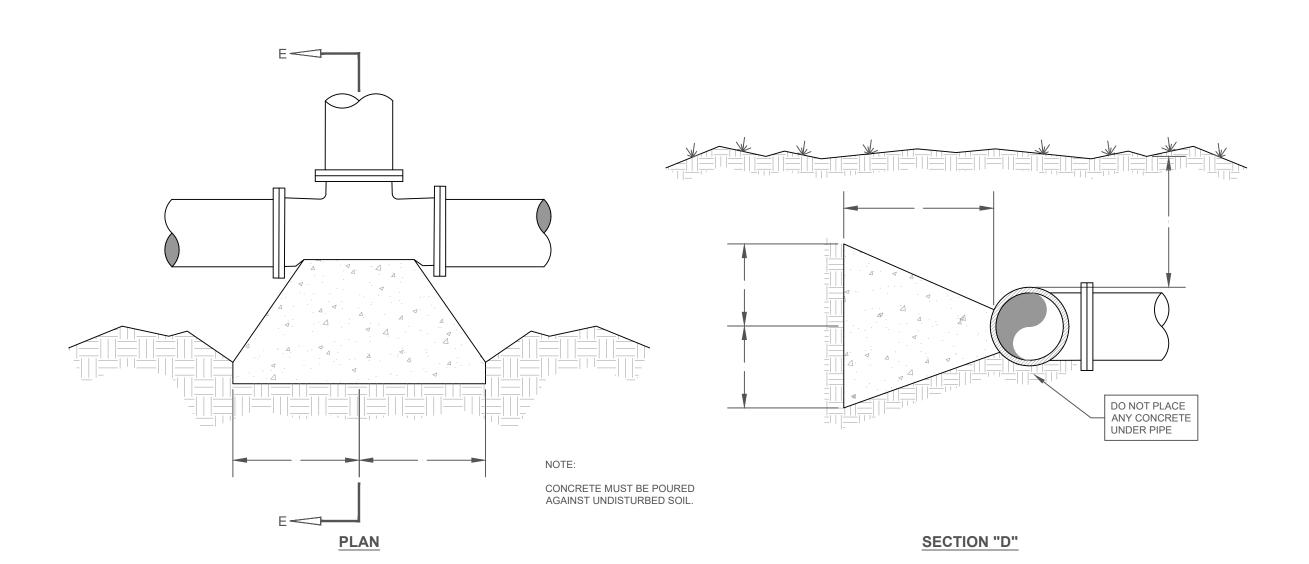


PIPE DIA.	Н	W	D	MIN. COVER
4"	9"	9"	1'-6"	3'-0"
6"	9"	1'-6"	1'-6"	3'-0"
8"	1'-3"	1'-9"	1'-6"	3'-0"
10"	1'-6"	2'-0"	1'-6"	3'-0"
12"	1'-6"	3'-0"	1'-6"	4'-0"
14"	2'-3"	3'-0"	1'-9"	4'-0"
16"	2'-3"	3'-0"	2'-0"	4'-0"
18"	2'-6"	3'-0"	2'-3"	4'-0"
20"	2'-6"	3'-3"	2'-6"	5'-0"
24"	3'-0"	3'-6"	3'-0"	5'-0"

TYPICAL TEE THRUST BLOCK DETAIL

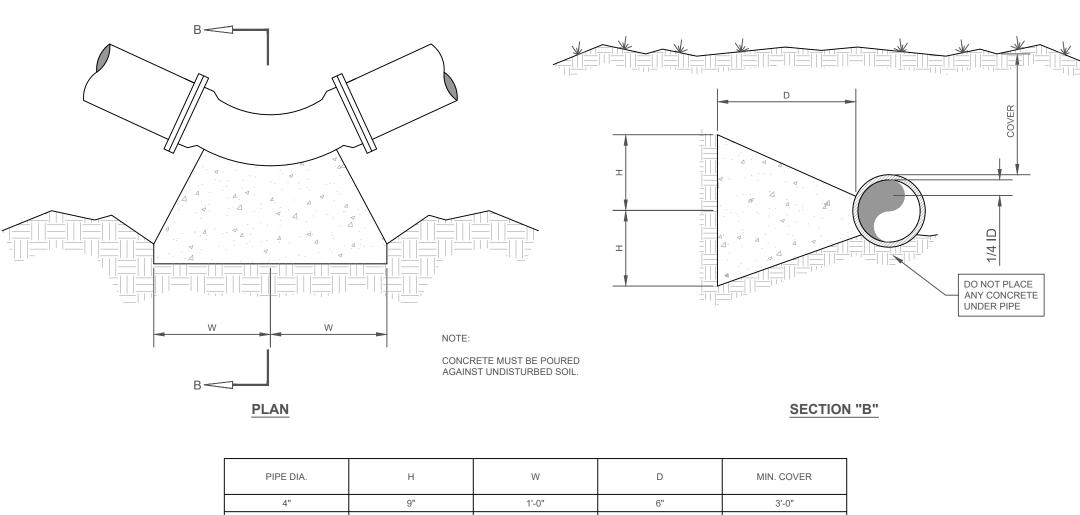

PIPE DIA.	Н	W	D	MIN. COVER
4"	9"	1'-0"	6"	3'-0"
6"	9"	1'-3"	9"	3'-0"
8"	1'-0"	1'-6"	1'-0"	3'-0"
10"	1'-6"	1'-6"	1'-3"	3'-0"
12"	1'-6"	2'-3"	1'-6"	4'-0"
14"	1'-9"	2'-6"	1'-9"	4'-0"
16"	2'-3"	2'-6"	2'-0"	4'-0"
18"	2'-6"	3'-0"	2'-3"	4'-0"
20"	3'-0"	3'-0"	2'-6"	5'-0"
24"	3'-6"	3'-6"	3'-0"	5'-0"

TYPICAL 45° BEND THRUST BLOCK DETAIL
NO SCALE

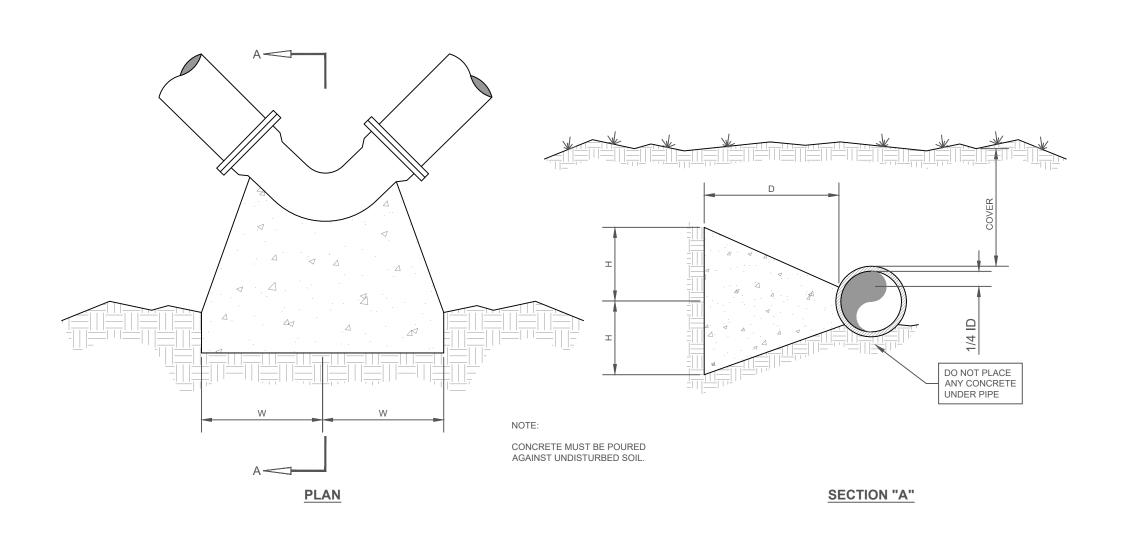

PIPE DIA.	н	W	D	MIN. COVER
4"	9"	1'-0"	1'-6"	3'-0"
6"	1'-0"	1'-6"	1'-6"	3'-0"
8"	1'-3"	2'-3"	1'-6"	3'-0"
10"	1'-8"	2'-6"	1'-6"	3'-0"
12"	2'-0"	3'-0"	1'-6"	4'-0"
14"	2'-3"	3'-9"	1'-9"	4'-0"
16"	2'-9"	4'-0"	2'-0"	4'-0"
18"	3'-0"	4'-6"	2'-3"	4'-0"
20"	3'-6"	4'-9"	2'-6"	5'-0"
24"	4'-3"	5'-0"	3'-0"	5'-0"

TYPICAL 90° BEND THRUST BLOCK DETAIL



SCALE: NOTED DATE:

JANUARY 2025

PROJ. NO.: 232301

DRAWN BY: CWJ


SHEET TITLE:

TYPICAL

DETAILS

SHEET NO.:


PLAN VIEW

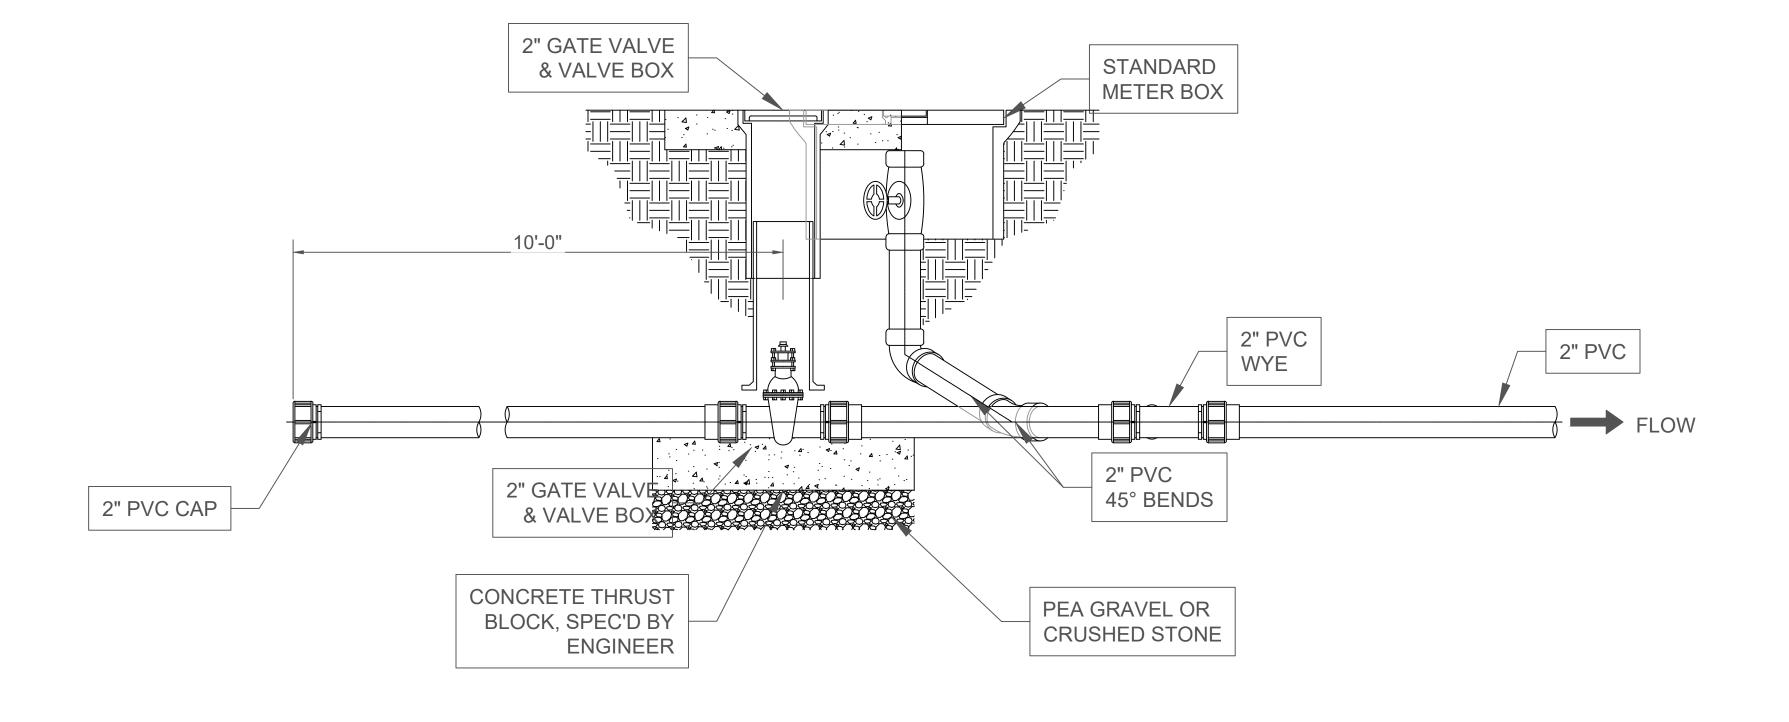

ELEVATION VIEW

END OF LINE BLOW-OFF DETAIL

NO SCALE

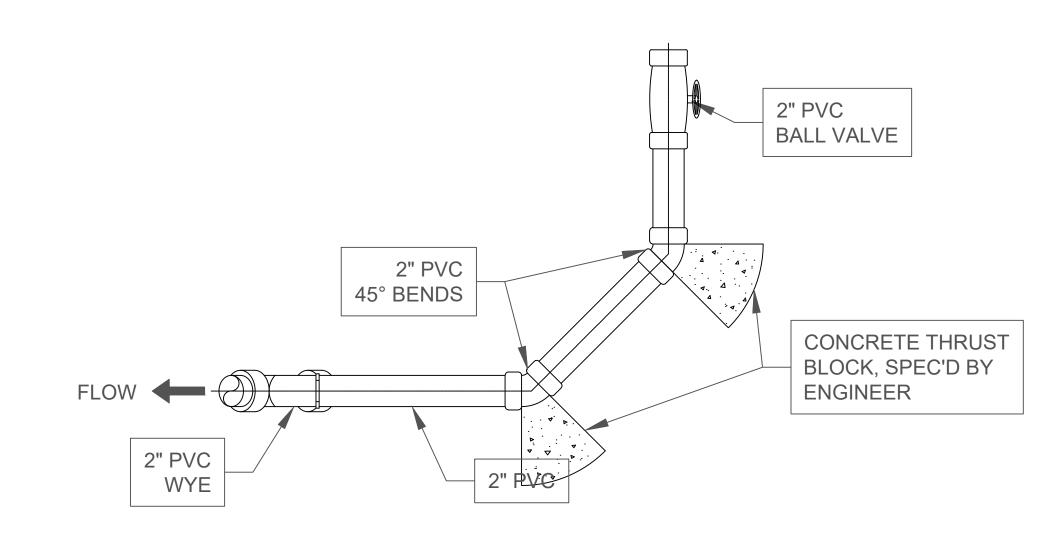

SECTION A-A





ALABAMA

CONSTRUCTION PLANS
DOGWOOD FARMS III

ARSHALL COLINTX

SCALE:
NOTED

DATE:

JANUARY 2025

PROJ. NO.: 232301

DRAWN BY: CWJ

SHEET TITLE:

TYPICAL


DETAILS

SHEET NO.:

VALVE CURB STOP W/ FEMALE PIPE
THREADS AND VALVE POSITION STOPS
(OPEN/CLOSED) W/ INTEGRAL CHECK VALVE
(BRASS)

TYPICAL CONNECTION DETAIL

NO SCALE

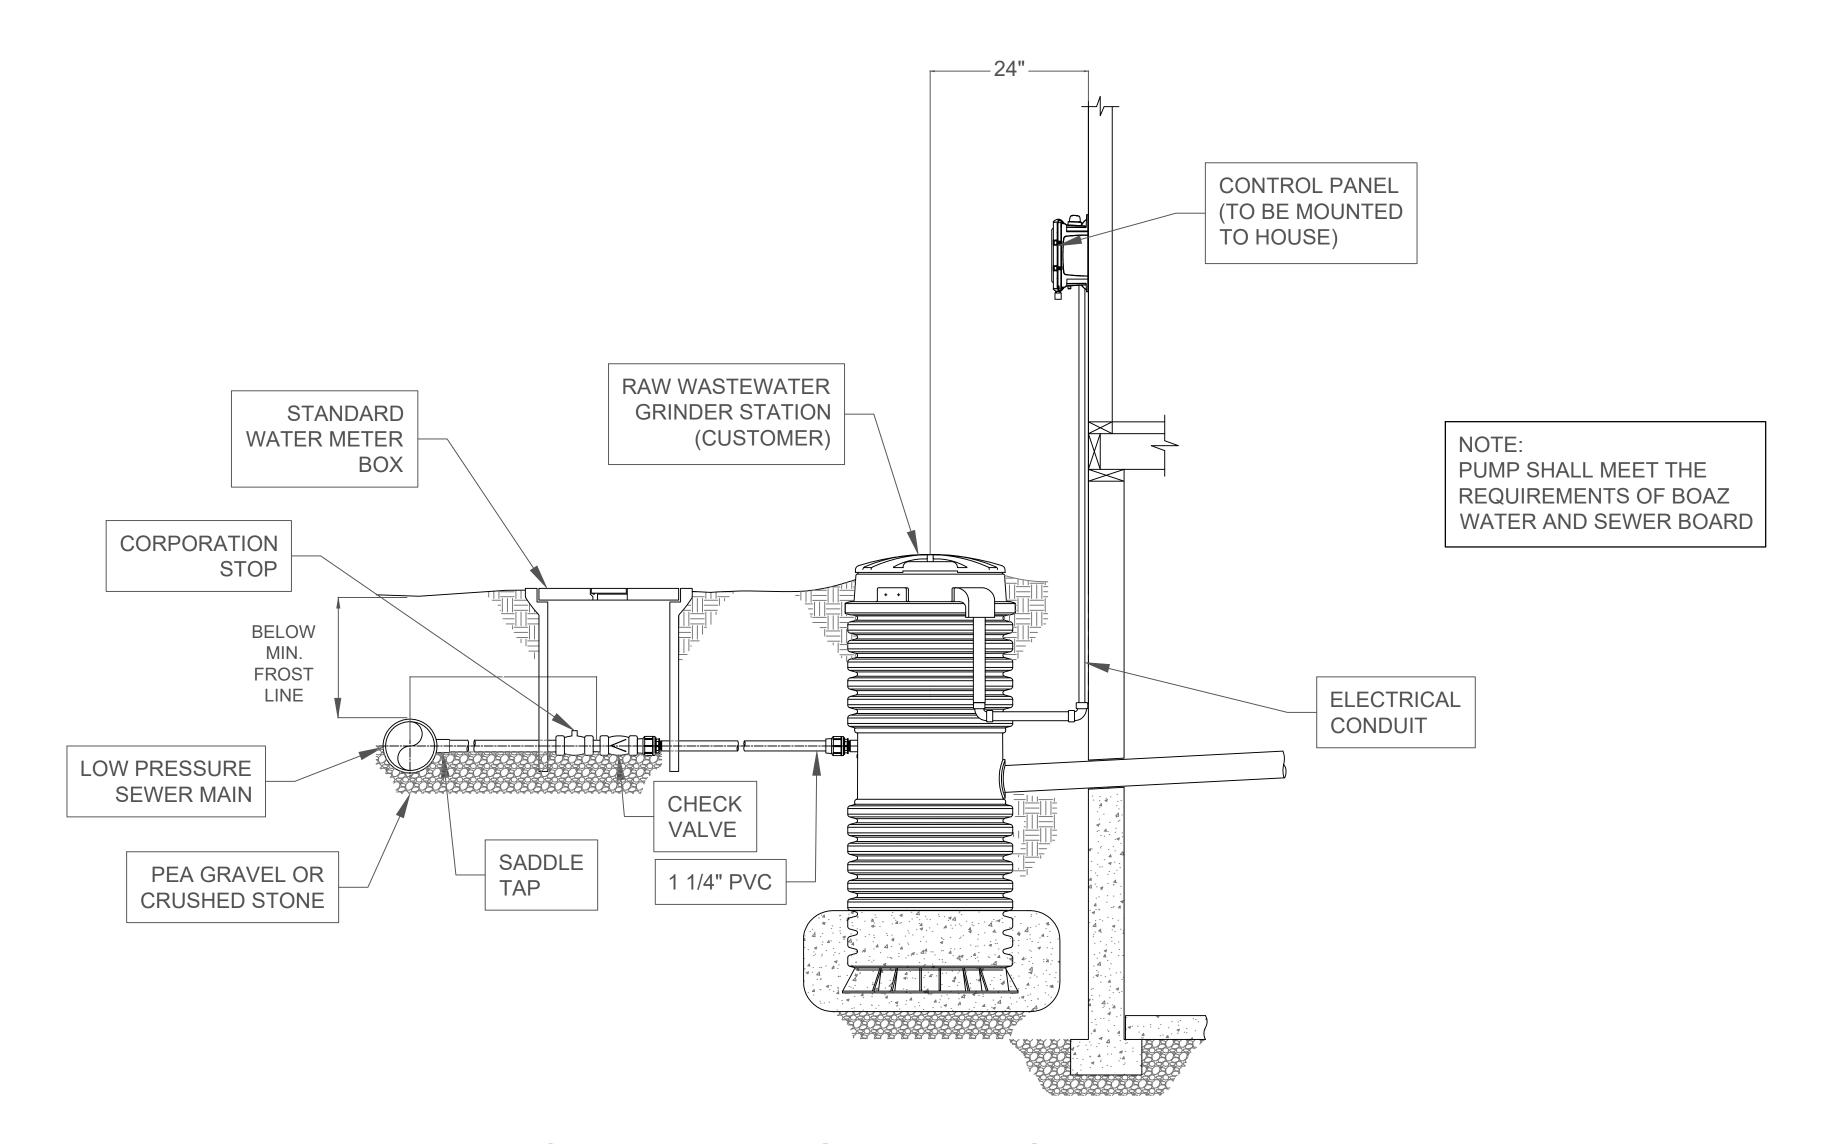

TYPICAL PUMP INSTALLATION

NO SCALE





ALABAMA

CONSTRUCTION PLANS
DOGWOOD FARMS III

RSHALL COUNTY

SCALE:

JANUARY 2025 PROJ. NO.:

DATE:

232301 DRAWN BY:

CWJ SHEET TITLE:

TYPICAL

DETAILS

SHEET NO.:

C-805

iitwood Projects\9 Dogwood Farms Phase III\Dogwood Farms III REDESIGN.dwg

