ISSUED FOR TOWN OF BLUFFTON, COFA, FINAL REVIEW

## SEWELL RESIDENCE

26 TABBY SHELL ROAD, TABBY ROADS, BLUFFTON, SC 29910

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DETAILS

**DETAILS** 


DOOR AND WINDOW SCHEDULE

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CH ELEC. PLANS

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#### **VICINITY MAP - N.T.S.**



#### **BUILDING AREA:**

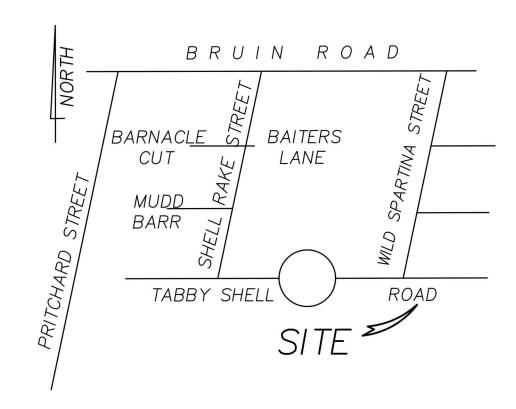GARAGE HT.	
HEATED AND COOLED	82
COVERED AND ENCLOSED	268
FIRST FLOOR HT.	
HEATED AND COOLED	1348
BONUS HT.	
HEATED AND COOLED	268
SECOND FLOOR HT.	
HEATED AND COOLED	609
TOTAL COVERED AND ENCLOSED	268
TOTAL HEATED AND COOLED	2307
Total Gross Area (H/C & C/E)	2575

### PROJECT INFORMATION:

26 TABBY SHELL ROAD, TABBY

ROADS, BLUFFTON, SC 29910

<u>(843) 757-7411</u>

NAME OF PROJECT:

ADDRESS:

OWN	•	ACT PERSON: MENT JURISDICTION:	DAVI	 y residence Jsan sewell Junty	
		RESIDENTIAL CODE (IRC ENERGY CONSERVATIO	•	2021 2021	
<u>DES</u>	IGNER (	OF RECORD:			
DESIG Archite Electric Plumbi Mecho Structu Civil	ectural cal ing anical	NAME COURT ATKINS ARCHI	<u>rects</u>	#100019	 PHONE NO. 3) 815-2557

#### **BUILDING DATA:**

WHITMER JONES KEEFER

OCCUPANCY CLA	ASSIFICA	TION: RI	ESIDENTI	AL GROU	P R-3	
MIXED OCCUPAN	ICY:	Yes		No <u>X</u>		Separation Hr.
CONSTRUCTION III-A		I-A IV	I-B V-A	II-A V-B	II-B	
MIXED CONSTRU	CTION:		Yes		No_	<u>Х</u> Туре
SPRINKLERED:			Yes		No_	Χ
FIRE DISTRICT:			Yes		No_	<u>X</u>
BUILDING HEIGH	T:		28'-6" A	4.F.F		Number of Stories: 2
MEZZANINE:			Yes		No_	Χ
HIGH RISE:			Yes		Nο	Χ

NOTE TO GENERAL CONTRACTORS: THESE DRAWINGS HAVE BEEN PRODUCEDUNDER A LIMITED SERVICES AGREEMENT BETWEEN THE OWNER/OWNER'SREPRESENTATION

- THE ARCHITECT'S DRAWINGS CANNOT STAND ALONE AS CONSTRUCTION DOCUMENTS.
- SEE STRUCTURAL ENGINEERING DOCUMENTS FOR STRUCTURAL CONNECTION TECHNIQUES, CALCULATIONS REQUIRED BY CODE, CODE COMPLIANCE INSTRUCTIONS FOR WALL AND ROOF CONSTRUCTION, AND
- SEPARATE MECHANICAL, ELECTRICAL, AND PLUMBING ENGINEERING RISER DIAGRAMS, CALCULATIONS AND INSTALLATION SPECIFICATIONS
- SEPARATE CIVIL ENGINEERING DOCUMENTS MAY BE PROVIDED, WHICH
- SELECTIONS NOT INCLUDED IN THESE DOCUMENTS WILL BE COORDINATED
- REPRESENTED HEREIN, THE OWNER AGREES TO LIMIT THE LIABILITY OF THE ARCHITECT TO THE OWNER OF THE PROJECT FOR ALL AND ANY CLAIMS, LOSSES, DAMAGES OR ANY NATURE WHATSOEVER, OR CLAIMS OF EXPENSES FOR ANY SUCH ITEMS TO THE ARCHITECTS TOTAL COMPENSATION FOR SERVICES RENDERED HEREIN.
- THESE DOCUMENTS ARE THE WORK INSTRUMENTS OF THE ARCHITECT AND HAVE BEEN PREPARED SPECIFICALLY AND SOLELY FOR THE PROJECT NAMED HEREIN. THEY ARE NOT SUITABLE FOR USE ON OTHER PROJECTS OR IN OTHER LOCATIONS WITHOUT THE PARTICIPATION OF THE ARCHITECT. REPRODUCTION IS STRICTLY PROHIBITED. THE ARCHITECT SHALL BE DEEMED THE AUTHOR AND OWNER OF THESE DOCUMENTS AND SHALL RETAIN COMMON LAW, STATUTORY AND OTHER RESERVED RIGHTS, INCLUDING THE
- THE ARCHITECT HAS NOT BEEN CONTRACTED TO PERFORM CONSTRUCTION ADMINISTRATION/ ON-SITE OBSERVATION FOR THIS PROJECT.
- FOR DIMENSIONS NOT SHOWN OR IN QUESTION, THE CONTRACTOR WILL
- CONTRACTOR WILL VERIFY ALL EXISTING CONDITIONS IN THE FIELD-ANY
- THE CONTRACTOR SHALL MAINTAIN AT THE SITE OF THE WORK, A SET OF RECORD DRAWINGS. THE CONTRACTOR SHALL RECORD ALL CHANGES AND DEVIATIONS FROM THE DRAWINGS ON THIS "AS-BUILT" SET, WHICH SHALL BE UPDATED AT LEAST EVERY OTHER WEEK. AT THE CLOSE OF THE JOB, THE CONTRACTOR SHALL PROVIDE ONE COMPLETE SET OF ALL AS-BUILT INFORMATION TO THE ARCHITECT IN CLEAR AND LEGIBLE FORMAT.
- IDENTIFICATION SIGN SHALL IDENTIFY THE PROJECT, THE ARCHITECT AND THE
- REPRESENTATIONS OF SUCH CONDITIONS.
- WHEN ARCHITECTURAL DRAWINGS ARE IN CONFLICT WITH ENGINEERING DRAWINGS THE GENERAL CONTRACTOR SHALL REQUEST CLARIFICATION FROM THE ARCHITECT BEFORE PROCEEDING.

THIS WRITTEN NOTICE REQUIRED BY SOUTH CAROLINA REGULATIONS TO THE PERMITTING AUTHORITY AND BUILDING OWNER THAT THE ARCHITECTS WILLIAM COURT AND JAMES ATKINS HAVE NOT BEEN HIRED TO PROVIDE MINIMUM CONSTRUCTION ADMINISTRATION SERVICES ON THE FOLLOWING PROJECT.

LEAST MINIMUM CONSTRUCTION ADMINISTRATION SERVICES, AS DEFINED IN NOT BEEN SO ENGAGED.

(5) THE MINIMUM CONSTRUCTION ADMINISTRATION SERVICES EXPECTED OF THE SEALING ARCHITECT AND FIRM DEEMED NECESSARY TO PROTECT THE HEALTH, SAFETY, AND WELFARE OF THE PUBLIC SHALL BE PERIODIC SITE OBSERVATIONS OF THE CONSTRUCTION PROGRESS AND QUALITY, REVIEW OF CONTRACTOR SUBMITTAL DATA AND DRAWINGS, AND REPORTING TO THE BUILDING OFFICIAL AND OWNER ANY VIOLATIONS OF CODES OR SUBSTANTIAL DEVIATIONS FROM THE CONTRACT DOCUMENTS WHICH THE ARCHITECT OBSERVED.

#### **GENERAL NOTES:**

AND COURT ATKINS ARCHITECTS, INC. THEY ARE TO BE USEDFOR DESIGN INTENT AND IN COORDINATION WITH SUPPLEMENT ENGINEERING DOCUMENTS.

- TIE DOWN REQUIREMENTS.
- DOCUMENTS MAY BE PROVIDED, WHICH INDICATE REQUIRED SERVICEAND BEYOND THE ARCHITECTS BASIC LAYOUT AND SELECTIONS SUGGESTIONS.
- INDICATE ADDITIONAL SITE PLANNING, DRAINAGE, AND OTHER RELATED SITE WORK REQUIREMENTS.
- BY THE OWNER/ OWNER'S REPRESENTATIVES.
- BY APPLYING FOR A BUILDING PERMIT AND/OR CONSTRUCTING THE PROJECT
- REQUEST CLARIFICATION FROM THE ARCHITECT BEFORE PROCEEDING.
- DISCREPANCIES WILL BE BROUGHT TO THE ATTENTION OF THE ARCHITECT.
- SIGNS SHALL BE LIMITED TO THE PROJECT IDENTIFICATION SIGN. THE CONTRACTOR.
- INFORMATION CONTAINED ON THESE DRAWINGS IS PROVIDED FOR THE CONVENIENCE OF THE GENERAL CONTRACTOR IN EXECUTING THE WORK. EVERY ATTEMPT HAS BEEN MADE TO PROVIDE COMPLETE AND ACCURATE

#### **CONSTRUCTION ADMIN.:**

REGULATION 11-12.B.4 AND 5 STATE:

(4) ON A PROJECT WHERE A BUILDING PERMIT HAS BEEN ISSUED AND THE SEALING ARCHITECT AND THE FIRM OF RECORD HAVE NOT BEEN ENGAGED TO PERFORM AT SUBSECTION (5) BELOW, THE SEALING ARCHITECT AND FIRM MUST REPORT TO THE PERMITTING AUTHORITY AND THE BUILDING OWNER THAT HE AND THE FIRM HAVE

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PROJECT INFO Date

12/06/2023 Project No.

NO. REV. DATE DESCRIPTION

SHEET TITLE





## **ABBREVIATIONS**

AB	anchor bolt	JNT	JOINT
ABV	ABOVE	KS	KNEE SPACE
AFF	ABOVE FINISH FLOOR	LAM	LAMINATE
ASF	ABOVE SUBFLOOR	LL 	LIVE LOAD
A/C	AIR CONDITIONER	LT	LIGHT
AHU	AIR HANDLING UNIT	LIN	LINEN
ALUM	ALUMINUM	MA	MASONITE
AMSL APPROX	ABOVE MEAN SEA LEVEL APPROXIMATE	MAS MAX	MASONRY MAXIMUM
A/V	AUDIO/VISUAL	MECH	MECHANICAL
BD BD	BOARD	MED	MEDIUM
BF	BI-FOLD	MFR	MANUFACTURER
BLKG	BLOCKING	MID	MIDDLE
BLDG	BUILDING	MIN	MINIMUM
B.O.	BOTTOM OF	MISC	MISCELLANEOUS
BOD	BASIS OF DESIGN	MUL	MULLION
BRG	BEARING	N/A	NOT APPLICABLE
BTW	BETWEEN	N.I.C.	NOT IN CONTRACT
CAB	CABINET	NTS	NOT TO SCALE
CANT	CANTILEVER	OC	ON CENTER
CEN CJ	CENTER CEILING JOIST	OH OPNG	overhang opening
CL	CENTERLINE	OSB	ORIENTED STRAND BOARD
CLG	CEILING	PEMB	PRE-ENGINEERED METAL BLDC
CO	CASED OPENING	PL	PLATE
COL	COLUMN	PNL	PANEL
CONC	CONCRETE	PNT	PAINT
CT	CERAMIC TILE	PR	PAIR
DBL	DOUBLE	PT	PRESSURE TREATED
DEMO	DEMOLISH	PVC	POLYVINLYCHLORIDE
DH	DOUBLE HUNG	PVMT	PAVEMENT
DIA	DIAMETER	PLY	PLYWOOD
DIM	DIMENSION	PWDR	POWDER ROOM
DIST	DISTANCE	R	RISER
DN	DOWN	R & S	ROD & SHELF
DP DR	DESIGN PRESSURE DOOR	RAG REF	RETURN AIR GRILL REFRIGERATOR
DW	DISHWASHER	REQ'D	REQUIRED
DWG	DRAWING	RM	ROOM
EA	EACH	R.O.	ROUGH OPENING
ELEV	ELEVATION	RV	RIDGE VENT
ELEC	ELECTRICAL	SCHED	SCHEDULE
EQ	EQUAL	SECT	SECTION
EQUIP	EQUIPMENT	SF	SQUARE FEET
EXST	EXISTING	SH	SHELF
EXT	EXTERIOR	SIM	SIMILAR
FD FDTN	FLOOR DRAIN FOUNDATION	SPEC SQ	SPECIFICATION SQUARE FEET
FF	FIRST FLOOR	STD	STANDARD
FFE	FINISH FLOOR ELEVATION	STL	STEEL
FIN	FINISH	STOR	STORAGE
FIX	FIXTURE	SYS	SYSTEM
FIXT	FIXTURE	T	TREAD
FLUOR	FLUORESCENT	T.B.D.	to be determined
FLR	FLOOR	TR	TREAD
FRZ	FREEZER	T & G	TONGUE & GROOVE
FRMG	FRAMING	TEL	TELEPHONE
FT	FEET	TEMP	TEMPORARY/TEMPERATURE
FTG	FOOTING	THK	THICK
GA GALV	GAUGE GALVANIZE	T.O. TV	TOP OF TELEVISION
G.C.	GENERAL CONTRACTOR	TYP	TYPICAL
GFI	GROUND FAULT INTERRUPTER	UC	UNDERCOUNTER
GL	GLASS	UNFIN	UNFINISHED
GYP	GYPSUM	U.N.O.	UNLESS NOTED OTHERWISE
НВ	HOSE BIBB	U.O.N.	UNLESS OTHERWISE NOTED
HDR	HEADER	VB	VAPOR BARRIER
HORIZ	HORIZONTAL	VER	VERIFY
HT	HEIGHT	V.I.F.	VERIFY IN FIELD
HVAC	HEATING, VENTILATION & AIR CONDTIONING	VERT	VERTICAL
IN	INCH	W/D	WASHER-DRYER
incl Insul	INCLUDE INSULATION	WH WWF	WATER HEATER
INSUL	INSULATION INTERIOR	Y	WELDED WIRE FABRIC
IRC	INTERNATIONAL RESIDENTIAL CODE		

#### TYP. RESTROOM CLEARANCES


MINIMUM DIMENSIONS TAKEN FROM FINISH FACE. THIS INFORMATION IS FOR REFERENCE ONLY-SEE PLAN FOR ACTUAL DIMENSIONS

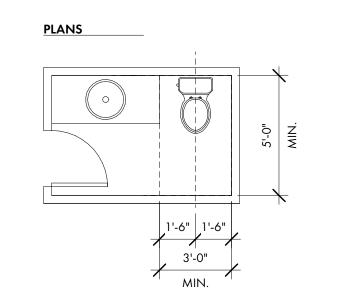


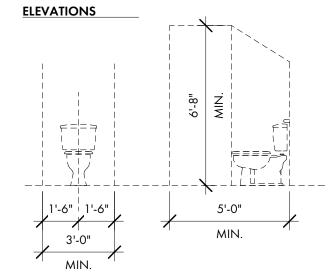

## STAIR CRITERIA


MINIMUM CRITERIA FOR INTERIOR STAIRS THIS INFORMATION IS FOR REFERENCE PURPOSES

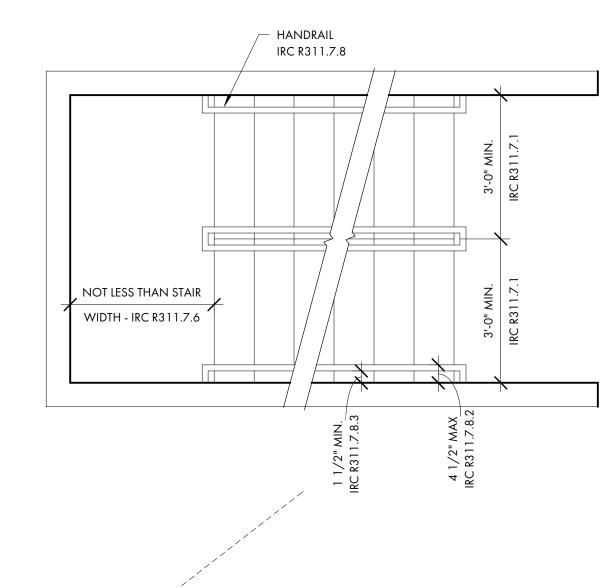


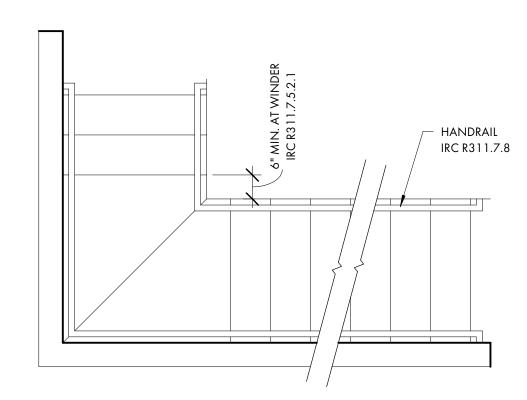

# 10" MIN. 1 1/4" MAX. - 3/4" MIN. IRC R311.7.5.3

**CLOSED RISER STAIR** 

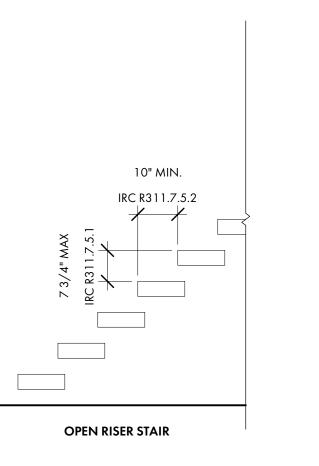

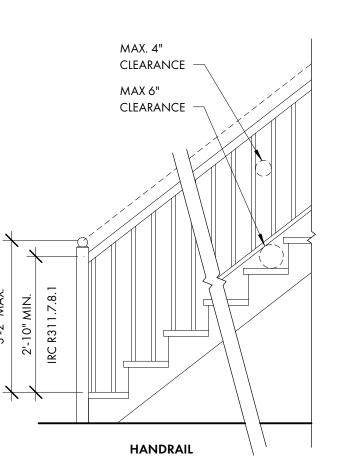


### REFERENCE SYMBOLS

JOIST

INTERNATIONAL RESIDENTIAL CODE

DETAIL CALLOUT

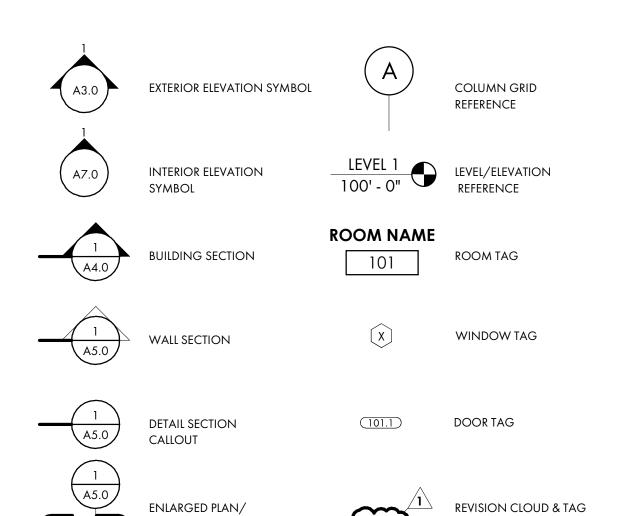

SHEET TITLE

GENERAL NOTES



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**PROJECT INFO** 

Date 12/06/2023

> Project No. 23-065

NO. REV. DATE DESCRIPTION

ISSUE

#### **SITE PLAN CALCS:**

TOTAL LOT AREA **BUILDABLE AREA** BUILDING FOUNDATION FOOTPRINT WALKS, DRIVES & DECKS(IMPERVIOUS) IMPERVIOUS COVER (LOT AREA) IMPERVIOUS TO LOT RATIO

5,541 SQ. FT. 3,404 SQ. FT. 2,489 SQ. FT. 35 SQ. FT. 2,524 SQ. FT. 45.8 %

#### **SITE PLAN NOTES:**

OWNER TO PROVIDE TREE AND TOPOGRAPHIC SURVEY W/ FLOOD PLAIN INFORMATION UNDER SEPARATE COVER.

GENERAL CONTRACTOR NOTE: ADJUST TOP OF SLAB, WALL, AND ROOF BEARING PLATES AS REQUIRED FOR CHANGES IN STRUCTURAL MEMBER SIZES OR EXISTING SITE CONDITIONS.

GRADING INFORMATION IS INCLUDED FOR SCHEMATIC REFERENCE ONLY. LANDSCAPE ARCHITECT TO PROVIDE GRADING AND DRAINAGE PLANS IN ACCORDANCE WITH NEIGHBORHOOD GUIDELINES.


SITE PLAN LOCATION AND DIMENSIONS ARE APPROXIMATE. G.C. TO COORDINATE ACTUAL BUILDING LOCATION WITH FOUNDATION AND FRAMING PLANS.

SEE COVER PAGE FOR NOTES AND LIMITATIONS TO ARCHITECTURAL SCOPE OF SERVICES.

TREE BARRICADE PROCEDURES: ALL TREES TO BE PROTECTED WITH A 5'-0" HIGH FENCE FRAMED WITH 2x4'S AND ORANGE PROTECTION MATERIAL (ALL TREES WHERE BARRICADING IS INDICATED).

### SEE LANDSCAPE PLANS FOR FINAL: SITE MOBILIZATION & TREE PROTECTION

GRADING TREE REMOVAL DRIVE, WALK & TERRACE LAYOUTS HARDSCAPE DETAILS

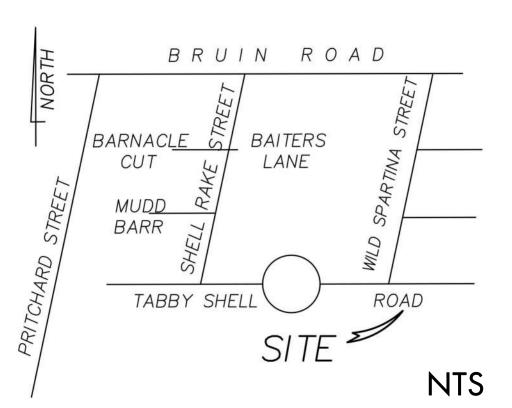

#### LEGEND

- 1. THIS LOT LIES IN ZONE "X", NO B.F.E. PER F.I.R.M. PANEL 45013C 0426 G, COMMUNITY No. 450251, EFFECTIVE: 03/23/21.
- THIS SURVEY DOES NOT CONSTITUTE A TITLE SEARCH BY THE SURVEYOR. NO INVESTIGATIONS FOR EASEMENTS, ENCUMBRANCES, RESTRICTIVE COVENANTS, OWNERSHIP TITLE EVIDENCE, OR ANY OTHER FACTS HAVE BEEN MADE THAT AN ACCURATE AND CURRENT TITLE SEARCH MAY DISCLOSE.
- 3. ALL BUILDING SETBACK REQUIREMENTS SHOULD BE VERIFIED WITH THE PROPER AUTHORITIES PRIOR TO DESIGN AND CONSTRUCTION.
- 4. CERTIFICATIONS ARE NOT TRANSFERABLE TO ADDITIONAL INSTITUTIONS OR SUBSEQUENT OWNERS.

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PROJECT INFO

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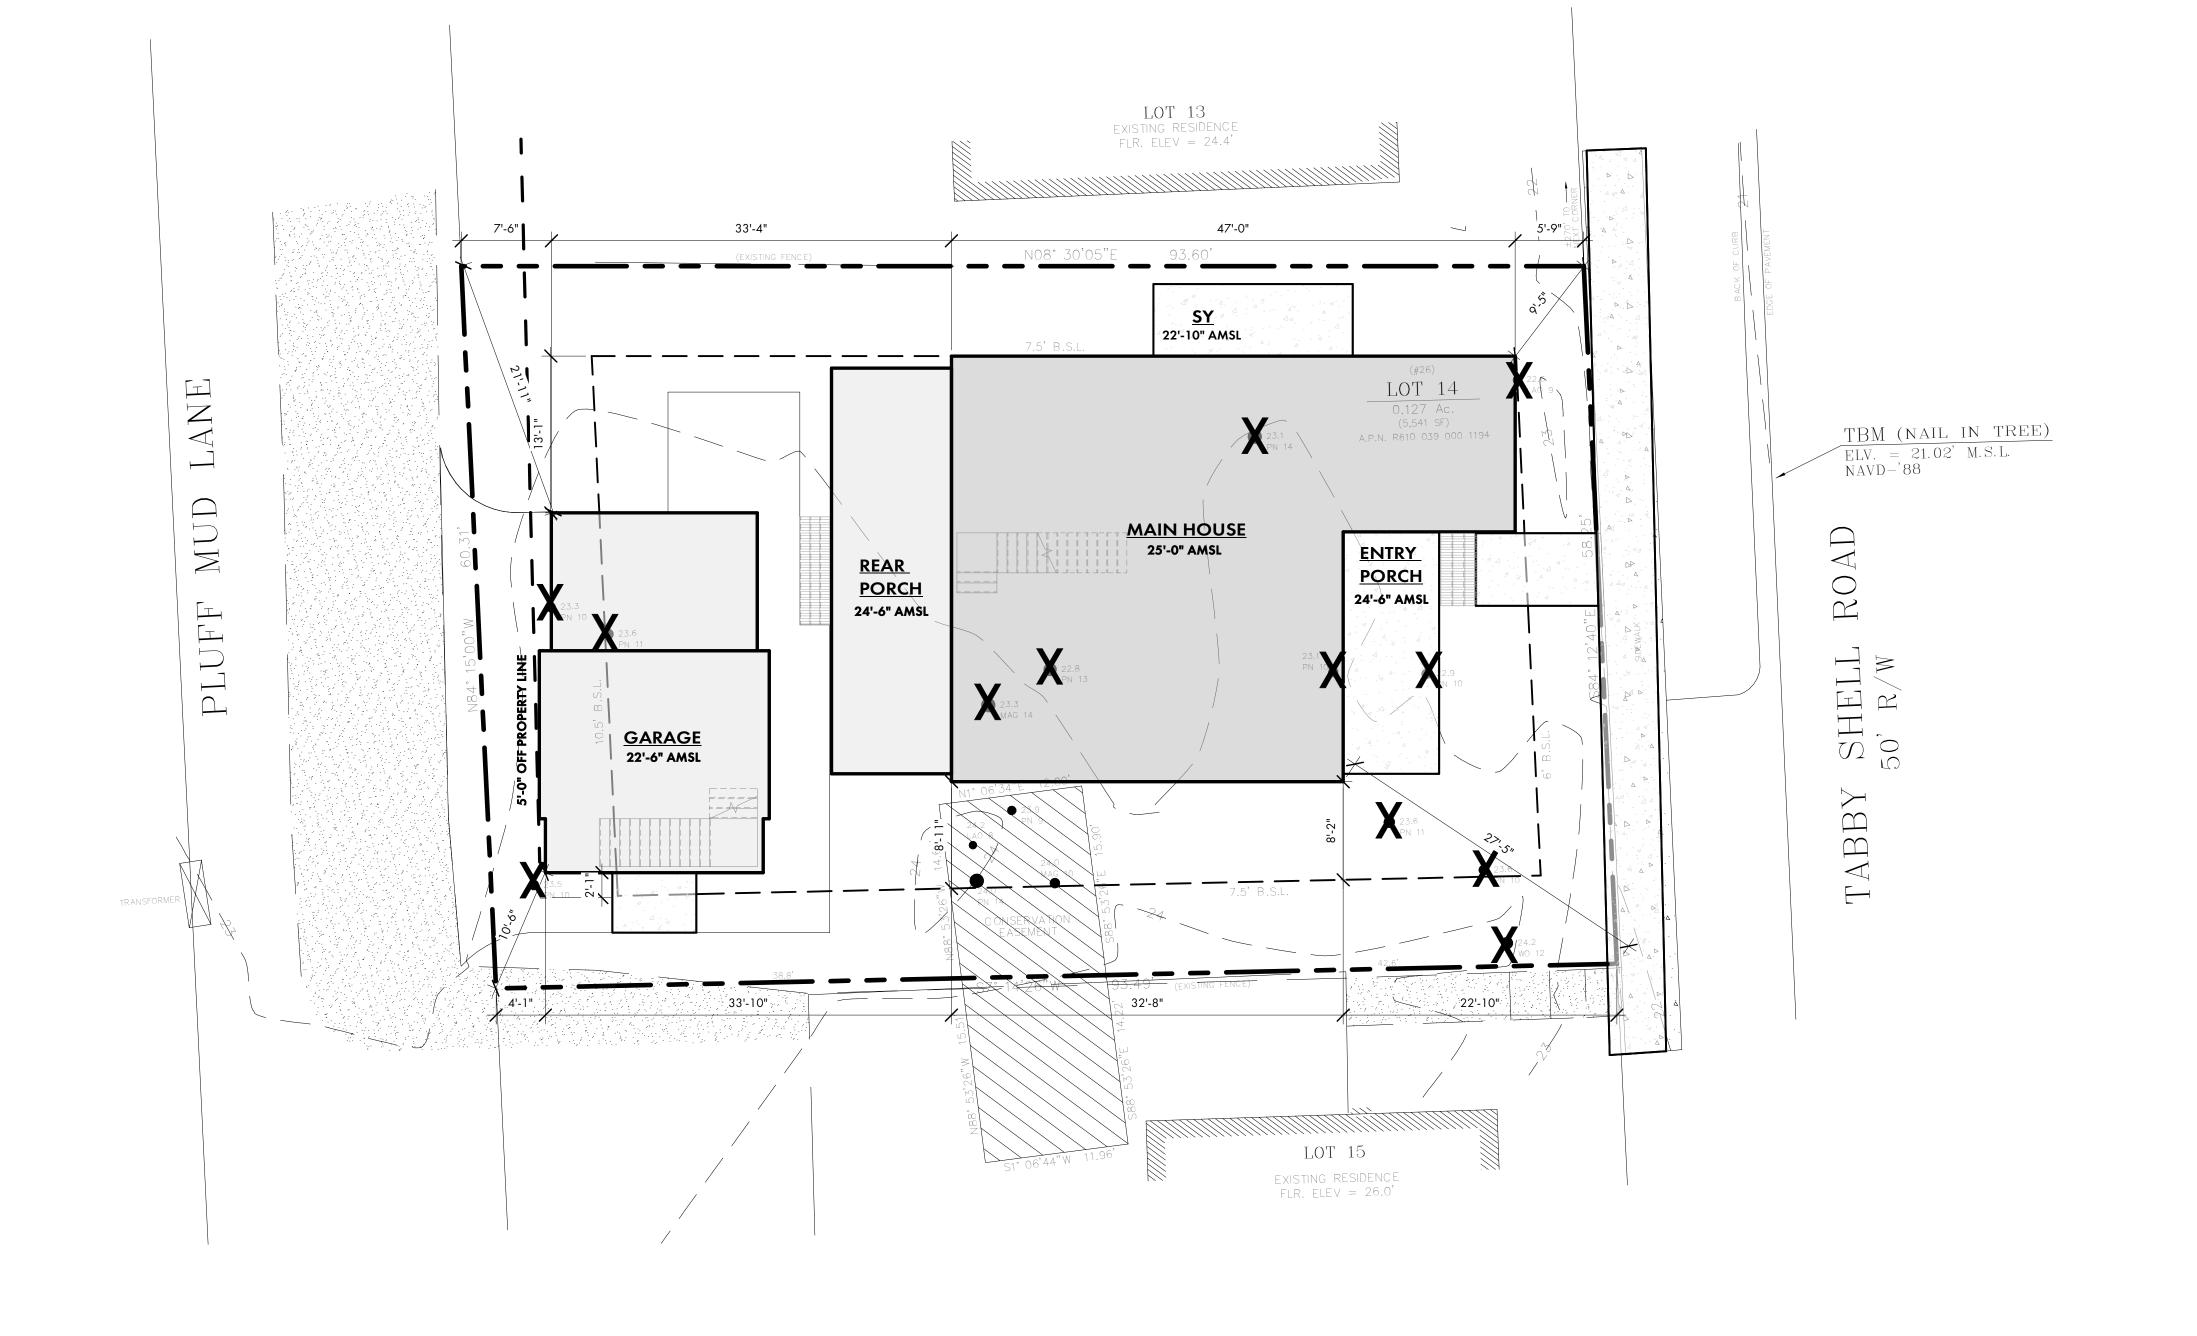
Project No. 23-065

**ISSUE** 

NO. REV. DATE DESCRIPTION

SHEET TITLE

SITE PLAN





FOUNDATION PLAN NOTES:

SEE COVER PAGE FOR NOTES AND LIMITATIONS TO ARCHITECTURAL SCOPE OF SERVICES.

GENERAL CONTRACTOR NOTE:

ADJUST TOP OF SLAB, WALL, AND ROOF BEARING PLATES AS
REQUIRED FOR CHANGES IN STRUCTURAL MEMBER SIZES OR
EXISTING SITE CONDITIONS.

G.C. / OWNER TO COORDINATE ALL IN-SLAB ELECTRICAL AND PLUMBING REQUIREMENTS WITH APPROPRIATE SUBCONTRACTOR TRADES PRIOR TO PLACING SLAB.

DIMENSION NOTES:

ALL DIMENSIONS ARE TO EDGE OF SLAB, BLOCK, AND FRAMING AND ARE INDEPENDENT FROM ALL BRICK LEDGES U.N.O. G.C. TO COORDINATE SIZE AND LOCATIONS OF ADDITIONAL BRICK LEDGES WITH PLANS, ELEVATIONS, AND DETAILS.

DO NOT SCALE DRAWINGS. CONTACT ARCHITECT WITH ANY DISCREPANCIES.

FOUNDATION NOTES:

STRUCTURAL ENGINEERING DOCUMENTS SUPERCEDE ARCH.
DOCUMENTS AND SCHEDULES WITH REGARD TO SIZE OF
STRUCTURAL MEMBERS, PLACEMENT, AND CONNECTION DETAILS.

UNLESS OTHERWISE NOTED BY TYPICAL WALL SECTIONS, STRUCTURAL ENGINEER, OR STRUCTURAL DRAWINGS, FOUNDATION IS TO BE AS FOLLOWS:

AT ALL RETAINING/FOUNDATION WALL LOCATIONS WITH FILL, WALLS TO BE CMU WITH BITUMINOUS COATING AND VERTICAL DRAINAGE MAT (ENKADRAIN) ON THE DIRT SIDE, GRAVEL BASE, AND DRAINAGE PIPE WITH SLEEVE DISCHARGE TO EXTERIOR. SLOPE ALL WATER/DRAINAGE TO EXTERIOR OF RETAINING WALL.

#### TYPICAL THICKENED SLAB:

THICKENED SLAB AT CRITICAL BEARING POINTS IS TO BE A MINIMUM OF 1'-0" DEEP BY 1'-8" WIDE, CENTERED ON WALL, UNLESS OTHERWISE NOTED, WITH (2) #5 REINFORCING BARS, CONTINUOUS WITH 6x6 W.W.F. SUPPORT REINFORCING DURING CONCRETE PLACEMENT PER IRC R506.2.4.

#### TYPICAL CONNECTING/CONTINUOUS GRADE BEAM:

FOOTINGS AT CONNECTING GRADE BEAM ARE TO BE 12" DEEP x 36" WIDE, CAST IN PLACE CONCRETE WITH (2) #5 REINFORCING BARS, CONTINUOUS. SEE STRUCTURAL ENGINEERING DOCUMENTS FOR GRADE BEAM/FOOTING CONNECTION DETAILS. SUPPORT REINFORCING DURING CONCRETE PLACEMENT PER IRC R506.2.4.

#### TYPICAL SLAB ON GRADE:

SLAB ON GRADE TO BE 4" THICK, CAST IN PLACE CONCRETE ON 6 MIL. POLYETHYLENE VAPOR BARRIER WITH MINIMUM 16"x20" (20"x20" AT ANY TWO STORY LOCATIONS) TURNED DOWN EDGE (EXTENDING MINIMUM 1'-0" INTO UNDISTURBED SOIL) WITH (2) #5 REINFORCING BARS, CONTINUOUS AND 6x6 10/10 W.W.F. SUPPORT REINFORCING DURING CONCRETE PLACEMENT PER IRC R506.2.4.

**NOTE:** ALL TOP OF WALL NOTES ARE TO THE TOP OF BLOCK WALLS, U.N.O. (SEE DETAILS FOR FINISHES)

#### FOUNDATION PLAN - SYMBOL KEY

8" CMU WALL

6" CMU PLANTER WALL

4" CMU WALL

BRICK VENEER

CONCRETE TURN-DOWN EDGE / THICKENED SLAB / CMU FOOTING

BACKFILL DIRT

CONCRETE SLAB

----- ENG. BEAM BY OTHERS TYP.

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#### PROJECT INFO

Date 12/06/2023

Project No. 23-065

**ISSUE** 

NO. REV. DATE DESCRIPTION

SHEET TITLE

FOUNDATION PLAN

A2.0



GENERAL CONTRACTOR NOTE:

ADJUST TOP OF SLAB, WALL, AND ROOF BEARING PLATES AS REQUIRED FOR CHANGES IN STRUCTURAL MEMBER SIZES OR existing site conditions.

GC/OWNER TO COORDINATE ALL IN-SLAB ELECTRICAL AND PLUMBING REQUIREMENTS WITH APPROPRIATE SUBCONTRACTOR TRADES PRIOR TO PLACING SLAB.

**DIMENSION NOTES:** 

DIMENSIONS ARE TO THE EDGE OF FOUNDATION AND

FRAMING, U.O.N.. DO NOT SCALE DRAWINGS. CONTACT ARCHITECT WITH ANY DISCREPANCIES.

**CABINET & EQUIPMENT NOTES:** 

CABINET LAYOUTS ARE PROVIDED FOR DESIGN CONFIGURATION ONLY. EXACT LAYOUT AND PLACEMENT OF FIXTURES, APPLIANCES, CABINETS, AND COUNTERTOPS ARE TO BE DETERMINED IN COORDINATION WITH OWNER AND GENERAL CONTRACTOR.

#### FINISH NOTES:

FLOOR, WALL, CEILING, FINISHES AND INTERIOR TRIM ARE TO BE DETERMINED BY THE GENERAL CONTRACTOR AND OWNER. GENERAL CONTRACTOR TO ADJUST SLAB, WALLS, AND CEILING TO ACCOMMODATE OWNER SPECIFIC FINISHES AND TRIM.

FLOOR, WALL, CEILING, AND FINISHES ARE AS NOTED ON FINISH SCHEDULE - SEE SHEET A8.0. GENERAL CONTRACTOR TO ADJUST SLAB, WALLS, AND CEILING TO ACCOMMODATE OWNER SPECIFIC FINISHES AND TRIM.

#### PLUMBING NOTES: G.C. / OWNER TO COORDINATE LOCATION OF EXTERIOR HOSE

#### FRAMING NOTES:

STRUCTURAL ENGINEERING DOCUMENTS SUPERSEDE ARCHITECTURAL DOCUMENTS AND SCHEDULES WITH REGARD TO SIZE OF STRUCTURAL MEMBERS, PLACEMENT, AND CONNECTION DETAILS.

DOOR OPENINGS SET 6" OFF INTERSECTING WALL, UNLESS OTHERWISE DIMENSIONED.

UNLESS OTHERWISE NOTED BY TYPICAL WALL SECTIONS, STRUCTURAL ENGINEER, OR STRUCTURAL DRAWINGS.

#### FRAMING IS TO BE AS FOLLOWS:

EXTERIOR: 1/2" PLYWOOD SHEATHING (EXTERIOR SIDE) ON 2x6'S AT 16" O.C. WITH BLOCKING AT MIDSPAN.

INTERIOR: 2x4'S AND 2x6'S AT 16" O.C. WITH BLOCKING AT MIDSPAN.

#### FIRST FLOOR SYSTEM:

CONCRETE SLAB FLOOR WITH 3/4" T&G PLYWOOD, GLUED AND NAILED ON P.T. 1x4 SLEEPER SYSTEM WITH VAPOR BARRIER.

#### SECOND FLOOR SYSTEM:

3/4" T&G PLYWOOD, GLUED AND NAILED ON 10" OPEN WEB WOOD TRUSS SYSTEM (LAYOUT AND SPACING BY STRUCTURAL ENG). SEE TYPICAL WALL SECTIONS AND DETAILS FOR VARIOUS CONNECTION DETAILS, NOTE: IF TRUSS JOISTS (OR SIM.) ARE USED IN LIEU OF SPECIFIED MATERIALS, TRUSS MANUFACTURER IS TO PROVIDE SHOP DRAWINGS, SUPPORT AND CONNECTION DETAILS, AND BEAM SIZES FOR ARCHITECT/ENGINEER APPROVAL.

#### BONUS ROOM FLOOR SYSTEM:

3/4" T&G PLYWOOD, GLUED AND NAILED ON 12" OPEN WEB WOOD TRUSS SYSTEM (LAYOUT AND SPACING BY STRUCTURAL ENG). SEE TYPICAL WALL SECTIONS AND DETAILS FOR VARIOUS CONNECTION DETAILS. TRUSS MANUFACTURER IS TO PROVIDE SHOP DRAWINGS, SUPPORT AND CONNECTION DETAILS, AND BEAM SIZES FOR ARCHITECT/ENGINEER APPROVAL.

#### PORCH FLOOR SYSTEM:

CONCRETE SLAB FLOOR WITH TABBY FLOOR FINISH AND BRICK EDGING. SEE TYPICAL WALL SECTIONS AND DETAILS FOR VARIOUS CONNECTION DETAILS.

#### ATTIC FLOOR SYSTEM: (ONLY EXTENT TO BE DETERMINED BY

3/4" T&G PLYWOOD, GLUED AND NAILED ON 2x12'S AT 16" O.C. SEE TYPICAL WALL SECTIONS AND DETAILS FOR VARIOUS CONNECTION DETAILS. NOTE: IF TRUSS JOISTS (OR SIM.) ARE USED IN LIEU OF SPECIFIED MATERIALS, TRUSS MANUFACTURER IS TO PROVIDE SHOP DRAWINGS, SUPPORT AND CONNECTION DETAILS, AND BEAM SIZES FOR ARCHITECT/ENGINEER APPROVAL.

ATTIC CEILING JOISTS / PORCH CEILING: 2x8'S AT 16" O.C. (2x10'S FOR CERTAIN SPANS)

#### **ROOF RAFTERS:** EXT SHEATHING, NAILED ON 2x10'S WITH SIMPSON

HURRICANE CLIPS AT 16" O.C. SEE TYPICAL WALL SECTIONS FOR VARIOUS CONNECTION DETAILS. IF PRE-ENGINEERED WOOD ROOF TRUSSES ARE INSTALLED IN LIEU OF SPECIFIED MATERIALS, TRUSS MANUFACTURER IS TO PROVIDE SHOP DRAWINGS, SUPPORT AND CONNECTION DETAILS, AND SIZES FOR ARCHITECT/ENGINEER APPROVAL.

NOTE: SEE STRUCTURAL ENGINEERING DOCUMENTS FOR SIZE, LOCATION AND PLACEMENT OF ALL WORK DESCRIBED.

ALL DIMENSIONS ARE TO EDGE OF SLAB, BLOCK, AND FRAMING AND ARE INDEPENDENT FROM ALL BRICK LEDGES U.N.O. G.C. TO COORDINATE SIZE AND LOCATIONS OF ADDITIONAL BRICK LEDGES WITH PLANS, ELEVATIONS, AND DETAILS.


#### FLOOR PLAN - SYMBOL KEY

2 x 4 WALL WITH 1/2" GYPSUM WALLBOARD

EXISTING WALL TO REMAIN

2 x 6 WALL WITH 1/2" GYPSUM WALLBOARD

BRICKWORK

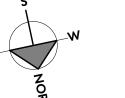

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Date 12/06/2023

Project No. 23-065

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FIRST FLOOR PLAN

GENERAL CONTRACTOR NOTE:

ADJUST TOP OF SLAB, WALL, AND ROOF BEARING PLATES AS REQUIRED FOR CHANGES IN STRUCTURAL MEMBER SIZES OR existing site conditions.

GC/OWNER TO COORDINATE ALL IN-SLAB ELECTRICAL AND PLUMBING REQUIREMENTS WITH APPROPRIATE SUBCONTRACTOR TRADES PRIOR TO PLACING SLAB.

**DIMENSION NOTES:** 

DIMENSIONS ARE TO THE EDGE OF FOUNDATION AND

FRAMING, U.O.N.. DO NOT SCALE DRAWINGS. CONTACT ARCHITECT WITH ANY DISCREPANCIES.

**CABINET & EQUIPMENT NOTES:** 

CABINET LAYOUTS ARE PROVIDED FOR DESIGN CONFIGURATION ONLY. EXACT LAYOUT AND PLACEMENT OF FIXTURES, APPLIANCES, CABINETS, AND COUNTERTOPS ARE TO BE DETERMINED IN COORDINATION WITH OWNER AND GENERAL CONTRACTOR.

#### FINISH NOTES:

FLOOR, WALL, CEILING, FINISHES AND INTERIOR TRIM ARE TO BE DETERMINED BY THE GENERAL CONTRACTOR AND OWNER. GENERAL CONTRACTOR TO ADJUST SLAB, WALLS, AND CEILING TO ACCOMMODATE OWNER SPECIFIC FINISHES AND TRIM.

FLOOR, WALL, CEILING, AND FINISHES ARE AS NOTED ON FINISH SCHEDULE - SEE SHEET A8.0. GENERAL CONTRACTOR TO ADJUST SLAB, WALLS, AND CEILING TO ACCOMMODATE OWNER SPECIFIC FINISHES AND TRIM.

#### PLUMBING NOTES:

G.C. / OWNER TO COORDINATE LOCATION OF EXTERIOR HOSE

#### FRAMING NOTES:

STRUCTURAL ENGINEERING DOCUMENTS SUPERSEDE ARCHITECTURAL DOCUMENTS AND SCHEDULES WITH REGARD TO SIZE OF STRUCTURAL MEMBERS, PLACEMENT, AND CONNECTION DETAILS.

DOOR OPENINGS SET 6" OFF INTERSECTING WALL, UNLESS OTHERWISE DIMENSIONED.

UNLESS OTHERWISE NOTED BY TYPICAL WALL SECTIONS, STRUCTURAL ENGINEER, OR STRUCTURAL DRAWINGS.

#### FRAMING IS TO BE AS FOLLOWS:

EXTERIOR: 1/2" PLYWOOD SHEATHING (EXTERIOR SIDE) ON 2x6'S AT 16" O.C. WITH BLOCKING AT MIDSPAN.

INTERIOR: 2x4'S AND 2x6'S AT 16" O.C. WITH BLOCKING AT MIDSPAN.

#### FIRST FLOOR SYSTEM:

CONCRETE SLAB FLOOR WITH 3/4" T&G PLYWOOD, GLUED AND NAILED ON P.T. 1x4 SLEEPER SYSTEM WITH VAPOR BARRIER.

#### SECOND FLOOR SYSTEM:

3/4" T&G PLYWOOD, GLUED AND NAILED ON 10" OPEN WEB WOOD TRUSS SYSTEM (LAYOUT AND SPACING BY STRUCTURAL ENG). SEE TYPICAL WALL SECTIONS AND DETAILS FOR VARIOUS CONNECTION DETAILS, NOTE: IF TRUSS JOISTS (OR SIM.) ARE USED IN LIEU OF SPECIFIED MATERIALS, TRUSS MANUFACTURER IS TO PROVIDE SHOP DRAWINGS, SUPPORT AND CONNECTION DETAILS, AND BEAM SIZES FOR ARCHITECT/ENGINEER APPROVAL.

#### BONUS ROOM FLOOR SYSTEM:

3/4" T&G PLYWOOD, GLUED AND NAILED ON 12" OPEN WEB WOOD TRUSS SYSTEM (LAYOUT AND SPACING BY STRUCTURAL ENG). SEE TYPICAL WALL SECTIONS AND DETAILS FOR VARIOUS CONNECTION DETAILS. TRUSS MANUFACTURER IS TO PROVIDE SHOP DRAWINGS, SUPPORT AND CONNECTION DETAILS, AND BEAM SIZES FOR ARCHITECT/ENGINEER APPROVAL.

#### PORCH FLOOR SYSTEM:

CONCRETE SLAB FLOOR WITH TABBY FLOOR FINISH AND BRICK EDGING. SEE TYPICAL WALL SECTIONS AND DETAILS FOR VARIOUS CONNECTION DETAILS.

#### ATTIC FLOOR SYSTEM: (ONLY EXTENT TO BE DETERMINED BY

3/4" T&G PLYWOOD, GLUED AND NAILED ON 2x12'S AT 16" O.C. SEE TYPICAL WALL SECTIONS AND DETAILS FOR VARIOUS CONNECTION DETAILS. NOTE: IF TRUSS JOISTS (OR SIM.) ARE USED IN LIEU OF SPECIFIED MATERIALS, TRUSS MANUFACTURER IS TO PROVIDE SHOP DRAWINGS, SUPPORT AND CONNECTION DETAILS, AND BEAM SIZES FOR ARCHITECT/ENGINEER APPROVAL.

ATTIC CEILING JOISTS / PORCH CEILING: 2x8'S AT 16" O.C. (2x10'S FOR CERTAIN SPANS)

#### **ROOF RAFTERS:**

EXT SHEATHING, NAILED ON 2x10'S WITH SIMPSON HURRICANE CLIPS AT 16" O.C. SEE TYPICAL WALL SECTIONS FOR VARIOUS CONNECTION DETAILS. IF PRE-ENGINEERED WOOD ROOF TRUSSES ARE INSTALLED IN LIEU OF SPECIFIED MATERIALS, TRUSS MANUFACTURER IS TO PROVIDE SHOP DRAWINGS, SUPPORT AND CONNECTION DETAILS, AND SIZES FOR ARCHITECT/ENGINEER APPROVAL.

NOTE: SEE STRUCTURAL ENGINEERING DOCUMENTS FOR SIZE, LOCATION AND PLACEMENT OF ALL WORK DESCRIBED.


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#### FLOOR PLAN - SYMBOL KEY

2 x 4 WALL WITH 1/2" GYPSUM WALLBOARD

2 x 6 WALL WITH 1/2" GYPSUM WALLBOARD

existing wall to remain BRICKWORK

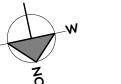

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SECOND FLOOR PLAN

GENERAL CONTRACTOR NOTE:

ADJUST TOP OF SLAB, WALL, AND ROOF BEARING PLATES AS REQUIRED FOR CHANGES IN STRUCTURAL MEMBER SIZES OR existing site conditions.

GC/OWNER TO COORDINATE ALL IN-SLAB ELECTRICAL AND PLUMBING REQUIREMENTS WITH APPROPRIATE

SUBCONTRACTOR TRADES PRIOR TO PLACING SLAB.

**DIMENSION NOTES:** 

DIMENSIONS ARE TO THE EDGE OF FOUNDATION AND FRAMING, U.O.N..

DO NOT SCALE DRAWINGS. CONTACT ARCHITECT WITH ANY DISCREPANCIES.

**CABINET & EQUIPMENT NOTES:** 

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#### FINISH NOTES:

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#### PLUMBING NOTES:

G.C. / OWNER TO COORDINATE LOCATION OF EXTERIOR HOSE

#### FRAMING NOTES:

STRUCTURAL ENGINEERING DOCUMENTS SUPERSEDE ARCHITECTURAL DOCUMENTS AND SCHEDULES WITH REGARD TO SIZE OF STRUCTURAL MEMBERS, PLACEMENT, AND CONNECTION DETAILS.

DOOR OPENINGS SET 6" OFF INTERSECTING WALL, UNLESS OTHERWISE DIMENSIONED.

UNLESS OTHERWISE NOTED BY TYPICAL WALL SECTIONS, STRUCTURAL ENGINEER, OR STRUCTURAL DRAWINGS.

#### FRAMING IS TO BE AS FOLLOWS:

EXTERIOR: 1/2" PLYWOOD SHEATHING (EXTERIOR SIDE) ON 2x6'S AT 16" O.C. WITH BLOCKING AT MIDSPAN.

INTERIOR: 2x4'S AND 2x6'S AT 16" O.C. WITH BLOCKING AT MIDSPAN.

#### FIRST FLOOR SYSTEM:

CONCRETE SLAB FLOOR WITH 3/4" T&G PLYWOOD, GLUED AND NAILED ON P.T. 1x4 SLEEPER SYSTEM WITH VAPOR BARRIER.

#### SECOND FLOOR SYSTEM:

3/4" T&G PLYWOOD, GLUED AND NAILED ON 10" OPEN WEB WOOD TRUSS SYSTEM (LAYOUT AND SPACING BY STRUCTURAL ENG). SEE TYPICAL WALL SECTIONS AND DETAILS FOR VARIOUS CONNECTION DETAILS, NOTE: IF TRUSS JOISTS (OR SIM.) ARE USED IN LIEU OF SPECIFIED MATERIALS, TRUSS MANUFACTURER IS TO PROVIDE SHOP DRAWINGS, SUPPORT AND CONNECTION DETAILS, AND BEAM SIZES FOR ARCHITECT/ENGINEER APPROVAL.

#### BONUS ROOM FLOOR SYSTEM:

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CONCRETE SLAB FLOOR WITH TABBY FLOOR FINISH AND BRICK EDGING. SEE TYPICAL WALL SECTIONS AND DETAILS FOR VARIOUS CONNECTION DETAILS.

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ATTIC CEILING JOISTS / PORCH CEILING: 2x8'S AT 16" O.C. (2x10'S FOR CERTAIN SPANS)

#### **ROOF RAFTERS:**

EXT SHEATHING, NAILED ON 2x10'S WITH SIMPSON HURRICANE CLIPS AT 16" O.C. SEE TYPICAL WALL SECTIONS FOR VARIOUS CONNECTION DETAILS. IF PRE-ENGINEERED WOOD ROOF TRUSSES ARE INSTALLED IN LIEU OF SPECIFIED MATERIALS, TRUSS MANUFACTURER IS TO PROVIDE SHOP DRAWINGS, SUPPORT AND CONNECTION DETAILS, AND SIZES FOR ARCHITECT/ENGINEER APPROVAL.

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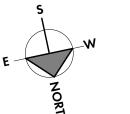
#### FLOOR PLAN - SYMBOL KEY

2 x 4 WALL WITH 1/2" GYPSUM WALLBOARD

2 x 6 WALL WITH 1/2" GYPSUM WALLBOARD

**EXISTING WALL TO REMAIN** 

BRICKWORK





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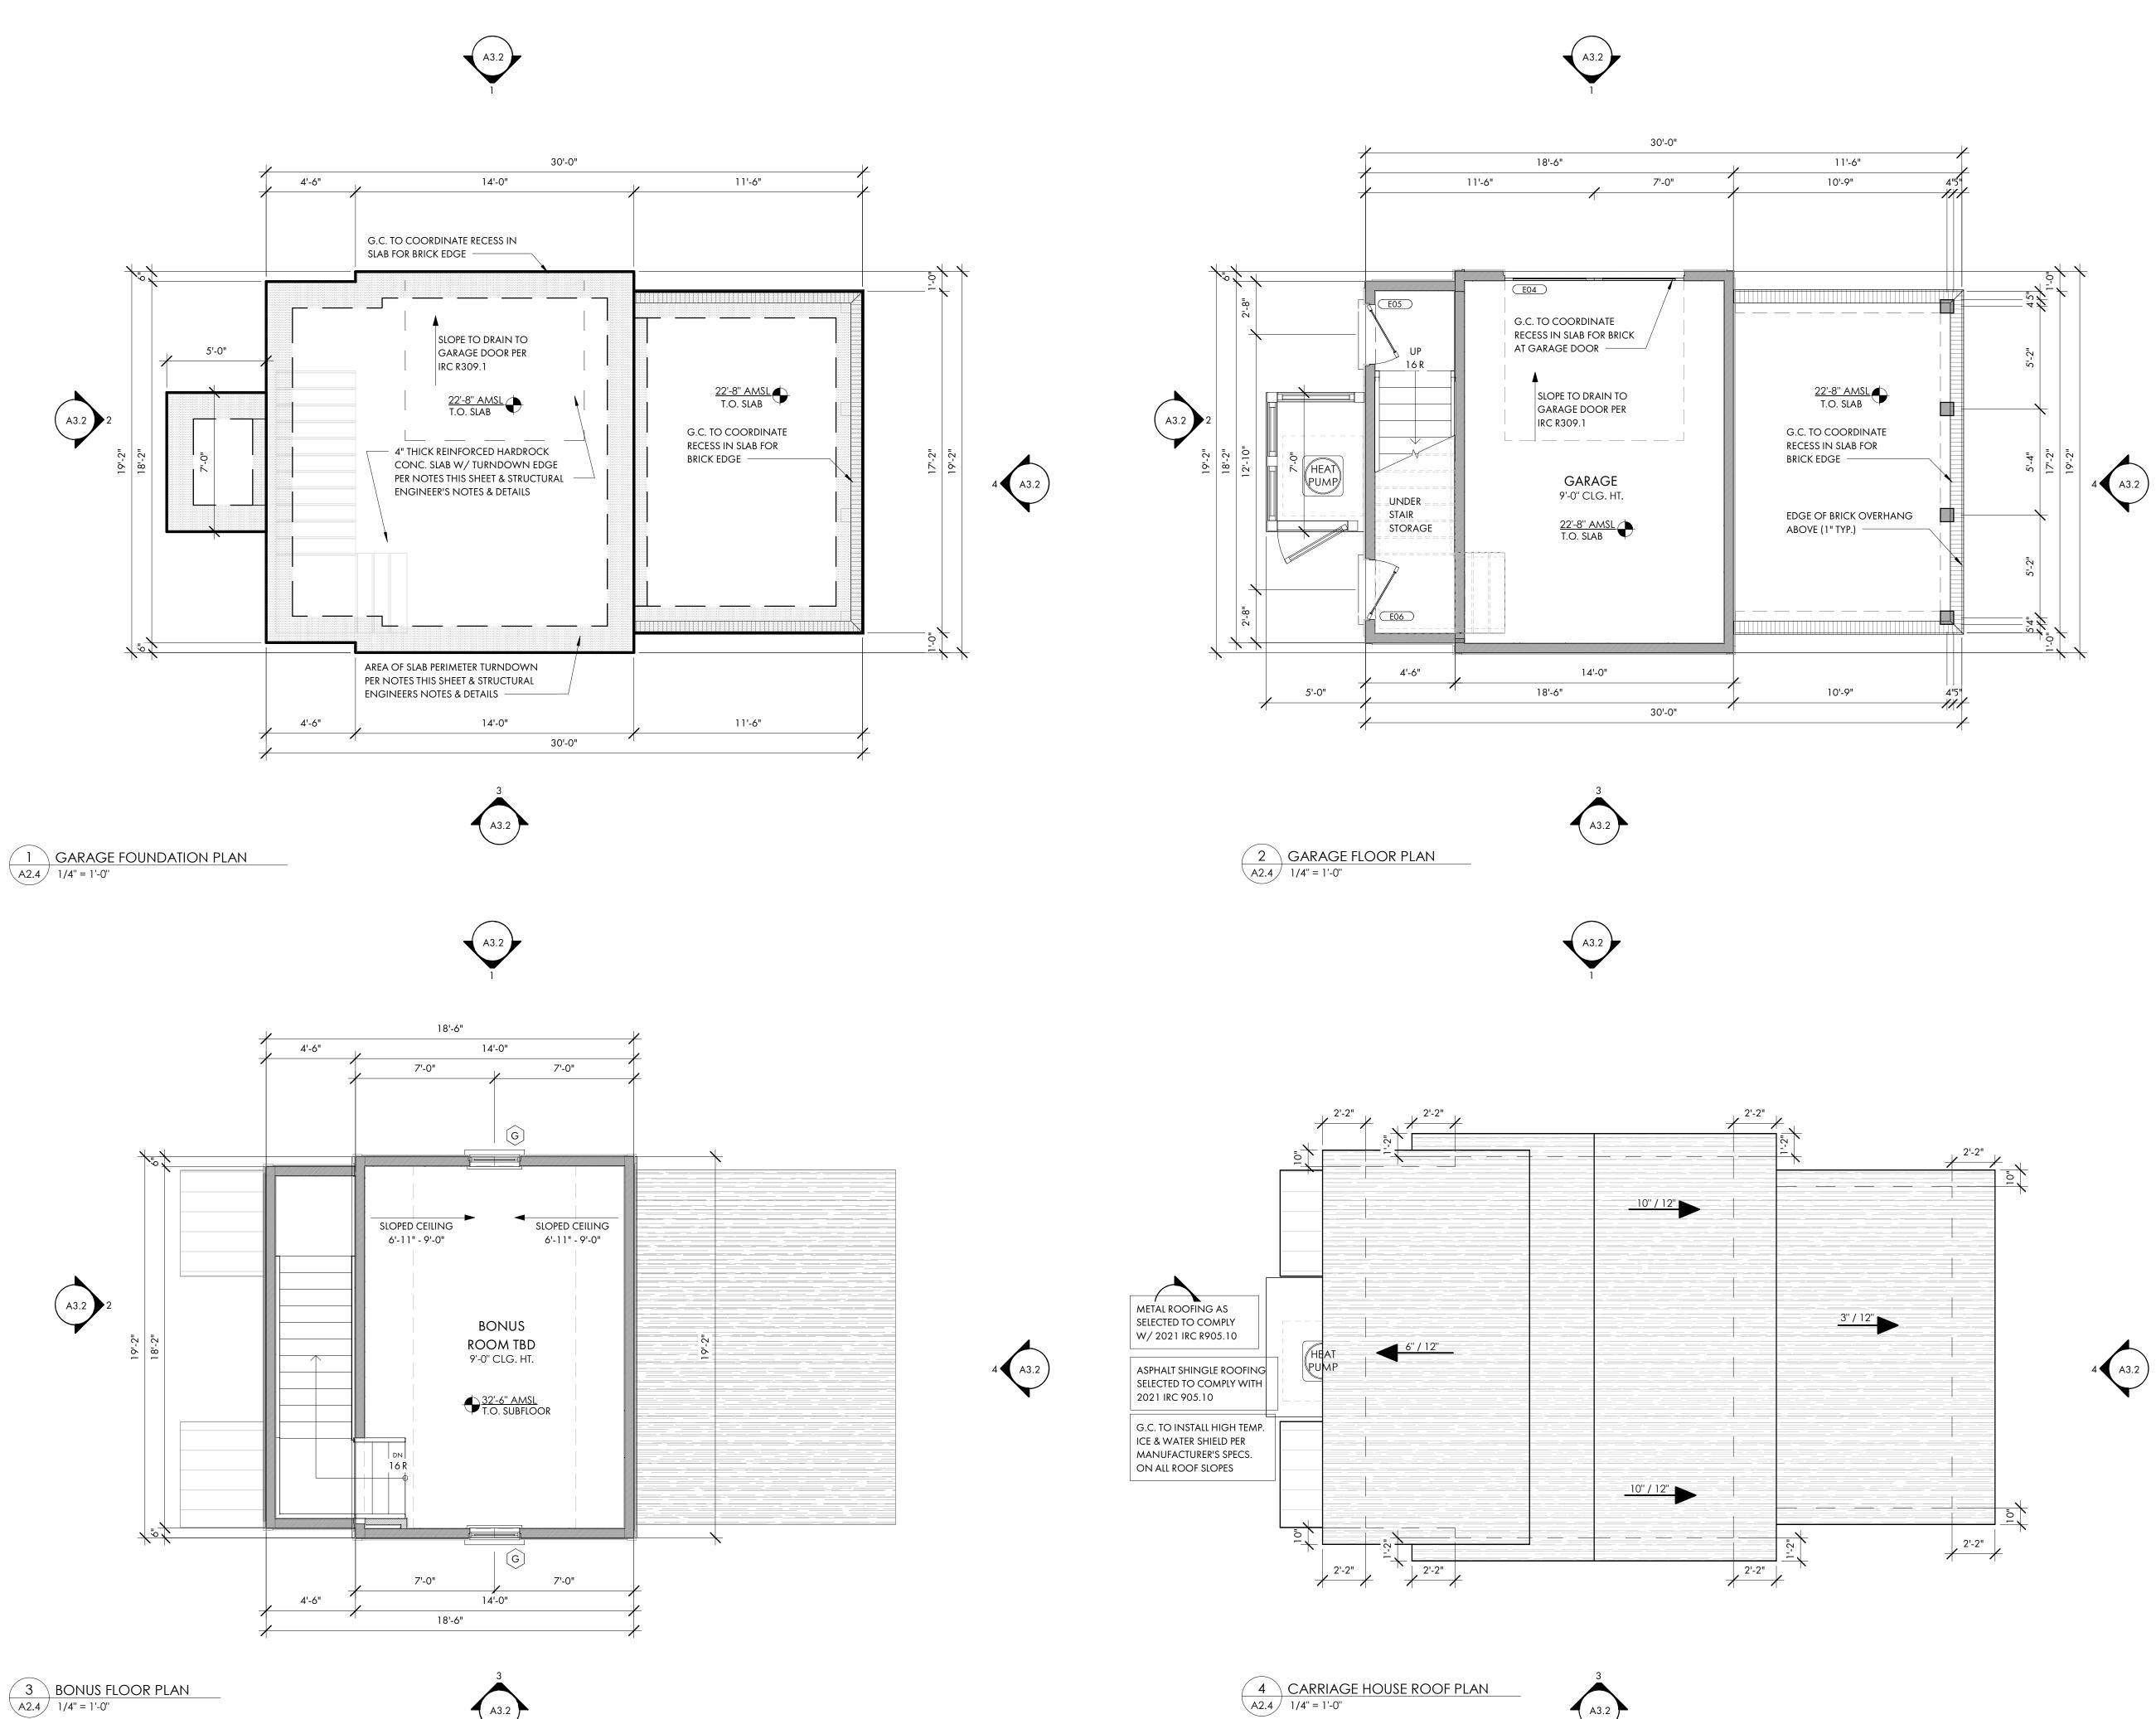
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ROOF PLAN



GENERAL CONTRACTOR NOTE:

ADJUST TOP OF SLAB, WALL, AND ROOF BEARING PLATES AS REQUIRED FOR CHANGES IN STRUCTURAL MEMBER SIZES OR existing site conditions.

GC/OWNER TO COORDINATE ALL IN-SLAB ELECTRICAL AND PLUMBING REQUIREMENTS WITH APPROPRIATE

DIMENSION NOTES:

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#### PLUMBING NOTES:

G.C. / OWNER TO COORDINATE LOCATION OF EXTERIOR HOSE

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#### PORCH FLOOR SYSTEM:

CONCRETE SLAB FLOOR WITH TABBY FLOOR FINISH AND BRICK EDGING. SEE TYPICAL WALL SECTIONS AND DETAILS FOR VARIOUS CONNECTION DETAILS.

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ATTIC CEILING JOISTS / PORCH CEILING: 2x8'S AT 16" O.C. (2x10'S FOR CERTAIN SPANS)

#### ROOF RAFTERS:

EXT SHEATHING, NAILED ON 2x10'S WITH SIMPSON HURRICANE CLIPS AT 16" O.C. SEE TYPICAL WALL SECTIONS FOR VARIOUS CONNECTION DETAILS. IF PRE-ENGINEERED WOOD ROOF TRUSSES ARE INSTALLED IN LIEU OF SPECIFIED MATERIALS, TRUSS MANUFACTURER IS TO PROVIDE SHOP DRAWINGS, SUPPORT AND CONNECTION DETAILS, AND SIZES FOR ARCHITECT/ENGINEER APPROVAL.

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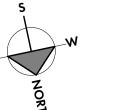
#### FLOOR PLAN - SYMBOL KEY

2 x 4 WALL WITH 1/2" GYPSUM WALLBOARD

2 x 6 WALL WITH 1/2" GYPSUM WALLBOARD

EXISTING WALL TO REMAIN







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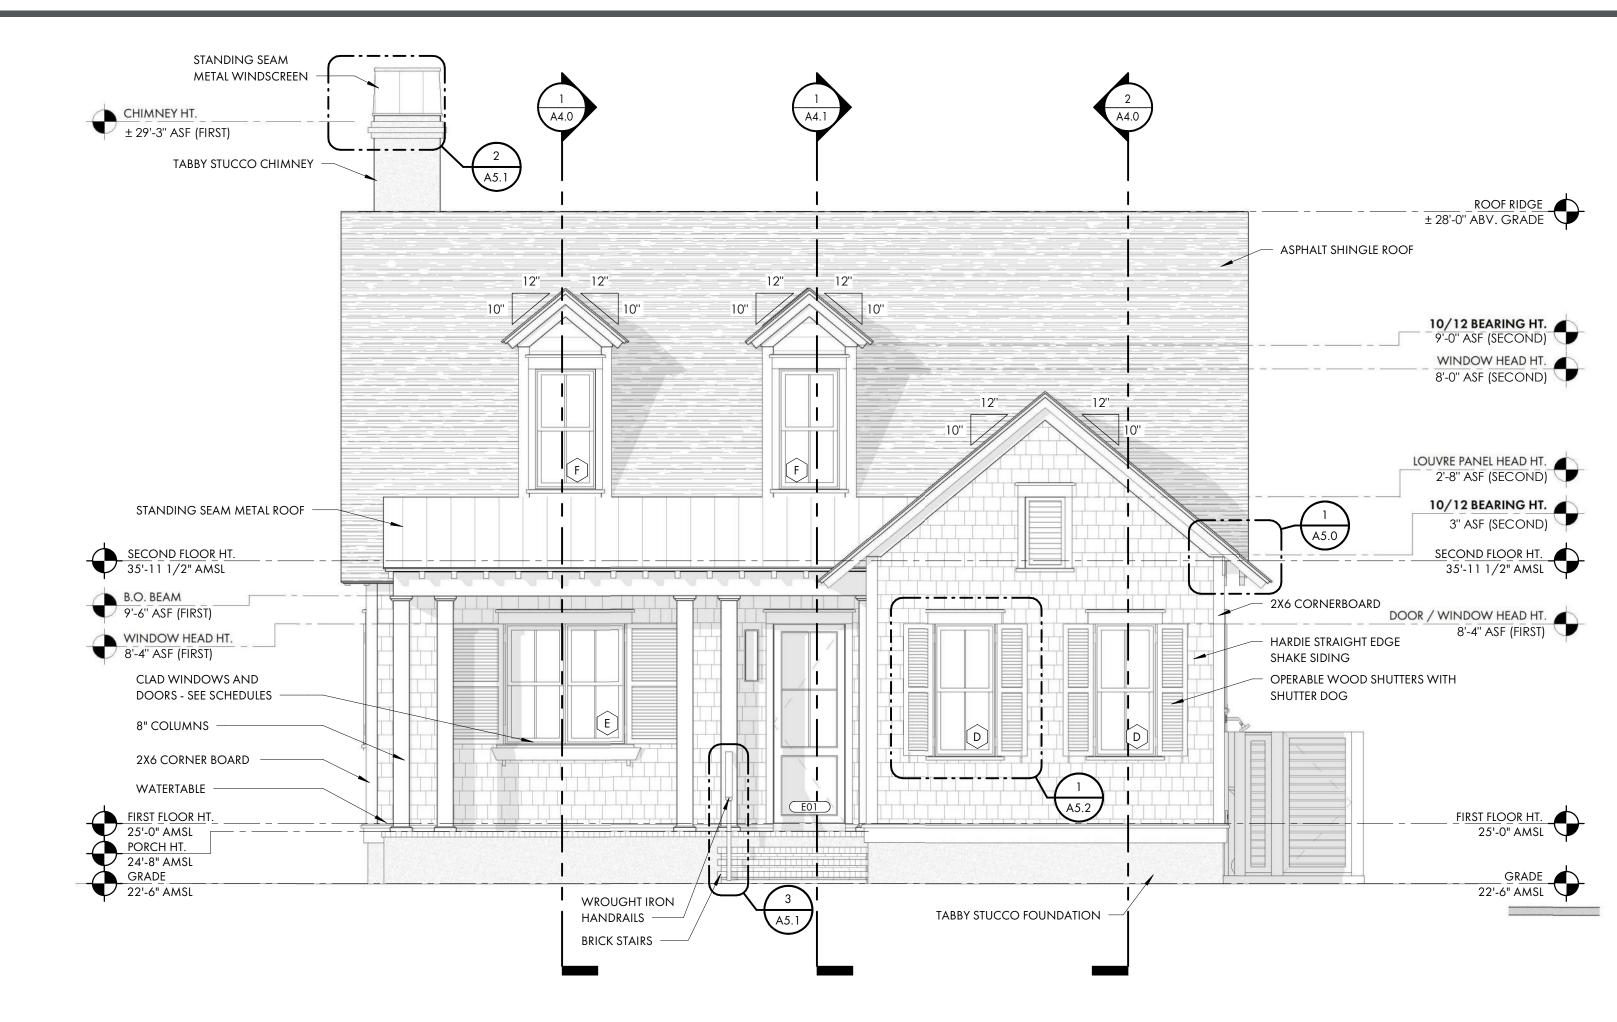
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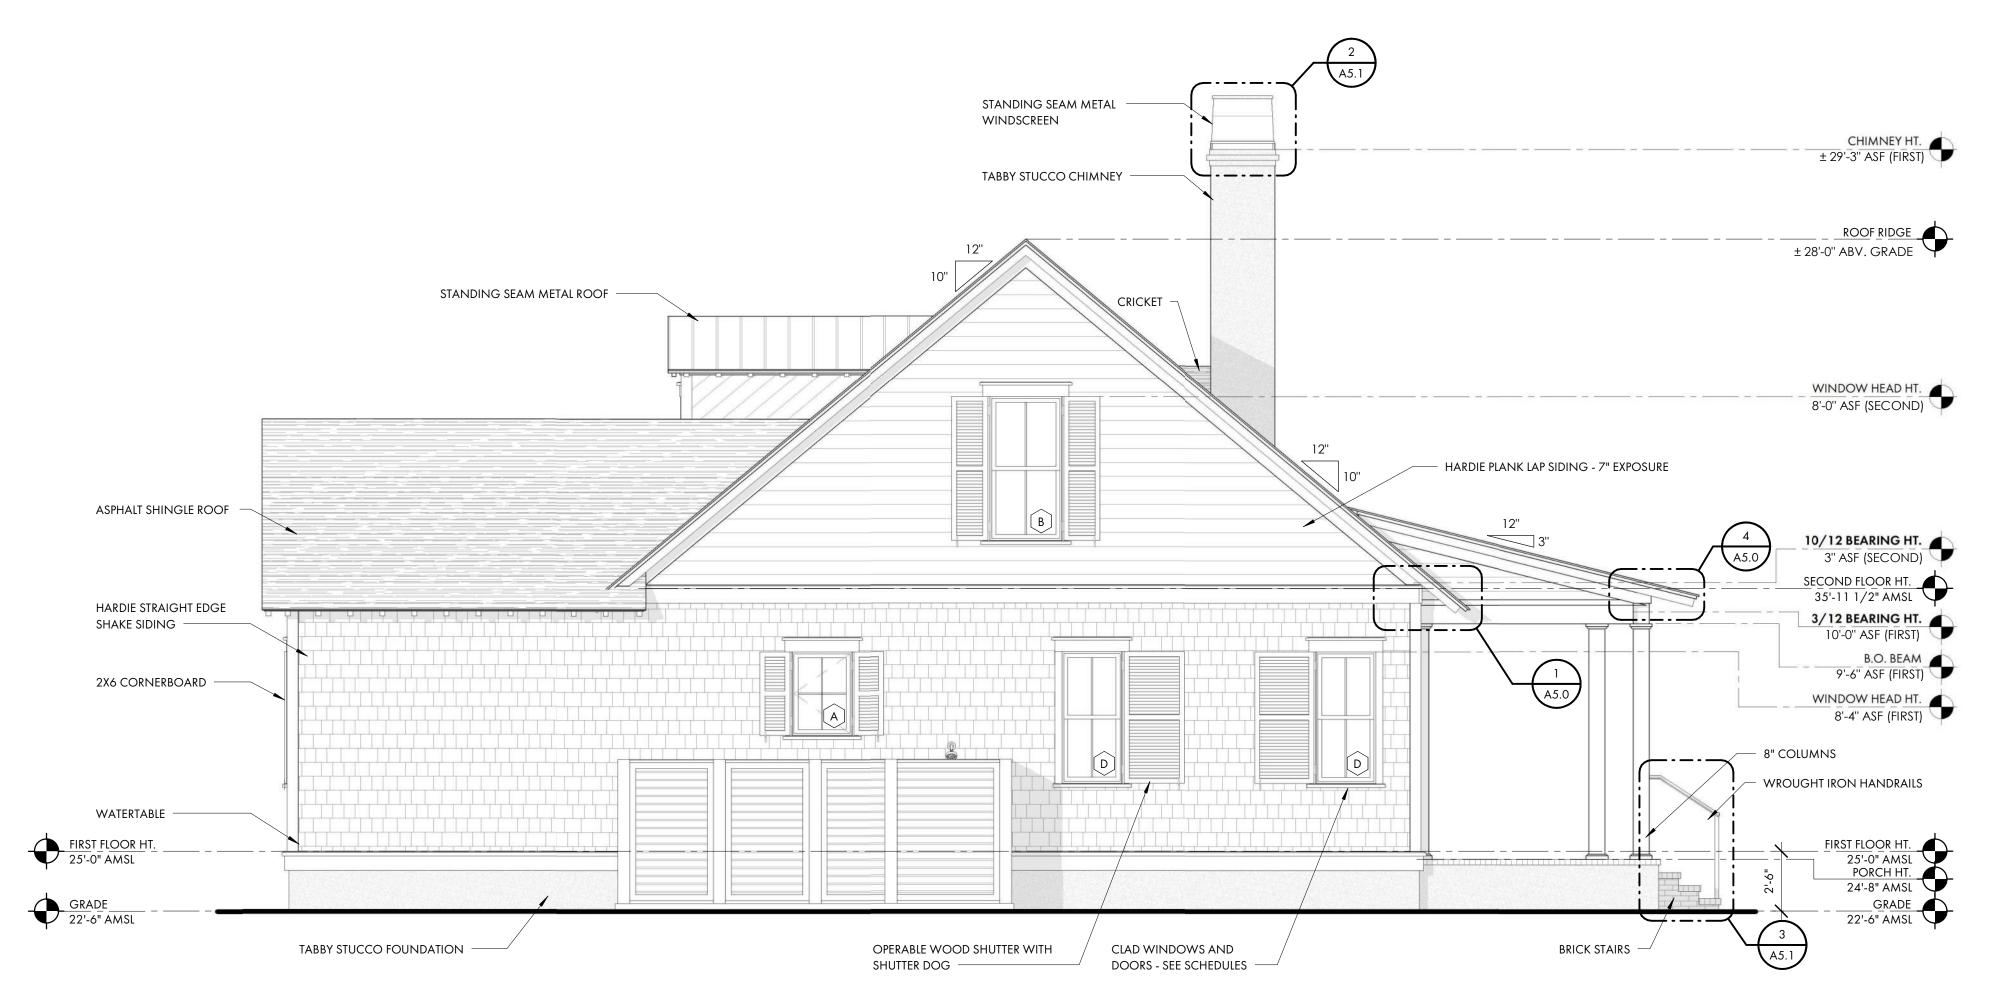
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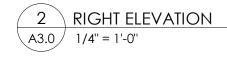
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CH PLANS



1 FRONT ELEVATION
A3.0 1/4" = 1'-0"







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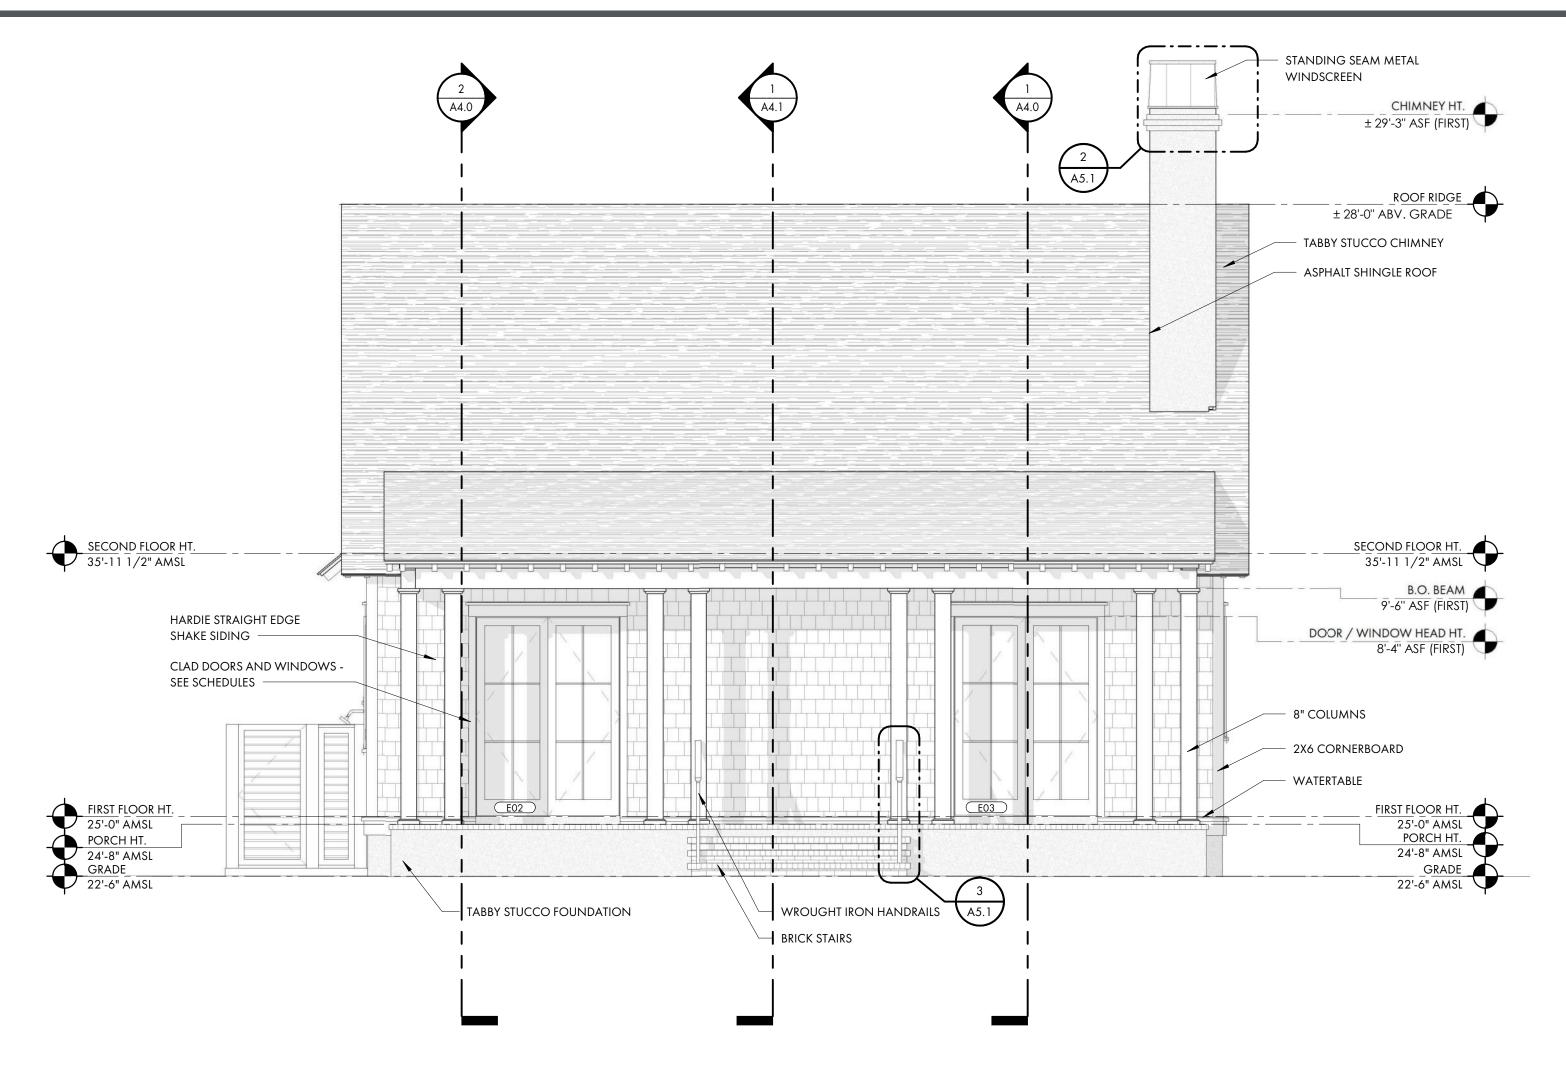
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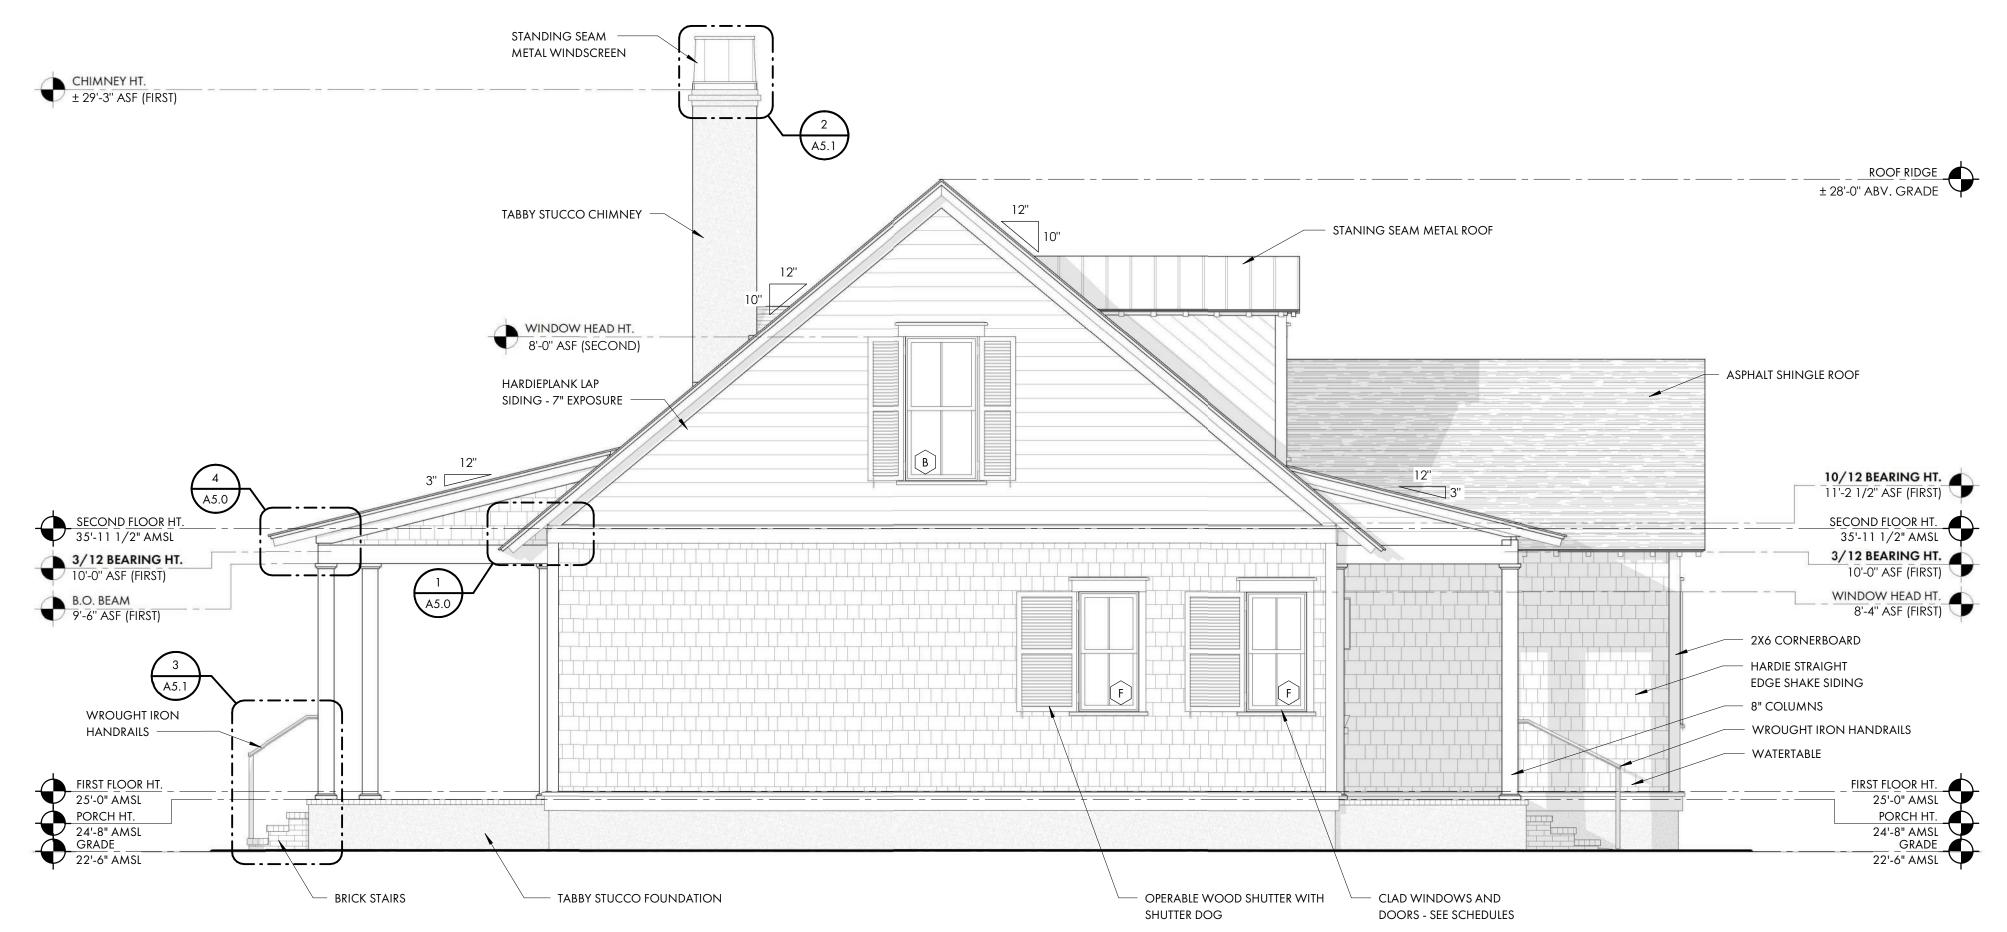
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BUILDING ELEVATIONS

A3.0



1 REAR ELEVATION
A3.1 1/4" = 1'-0"





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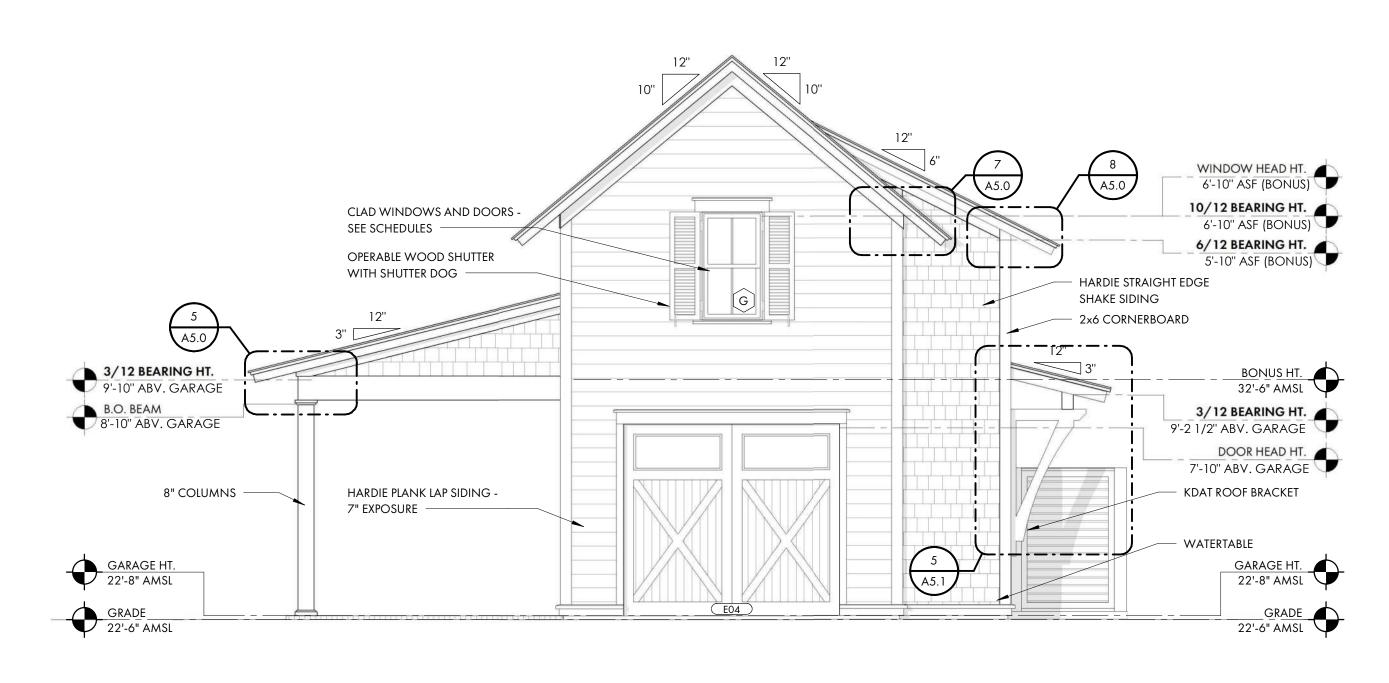
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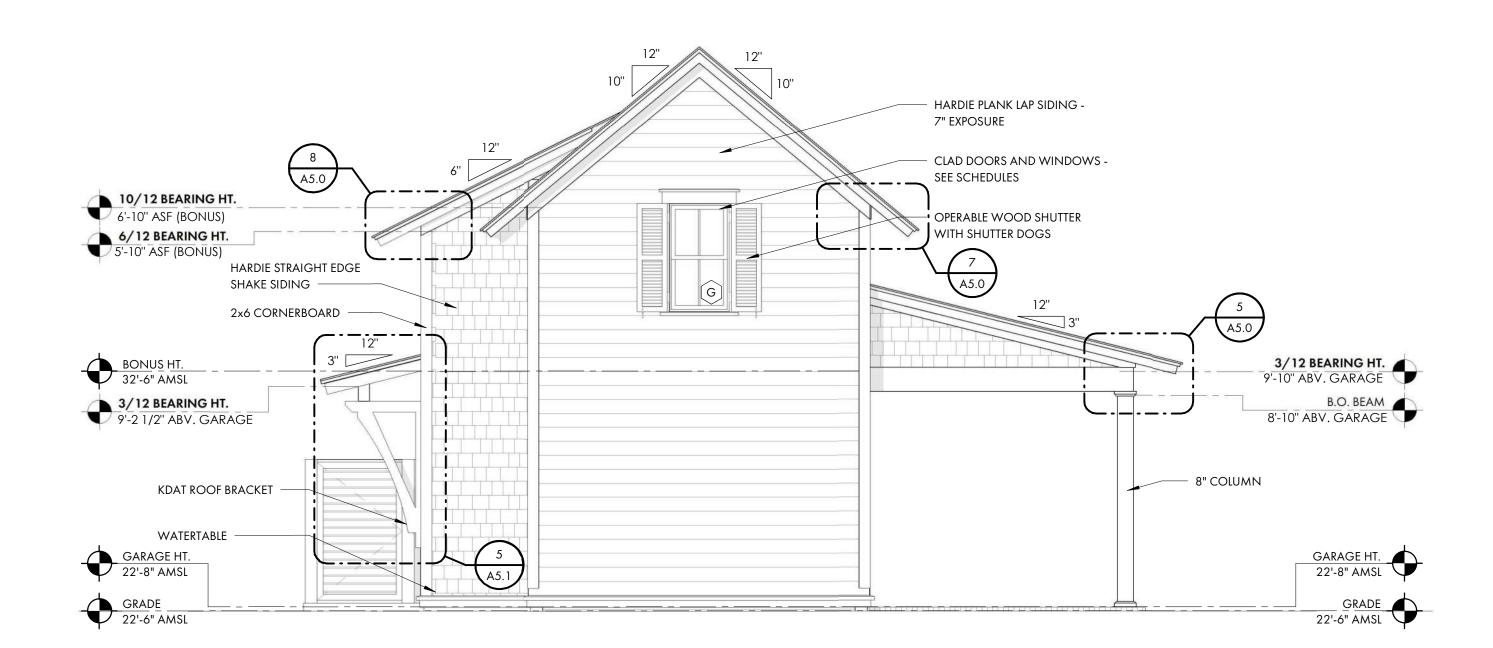
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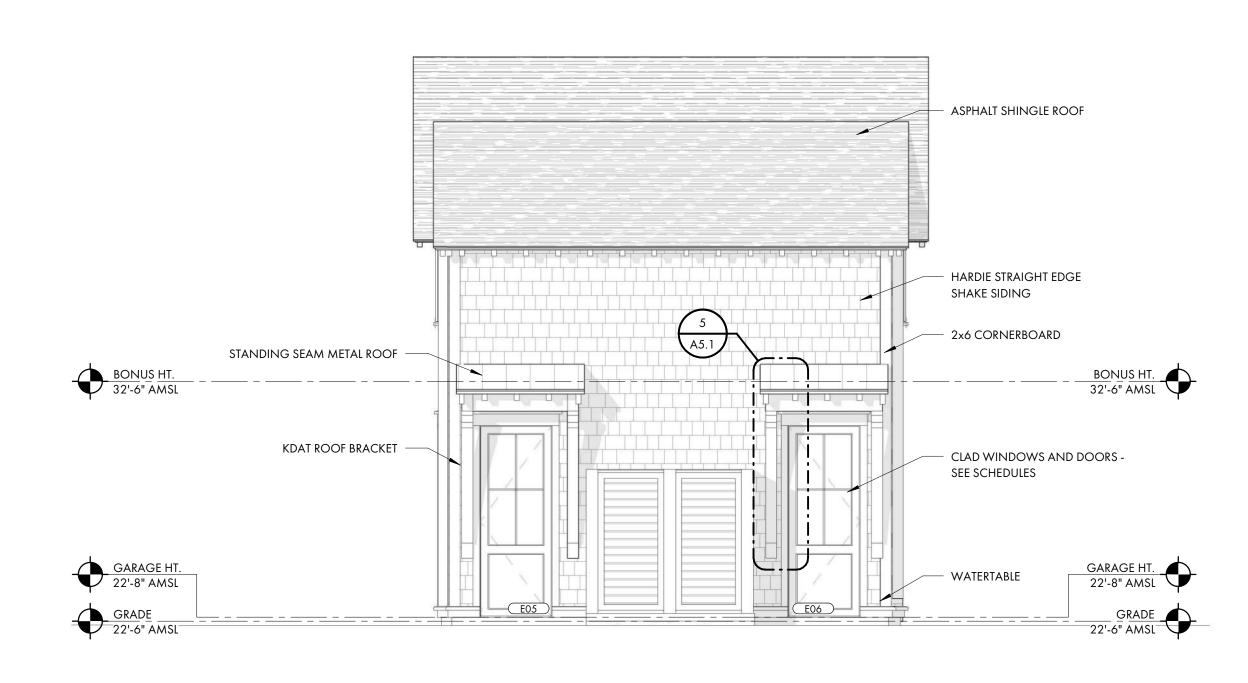
BUILDING ELEVATIONS

A3.1












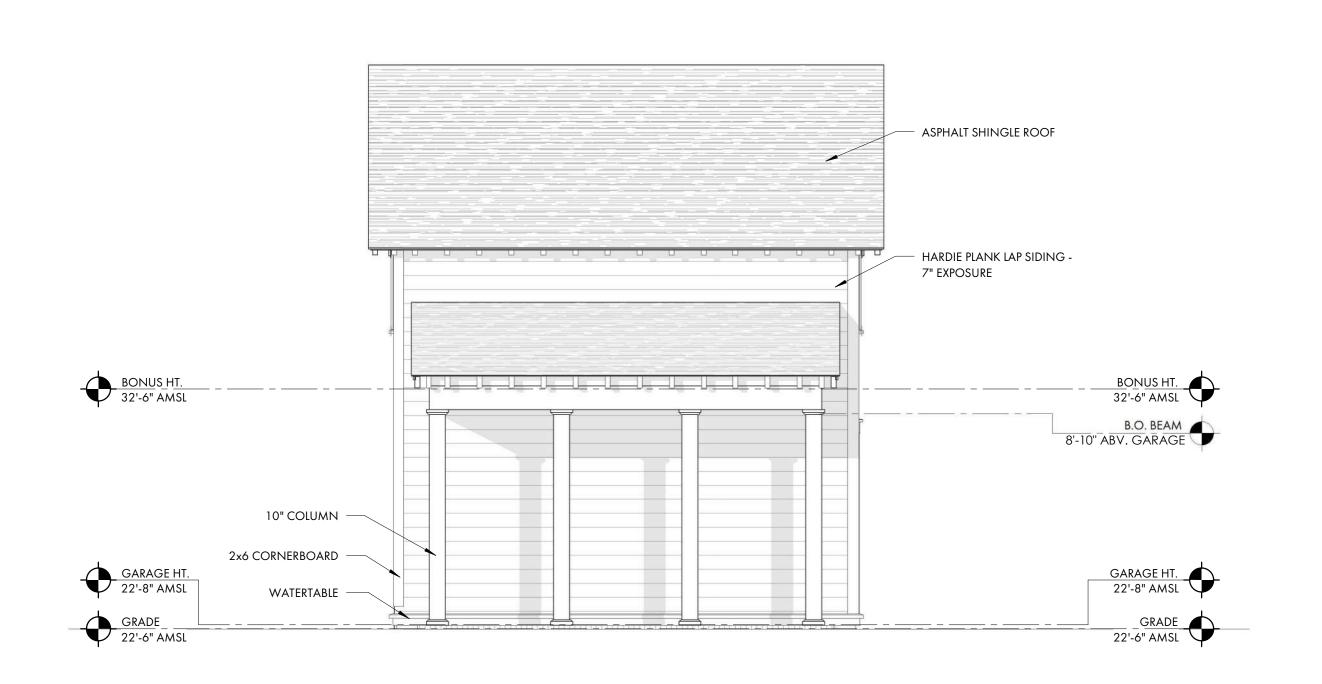

4 CH LEFT ELEVATION 1/4" = 1'-0"



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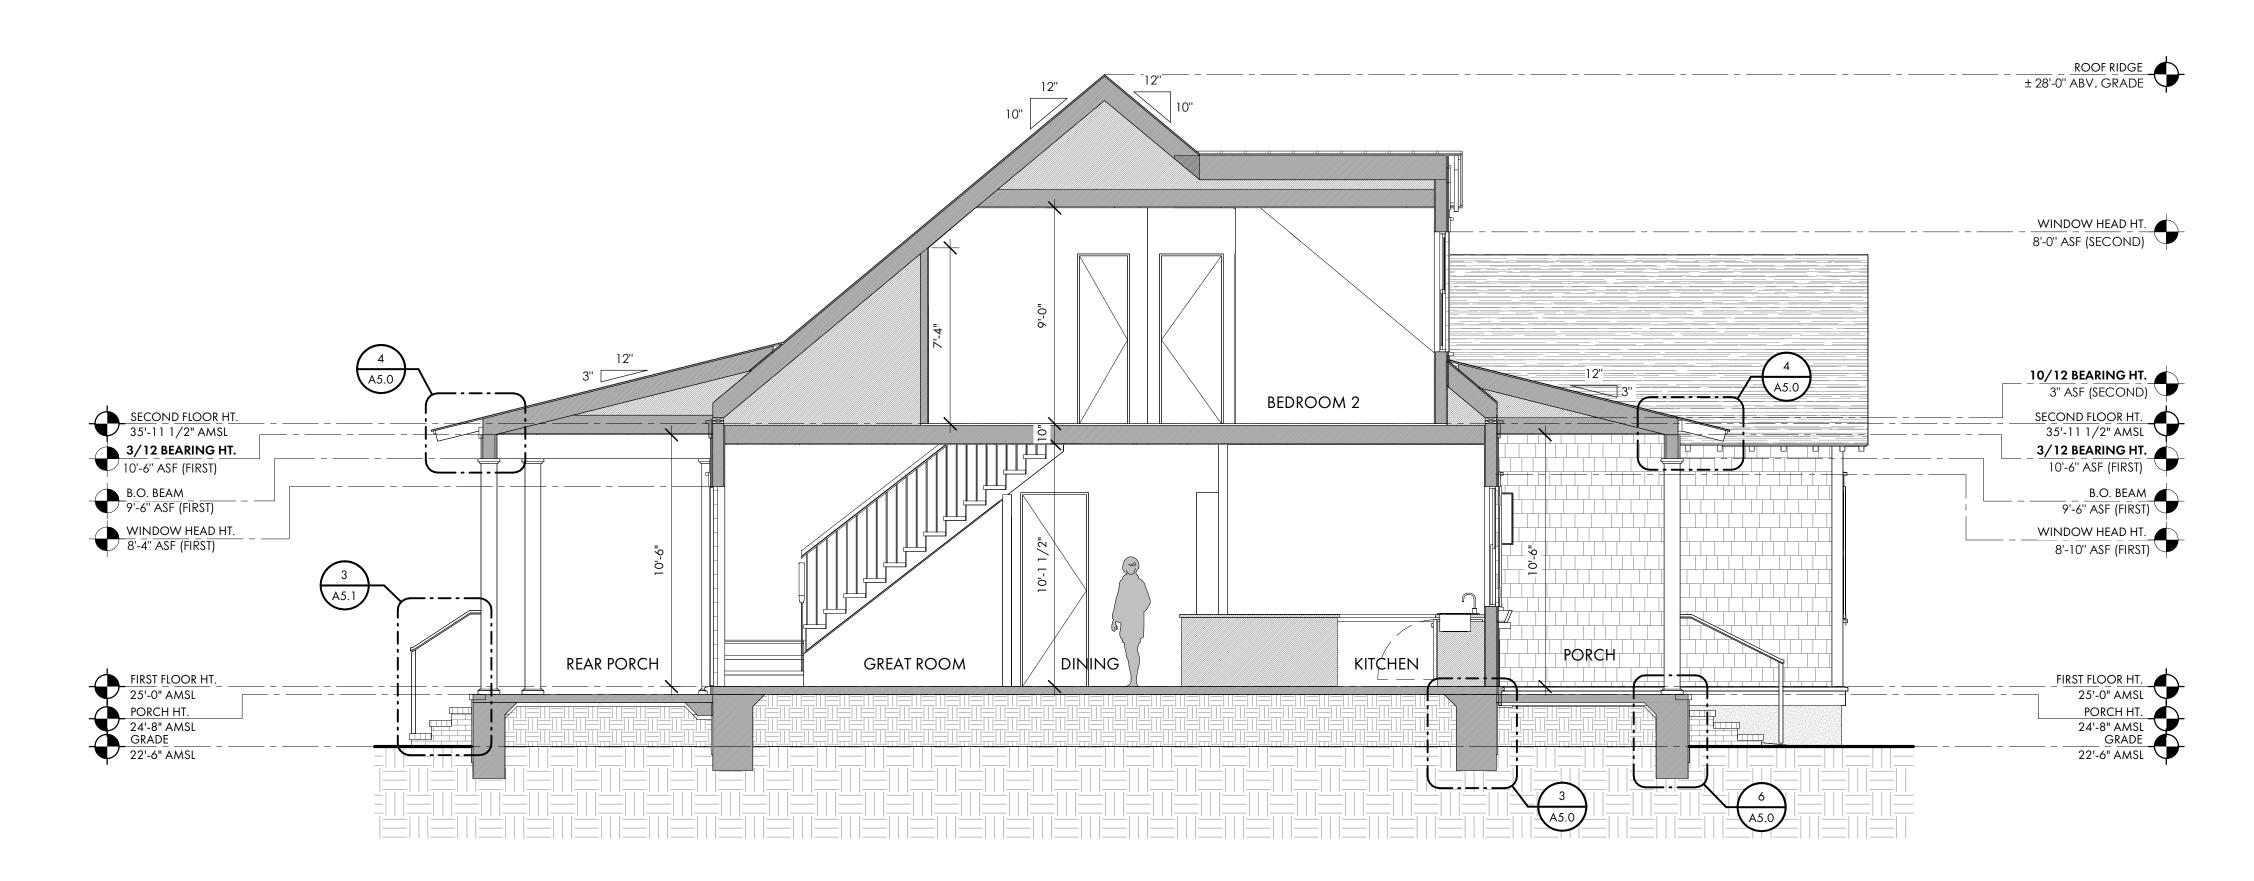
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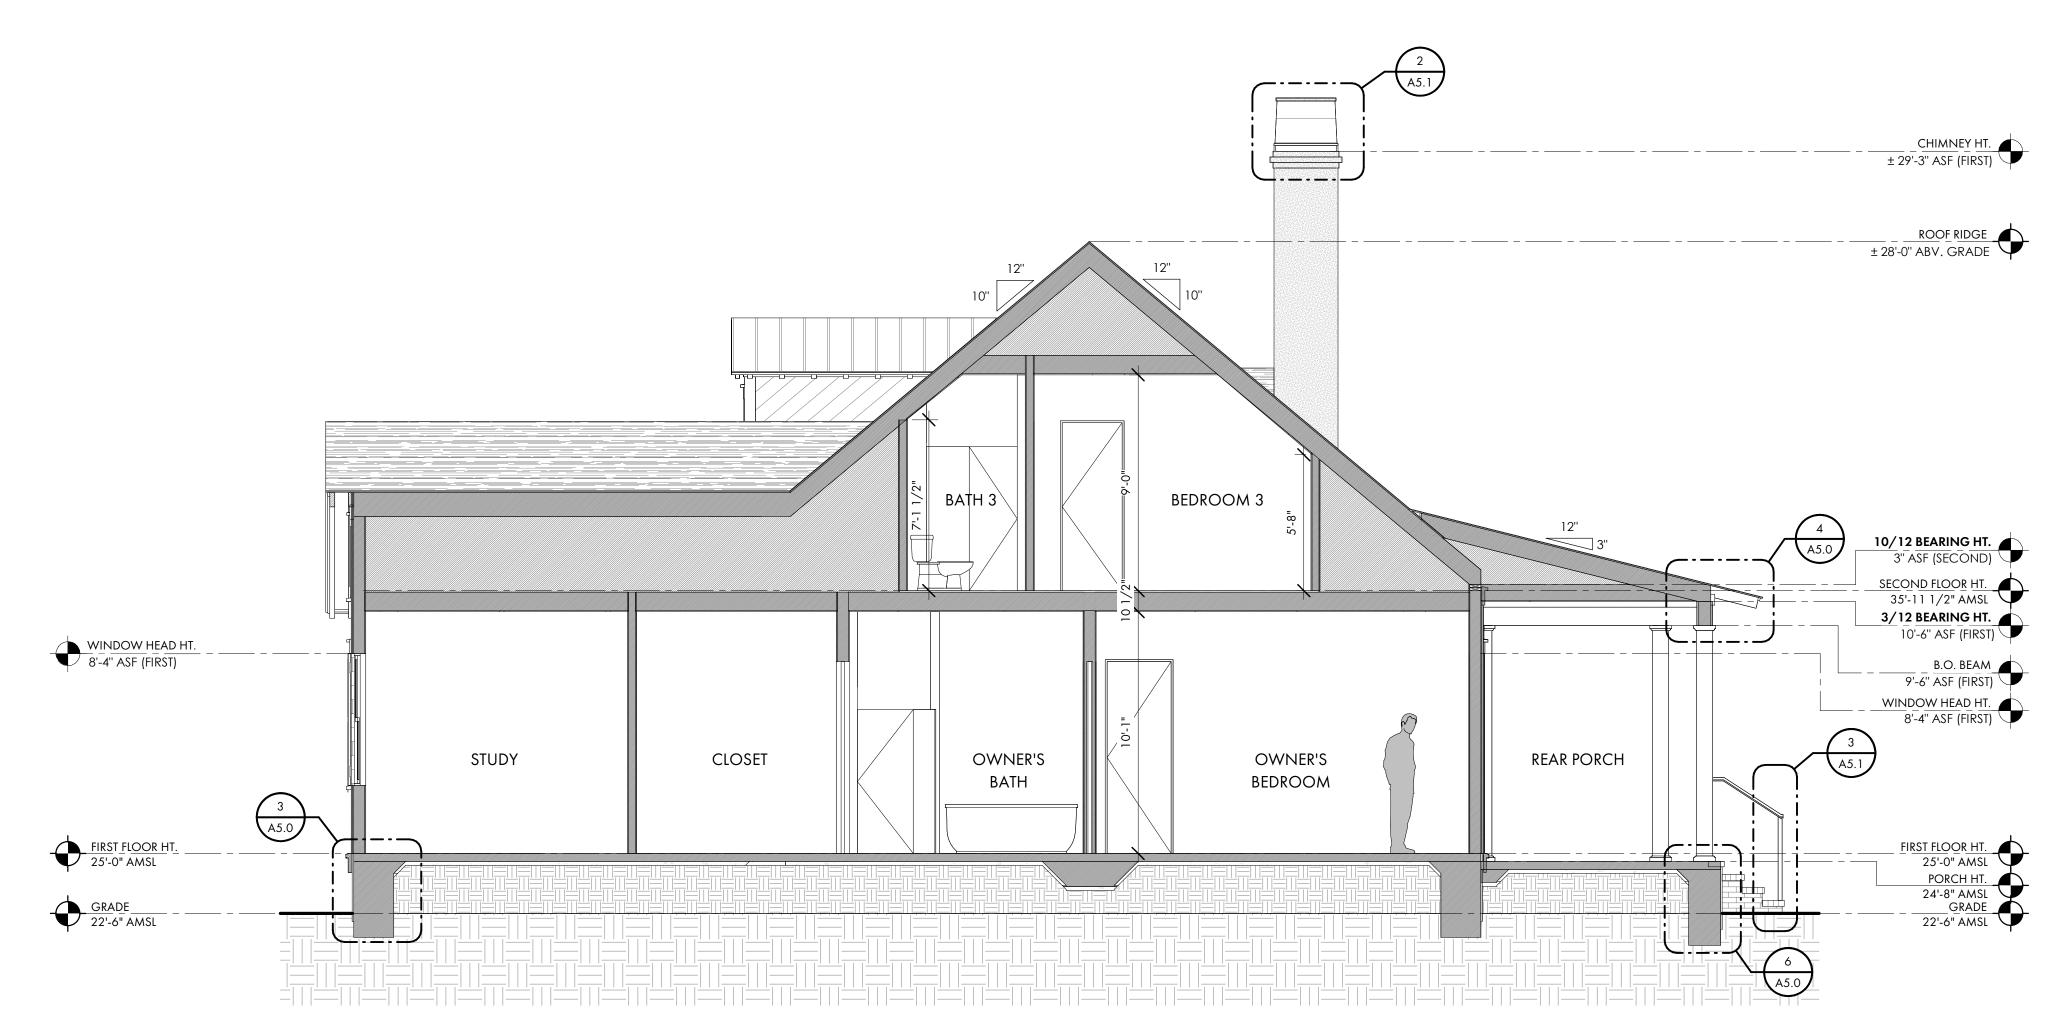
CH BUILDING ELEVATIONS

A3.2



SECTION THROUGH GREAT ROOM AND KITCHEN

1/4" = 1'-0"



2 SECTION THROUGH OWNER'S SUITE A4.0 1/4" = 1'-0"



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Date 12/06/2023

Project No. 23-065


ISSUE

NO. REV. DATE **DESCRIPTION** 

SHEET TITLE

BUILDING SECTIONS

A4.0

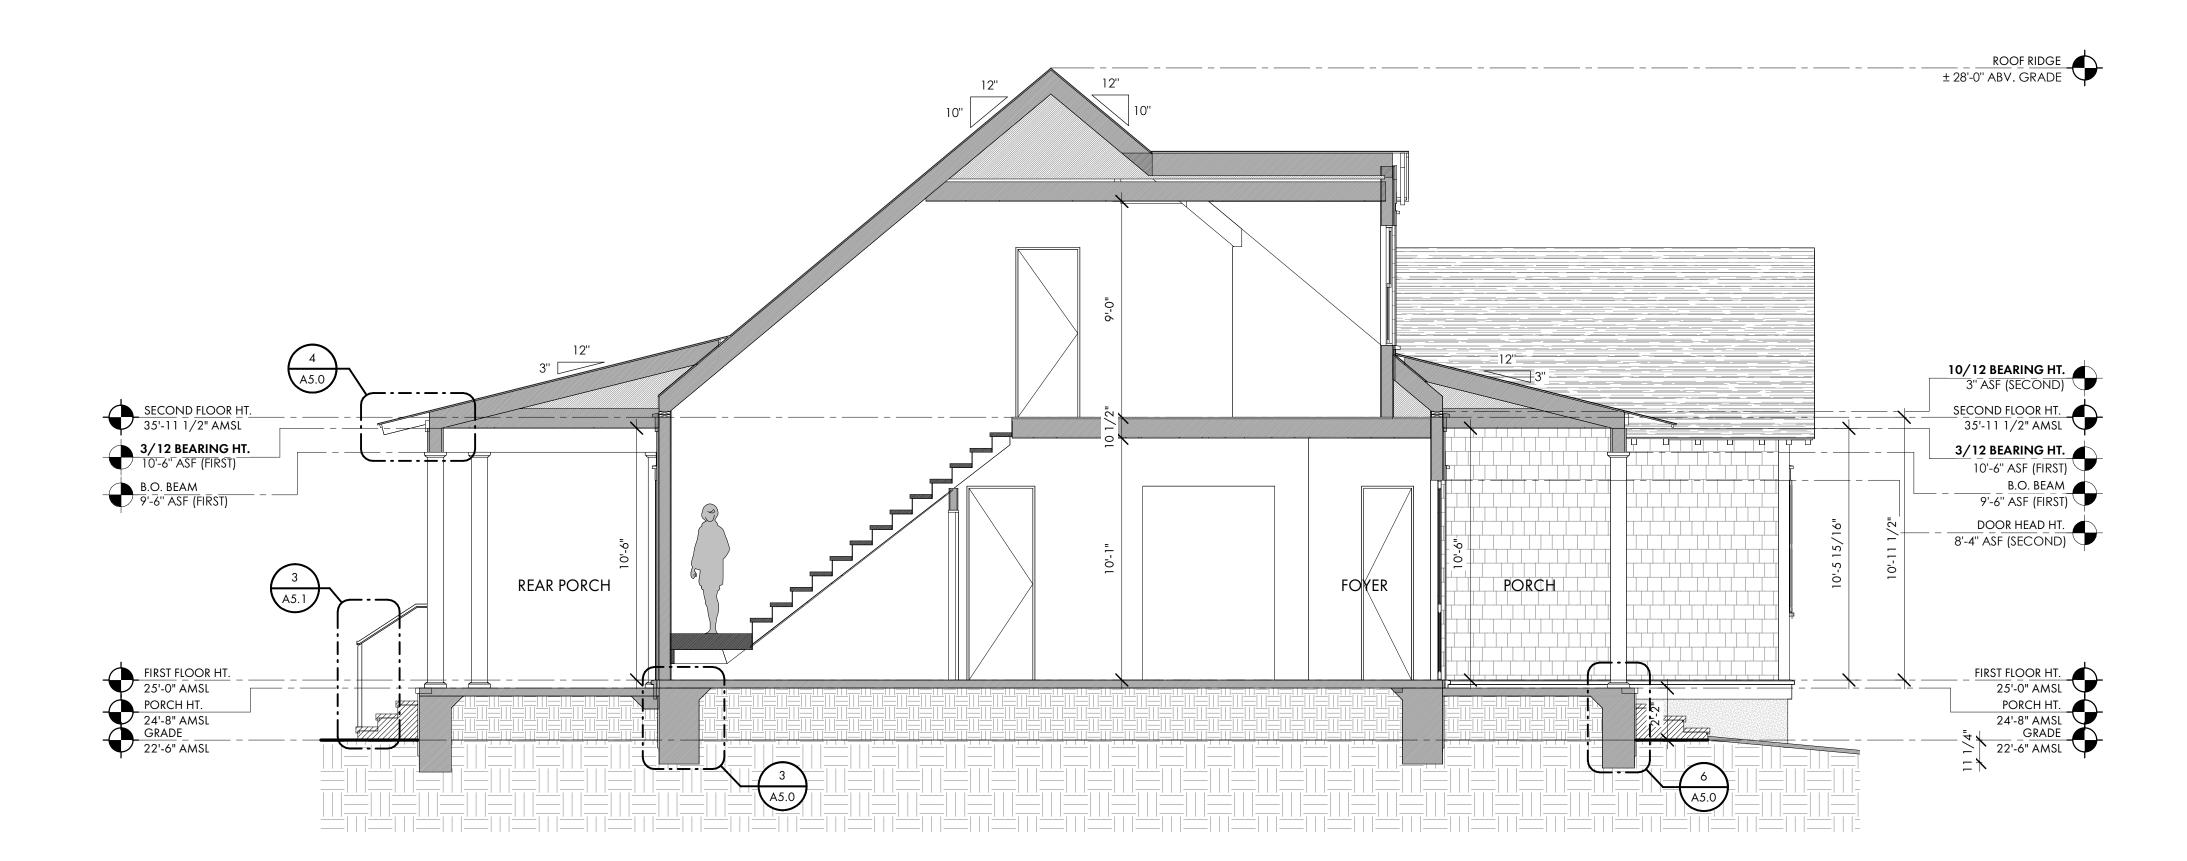





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SEWELL RESIDENCE

, NO FOR CONSTRUCTION

26 TABBY SHELL ROAD, TABBY ROADS, BLUFFTON, SC 29910



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PROJECT INFO

Date 12/06/2023

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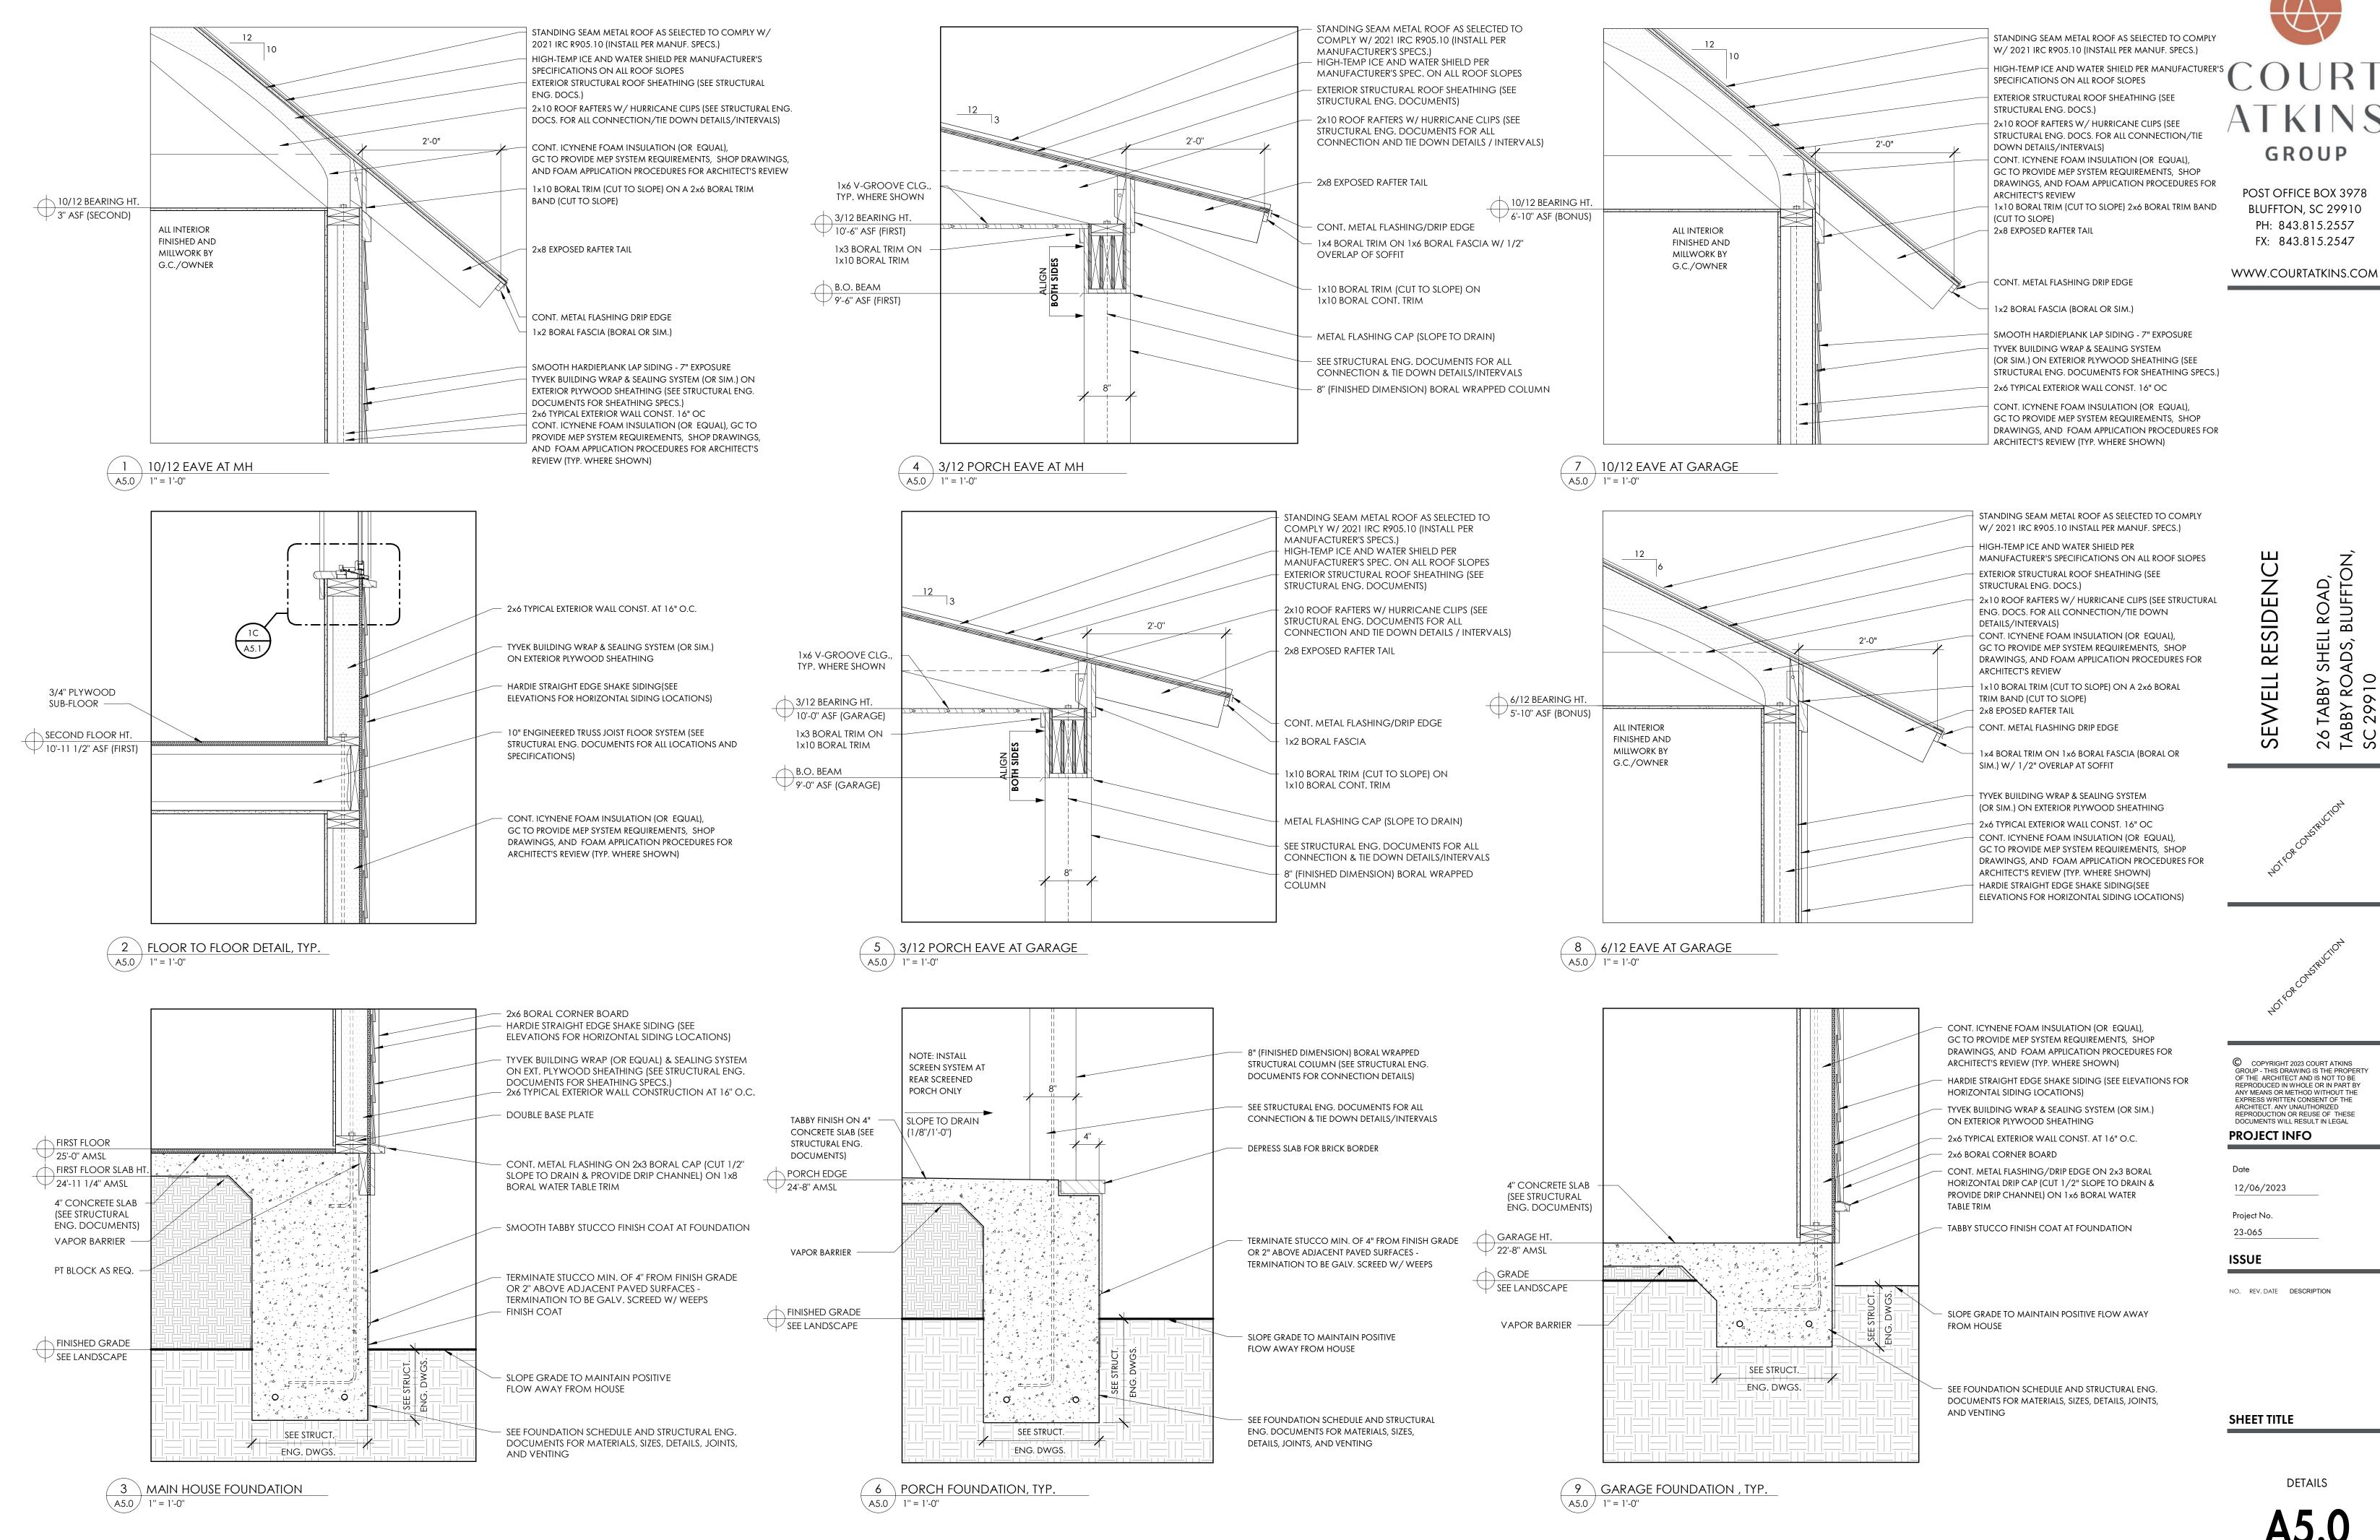
ISSUE

NO. REV. DATE DESCRIPTION

SHEET TITLE

BUILDING SECTIONS

**A4.1** 



- STANDARD FIREROCK

CHIMNEY FLUE BLOCK


1'-9

STANDING SEAM

SMOOTH TABBY

STUCCO AS SELECTED

METAL WINDSCREEN

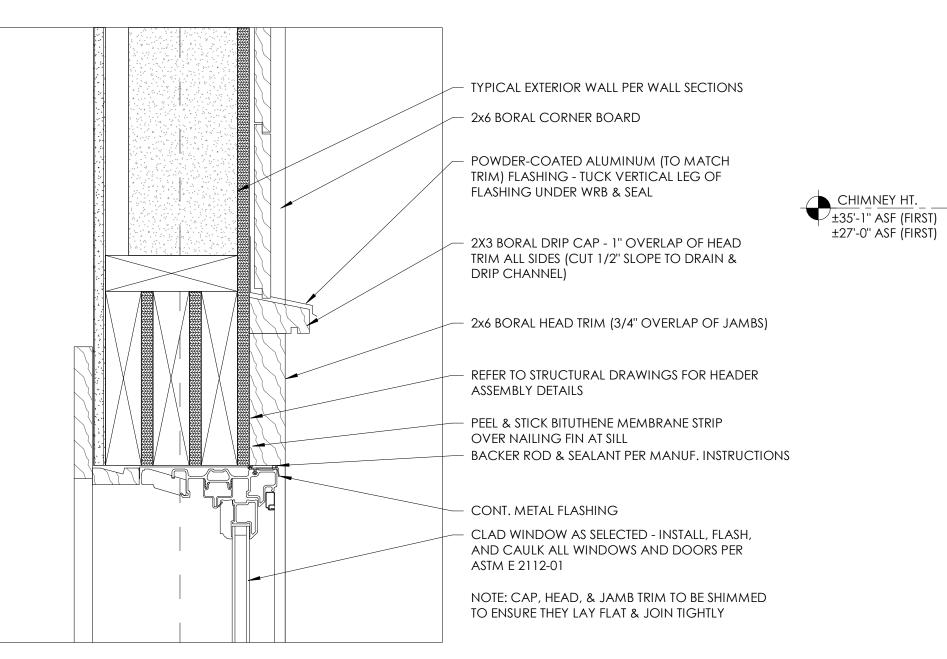

INTERIOR WALL FINISH & CASINGS AS SELECTED

TYPICAL EXTERIOR WALL PER WALL SECTIONS

CLAD WINDOW AS SELECTED - INSTALL, FLASH, AND CAULK ALL WINDOWS AND DOORS PER

NOTE: CAP, HEAD, & JAMBTRIM TO BE SHIMMED TO ENSURE THEY LAY FLAT & JOIN TIGHTLY

NAILING FIN AT JAMB - OVERLAY W/ PEEL &

TO ENSURE THEY LAY FLAT & JOIN TIGHTLY

BACKER ROD & SEALANT PER MANUF, INSTRUCTIONS

ASTM E 2112-01

STICK BITUTHENE


2x6 BORAL JAMB

- SILL BEYOND - SEE DETAIL

2 CHIMNEY DETAIL, TYP.

1 1/2"\ | | 1 1/2"<sup>[-</sup>


2'-9"

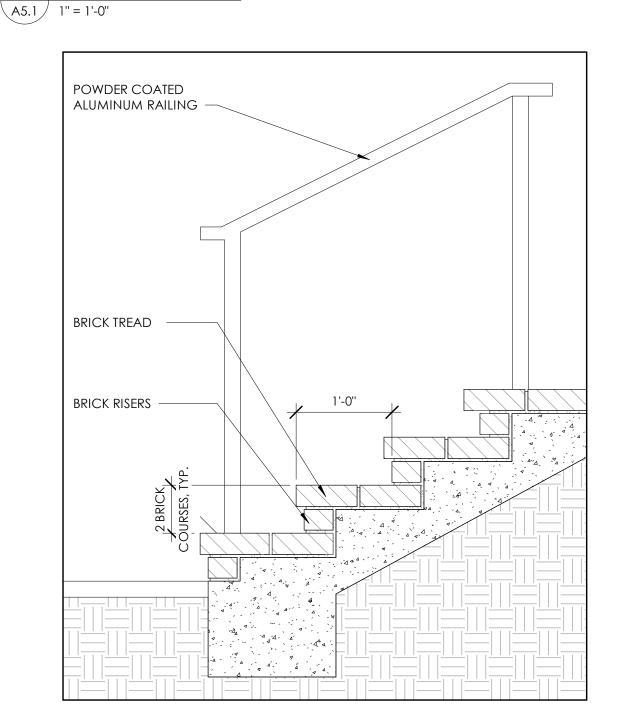


3 BRICK STAIR DETAIL, TYP.
A5.1 1" = 1'-0"



TABBY STUCCO BRICK STRETCHER COURSE (OR AS INDICATED ON PLAN) - 45 DEGREE CUT, TYP. FACE BRICK AS SELECTED, TYP. **NOTE:** SEE STRUCTURAL ENG. DOCUMENTS FOR HORIZ. TIE & JOINT REINF. DETAILS & SPACING FOR ALL BRICK WORK SOLID BRICK CORNER, FINISH & COLOR AS SELECTED AT ALL PORCHES AND STAIRS **NOTE:** DETAILS SHOWN IN STANDARD MODULAR BRICK

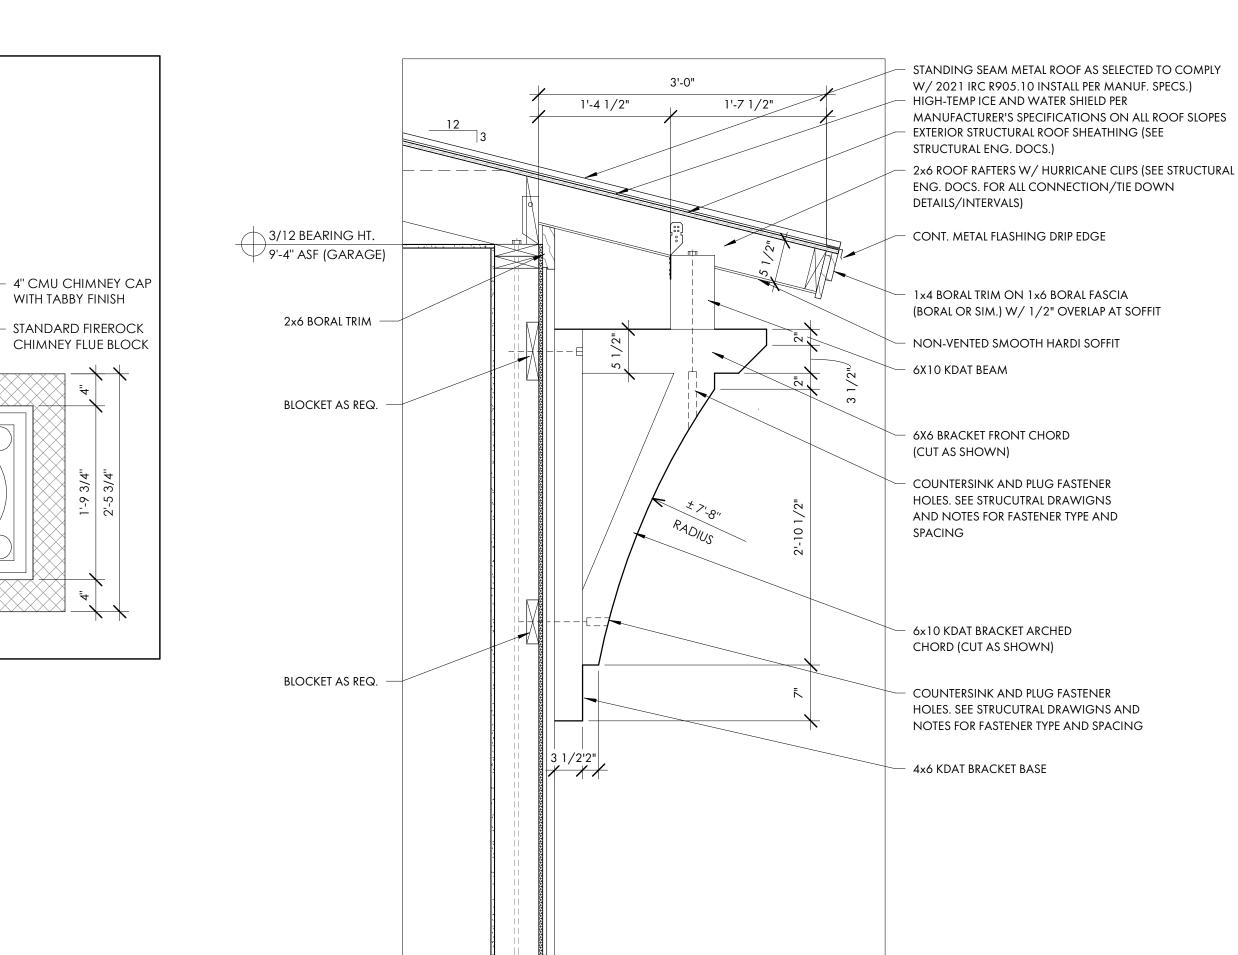

5 3/12 BRACKET DETAIL AT GARAGE
A5.1 1" = 1'-0"

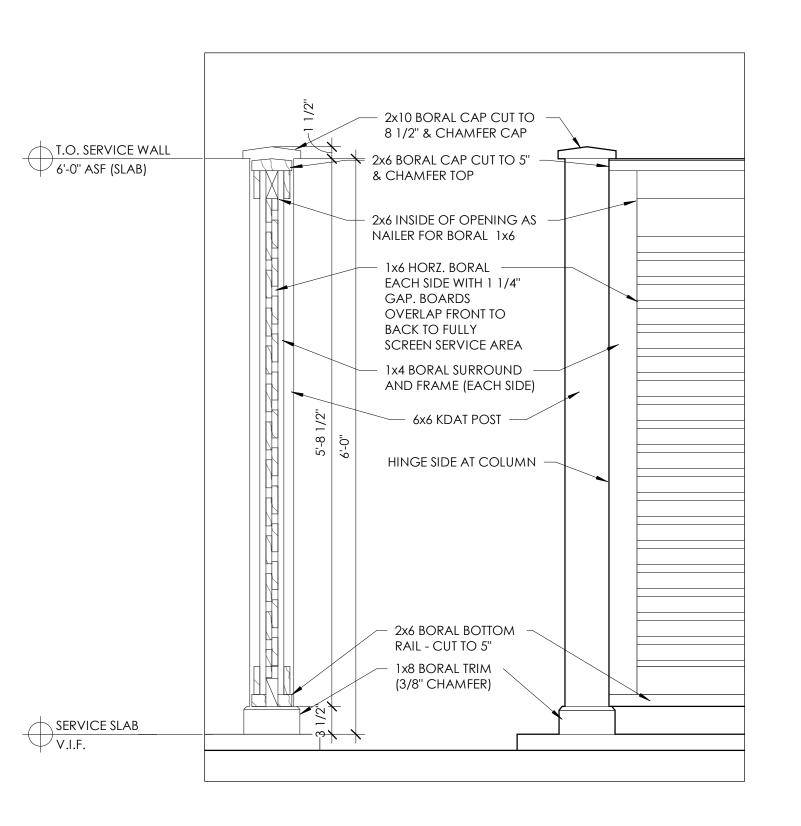

6 SERVICE YARD DETAIL


GROUP

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26 TAI SC





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PROJECT INFO Date

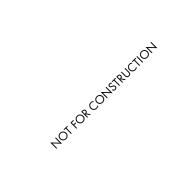
12/06/2023

Project No. 23-065 **ISSUE** 

NO. REV. DATE DESCRIPTION

SHEET TITLE

DETAILS

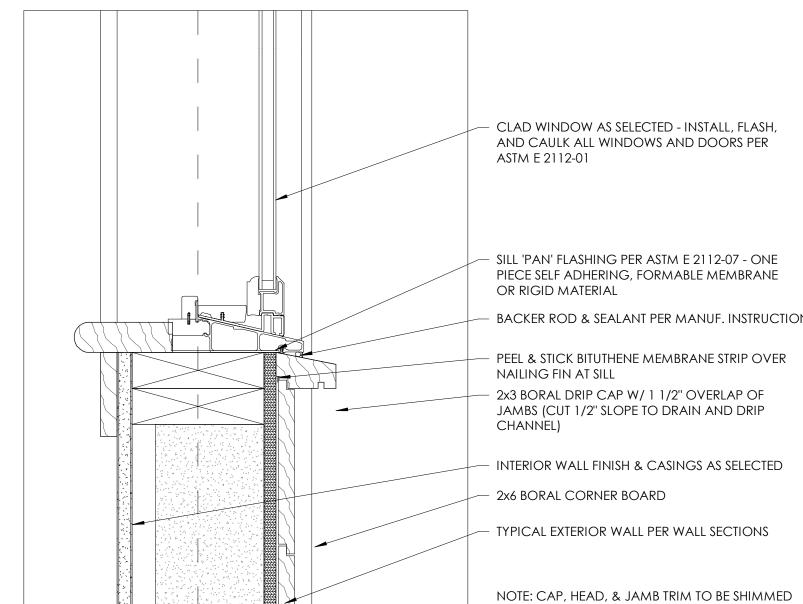

BACKER ROD & SEALANT PER MANUF. INSTRUCTIONS


1C WINDOW SILL DETAIL

1A WINDOW HEAD DETAIL
A5.1 3" = 1'-0"


1B WINDOW JAMB DETAIL

A5.1 3" = 1'-0"

4 PORCH CORNER, TYP.

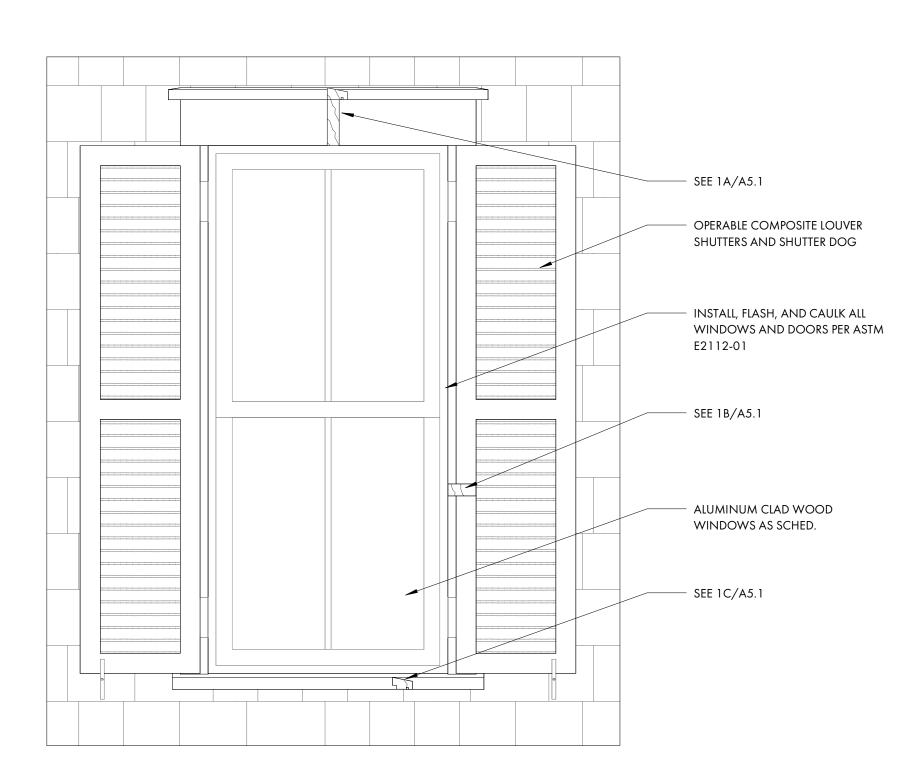

1 WINDOW SHUTTER DETAIL
A5.2 1" = 1'-0"

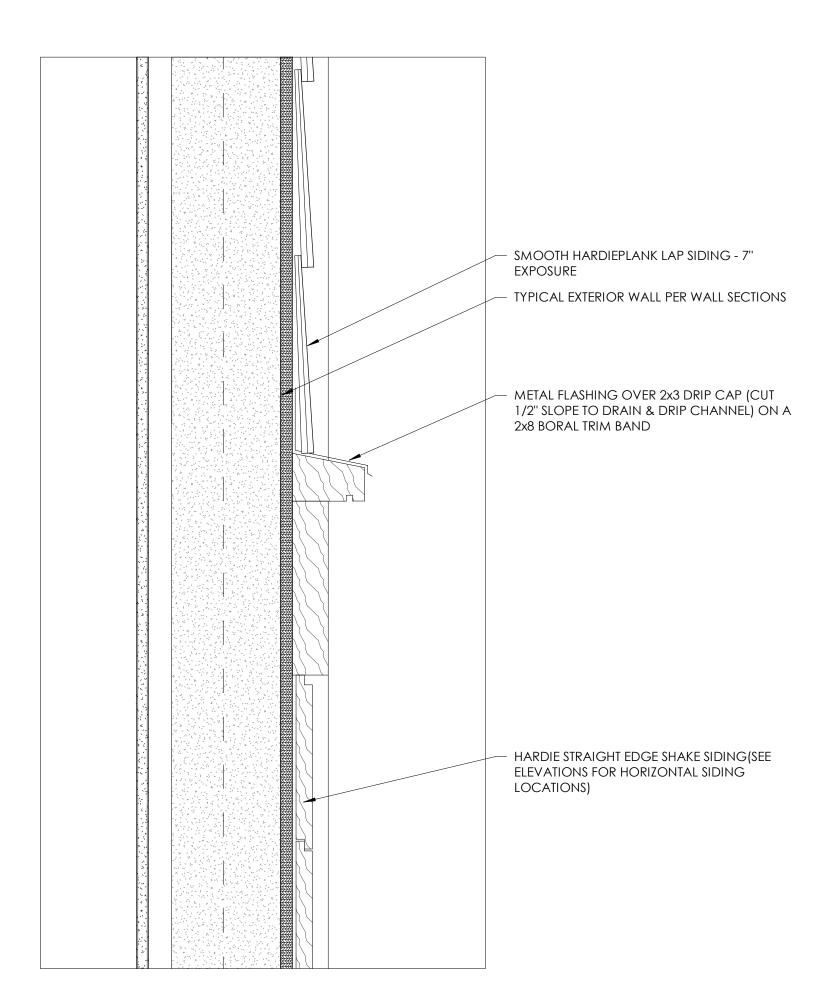





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PROJECT INFO

Date 12/06/2023

ISSUE

Project No. 23-065

NO. REV. DATE DESCRIPTION

SHEET TITLE

DETAILS

#### **CAG - WINDOW SCHEDULE**


U-VALUE AND SOLAR HEAT GAIN FACTOR TO COMPLY W/ ALL APPLICABLE ENERGY CODES, BUILDING CODES AND REGULATORY REQUIREMENTS OR APPROVED EQUIVALENT OR AS SPECIFIED BY ENGINEER. ASSUME MINIMUM U-VALUE OF 0.30 AND MINIMUM SHGC OF 0.30

DP 50 RATING OR EQUIVALENT BY G.C./ STRUCTURAL ENGINEER AND TO COMPLY WITH ALL APPLICABLE BUILDING CODES AND REGULATORY REQUIREMENTS.


Type Mark	Window Type	Description	Rough Width	Rough Height	Head Height	Design Pressure	Comments
Α	CLAD CASEMENT UNIT	2'-6" x 3'-6"	2'-6"	3'-6"	8'-4"		SEE ELEVATION
В	CLAD DOUBLE HUNG UNIT	3'-0" x 6'-0"	3'-0"	6'-0"	8'-0"		SEE ELEVATION
D	CLAD DOUBLE HUNG UNIT	2'-6" x 5'-6"	2'-6"	5'-6"	8'-4"		SEE ELEVATION
Е	CLAD DOUBLE HUNG UNITS	(2) 2'-6" x 5'-0"	5'-0"	5'-0"	8'-4"		SEE ELEVATION
F	CLAD DOUBLE HUNG UNIT	2'-6" x5'-0"	2'-6"	5'-0"	<varies></varies>		SEE ELEVATION - HEAD HT. VARIES
G	CLAD DOUBLE HUNG UNIT	2'-6" x4'-6"	2'-6"	4'-6"	7'-0"		SEE ELEVATION

PROVIDE WOOD STRUCTURAL PANELS, IMPACT PANELS OR IMPACT RESISTANCE GLAZING FOR OPENING PROTECTION AT ALL NEW WINDOWS, SKYLIGHTS AND DOORS IN ACCORDANCE W/ SECTION R301.2.1.2 OF THE 2021 INTERNATIONAL RESIDENTIAL BUILDING CODE. FASTENING SHALL BE BY MEANS OF CORROSION RESISTANT MACHINE SCREWS FASTENED TO PERMANENTLY INSTALLED THREADED RECEIVERS LAG BOLTED INTO THE FRAMING. EACH VIBRATION-RESISTANT RECEIVER SHALL HAVE A MINIMUM WITHDRAWAL CAPACITY OF 490 POUNDS. SEAL AROUND EACH RECEIVER W/ A SUITABLE SEALANT. ALL PANELS MUST BE PRECUT, LABELED AND STORED ON SITE.


G.C. TO COORDINATE ROUGH OPENINGS PER MANUFACTURERS SPECIFICATIONS G.C. TO PREPARE EXTERIOR OPENINGS PER ASTM E2112-07.

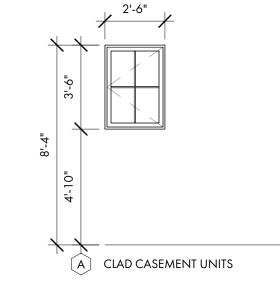

2'-6" x 3'-6" (R.O. ± ) SDL MUNTINS W/ SPACER BAR (PATTERN AS SHOWN) MANUFACTURER T.B.D. BY G.C. / OWNER DP RATING 50 OR APPROVED EQUIVALENT

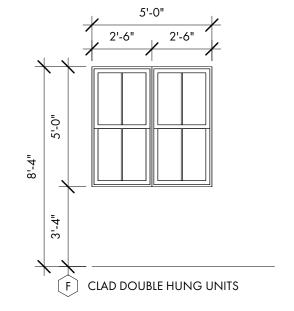


(2) 2'-6" x 5'-0" (R.O. ± 5'-0" x 5'-0") SDL MUNTINS W/ SPACER BAR (PATTERN AS MANUFACTURER T.B.D. BY G.C. / OWNER DP RATING 50 OR APPROVED EQUIVALENT

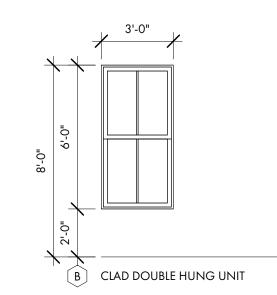


3'-0" x 6'-0" (R.O. ±) SDL MUNTINS W/ SPACER BAR (PATTERN AS MANUFACTURER T.B.D. BY G.C. / OWNER

DP RATING 50 OR APPROVED EQUIVALENT

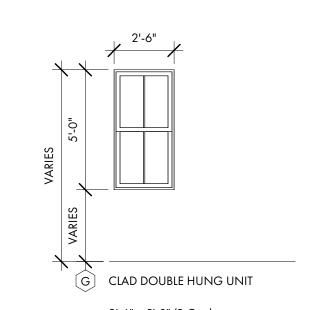


2'-6" x 5'-0" (R.O. ±) SDL MUNTINS W/ SPACER BAR (PATTERN AS MANUFACTURER T.B.D. BY G.C. / OWNER DP RATING 50 OR APPROVED EQUIVALENT

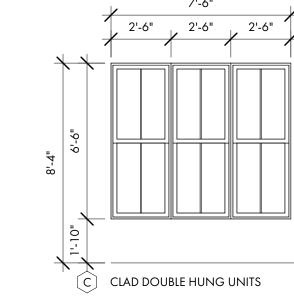

(3) 2'-6" x 6'-6" (R.O. ± 7'-6" x 6'-6") SDL MUNTINS W/ SPACER BAR (PATTERN AS MANUFACTURER T.B.D. BY G.C. / OWNER

DP RATING 50 OR APPROVED EQUIVALENT

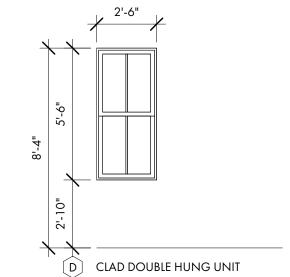


2'-6" x 5'-6" (R.O. ±) SDL MUNTINS W/ SPACER BAR (PATTERN AS MANUFACTURER T.B.D. BY G.C. / OWNER DP RATING 50 OR APPROVED EQUIVALENT




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2'-6" x 4'-6" (R.O. ±) SDL MUNTINS W/ SPACER BAR (PATTERN AS MANUFACTURER T.B.D. BY G.C. / OWNER

DP RATING 50 OR APPROVED EQUIVALENT

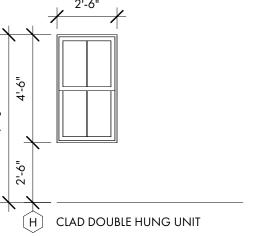

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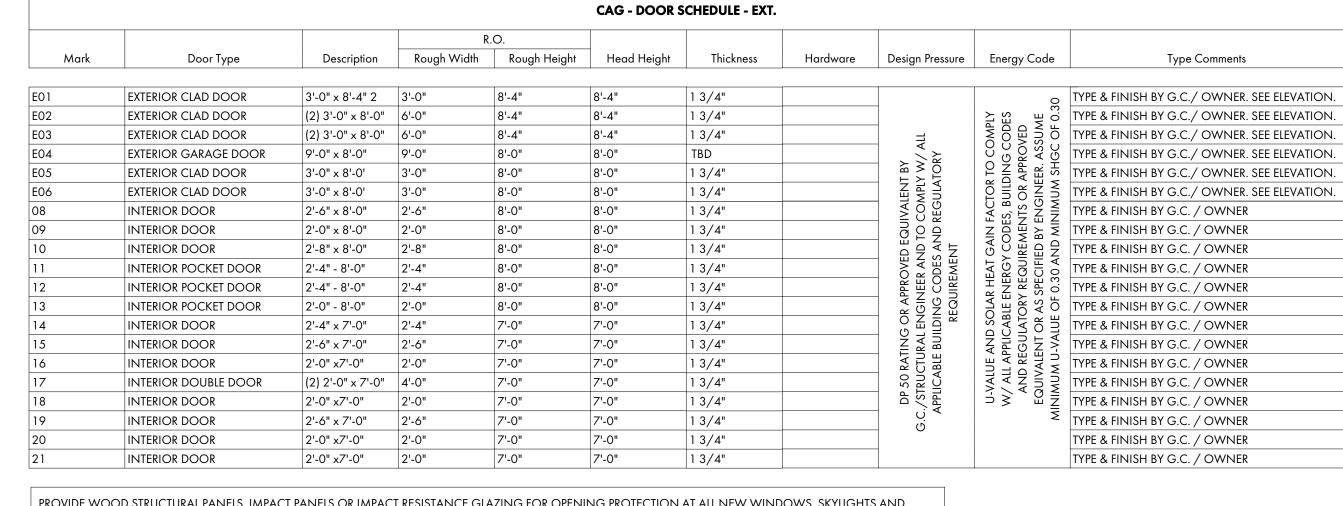
PROJECT INFO Date 12/06/2023


Project No. 23-065

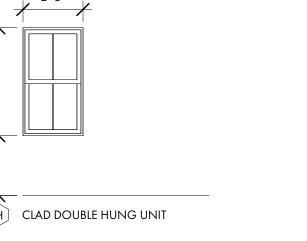**ISSUE** 

NO. REV. DATE DESCRIPTION


DOOR AND WINDOW



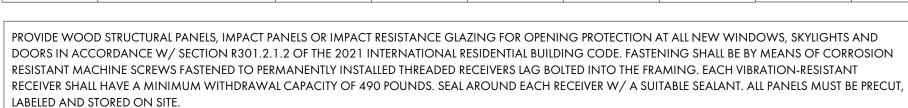

G.C. TO COORDINATE ROUGH OPENINGS PER MANUFACTURERS SPECIFICATIONS G.C. TO PREPARE EXTERIOR OPENINGS PER ASTM E2112-07.


NOTE: ADJUST DOOR HEIGHT TO PROVIDE TRUE 8'-0" R.O. TO ALIGN WITH WINDOWS AND EXTERIOR DOORS.

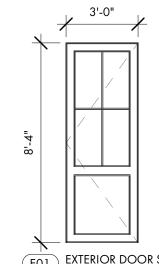

EXTERIOR DOOR SYSTEM (FIR DOOR) INSWING DOOR 3'-0" x 8'-4" (R.O. ±) SDL MUNTINS W/ SPACE BAR (PATTERN AS SHOWN) MANUFACTURER T.B.D. BY G.C. / OWNER


ADJUST DOOR HEIGHT TO ENSURE TRUE 8'-4" ROUGH OPENING - TOP OF DOOR TO ALIGN W/ TOP OF ADJACENT WINDOWS

DP RATING 50 OR APPROVED EQUIVALENT

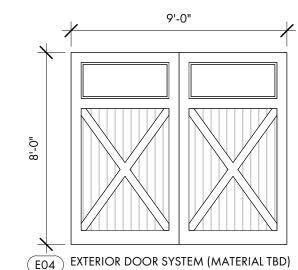

GARAGE DOOR 9'-0" x 8'-0" (R.O. ±)


> MANUFACTURER T.B.D. BY G.C. / OWNER DP RATING 50 OR APPROVED EQUIVALENT

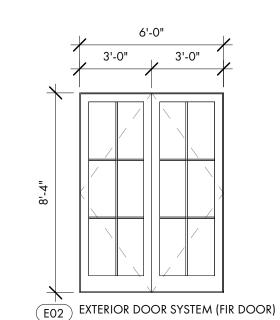

OUTSWING DOOR (2) 3'-0" x 8'-4" (R.O. ± 6'-0" x 8'-4") SDL MUNTINS W/ SPACE BAR (PATTERN AS SHOWN) MANUFACTURER T.B.D. BY G.C. / OWNER

DP RATING 50 OR APPROVED EQUIVALENT

ADJUST DOOR HEIGHT TO ENSURE TRUE 8'-4" ROUGH OPENING - TOP OF DOOR TO ALIGN W/TOP OF ADJACENT WINDOWS

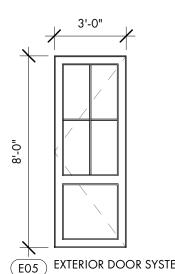


E05 EXTERIOR DOOR SYSTEM (FIR DOOR) INSWING DOOR E06 3'-0" x 8'-0" (R.O. ±) SDL MUNTINS W/ SPACE BAR (PATTERN AS SHOWN)

> ADJUST DOOR HEIGHT TO ENSURE TRUE 8'-0" ROUGH OPENING - TOP OF DOOR TO ALIGN W/TOP OF ADJACENT WINDOWS

MANUFACTURER T.B.D. BY G.C. / OWNER

DP RATING 50 OR APPROVED EQUIVALENT

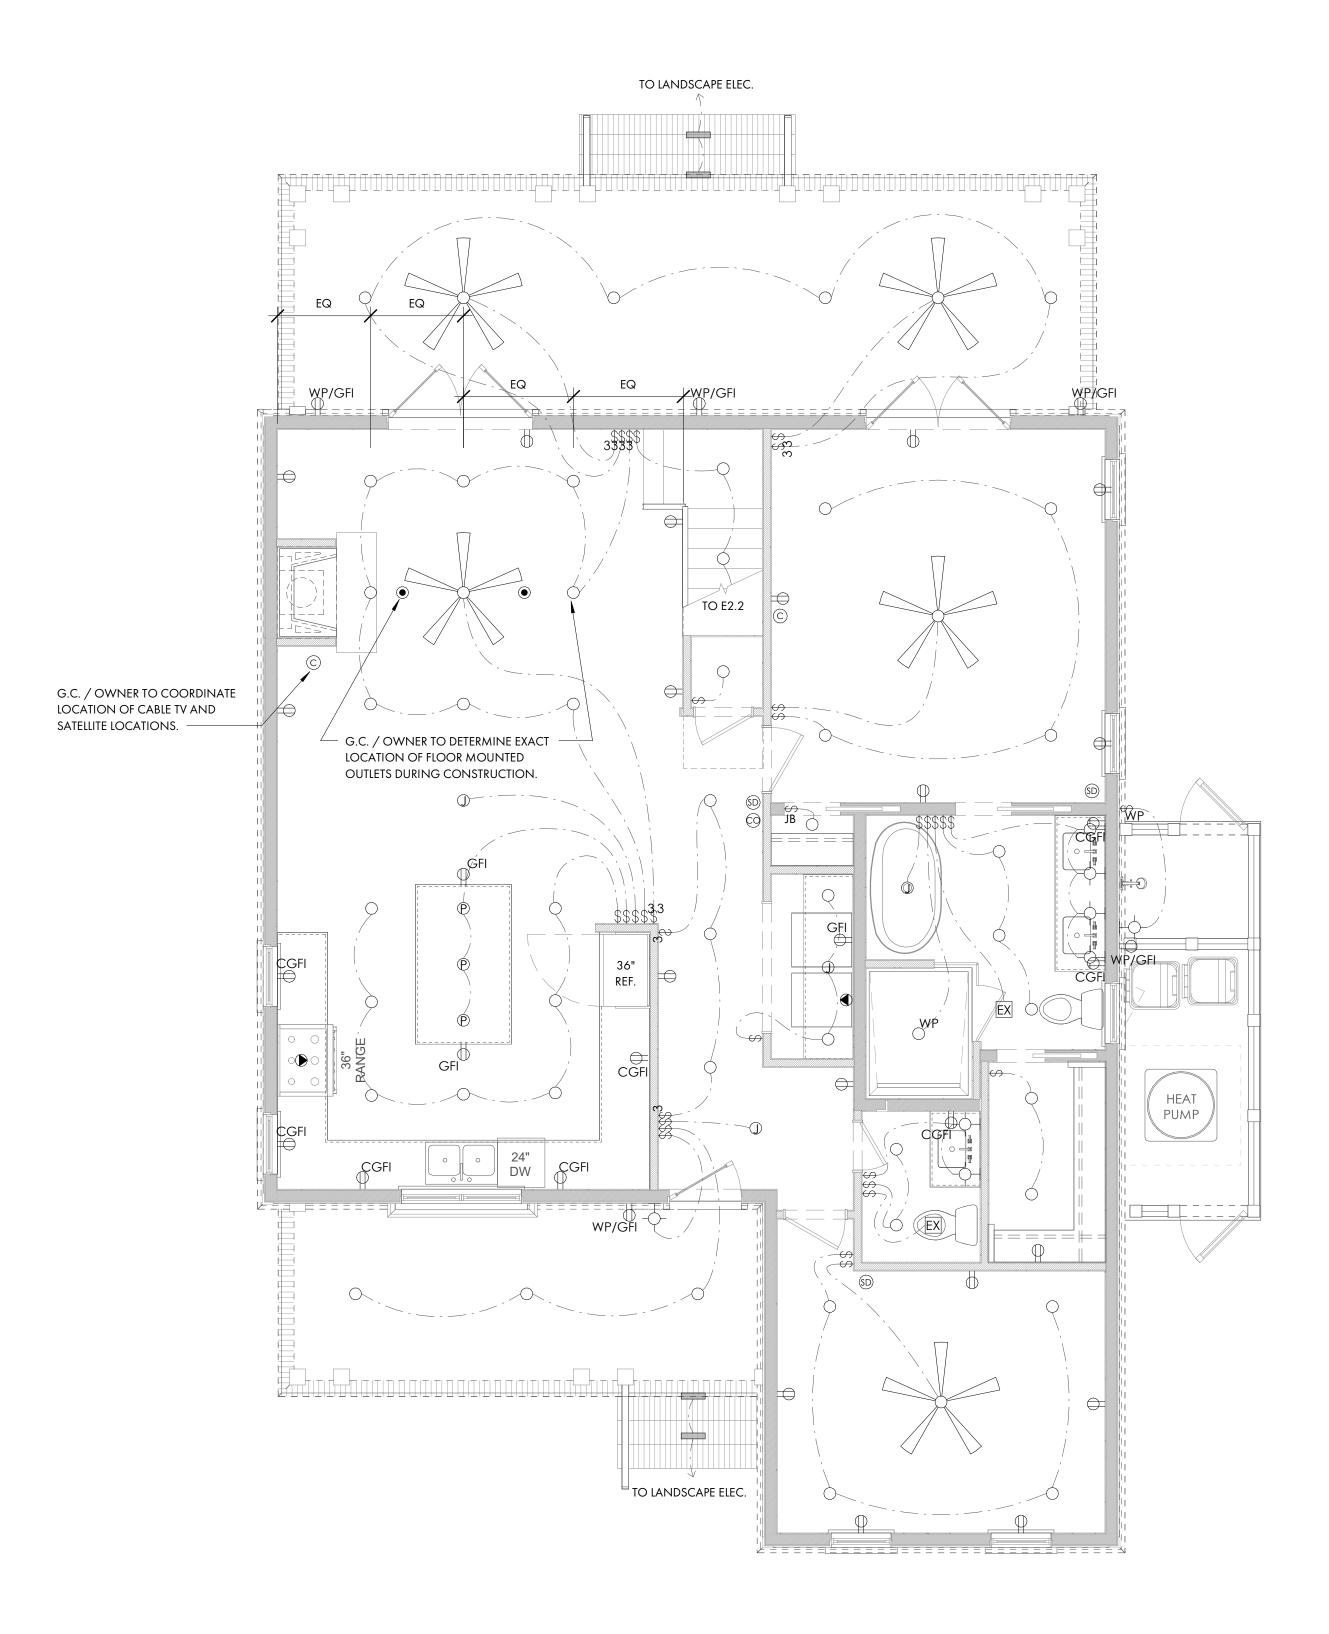

**ELECTRICAL PLAN - SYMBOL KEY**  COORDINATE TELEPHONE,  $\Rightarrow$ DUPLEX RECEPTACLE COMMUNICATIONS AND SPEAKER OUTLET LOCATIONS WITH GC/OWNER  $\Rightarrow_{\mathsf{GFI}}$ GFI RECEPTACLE 2. VERIFY ALL SWITCH AND POWER LOCATIONS IN FIELD. COUNTERTOP LEVEL GFI RECEPTACLE ALL SWITCHES TO BE 42" A.F.F. UNLESS OTHER-WISE NOTED.  $\Rightarrow_{\mathsf{GFI}}$ GFI IN WATERPROOF BOX GENERAL CONTRACTOR TO VERIFY SIZING OF SERVICE TO ACCOMMODATE ALL FIXTURES. ALL UNDER-COUNTER RECEPTACLE PANELS SHOULD BE LOCATED WITH GC/OWNER IN FIELD. SWITCH DUPLEX RECEPTACLE ALL OUTLETS AND FIXTURES TO BE LOCATED ABOVE FLOOD LEVEL. 220V RECEPTACLE ASSUME STANDARD TOGGLE SWITCHES AND PLATES UNLESS OTHERWISE NOTED. FLOOR RECEPTACLE ALL OUTLETS TO BE HORIZONTALLY INSTALLED, CENTERED ON WINDOWS, SWITCH and in baseboards, where POSSIBLE. 3-WAY SWITCH 8. SEE LIGHTING SCHEDULE FOR FIXTURE TYPES. ALL FIXTURES BY OWNER/G.C. 4-WAY SWITCH 9. OWNER/G.C. TO DETERMINE FINAL HVAC ZONING REQUIREMENTS. WATERPROOF SWITCH 10. OWNER/G.C. TO DETERMINE OPTIMAL THERMOSTAT LOCATIONS OR PROVIDE FOR REMOTE THERMOSTAT DIMMER SWITCH SENSORS. 11. OWNER/G.C. TO DETERMINE AND CABLE COORDINATE GROUND FAULT INTERRUPTERS, ARC FAULT INTERRUPTERS, AND SURGE PROTECTION TO BE PROVIDED SMOKE DETECTOR AT REMOTE POINTS OR AT PRIMARY LOCATIONS. CARBON MONOXIDE DETECTOR OWNER/G.C. TO DETERMINE AND RESIDENC COORDINATE FINAL EXTENT OF WATER SERVICE: SERVICE MAY INCLUDE A RECESSED CAN LIGHT COMBINATION OF RENNAI INSTANT HOT WATER SYSTEMS, REMOTE DIRECTIONAL CAN LIGHT TEMPERATURE CONTROLS, AND BACK-UP WATER STORAGE TANKS. SERVICE MAY ALSO INCLUDE A WATER WATERPROOF CAN LIGHT FILTRATION/ CONDITIONING SYSTEM AND/OR A REVERSE OSMOSIS SYSTEM. OWNER/G.C. TO DETERMINE AND JUNCTION BOX COORDINATE ANY EXTENT OF SMART HOUSE TECHNOLOGY, INCLUDING PENDANT LIGHT RADIO RA OR CRESTRON SYSTEMS, PC INTEGRATION, A/V REQUIREMENTS, S HVAC INTEGRATION, SECURITY AND **WALL SCONCE** LIGHTING INTEGRATION, AND "DIAL-IN" TECHNOLOGY. )——( UNDERCABINET LIGHT 14. OWNER/G.C. TO DETERMINE AND COORDINATE FINAL LOCATION OF IN GROUND PROPANE TANK SERVICE OR PIN LIGHT NATURAL GAS SERVICE IF APPLICABLE. OWNER/G.C. TO DETERMINE AND STEP LIGHT COORDINATE LANDSCAPE LIGHTING. 16. OWNER/G.C. TO COORDINATE EXTENT EXHAUST FAN OF DIMMER SWITCH LOCATIONS. 17. KITCHEN CABINET AND APPLIANCE DOOR BELL LOCATIONS ARE APPROXIMATE. OWNER/G.C. TO DETERMINE FINAL LOCATION AND PLACEMENT AND DOOR BELL CHIME COORDINATE ALL ELECTRICAL, POWER, AND LIGHTING REQUIREMENTS WITH SHOP DRAWINGS AND EQUIPMENT SPECIFICATIONS AS NEEDED. POWER 2' X 2' FLUORESCENT REQUIREMENTS TO MEET ALL APPLICABLE CODES. 18. OWNER/G.C. TO DETERMINE AND COORDINATE LOCATION AND FIXTURE FOR WALL MOUNTED JUNCTION BOX. 2' X 4' FLUORESCENT 19. ALL RECEPTACLES LOCATED IN THE SLEEPING ROOMS SHALL BE ARC FAULT PROTECTED PER IRC SECTION PROJECT INFO E3902.16. CEILING FAN 20. OWNER/G.C. TO COORDINATE Date LIGHTING FOR ALL HVAC APPLIANCES LOCATED IN THE ATTIC PER 2015 IRC 12/06/2023 SECTION M1305.1.3. ELECTRIC METER Project No. 21. OWNER/G.C. TO DETERMINE AND COORDINATE LOCATIONS FOR SMOKE 23-065 NOTE: G.C. TO COORDINATE FINAL DETECTORS INSIDE AND OUTSIDE OF LOCATION TO PROVIDE CLEARANCE EACH SLEEPING ROOM AS REQUIRED PER **ISSUE** PER 2018 IRC SECTION E3405.1 IRC SECTION R314.




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' SHELL ROAD, DADS, BLUFFTON, 26 TABBY STABBY STABBY SC 29910





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22. ALL GROUNDING POINTS AVAILABLE TO CONFORM TO 2015 IRC SECTIONS 3607-3611.

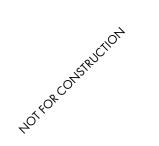CIRCUIT PANEL BOX

NOTE: G.C. TO COORDINATE FINAL

LOCATION TO PROVIDE CLEARANCE PER 2018 IRC SECTION E3405.1


23. AT LEAST 75% OF THE LAMPS INSTALLED IN PERMANENT LIGHT FIXTURES TO BE HIGH EFFICIENCY LAMPS PER 2015 IRC SECTION N1104.1.

SHEET TITLE

FIRST FLOOR ELEC. PLAN

NO. REV. DATE DESCRIPTION



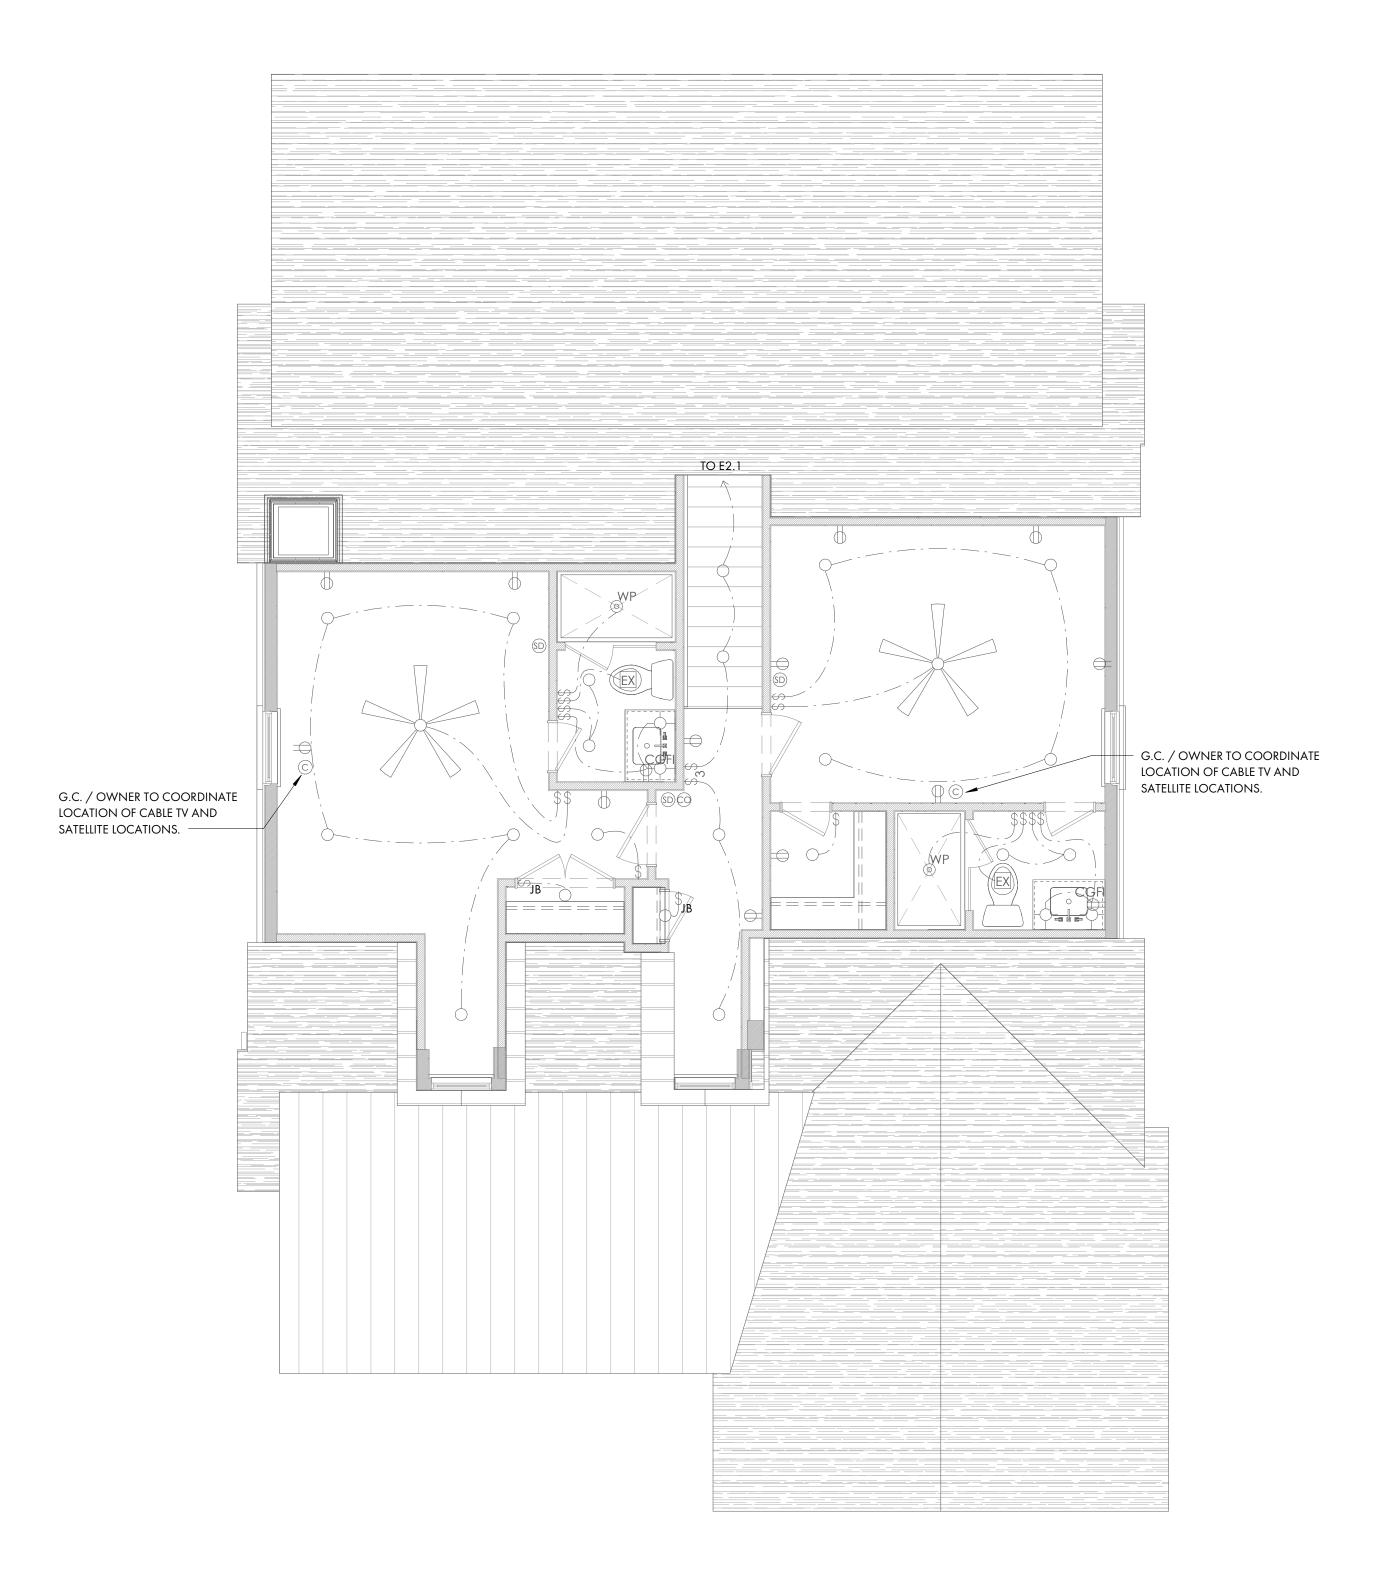


ELECTRICAL	L PLAN - SYMBOL KEY			
$\Rightarrow$	DUPLEX RECEPTACLE	1.	COORDINATE TELEPHONE, COMMUNICATIONS AND SPEAKER OUTLET LOCATIONS WITH GC/OWNER	
$\mathop{igoplus}_{GFI}$	GFI RECEPTACLE	2.	VERIFY ALL SWITCH AND POWER LOCATIONS IN FIELD.	COL
⊕ <sub>C</sub> GFI	COUNTERTOP LEVEL GFI RECEPTACLE	3.	ALL SWITCHES TO BE 42" A.F.F. UNLESS OTHER-WISE NOTED.	ATKI
⊕ <sub>GFI</sub> WP	GFI IN WATERPROOF BOX	4.	GENERAL CONTRACTOR TO VERIFY SIZING OF SERVICE TO	GRO
⊕ <sub>UC</sub>	UNDER-COUNTER RECEPTACLE		ACCOMMODATE ALL FIXTURES. ALL PANELS SHOULD BE LOCATED WITH GC/OWNER IN FIELD.	
<del></del>	SWITCH DUPLEX RECEPTACLE	5.	ALL OUTLETS AND FIXTURES TO BE LOCATED ABOVE FLOOD LEVEL.	POST OFFICE E BLUFFTON, S PH: 843.81
•	220V RECEPTACLE	6.	ASSUME STANDARD TOGGLE	FX: 843.81
•	FLOOR RECEPTACLE		SWITCHES AND PLATES UNLESS OTHERWISE NOTED.	WWW.COURTA
\$	SWITCH	7.	ALL OUTLETS TO BE HORIZONTALLY INSTALLED, CENTERED ON WINDOWS, AND IN BASEBOARDS, WHERE POSSIBLE.	
\$ <sup>3</sup>	3-WAY SWITCH	8.	SEE LIGHTING SCHEDULE FOR FIXTURE TYPES. ALL FIXTURES BY OWNER/G.C.	
\$ <sup>4</sup>	4-WAY SWITCH	9.	OWNER/G.C. TO DETERMINE FINAL	
\$ <sup>WP</sup>	WATERPROOF SWITCH	10.	HVAC ZONING REQUIREMENTS.  OWNER/G.C. TO DETERMINE OPTIMAL	
\$ <sup>D</sup>	DIMMER SWITCH		THERMOSTAT LOCATIONS OR PROVIDE FOR REMOTE THERMOSTAT SENSORS.	
С	CABLE	11.	OWNER/G.C. TO DETERMINE AND COORDINATE GROUND FAULT	
(SD)	SMOKE DETECTOR		INTERRUPTERS, ARC FAULT INTERRUPTERS, AND SURGE PROTECTION TO BE PROVIDED AT REMOTE POINTS OR AT PRIMARY LOCATIONS.	
60	CARBON MONOXIDE DETECTOR	12.	OWNER/G.C. TO DETERMINE AND	Ш
$\circ$	RECESSED CAN LIGHT		COORDINATE FINAL EXTENT OF WATER SERVICE: SERVICE MAY INCLUDE A COMBINATION OF RENNAI INSTANT	
$\Diamond$	DIRECTIONAL CAN LIGHT		HOT WATER SYSTEMS, REMOTE TEMPERATURE CONTROLS, AND BACK- UP WATER STORAGE TANKS. SERVICE	SIDEN
○ <sup>WP</sup>	WATERPROOF CAN LIGHT		MAY ALSO INCLUDE A WATER FILTRATION/ CONDITIONING SYSTEM AND/OR A REVERSE OSMOSIS SYSTEM.	<b>8</b>
$\circ$	JUNCTION BOX	13.	OWNER/G.C. TO DETERMINE AND COORDINATE ANY EXTENT OF SMART	/ELI
P	PENDANT LIGHT		HOUSE TECHNOLOGY, INCLUDING RADIO RA OR CRESTRON SYSTEMS, PC INTEGRATION, A/V REQUIREMENTS, HVAC INTEGRATION, SECURITY AND	SEWELL
<b>⊢</b> ∳-	WALL SCONCE		LIGHTING INTEGRATION, AND "DIAL- IN" TECHNOLOGY.	
)——(	undercabinet light	14.	OWNER/G.C. TO DETERMINE AND COORDINATE FINAL LOCATION OF IN GROUND PROPANE TANK SERVICE OR	,s
•	PIN LIGHT	15.	NATURAL GAS SERVICE IF APPLICABLE.  OWNER/G.C. TO DETERMINE AND	HOT FOR COLLECT
-	STEP LIGHT		COORDINATE LANDSCAPE LIGHTING.	40tx
EX	EXHAUST FAN	16.	OWNER/G.C. TO COORDINATE EXTENT OF DIMMER SWITCH LOCATIONS.	
H	DOOR BELL	1 <i>7</i> .	KITCHEN CABINET AND APPLIANCE LOCATIONS ARE APPROXIMATE. OWNER/G.C. TO DETERMINE FINAL	
HETH	DOOR BELL CHIME		LOCATION AND PLACEMENT AND COORDINATE ALL ELECTRICAL, POWER, AND LIGHTING REQUIREMENTS WITH SHOP DRAWINGS AND EQUIPMENT SPECIFICATIONS AS NEEDED. POWER	Hol <sup>kok Const</sup>
	2' X 2' FLUORESCENT		REQUIREMENTS TO MEET ALL APPLICABLE CODES.	
	2' X 4' FLUORESCENT	18.	OWNER/G.C. TO DETERMINE AND COORDINATE LOCATION AND FIXTURE FOR WALL MOUNTED JUNCTION BOX.	© COPYRIGHT 2023 COU GROUP - THIS DRAWING IS OF THE ARCHITECT AND IS REPRODUCED IN WHOLE C ANY MEANS OR METHOD V
	2 X 4 TEOORESCEIVI	19.	ALL RECEPTACLES LOCATED IN THE SLEEPING ROOMS SHALL BE ARC FAULT PROTECTED PER IRC SECTION E3902.16.	EXPRESS WRITTEN CONSE ARCHITECT. ANY UNAUTHO REPRODUCTION OR REUSI DOCUMENTS WILL RESULT PROJECT INFO
	CEILING FAN	20.	OWNER/G.C. TO COORDINATE LIGHTING FOR ALL HVAC APPLIANCES LOCATED IN THE ATTIC PER 2015 IRC SECTION M1305.1.3.	Date 12/06/2023
	ELECTRIC METER	21.	OWNER/G.C. TO DETERMINE AND COORDINATE LOCATIONS FOR SMOKE	Project No. 23-065
	NOTE: G.C. TO COORDINATE FINAL LOCATION TO PROVIDE CLEARANCE PER 2018 IRC SECTION E3405.1		DETECTORS INSIDE AND OUTSIDE OF EACH SLEEPING ROOM AS REQUIRED PER IRC SECTION R314.	ISSUE
	CIRCUIT PANEL BOX  NOTE: G.C. TO COORDINATE FINAL LOCATION TO PROVIDE CLEARANCE	22.	ALL GROUNDING POINTS AVAILABLE TO CONFORM TO 2015 IRC SECTIONS 3607-3611.	NO. REV. DATE <b>DESCRIP</b>
	PER 2018 IRC SECTION E3405.1	23.	AT LEAST 75% OF THE LAMPS INSTALLED IN PERMANENT LIGHT FIXTURES TO BE HIGH EFFICIENCY LAMPS	

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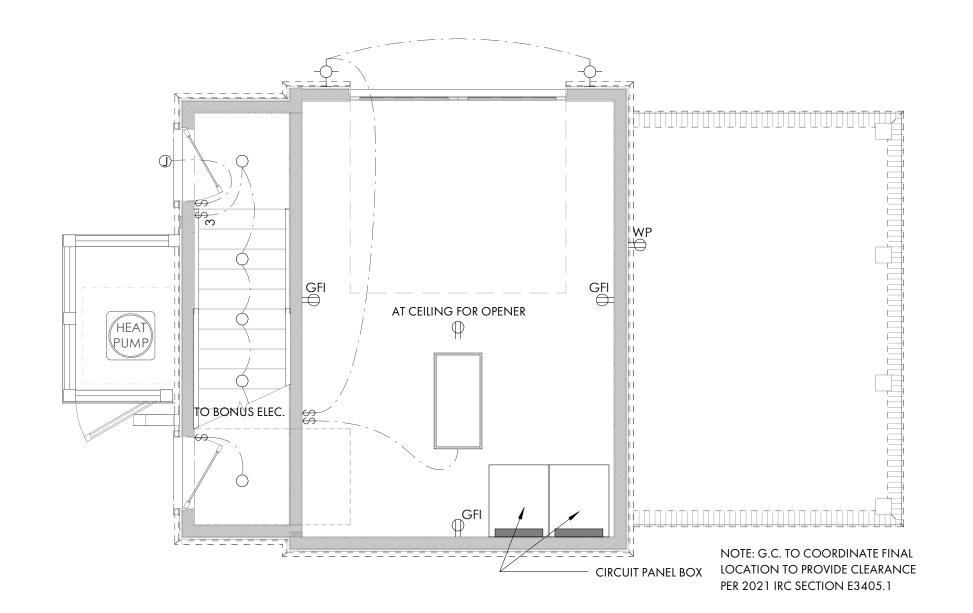


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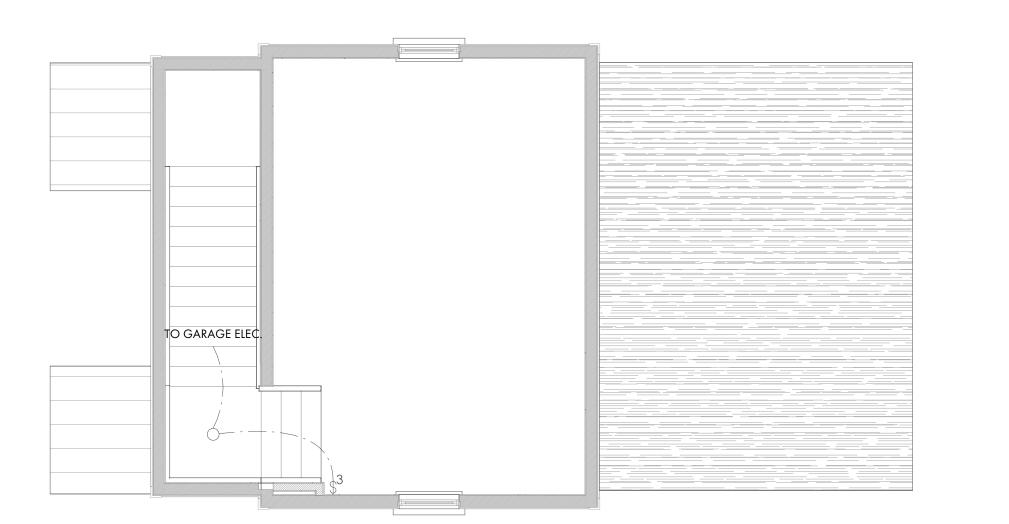
FIXTURES TO BE HIGH EFFICIENCY LAMPS PER 2015 IRC SECTION N1104.1.


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SECOND FLOOR ELEC.

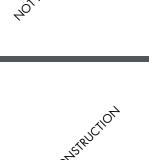







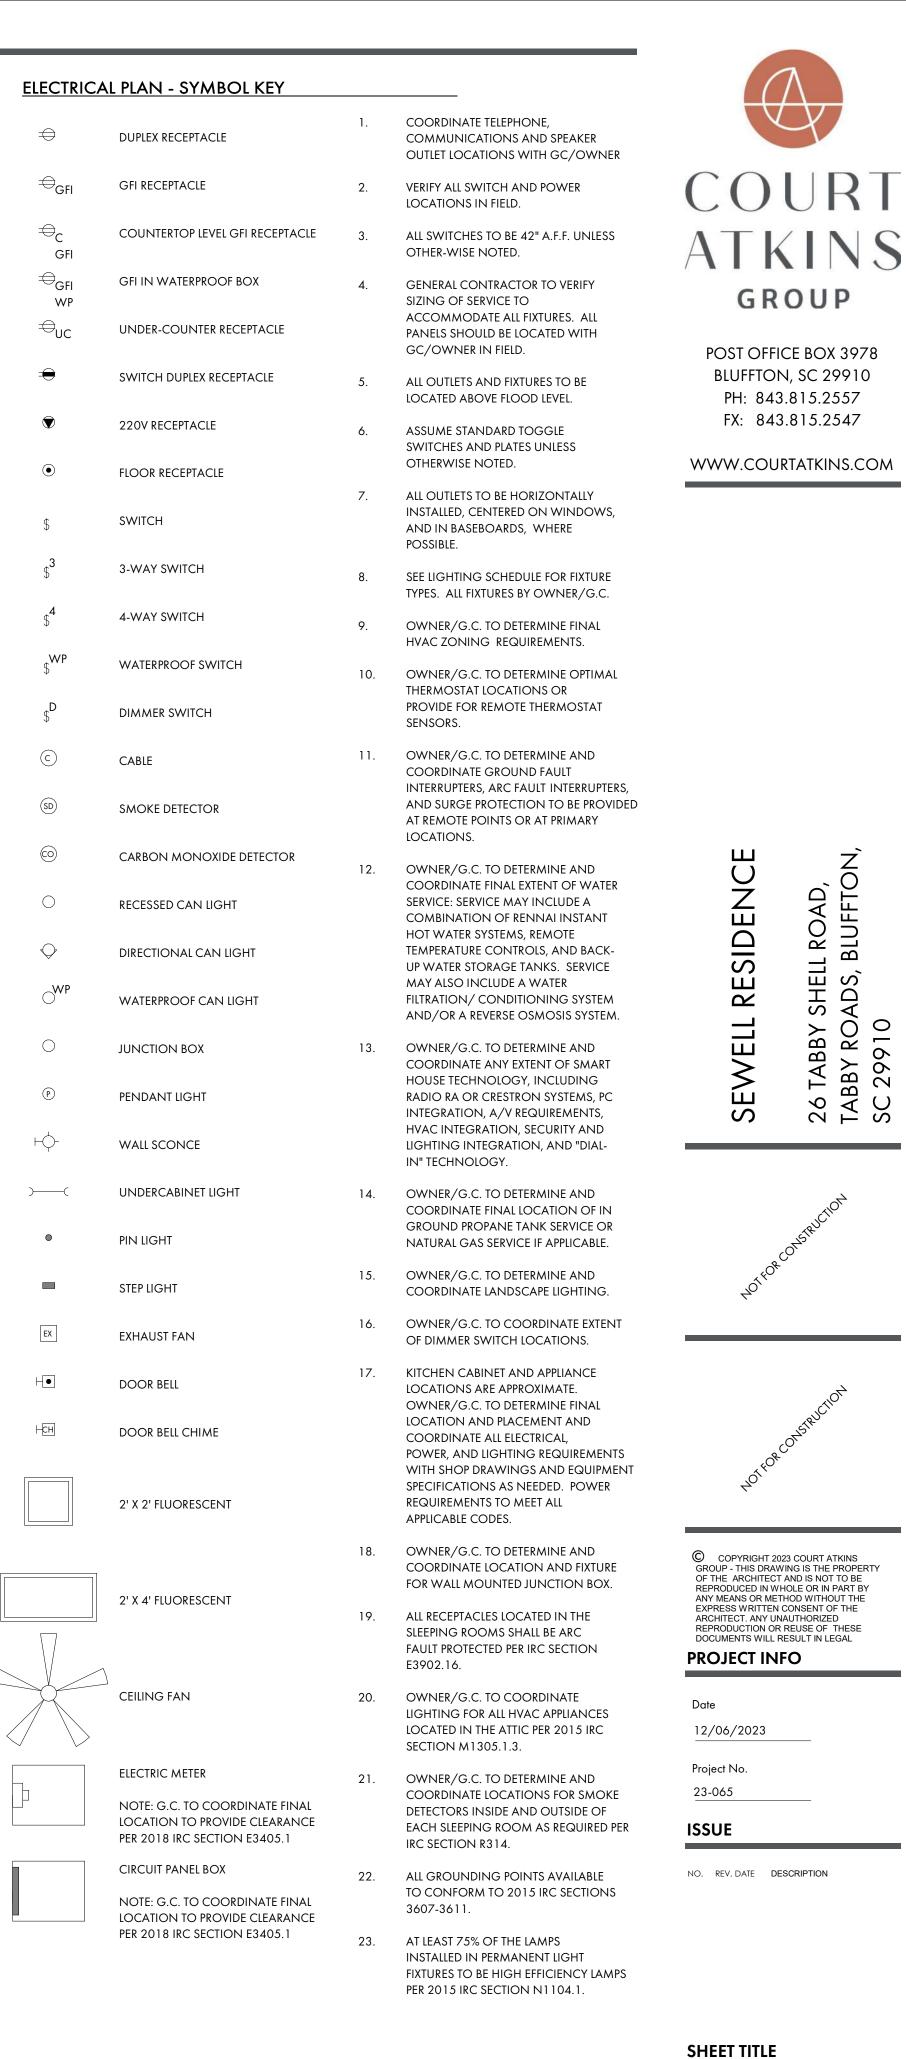

E2.3

CH ELEC. PLANS