

SITE DEVELOPMENT PLAN OF MAY RIVER CROSSING - CHIPOTLE

MAY RIVER CROSSING

BLUFFTON | BEAUFORT COUNTY | SOUTH CAROLINA

OWNER CERTIFICATION STATEMENT:

I, HEPBLUFF, LLC, CERTIFY THAT THE LAND DISTURBING ACTIVITY WILL BE ACCOMPLISHED ACCORDING TO THE PLAN ACCEPTED BY THE OWN OF BLUFFTON AND SCDHEC. I, HEPBLUFF, LLC, ACKNOWLEDGE AS THE PROPERTY OWNER AND PERSON ULTIMATELY RESPONSIBLE FOR THE LAND DISTURBING ACTIVITY AT THIS SITE AND THE RIGHT OF THE TOWN OF BLUFFTON OR SCDHEC TO CONDUCT ON-SITE INSPECTIONS.

ENGINEER CERTIFICATION STATEMENT:

I HAVE PLACED MY SIGNATURE AND SEAL ON THE DESIGN DOCUMENTS SUBMITTED SIGNIFYING THAT I ACCEPT RESPONSIBILITY FOR THE DESIGN OF THE SYSTEM. FURTHER, I CERTIFY TO THE BEST OF MY KNOWLEDGE AND BELIEF THAT THE DESIGN IS CONSISTENT WITH THE REQUIREMENTS OF TITLE 48, CHAPTER 14 OF THE CODE OF LAWS OF SC, 1976 AS AMENDED, PURSUANT TO REGULATION 72-300 ET SEQ. (IF APPLICABLE), AND IN ACCORDANCE WITH THE TERMS AND CONDITIONS OF SCR100000.

SCDHEC OCRM STORMWATER PERMIT #000000000 SCDHEC # 00000-WW SCDHEC # 00000-WS

TOWN OF BLUFFTON STORM WATER PERMIT #SWPTOWN OF BLUFFTON PERMIT #DP-08-25-019908

BJWSA #

VERTICAL DATUM: NAVD 88

PREPARED FOR:

ONPOINT PARTNERS, LLC

1315 WHITTAKER DRIVE COLUMBIA, SOUTH CAROLINA 26206


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AUGUST 22, 2025


LAST REVISED: 10/22/2025

J-26430.2000

PREPARED BY:



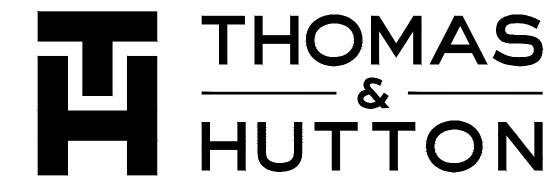

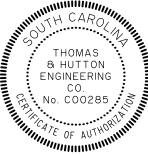



SCALE: 1" = 1000'

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	REVISION HISTORY		
REV. NO.	REVISION	BY	DATE

	SUBMITTAL HISTORY	
TOWN OF BLUFFTON		10/22/25
TOWN OF BLUFFTON		10/9/25
TOWN OF BLUFFTON		8/25/25
	SUBMITTED TO	DATE





50 Park of Commerce Way Savannah, GA 31405 p.912.234.5300

BY DATE

& HUTTON

ENGINEERING

No. C00285

REVISIONS

GENERAL NOTES

- CONTRACTOR SHALL VERIFY LOCATION & DEPTH OF ALL UTILITIES PRIOR TO BEGINNING WORK & NOTIFY ENGINEER OF ANY DISCREPANCIES.
- THE CONTRACTOR SHALL USE EXTREME CARE NOT TO DAMAGE EXISTING TREES WHICH ARE TO REMAIN.
- 3. ALL STORM DRAIN PIPE JOINTS SHALL BE WRAPPED WITH FILTER FABRIC. CONTRACTOR SHALL LIMIT CLEARING ACTIVITIES & TREE REMOVAL TO AREAS INDICATED ON PLAN.
- CONTRACTOR SHALL BE RESPONSIBLE FOR ANY AREA CLEARED OUTSIDE THE LIMITS AND ANY DAMAGE TO
- . ALL VERTICAL ELEVATIONS REFER TO NAVD 88 DATUM.
- ALL HORIZONTAL GEOMETRIES REFER TO NAD83 DATUM.

SPECIFICATIONS.

- CONTRACTOR SHALL BE RESPONSIBLE FOR ALL UNDERGROUND UTILITIES AND SHALL COORDINATE ALL WORK WITH THE OWNER AND UTILITY COMPANIES.
- THE DATA, TOGETHER WITH ALL OTHER INFORMATION SHOWN ON THESE PLANS OR IN ANY WAY INDICATED THEREBY, WHETHER BY DRAWINGS OR NOTES, OR IN ANY OTHER MANNER, ARE BASED UPON FIELD INVESTIGATIONS AND ARE BELIEVED TO BE INDICATIVE OF ACTUAL CONDITIONS. HOWEVER, THE SAME ARE
- SHOWN AS INFORMATION ONLY, ARE NOT GUARANTEED, AND DO NOT BIND THOMAS & HUTTON. ALL EXCAVATION AND BACKFILLING SHALL BE PERFORMED IN ACCORDANCE WITH THE TECHNICAL
- 10. ALL PROPOSED ELEVATIONS SHOWN ARE TOP OF PAVEMENT OR FINAL DIRT GRADE (INCLUDING TOPSOIL) IN GRASSED AREAS UNLESS OTHERWISE INDICATED.
- . CALL BEFORE YOU DIG: 1-800-282-7411. FOR COUNTY WATER AND SANITARY SEWER LINE LOCATIONS, CONTACT THE UTILITIES PROTECTION CENTER (1-800-282-7411) A MINIMUM OF SEVENTY-TWO (72) HOURS PRIOR
- GRASSED AND LANDSCAPE AREAS SHALL BE GRADED AS NECESSARY TO PROVIDE POSITIVE DRAINAGE. ALL PRECAUTIONS SHALL BE TAKEN TO PROTECT TREES RETAINED. PROVIDE 4" MIN. TOPSOIL IN ALL LANDSCAPE
- WATER MAINS SHALL BE LAID AT LEAST 10 FEET HORIZONTALLY FROM ANY EXISTING OR PROPOSED SANITARY SEWER, STORM SEWER, OR SEWER MANHOLE. THE DISTANCE SHALL BE MEASURED EDGE-TO-EDGE. A MINIMUM 18 INCHES VERTICAL SEPARATION MUST BE MAINTAINED.
- When Conditions Prevent a Horizontal Separation of 10 feet, the Water main may be laid closer to A SEWER (ON A CASE-BY-CASE BASIS) PROVIDED THE WATER MAIN IS LAID IN A SEPARATE TRENCH OR ON A UNDISTURBED EARTH SHELF LOCATED ON ONE SIDE OF THE SEWER AT SUCH AN ELEVATION WHERE THE BOTTOM OF THE WATER MAIN IS AT LEAST 18 INCHES ABOVE THE TOP OF THE SEWER. IT IS ADVISED THE SEWER BE CONSTRUCTED OF MATERIALS AND WITH JOINTS EQUIVALENT TO WATER MAIN STANDARDS OF CONSTRUCTION
- THE MINIMUM DEPTH OF COVER OVER WATER LINES SHALL NOT BE LESS THAN 36" IN ANY CASE. WHERE IT IS IMPOSSIBLE TO MAINTAIN 36" COVER AND 18" MINIMUM SEPARATION, THE 36" COVER WILL BE MAINTAINED AND BOTH WATER AND SEWER LINES WILL BE CONSTRUCTED OF ONE SECTION EACH OF DUCTILE IRON PIPE. THE PIPES SHALL BE SUPPORTED AND CENTERED AT THE CROSSING WITH MECHANICAL JOINTS ON EACH LINE AT BOTH

AND BE PRESSURE TESTED TO ASSURE WATER-TIGHTNESS PRIOR TO BACKFILLING

- THE REQUIRED MINIMUM 3 FT. OF COVER SHALL BE MAINTAINED ON THE EXISTING DOMESTIC AND FIRE SERVICE LINES. EXTREME CARE SHALL BE TAKEN TO AVOID DAMAGE TO EXISTING WATER VALVES AND HYDRANTS. AT NO TIME SHALL FLOW TO DOMESTIC WATER AND FIRE PROTECTION SUPPLY LINES BE DISRUPTED.
- PIPE, FITTINGS, VALVES AND OTHER ACCESSORIES SHALL, UNLESS OTHERWISE DIRECTED, BE UNLOADED AT THE POINT OF DELIVERY, AND STORED WHERE THEY WILL BE PROTECTED AND WILL NOT BE HAZARDOUS TO TRAFFIC. THEY SHALL AT ALL TIMES BE HANDLED WITH CARE TO AVOID DAMAGE. THE INTERIOR OF ALL PIPE, FITTINGS AND OTHER ACCESSORIES SHALL BE KEPT FREE FROM DIRT AND FOREIGN MATTER AT ALL TIMES.
- ANY DEFECTIVE, DAMAGED, OR UNSOUND PIPE SHALL BE REJECTED. ALL FOREIGN MATTER OR DIRT SHALL BE REMOVED FROM THE INSIDE OF THE PIPE BEFORE IT IS LOWERED INTO ITS POSITION IN THE TRENCH AND SHALL BE KEPT CLEAN BY ACCEPTABLE MEANS DURING AND AFTER LAYING. CARE SHALL BE TAKEN TO PREVENT DIRT FROM ENTERING THE JOINT SPACE. AT TIMES WHEN PIPE LAYING IS NOT IN PROGRESS, THE OPEN ENDS OF THE PIPE SHALL BE CLOSED BY ACCEPTABLE MEANS AND NO TRENCH WATER SHALL BE PERMITTED TO ENTER THE PIPE.
- 19. CLEAN THE INTERIORS OF ALL PIPE BY BRUSHING, SWABBING OR WASHING OUT OF ALL DIRT BEFORE LAYING.
- O. FLUSH THE NEW WATER, SEWER, AND NON-POTABLE PIPE LINES UNTIL THE WATER RUNS CLEAR AT THE END OF ALL MAINS AND LATERALS. THIS SHOULD BE COMPLETED AFTER THE PRESSURE TEST AND BEFORE DISINFECTION. A MINIMUM FLUSHING VELOCITY OF 2.5 ft/sec MUST BE ACHIEVED TO PURGE ALL FOREIGN MATERIAL FROM ALL
- . ALL JURISDICTIONAL WETLANDS ARE SUBJECT TO FEDERAL PROSECUTION BY THE ARMY CORPS OF ENGINEERS FOR WETLAND VIOLATIONS.
- 22. THERE ARE NO PROPOSED JURISDICTIONAL WETLAND IMPACTS AS PART OF THIS PROJECT.
- 23. CONTRACTOR IS RESPONSIBLE FOR CONNECTING BUILDING ROOF LEADS, WATER CONNECTIONS, AND SANITARY CONNECTIONS. ALL LOCATIONS AND ELEVATIONS TO BE VERIFIED WITH BUILDING ARCHITECTURAL, PLUMBING AND FIRE PROTECTION PLANS. CONTRACTOR REQUIRED TO COORDINATE ALL BUILDING LEAD LOCATIONS AND ELEVATIONS WITH BUILDING CONTRACTOR PRIOR TO INSTALLATION.
- 24. REFERENCE SURVEYS: THOMAS & HUTTON
- 25. ALL WATER USED FOR CONSTRUCTION SHALL BE METERED THROUGH AN ACCEPTABLE BACKFLOW PREVENTION DEVICE AND FIRE HYDRANT METER OBTAINED FROM EFFINGHAM COUNTY.
- 6. AN ACCEPTABLE WATER SUPPLY FOR FIRE PROTECTION, EITHER TEMPORARY OR PERMANENT, SHALL BE MADE AVAILABLE AS SOON AS COMBUSTIBLE MATERIAL ARRIVES ON THE SITE.
- ALL MATERIALS USED AND COME INTO CONTACT WITH DRINKING WATER DURING ITS DISTRIBUTION SHALL NOT ADVERSELY AFFECT DRINKING WATER QUALITY AND PUBLIC HEALTH AND MUST BE CERTIFIED FOR CONFORMANCE WITH AMERICAN NATIONAL STANDARDS INSTITUTE/NATIONAL SANITATION FOUNDATION STANDARD 61 (ANSI/NSF STANDARD 61).
- 28. IN ALL WATER LINE PROJECTS, CARE WILL BE TAKEN TO KEEP THE INTERIOR OF THE WATER PIPE CLEAN PRIOR TO CONNECTION TO THE COUNTY SYSTEM. THIS WILL BE ACCOMPLISHED BY STRICT ADHERENCE TO BEAUFORT COUNTY SPECIFICATIONS.
- 29. CONTRACTOR SHALL COORDINATE TIE-IN OF NEW WATER AND SEWER FACILITIES WITH BJWSA.
- 30. CONTRACTOR RESPONSIBLE FOR PROVIDING ENGINEER AS-BUILT SURVEY IN AUTOCAD FORMAT. AS-BUILT SURVEY TO INCLUDE TWO COPIES OF SURVEY AND BE SIGNED BY REGISTERED LAND SURVEYOR IN THE STATE OF
- . GROUNDWATER RECHARGE PERMANENT STORMWATER INFILTRATION BASINS SHALL NOT BE CONSTRUCTED IN SIGNIFICANT RECHARGE AREAS HAVING HIGH POLLUTION AND SUSCEPTIBILITY.

SPOT ELEVATION LEGEND

DBL DOUBLE вот воттом

CB CATCH BASIN

CO CLEAN OUT

DBL DOUBLE

CURB INLET

DITCH INLET

ELEVATION

END SECTION

FINISH GRADE

FIRE HYDRANT

CPP CORRUGATED PLASTIC PIPE

DUCTILE IRON PIPE

FLARED END SECTION

DESCRIPTION	PROPOSED	EXISTING
FINISHED GRADE	FG 16.90 ≯	FG 16.90
TOP OF PAVEMENT	TP 16.90 ×	TP 16.90
TOP OF CURB	TC 16.90 ×	TC 16.90
TOP OF WALK	™ 16.90 ×	TW 16.90
TOP OF WALL	WT 16.90 →	WT 16.90
BOTTOM OF WALL	WB 16.90 ×	WB 16.90

GENERAL PROJECT/SITE INFORMATION

COUNTY: BEAUFORT COUNTY

MUNICIPALITY: TOWN OF BLUFFTON

ZONING: PUD

PROPERTY OWNER

COMPANY/DEPT.: N/F FIRST CHATHAM BANK ADDRESS: 111 BARNARD STREET, SAVANNAH, GA 31401 TELEPHONE: (912) 629-2936

<u>DEVELOPER</u> NAME/TITLE: TAYLOR WOLFE COMPANY/DEPT.: ONPOINT PARTNERS, LLC ADDRESS: 1315 WHITTAKER DRIVE, COLUMBIA, SC 29206 TELEPHONE: (803) 261-8776

NAME/TITLE: GRIFFIN SAVEDGE, P.E. COMPANY/DEPT.: THOMAS & HUTTON ADDRESS: 50 PARK OF COMMERCE WAY, SAVANNAH, GA 31405 TELEPHONE: (912) 234-5300

ARCHITECT COMPANY/DEPT.: WILKUS ARCHITECTS ADDRESS: 15 NINTH AVE N, HOPKINS, MN 55343 TELEPHONE: (952) 941-8660

GEOTECHNICAL ENGINEER NAME/TITLE: TBD COMPANY/DEPT.: TBD ADDRESS: TBD TELEPHONE: TBD

TOPOGRAPHIC AND BOUNDARY SURVEYOR COMPANY/DEPT.: THOMAS & HUTTON ADDRESS: 50 PARK OF COMMERCE WAY, SAVANNAH, GA 31405

BUILDING DEPARTMENT NAME/TITLE: ROB CURRALL

TELEPHONE: (912) 234-5300

COMPANY/DEPT.: TOWN OF BLUFFTON/BUILDING OFFICIAL ADDRESS: 20 BRIDGE STREET, BLUFFTON, SC 29910 TELEPHONE: (843) 706-7810

NAME/TITLE: DAN WILTSE COMPANY/DEPT.: BLUFFTON FIRE DISTRICT ADDRESS: 357 FORDING ISLAND ROAD, BLUFFTON, SC 29910 TELEPHONE: (843) 757-2800

SANITARY & WATER SERVICE: NAME/TITLE: MATTHEW MICHAELS

COMPANY/DEPT.: BEUFORT JASPER WATER & SEWER AUTHORITY ADDRESS: 6 SNAKE ROAD, OKATIE, SC 29909 TELEPHONE: (843) 987-9250

COMMUNICATION SERVICE: NAME/TITLE: TRACY TRIMMER

COMPANY/DEPT.: SPARKLIGHT ADDRESS: 925 FORDING ISLAND RD, BLUFFTON, SC 29928 TELEPHONE: (912) 291-8341

ELECTRIC & NATURAL GAS SERVICE: COMPANY/DEPT.: DOMINION ENERGY ADDRESS: 81 MAY RIVER ROAD, BLUFFTON, SC 29910 TELEPHONE: (843) 816-2907

STORMWATER MANAGEMENT (TOWN): NAME/TITLE: ANDREA MORENO COMPANY/DEPT.: TOWN OF BLUFFTON

ADDRESS: 1261 MAY RIVER ROAD, BLUFFTON, SC 29910

TELEPHONE: (843) 706-4500

STORMWATER MANAGEMENT (STATE):

COMPANY/DEPT.: PAMELA WINKLER

COMPANY/DEPT.: SCDHEC-OCRM ADDRESS: 13662 MCMILLIAN AVE. SUITE 400, CHARLESTON, SC 29405 TELEPHONE: (843) 953-5324


L1 LANDSCAPE - PLAN/DETAILS

M MECHANICAL/HVAC


A ARCHITECTURAL P | PLUMBING

V SURVEY/MAPPING

E | ELECTRICAL

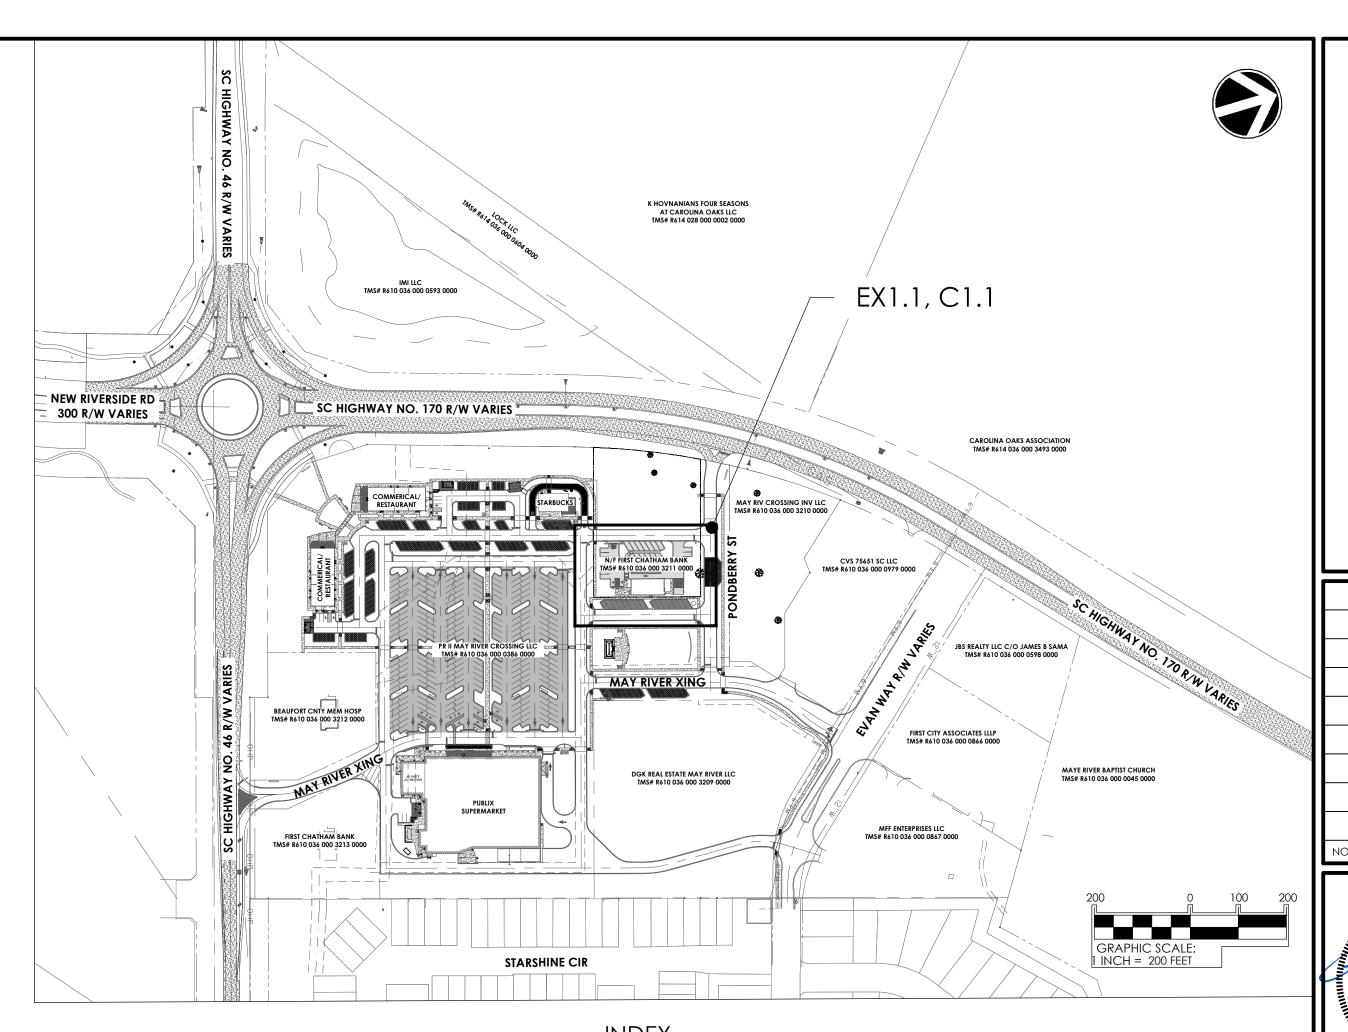

INDEX SCALE: 1" = 200'

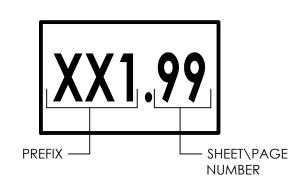

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- C3 PAVING & DRAINAGE
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SHEET NUMBERING DETAIL SCALE: NOT TO SCALE

<u>ABBREVIATIONS</u>							
	FM	FORCE MAIN (SANITARY SEWER)		ос	ON CENTER	SS	SANITARY SEWER
	FP	FINISH PAD		PC	POINT OF CURVE	TC	TOP OF CURB
	FPW	FIRE PROTECTION		PH	POST HYDRANT	TH	THROAT ELEVATION
	FR	FRAME		PT	POINT OF TANGENT	TG	TOP OF GUTTER
	Gl	GRATE INLET		PVC	POLYVINYL CHLORIDE	TP	TOP OF PAVEMENT
	GV	GATE VALVE		RCP	REINFORCED CONCRETE PIPE	TW	TOP OF WALK
	HDPE	HIGH DENSITY POLYETHYLENE		RC	ROLL CURB INLET	TYP	TYPICAL
	HI	HOODED INLET		RCP	REINFORCED CONCRETE PIPE	VI	VALLEY INLET
	INV	INVERT ELEVATION		RI	ROOF INLET	W	WATER
	JB	JUNCTION BOX		RJP	RESTRAINED JOINT PIPE	W/	WITH
	LF	LINEAR FEET		R/W	RIGHT-OF-WAY	WV	WATER VALVE
	MAX	MAXIMUM		SD	STORM DRAINAGE	ΥI	YARD INLET
	MIN	MINIMUM		SDMH	STORM DRAINAGE MANHOLE		
	МН	MANHOLE		SF	SQUARE FEET		

DRAINAGE LEGEND					
DESCRIPTION	<u>EXISTING</u>	<u>PROPOSED</u>			
PIPE	- · - · - · -				
DITCH		 ···-			
CURB INLET	0				
GRATE INLET					
JUNCTION BOX	0				
OUTLET STRUCTURE					

DESCRIPTION	<u>EXISTING</u>	<u>PROPOSED</u>
WATER MAIN	10"W	—— 10"W——
SINGLE SERVICE LATERAL		
DOUBLE SERVICE LATERAL	<u></u>	>
VALVE AND BOX	\otimes	•
FIRE HYDRANT W/VALVE & BOX	\otimes - φ -	ۥ
POST HYDRANT	Ţ	— 1
REDUCER		•
BACKFLOW PREVENTOR		
CROSS	_	1_1
TEE		1-1
90° BEND - HORIZONTAL		_
45° BEND - HORIZONTAL	/	/
22-½° BEND - HORIZONTAL	/	/
11-¼° BEND - HORIZONTAL	<i>f</i>	1
BEND - VERTICAL	П	11
CAP		

WATER LEGEND

OTHER UTILITIES LEGEND			
DESCRIPTION	<u>EXISTING</u>		
NATURAL GAS	UGG		
TELEPHONE	—— ОНТ ——		
UNDERGROUND TELEPHONE	—— UTL ——		
ELECTRICITY	—— ОНР ——		
UNDERGROUND ELECTRICITY	—— UGP ——		

DRAINAGE LEGEND					
DESCRIPTION	EXISTING	PROPOSED			
PIPE	- · - · - · -				
DITCH		 · · ·			
CURB INLET (CI) CATCH BASIN (CB)	0				
CURB INLET - RIGHT (CI) OR CATCH BASIN - RIGHT (CB)	OR O	OR OR			
CURB INLET - LEFT (CI) OR CATCH BASIN - LEFT (CB)	OR O	OR OR			
CURB INLET - BOTH (CI) OR CATCH BASIN - LEFT (CB)	OR O	OR •			
CONTROL STRUCTURE (CS)					
DITCH INLET (DI)	■ E				
GRATE INLET (GI)	⊞	⊞			
HOODED INLET (HI)	OR	OR III			
JUNCTION BOX (JB)		•			
MANHOLE (SDMH)	0	•			
ROLL CURB INLET (RC)					
ROOF INLET (RI)					
YARD INLET (YI)	®	®			
FLARED END SECTION (FES)	D				

DRAINAGE LEGEND						
DESCRIPTION	<u>existing</u>	PROPOSED				
PIPE	- · - · - · - · -					
DITCH		→ · · · · —				
CURB INLET (CI) CATCH BASIN (CB)						
CURB INLET - RIGHT (CI) OR CATCH BASIN - RIGHT (CB)	OR OR	OR OR				
CURB INLET - LEFT (CI) OR CATCH BASIN - LEFT (CB)	OR OR	OR OR				
CURB INLET - BOTH (CI) OR CATCH BASIN - LEFT (CB)	OR O	OR •				
CONTROL STRUCTURE (CS)						
DITCH INLET (DI)						
GRATE INLET (GI)	Ħ					
HOODED INLET (HI)	OR	OR				
JUNCTION BOX (JB)						
MANHOLE (SDMH)	0	•				
ROLL CURB INLET (RC)						
ROOF INLET (RI)						
YARD INLET (YI)	®	8				
flared end section (fes)						


DRAINAGE LEGEND						
ESCRIPTION	<u>existing</u>	PROPOSED				
E						
СН		 · · ·				
RB INLET (CI) TCH BASIN (CB)						
RB INLET - RIGHT (CI) OR TCH BASIN - RIGHT (CB)	OR OR	OR OR				
RB INLET - LEFT (CI) OR TCH BASIN - LEFT (CB)	OR OR	OR •				
RB INLET - BOTH (CI) OR TCH BASIN - LEFT (CB)	OR O	OR •				
ONTROL STRUCTURE (CS)						
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ATE INLET (GI)	Ħ	III				
ODED INLET (HI)	OR	OR (
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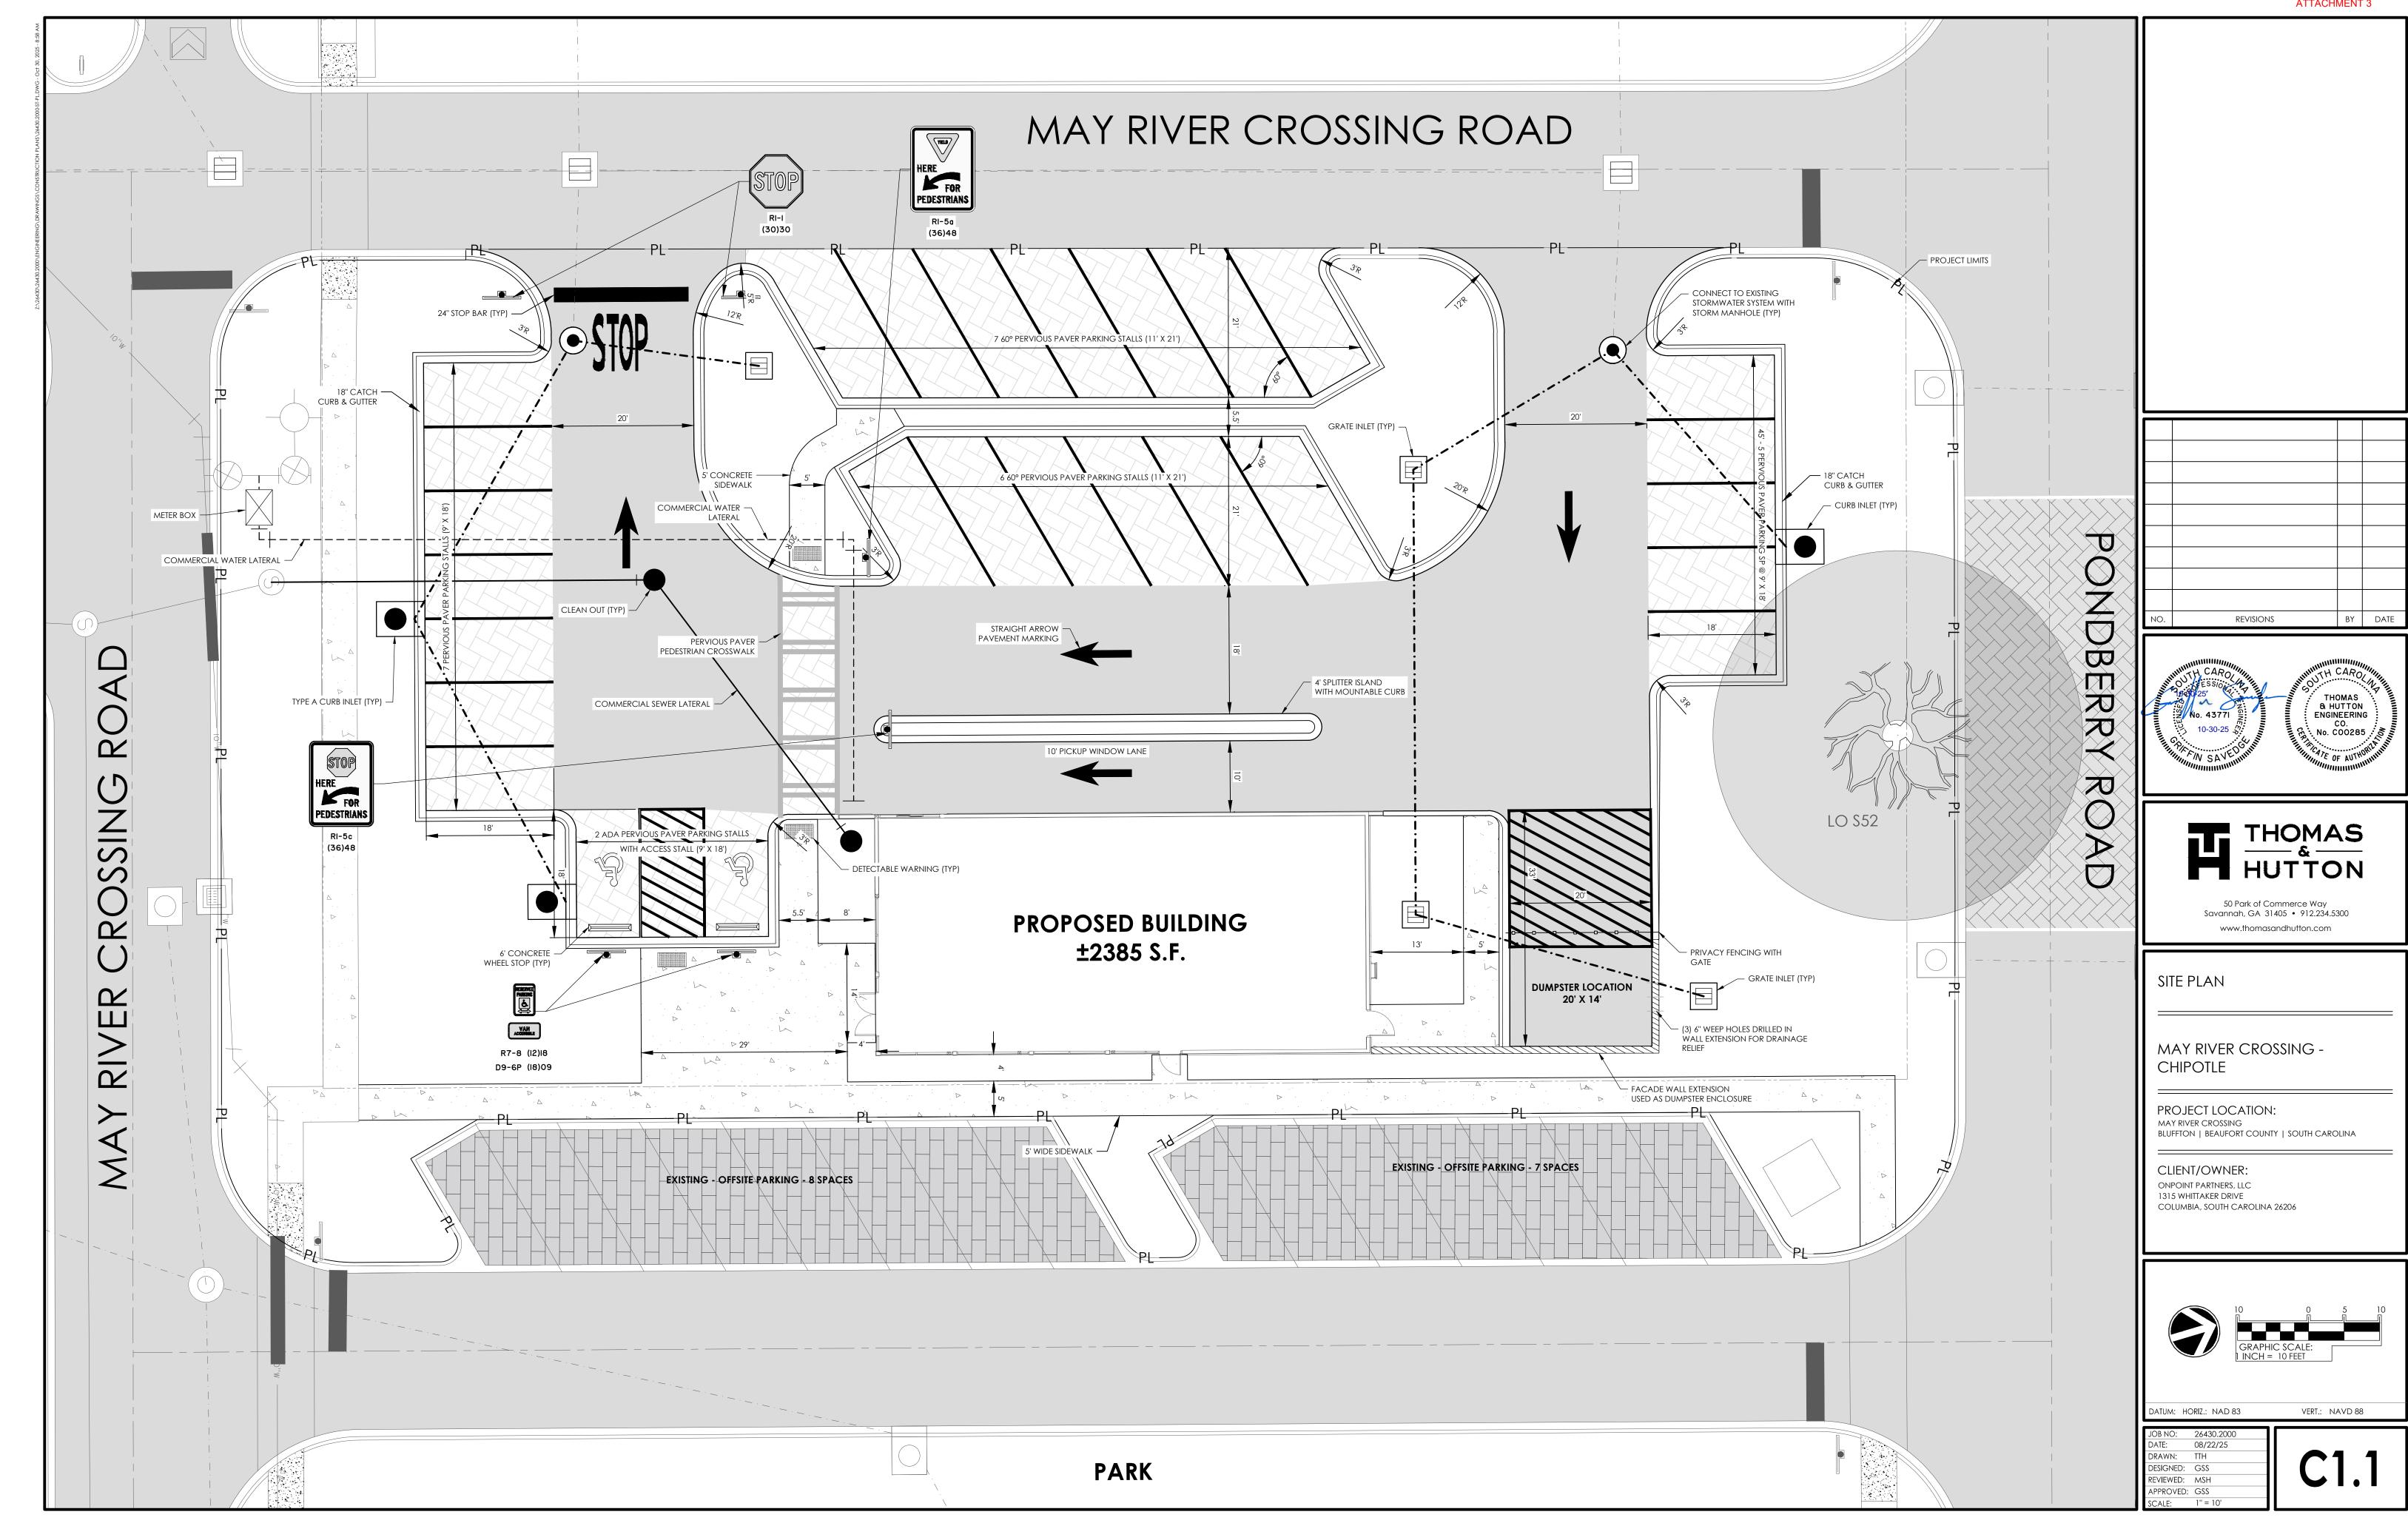
So Park of Commerce Way Savannah, GA 31405 • 912.234.5300 www.thomasandhutton.com GENERAL NOTES & INDEX MAY RIVER CROSSING - CHIPOTLE PROJECT LOCATION: MAY RIVER CROSSING BLUFFTON BEAUFORT COUNTY SOUTH CAROLINA CLIENT/OWNER: ONPOINT PARTNERS, LLC 1315 WHITTAKER DRIVE COLUMBIA, SOUTH CAROLINA 26206
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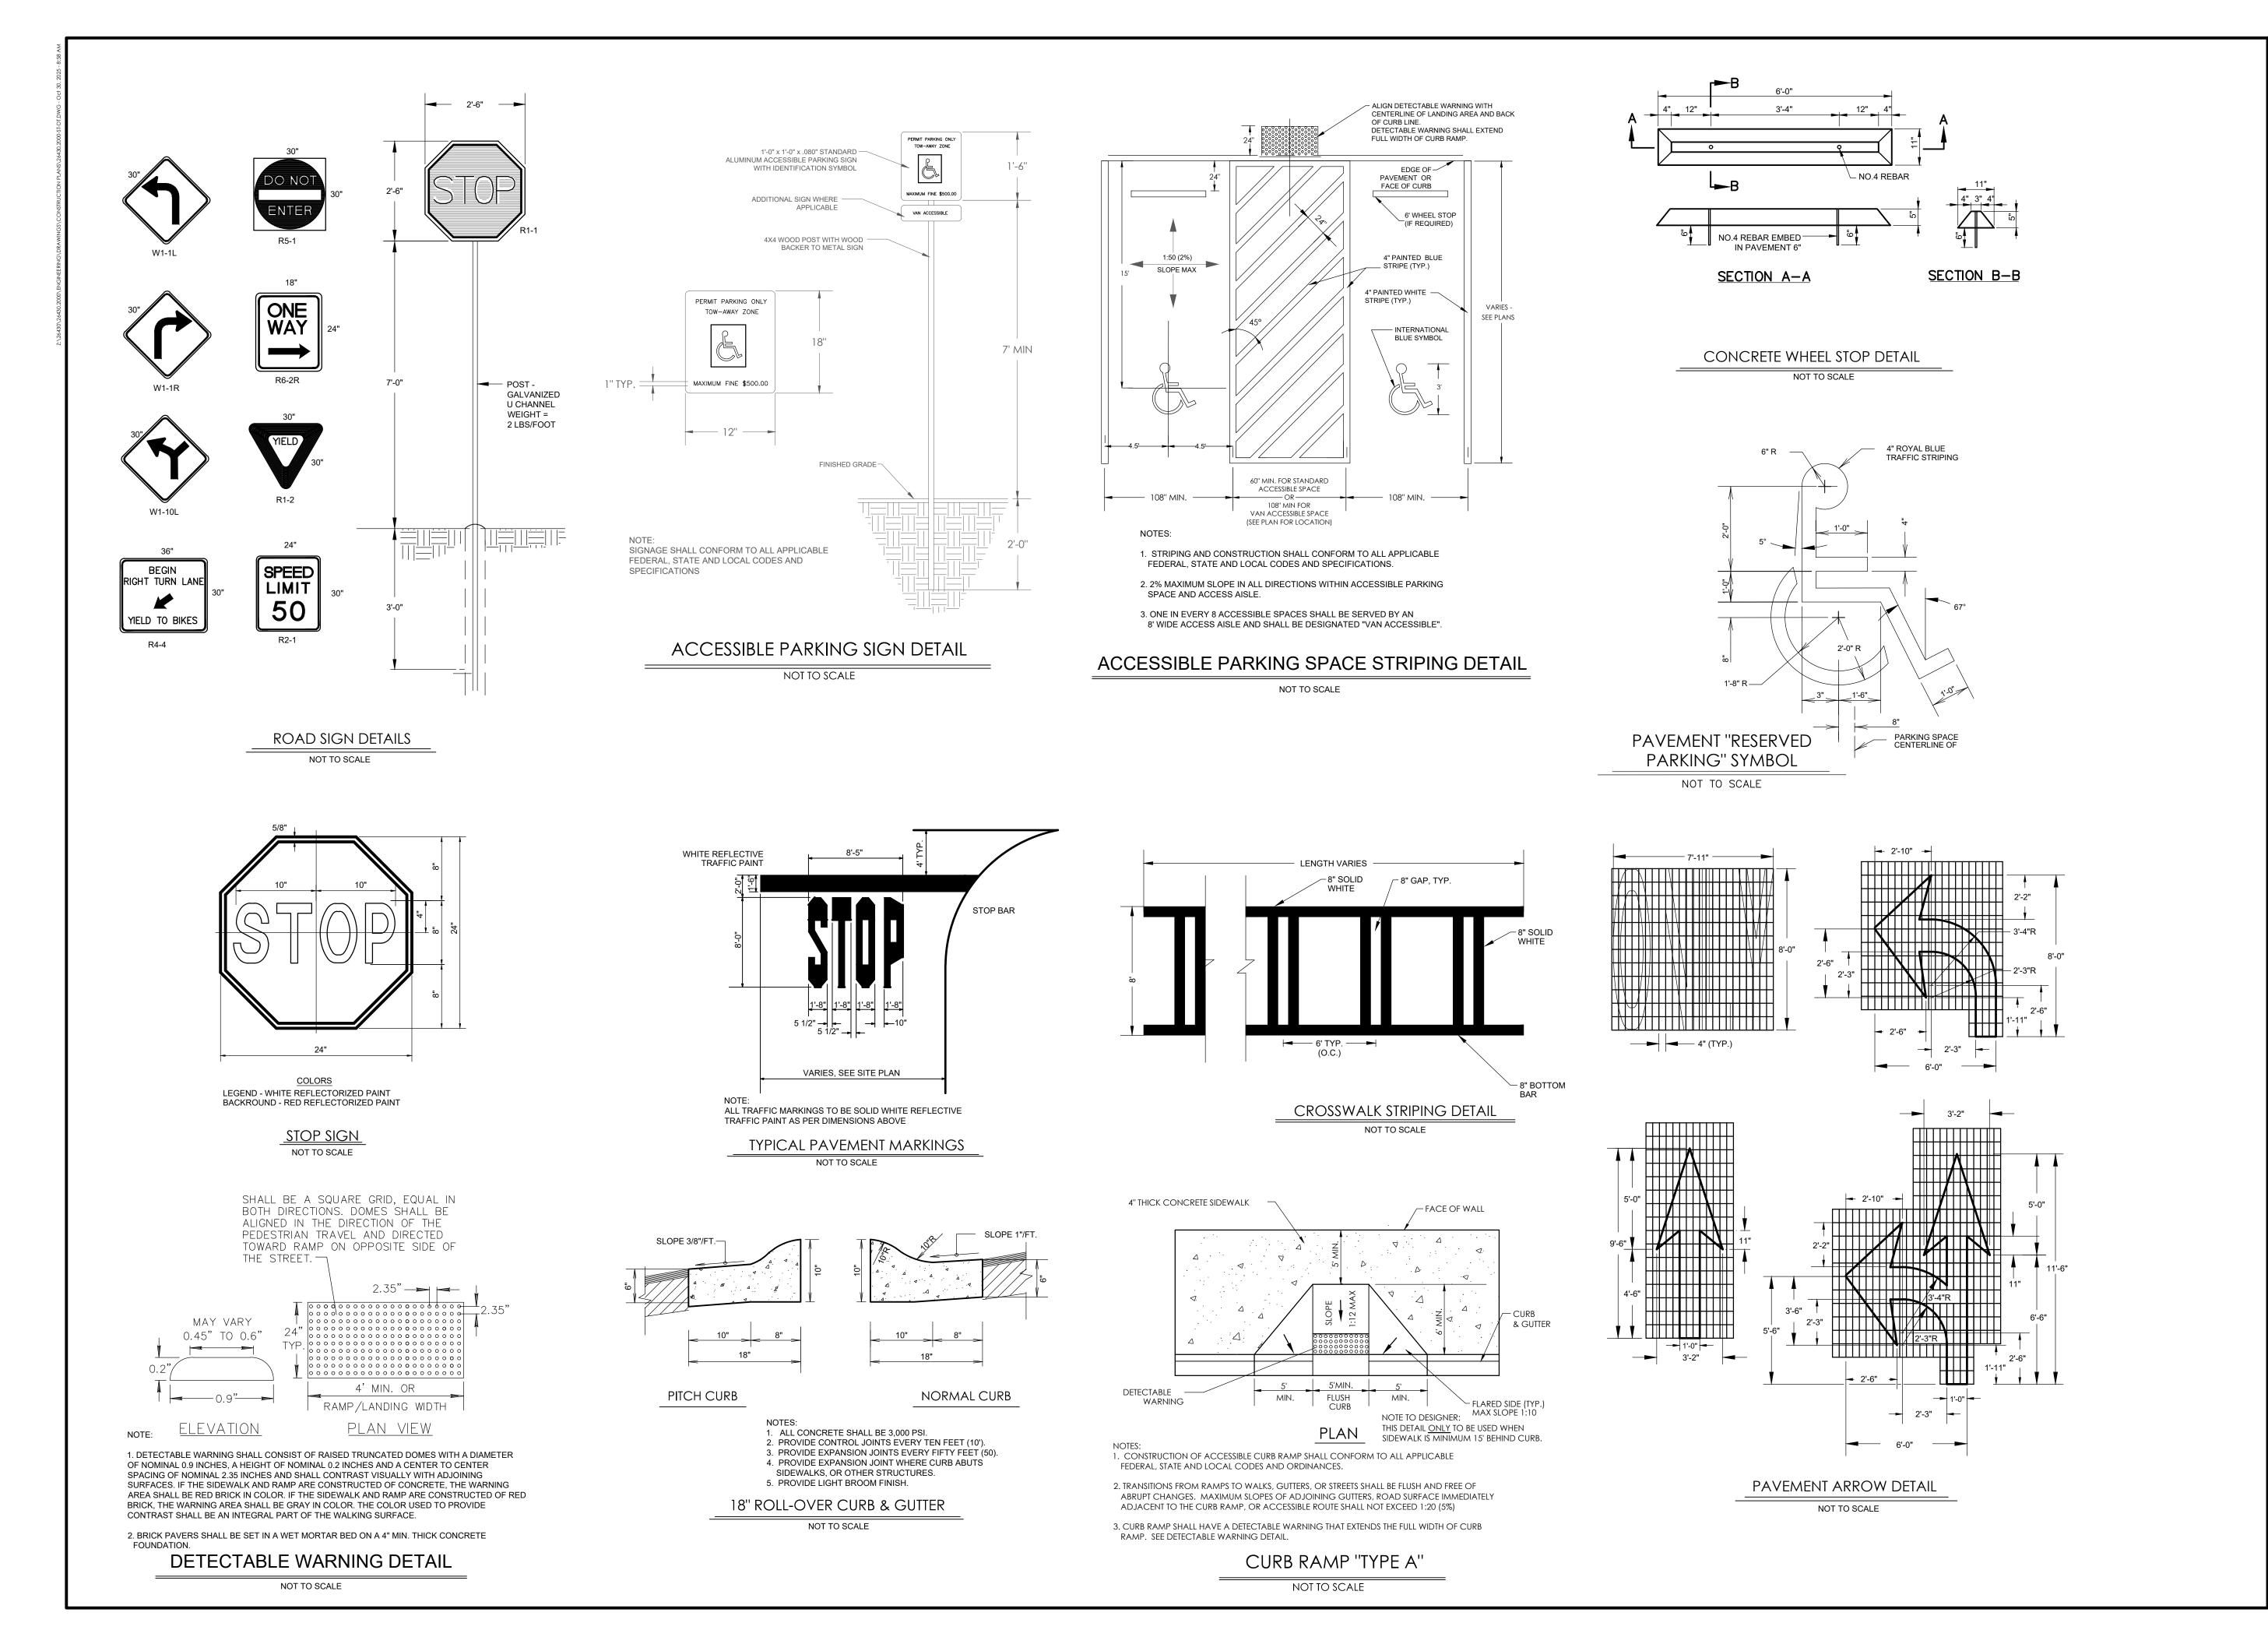
DATUM: HORIZ.: NAD 83 VERT.: NAVD 88 08/22/25 DRAWN: TTH

DESIGNED: GSS REVIEWED: MSH


APPROVED: GSS





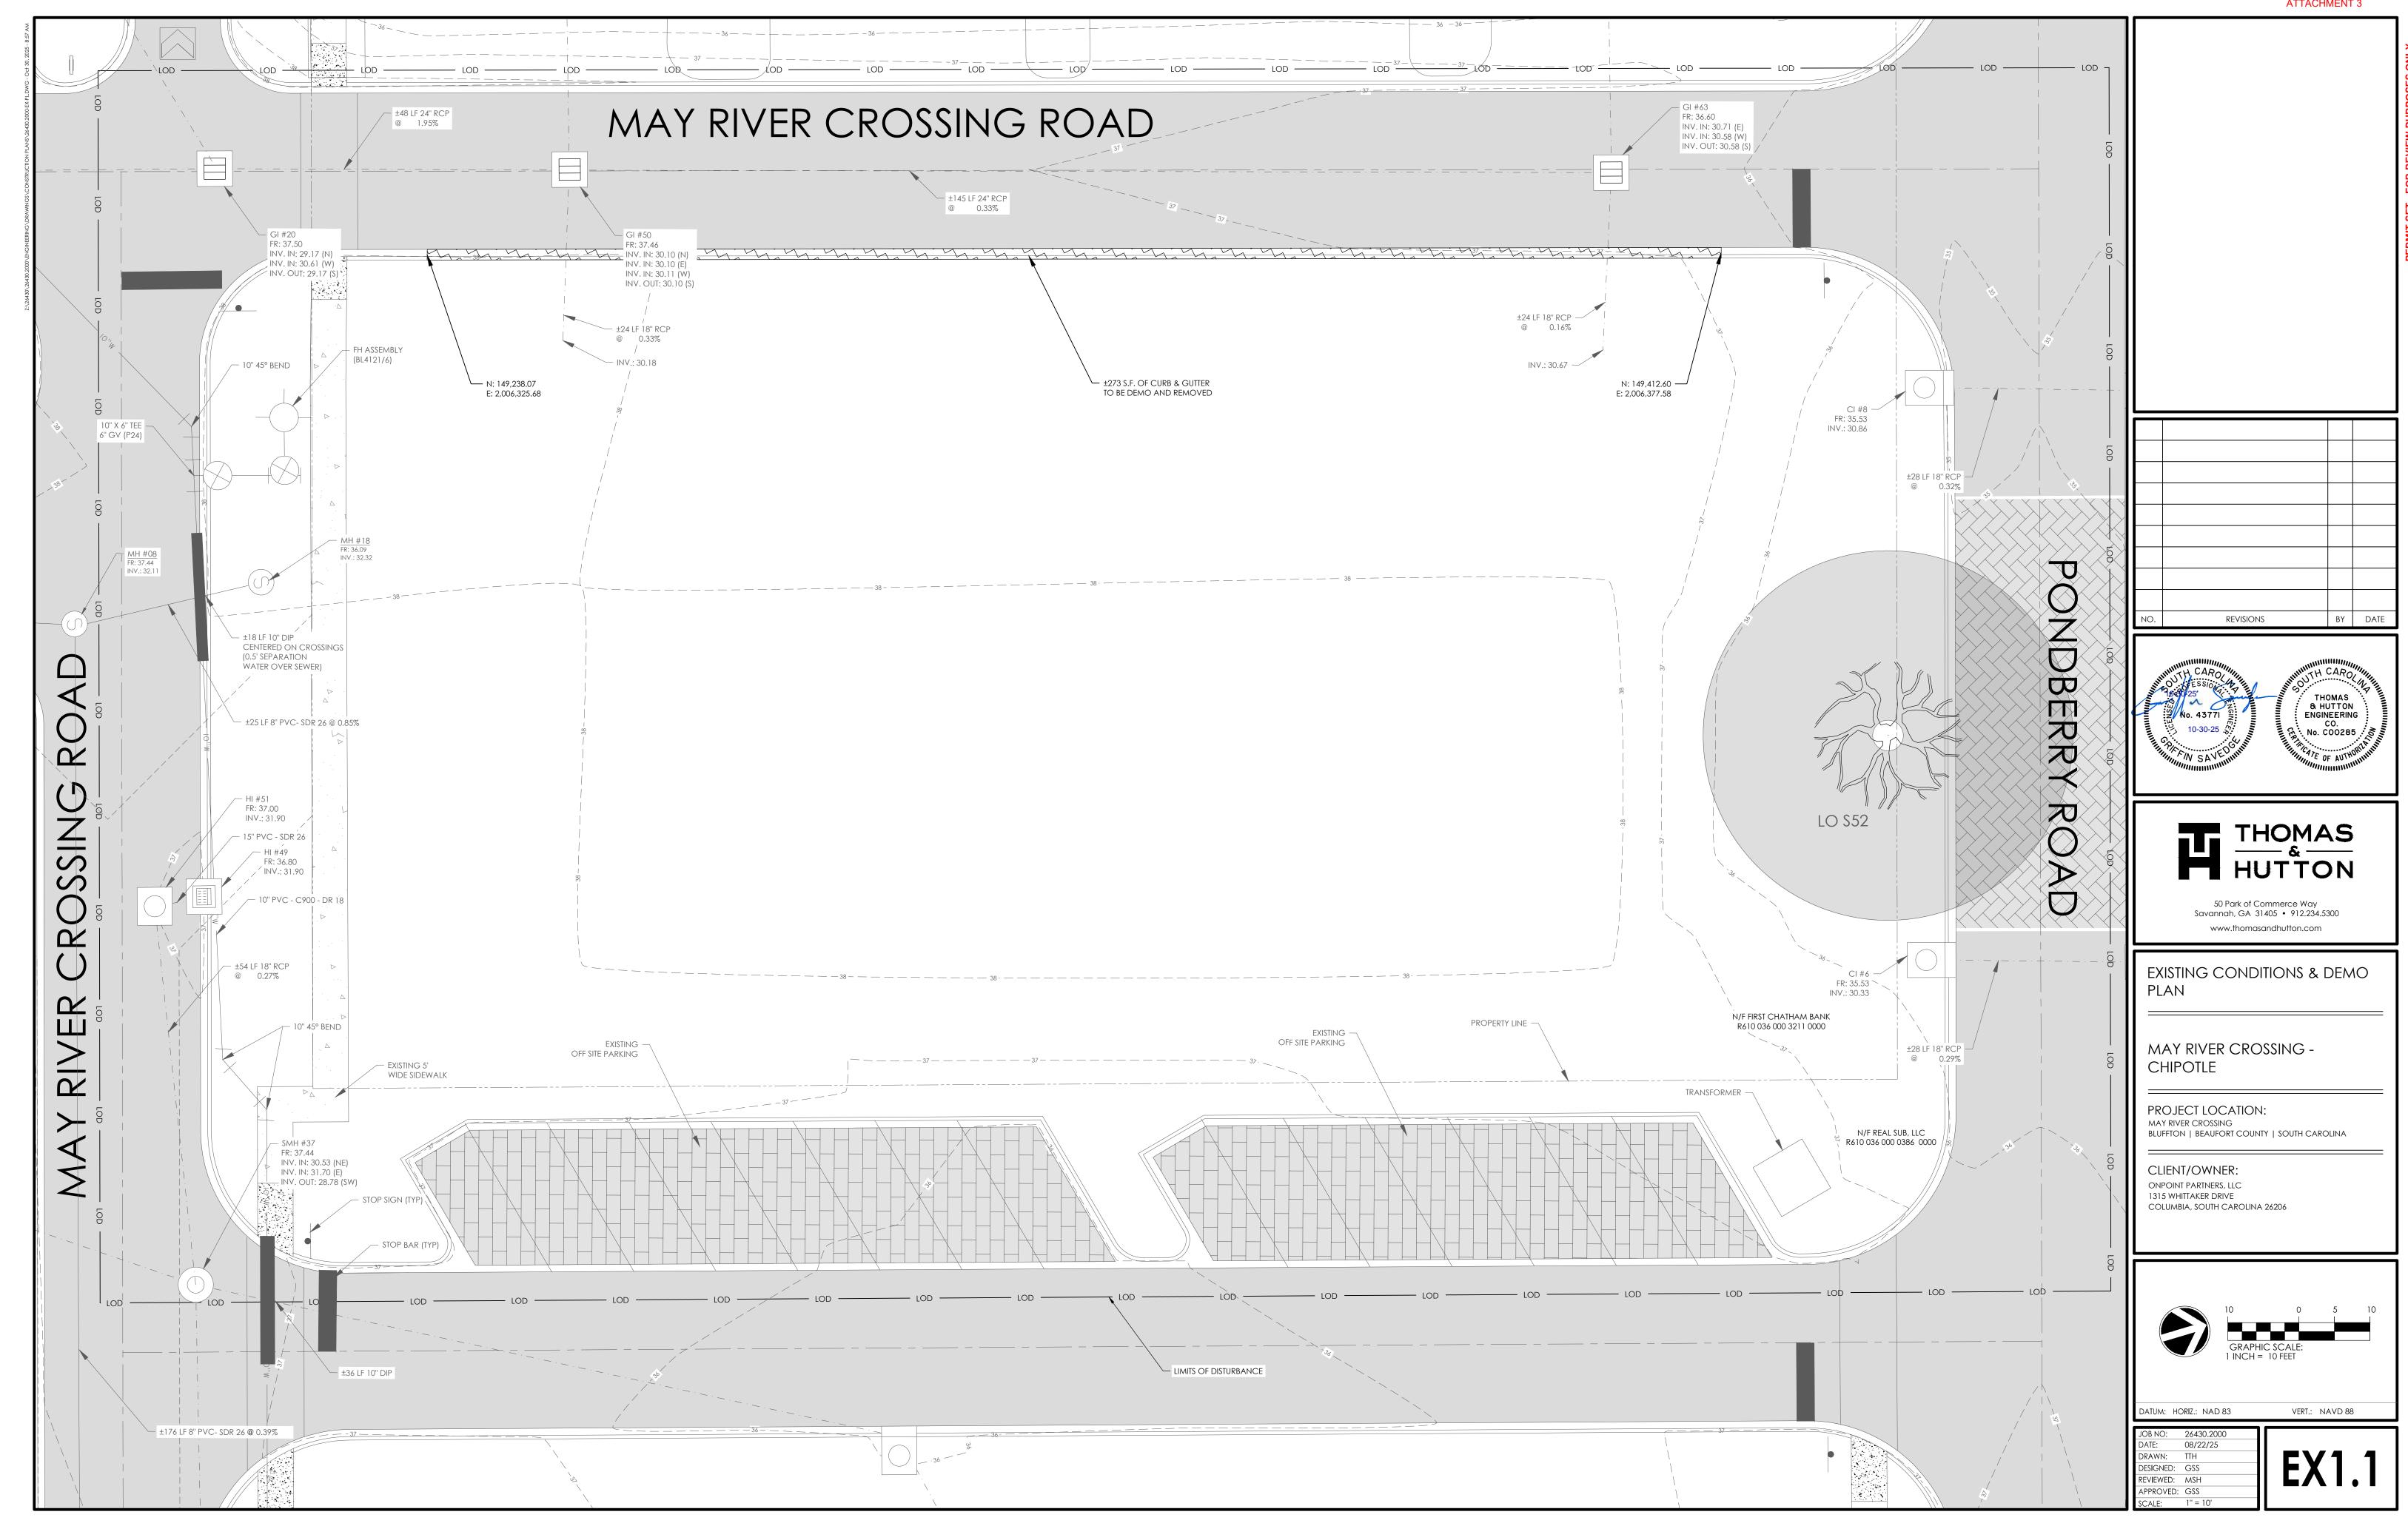

NO. REVISIONS BY DATE

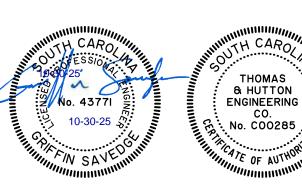



50 Park of Commerce Way Savannah, GA 31405 • 912.234.5300 www.thomasandhutton.com

SITE DETAILS

MAY RIVER CROSSING -CHIPOTLE

PROJECT LOCATION:

MAY RIVER CROSSING BLUFFTON | BEAUFORT COUNTY | SOUTH CAROLINA

CLIENT/OWNER:

Onpoint partners, LLC 1315 Whittaker Drive Columbia, South Carolina 26206



DATUM: HORIZ.: NAD 83 VERT.: NAVD 88

JOB NO: 26430.2000

DATE: 08/22/25

DRAWN: TTH

DESIGNED: GSS

REVIEWED: MSH

APPROVED: GSS

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