

# MAY RIVER N

#### **PROJECT INFORMATION**

ADDRESS:

PROPOSED USE:

NAME OF PROJECT:

OWNER CONTACT:

CODE ENFORCEMENT JURISDICTION:

INTERNATIONAL BUILDING CODE (IBC): INTERNATIONAL MECHANICAL CODE: INTERNATIONAL PLUMBING CODE: THE NATIONAL ELECTRICAL CODE: INTERNATIONAL FUEL GAS CODE: INTERNATIONAL FIRE CODE: INTERNATIONAL ENERGY CONSERV. CODE: 2009 ICC/ANSI A117.1: INTERNATIONAL RESIDENTIAL CODE

**PROJECT TEAM** 

OWNER CONTACT MICHELE QUIGLEY, DIRECTOR 60 CLAHOUN STREET BLUFFTON, SC, 29910 (843) 757-2312 PH

STRUCTURAL ENGINEER CRANSTON ENGINEERING GROUP 14 WESTBURY PARK WAY, SUITE 202

BLUFFTON, SC, 29910 (843) 815-3191 PH

MECHANICAL, PLUMBING & FIRE PROTECTION

DELTA ENGINEERING GROUP, LLC. 204-A PITCARIN WAY AUGUSTA, GA, 30909 (706) 364-1770 PH

ELECTRICAL ENGINEER

SDC ENGINEERING 1 DIAMOND CAUSEWAY, STE. 7 SAVANNAH, GA, 31406 (912) 677-7716 PH

#### **DESIGNER OF RECORD**

**DISCIPLINE** ARCHITECTURAL STRUCTURAL ELECTRICAL Plumbing MECHANICAL CIVIL

JAKE EAVENSON WARREN LAW CAPRICE BAUMERT CAPRICE BAUMERT CONOR BLANEY LANDSCAPE DAN KEEFER



NAME

JAMES C. ATKINS

MAY RIVER MONTESSORI NEW CLASSROOM BUILDING 60 CALHOUN STREET BLUFFTON, SC 29910 EDUCATIONAL (E)

MICHELE QUIGLEY TOWN OF BLUFFTON 2018 2018 2018

2017

2018

2018

2017 2018 ARCHITECT

COURT ATKINS ARCHITECTS, INC. 32 BRUIN ROAD P.O. BOX 3978 BLUFFTON, SC 29910 (843) 815-2557 PH (843) 815-2547 FAX

GENERAL CONTRACTOR JTVS BUILDERS, INC. 7 EAST CONGRESS STREET #309 Savannah, Ga 31401 (912) 233-1717 PH

LANDSCAPE ARCHITECT WITMER-JONES-KEEFER, LTD. 23 PROMENADE STREET, SUITE 201

BLUFFTON, SC 29910 (843) 757-7411 PH

**CIVIL ENGINEER** 

CONOR BLANEY WARD EDWARDS 119 PALMETTO WAY, SUITE C BLUFFTON, SC 29910 (843) 837-5250


LICENSE NO. TELEPHONE NO. SC #6743 (843) 815-2557 SC #33500 (843) 815-3191 SC #20698 (912) 677-7716

SC #30527 (706) 364-1770

SC #30527 (706) 364-1170

SC #36273 (843) 837-5250

SC #837 (843) 757-7411

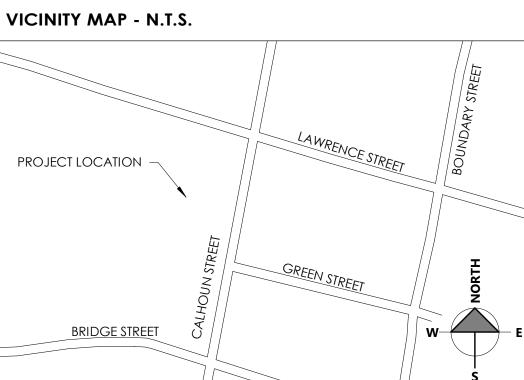

#### GENERAL NOTES

NOTE TO GENERAL CONTRACTORS: THESE DRAWINGS HAV UNDER A LIMITED SERVICES AGREEMENT BETWEEN THE OWN REPRESENTATION AND COURT ATKINS ARCHITECTS, INC. TH DESIGN INTENT AND IN COORDINATION WITH SUPPLEMENT DOCUMENTS.

THE ARCHITECT'S DRAWINGS CANNOT STAND ALONE AS C documents.

SEE STRUCTURAL ENGINEERING DOCUMENTS FOR STRUCTU TECHNIQUES, CALCULATIONS REQUIRED BY CODE, CODE INSTRUCTIONS FOR WALL AND ROOF CONSTRUCTION, AND REQUIREMENTS.

SEPARATE MECHANICAL, ELECTRICAL, AND PLUMBING ENG MAY BE PROVIDED, WHICH INDICATE REQUIRED SERVICE CALCULATIONS AND INSTALLATION SPECIFICATIONS BEYO BASIC LAYOUT AND SELECTIONS SUGGESTIONS.

SEPARATE CIVIL ENGINEERING DOCUMENTS MAY BE PROVI ADDITIONAL SITE PLANNING, DRAINAGE, AND OTHER RELA REQUIREMENTS.

SELECTIONS NOT INCLUDED IN THESE DOCUMENTS WILL BE C OWNER/ OWNER'S REPRESENTATIVES.

BY APPLYING FOR A BUILDING PERMIT AND/OR CONSTRUC REPRESENTED HEREIN, THE OWNER AGREES TO LIMIT THE L ARCHITECT TO THE OWNER OF THE PROJECT FOR ALL AND DAMAGES OR ANY NATURE WHATSOEVER, OR CLAIMS OF SUCH ITEMS TO THE ARCHITECTS TOTAL COMPENSATION FO HEREIN.

THESE DOCUMENTS ARE THE WORK INSTRUMENTS OF THE AR BEEN PREPARED SPECIFICALLY AND SOLELY FOR THE PROJE ARE NOT SUITABLE FOR USE ON OTHER PROJECTS OR IN OT THE PARTICIPATION OF THE ARCHITECT. REPRODUCTION IS ARCHITECT SHALL BE DEEMED THE AUTHOR AND OWNER C AND SHALL RETAIN COMMON LAW, STATUTORY AND OTHE INCLUDING THE COPYRIGHT.

FOR DIMENSIONS NOT SHOWN OR IN QUESTION, THE CON CLARIFICATION FROM THE ARCHITECT BEFORE PROCEEDIN

CONTRACTOR WILL VERIFY ALL EXISTING CONDITIONS IN T DISCREPANCIES WILL BE BROUGHT TO THE ATTENTION OF TH

THE CONTRACTOR SHALL MAINTAIN AT THE SITE OF THE WC DRAWINGS. THE CONTRACTOR SHALL RECORD ALL CHANC FROM THE DRAWINGS ON THIS "AS-BUILT" SET, WHICH SHAL EVERY OTHER WEEK. AT THE CLOSE OF THE JOB, THE CONTR ONE COMPLETE SET OF ALL AS-BUILT INFORMATION TO THE AND LEGIBLE FORMAT.

SIGNS SHALL BE LIMITED TO THE PROJECT IDENTIFICATION S SIGN SHALL IDENTIFY THE PROJECT, THE ARCHITECT AND TH

INFORMATION CONTAINED ON THESE DRAWINGS IS PROVI CONVENIENCE OF THE GENERAL CONTRACTOR IN EXECUT ATTEMPT HAS BEEN MADE TO PROVIDE COMPLETE AND ACC REPRESENTATIONS OF SUCH CONDITIONS.

WHEN ARCHITECTURAL DRAWINGS ARE IN CONFLICT WITH DRAWINGS THE GENERAL CONTRACTOR SHALL REQUEST C ARCHITECT BEFORE PROCEEDING.

## ATTACHMENT 4


	58 CALH	ioun s	TREET, BLI	JFFTO	N S(	C 29	<b>?</b> 91	0
	BUILDING DATA			FIRE SEPARATIO	ON			
'E BEEN PRODUCED	PROJECT DESCRIPTION:			IBC TABLE 601, 602, 5	508.3.3		REQ'D HR	
NER/OWNER'S IEY ARE TO BE USED FOR I ENGINEERING	CONSTRUCTION OF A 2 STOR BUILDING CONSTRUCTION:	RY EDUCATIONAL BUILDING		PRIMARY STRUCTUR	AL FRAME		0	
ONSTRUCTION		s, wood roof trusses & Educational (e)	CONCRETE SLAB ON GRADE.	BEARING WALLS: EXTERIOR			0	
IRAL CONNECTION COMPLIANCE		NO <u>X</u>	SEPARATION <u>0</u> HR.	INTERIOR NON-BEARING WALL EXTERIOR	LS:		0	
D TIE DOWN	III-A	I-B II-A II-B III-B IV V-A		INTERIOR FIRE SEPARATION W	ALLS:		0	
GINEERING DOCUMENTS AND RISER DIAGRAMS, ND THE ARCHITECTS		NO <u>X</u>	ТҮРЕ				0	
(IDED, WHICH INDICATE NTED SITE WORK			STORIES: 2	FLOOR CONSTRUCTI			0	
		NO <u>X</u>		ALL INTERIOR	WALLS AI		G FINISH	IES
COORDINATED BY THE	HIGH RISE: YES _	NO <u>X</u>		IBC TABLE 803.13		SPRI	NKLERED	
CTING THE PROJECT LIABILITY OF THE ANY CLAIMS, LOSSES, EXPENSES FOR ANY DR SERVICES RENDERED	ALLOWABLE HEIGHT & AR			GROUP	VERT. EXI EXIT PASS WAYS	SAGE- COR	ACCESS RIDORS / ER EXITS	RC EN SP
RCHITECT AND HAVE	CATAGORY HEIGHT (RES.): STORIES(RES.): AREA TOTAL:	<u>ALLOWABLE</u> 60'-0'' 2 ST. 28,500 SF	<u>ACTUAL</u> 32'-2" 2 ST. 5,317 SF	EDUCATIONAL (E)	В		С	
ECT NAMED HEREIN. THEY HER LOCATIONS WITHOUT STRICTLY PROHIBITED. THE DF THESE DOCUMENTS	AREA INCREASE? HEIGHT INCREASE?	Yes Yes	No <u>X</u> No <u>X</u>	MINIMUM REG	QUIRED PL		FIXTURES	5: P
er reserved rights,	GROSS BUILDING AREA			F	REQUIRED FIX	(TURE RATIO	RE	QUI
TRACTOR WILL REQUEST NG.			0.400.05	ITEM	MEN	WOMEN	MEN	
'HE FIELD- ANY HE ARCHITECT. DRK, A SET OF RECORD	LEVEL 01: HEATED & CO LEVEL 02: HEATED & CO ————————————————————————————————————		2,498 SF 2,819 SF 5,317 SF (H/C)	TOTAL WATER CLOSETS	1 PE	ER 50	2	
GES AND DEVIATIONS L BE UPDATED AT LEAST RACTOR SHALL PROVIDE E ARCHITECT IN CLEAR				TOTAL				
SIGN. THE IDENTIFICATION TE CONTRACTOR.				LAVATORIES	1 PE	ER 50	2	
IDED FOR THE TING THE WORK. EVERY CCURATE				DRINKING FOUNTAINS	1 PE	R 100		
I ENGINEERING CLARIFICATION FROM THE				service sink	1 REG	UIRED		
	EXITS (IBC TABLE 1006.3.2	)						
	NUMBER OF EXITS:	REQUIRED 2	PROVIDED 2	PLUMBING CA				
	TRAVEL DISTANCE							
	EXIT ACCESS DESIGN REQUIREMENTS			TOTAL OCCUPANCY	r = 181 PERS(	ON2		
	CATAGORY	MAX. ALLOWABLE	ACTUAL MAX	OCCUPANCY, 50% I 90 MALE OCCUPAN			rs	
	EXIT ACCESS TRAVEL DISTANCE (IBC TABLE 1017.2) :	250 FT	58FT 7IN					
	COMMON PATH OF TRAVEL	25011		SYMBOL KEY				

**DEAD END CORRIDOR** 

(IBC TABLE 1020.4)

50 FT

N/A

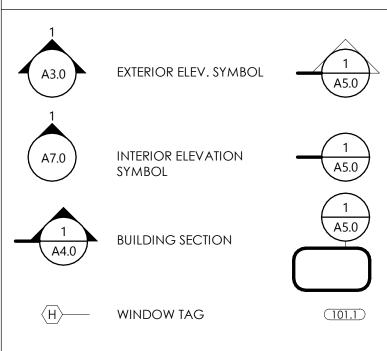


# SROOM BUILDING

DETAIL #	% WALL OPENING	UL RATED ASSEMBLY
		N/A

	UNSPRINKLERED				
ROOMS & ENCLOSED	VERT. EXITS / EXIT PASSAGE-	EXIT ACCESS CORRIDORS /	ROOMS & ENCLOSED		
SPACES	WAYS	OTHER EXITS	SPACES		

			OF A CEE		
С	А	В	С		
PER IBC TABLE 2902.1					

UIRED FIXTURES		FIXTURES PROVIDED				
	WOMEN	MEN	WOMEN	UNISEX		
	2	2	2	1		
	2	2	2	1		
	2		2			
	1		1			

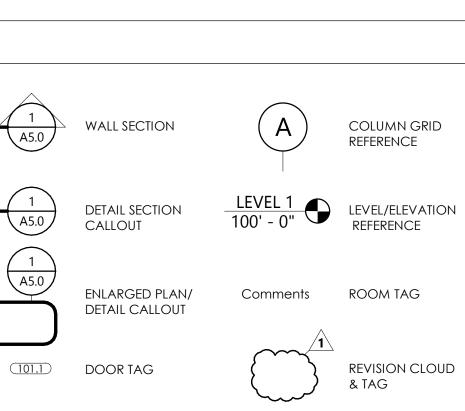

### INDEX OF DRAWINGS

FINAL	SHEET NAME	FINAL HPC 1/4	ISSUE 2	ISSUE 3	ISSUE 4 ISSUE 5
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A2.2	SECOND FLOOR PLAN				
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A7.2	SECOND FLOOR REFLECTED CEILING PLAN				
SURVEY					





COVER

**A0.0** 

## HEIGHTS

N 4.			
M			
M Hi Tŀ PI	JOINT KILN DRIED AFTER TREATMENT KNEE SPACE LAMINATE LIVE LOAD LIGHT LINEN MASONITE MASONRY MAXIMUM MECHANICAL MEDIUM MANUFACTURER MIDDLE MINIMUM MISCELLANEOUS MULLION NOT APPLICABLE NOT IN CONTRACT NOT TO SCALE ON CENTER OVERHANG	JNT KDAT KS LAM LL LT LIN MA MAS MAX MECH MED MFR MID MIN MISC MUL N/A N.I.C. NTS OC OH	
А	OPENING ORIENTED STRAND BOARD PRE-ENGINEERED METAL BLDG	OPNG OSB PEMB	
	PLATE PANEL	PL PNL	
	PAINT PAIR	PNT PR	
	PRESSURE TREATED POLYVINLYCHLORIDE	PT PVC	
	PAVEMENT	PVMT	
	PLYWOOD POWDER ROOM	PLY PWDR	
	RISER ROD & SHELF	R R & S	
	RETURN AIR GRILL REFRIGERATOR	RAG REF	
	REQUIRED	REQ'D RM	
	ROUGH OPENING	R.O.	
	RIDGE VENT SCHEDULE	RV SCHED	
	SECTION SQUARE FEET	SECT SF	
	SHELF	SH	
Φ	SIMILAR SPECIFICATION	SIM SPEC	
Ψ	SQUARE FEET STANDARD	SQ STD	
	STEEL	STL	
Δ.	STORAGE SYSTEM	STOR SYS	
A	TREAD TO BE DETERMINED	T T.B.D.	
Ν	TREAD	TR	
TI P	TONGUE & GROOVE TELEPHONE	t & G Tel	
	TEMPORARY/TEMPERATURE THICK	TEMP THK	
	TOP OF	T.O.	
	TELEVISION TYPICAL	TV TYP	
	UNDERCOUNTER UNFINISHED	UC UNFIN	
	UNLESS NOTED OTHERWISE	UNFIN U.N.O.	
	UNLESS OTHERWISE NOTED VAPOR BARRIER	U.N.N. VB	
	VERIFY	VER	
		\/   E	

VERIFY IN FIELD

WASHER-DRYER

WATER HEATER

WELDED WIRE FABRIC

VERTICAL

V.I.F.

VERT

W/D

WWF

## REFERENCE SYMBOLS

ABBREVIATIONS

AB

ABV

AFF

ASF

A/C

AHU

ALUM

AMSL

A/V

BLKG BLDG

B.O. BOD BRG

BTW CAB CANT CB CEN CJ

CL CLG CO COL CONC

CT

DIA

DI*M* DIST

DN

DP

DR

DW DWG

ΕA

ELEV

ELEC

EQ

EQUIP EXST EXT

FD

FF

FDTN

FFE

FIN

FIX

FIXT

FLR

F.O.F. F.O.S.

FRZ

FT

FRMG

ftg

GA

GALV G.C.

GFI

GL

HB

ΗT

IN INCL

GYP

HDR

HORIZ

HVAC

INSUL

INT

IRC

JST

FLUOR

DBL DEMO DH

BD

ΒF

APPROX

ANCHOR BOLT

ABOVE FINISH FLOOR

ABOVE SUBFLOOR

AIR CONDITIONER

AIR HANDLING UNIT

ABOVE MEAN SEA LEVEL

ABOVE

ALUMINUM

board

**BI-FOLD** 

BLOCKING

BUILDING

Bearing

BETWEEN

CABINET

CENTER

CEILING

CONCRETE

Demolish

DIAMETER

DIMENSION

DISTANCE

DISHWASHER

DRAWING

ELEVATION

ELECTRICAL

EQUIPMENT

DOWN

DOOR

EACH

EQUAL

existing

EXTERIOR

FLOOR DRAIN

FOUNDATION

FINISH FLOOR ELEVATION

FIRST FLOOR

FLUORESCENT

FACE OF FINISH

FACE OF STUD

FINISH

FIXTURE

FIXTURE

FLOOR

FREEZER

FEET

Framing

FOOTING

GAUGE

GLASS

GYPSUM

HEADER

HEIGHT

INCH

JOIST

INCLUDE

INTERIOR

INSULATION

HOSE BIBB

HORIZONTAL

GALVANIZE

GENERAL CONTRACTOR

GROUND FAULT INTERRUPTER

INTERNATIONAL RESIDENTIAL CODE

HEATING, VENTILATION & AIR CONDTIONING WH

DOUBLE

CERAMIC TILE

DOUBLE HUNG

DESIGN PRESSURE

CANTILEVER

**CEILING JOIST** 

CASED OPENING COLUMN

CENTERLINE

BOTTOM OF

**BASIS OF DESIGN** 


FIBER CEMENT BOARD


APPROXIMATE

audio/visual

A3.0	EXTERIOR ELEVATION SYMBO		COLUMN GRID REFERENCE
A7.0	INTERIOR ELEVATION SYMBOL	LEVEL 1 100' - 0"	LEVEL/ELEVATION REFERENCE
1 A4.0	BUILDING SECTION	Comments	ROOM TAG
1 (A5.0)	WALL SECTION		WINDOW TAG
1 (A5.0)	DETAIL SECTION CALLOUT	(101.1)	DOOR TAG
	ENLARGED PLAN/ DETAIL CALLOUT		REVISION CLOUD & TAG

## ATTACHMENT 4

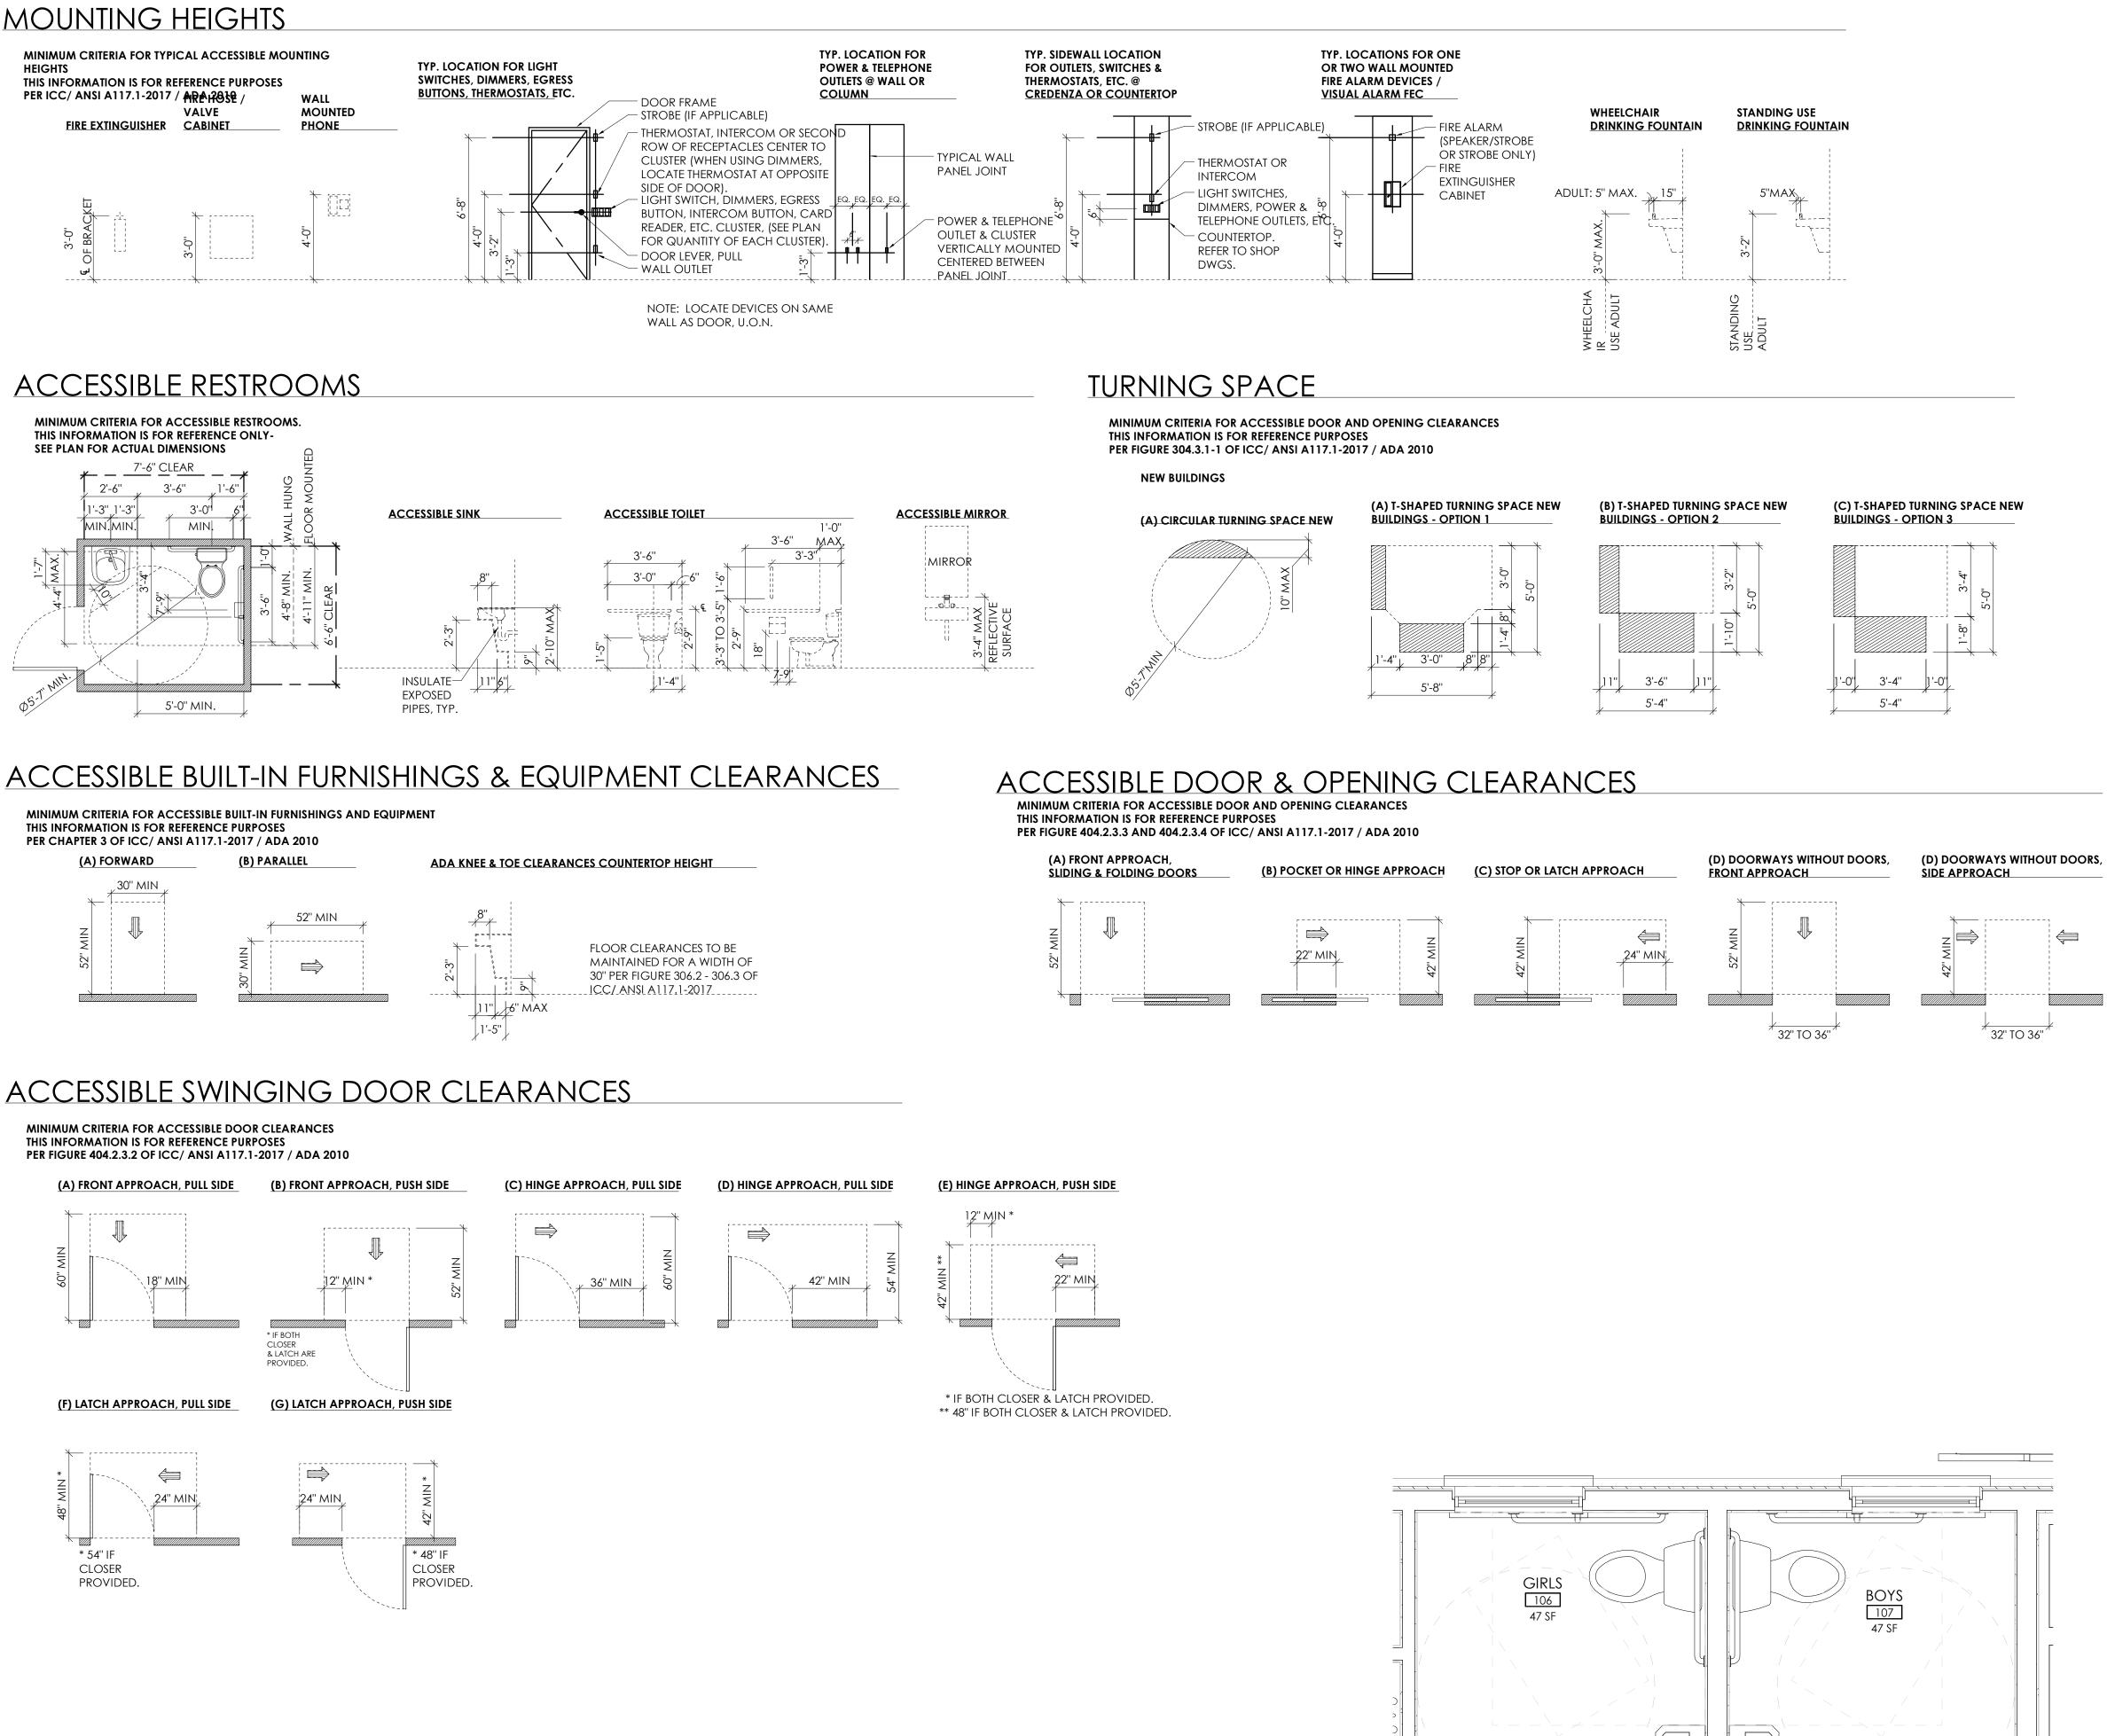

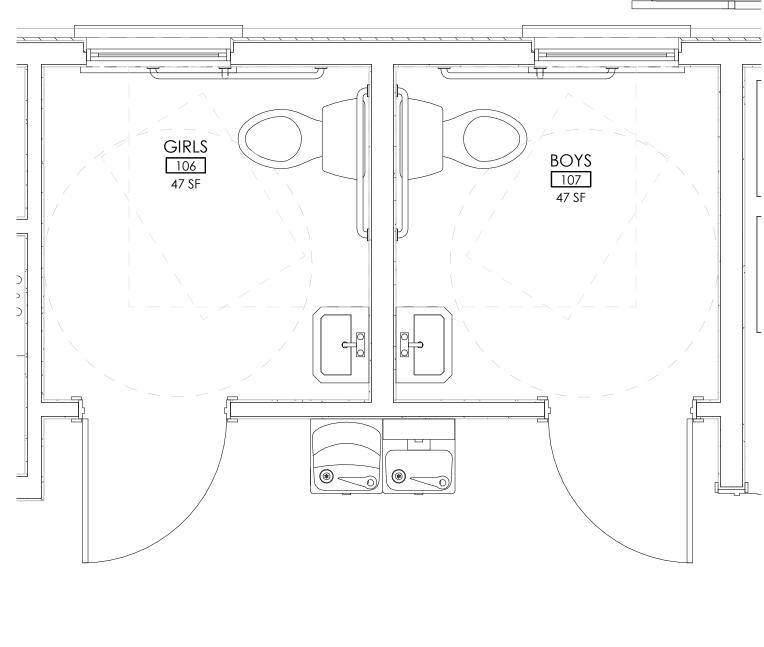









A0.2

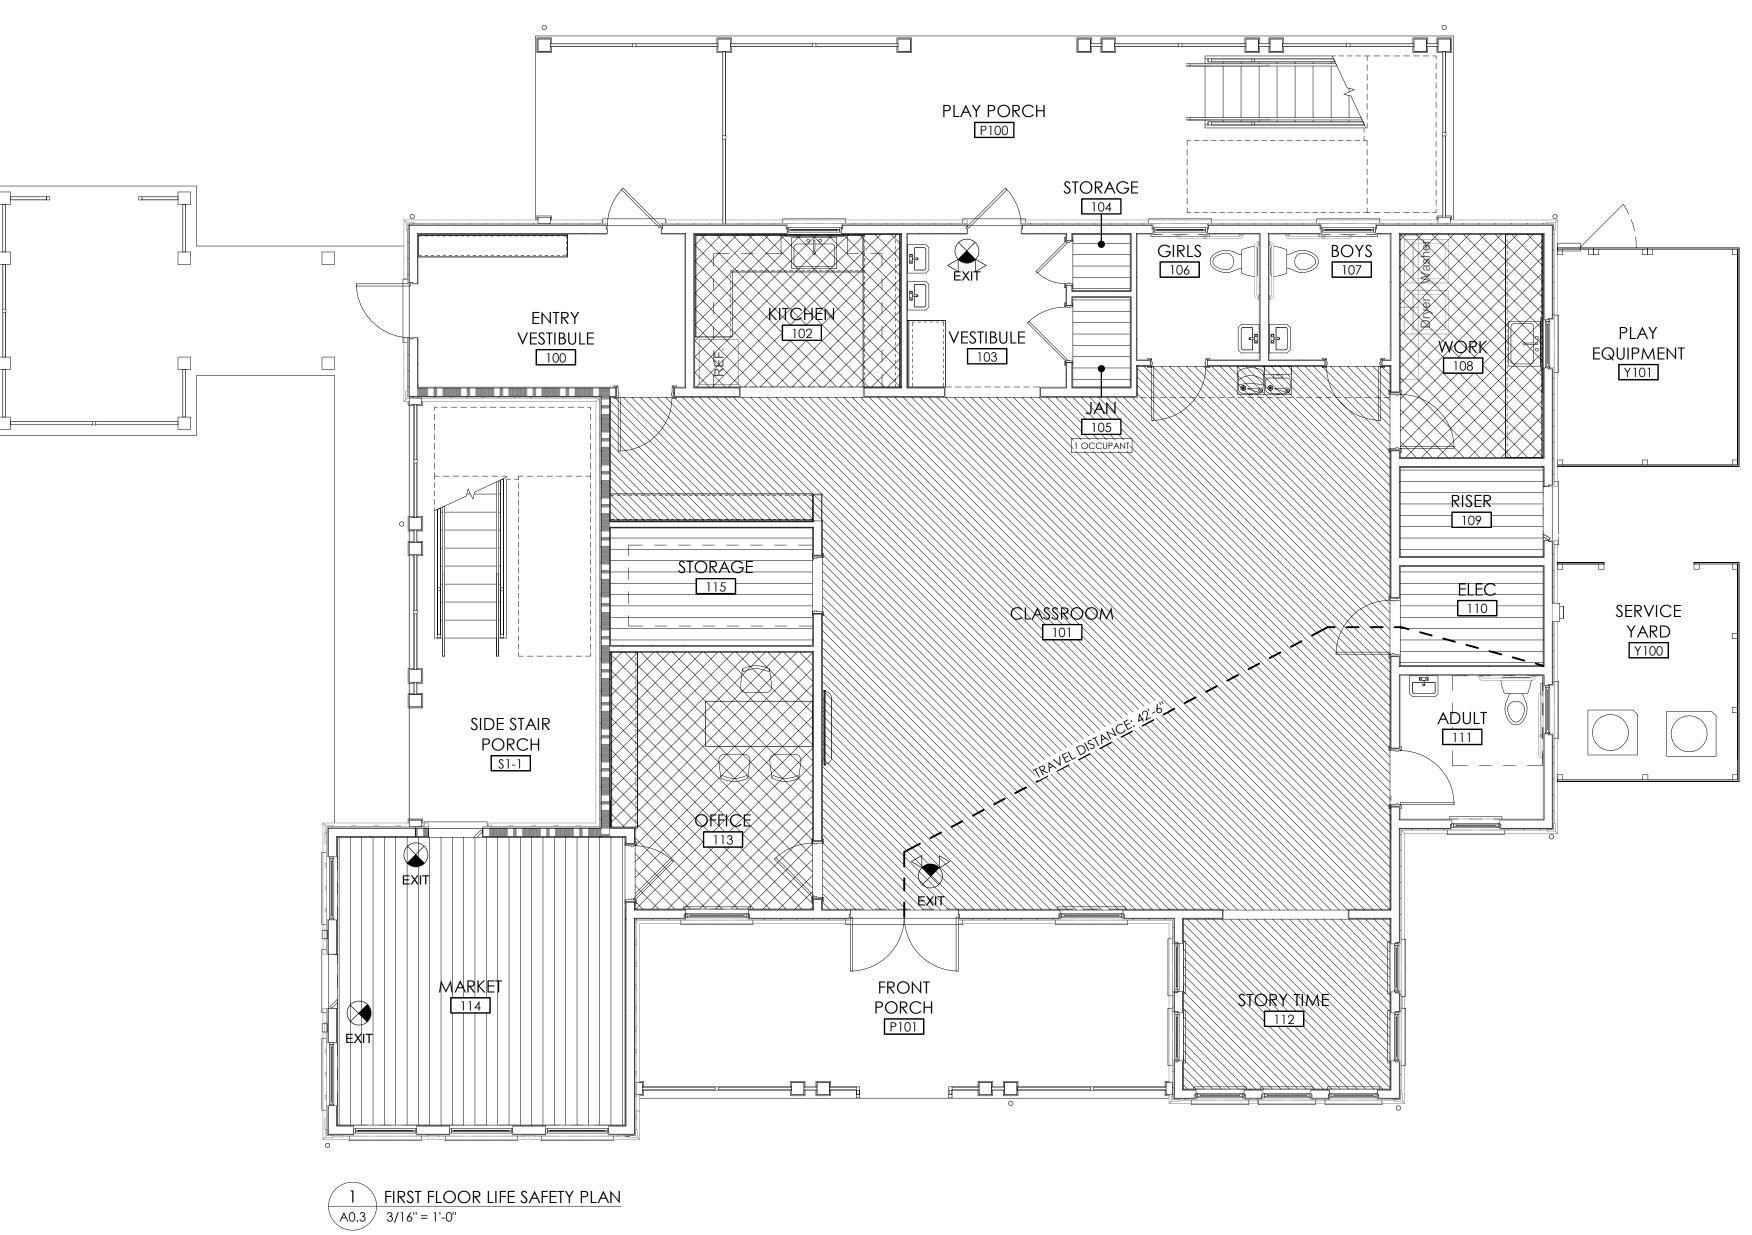

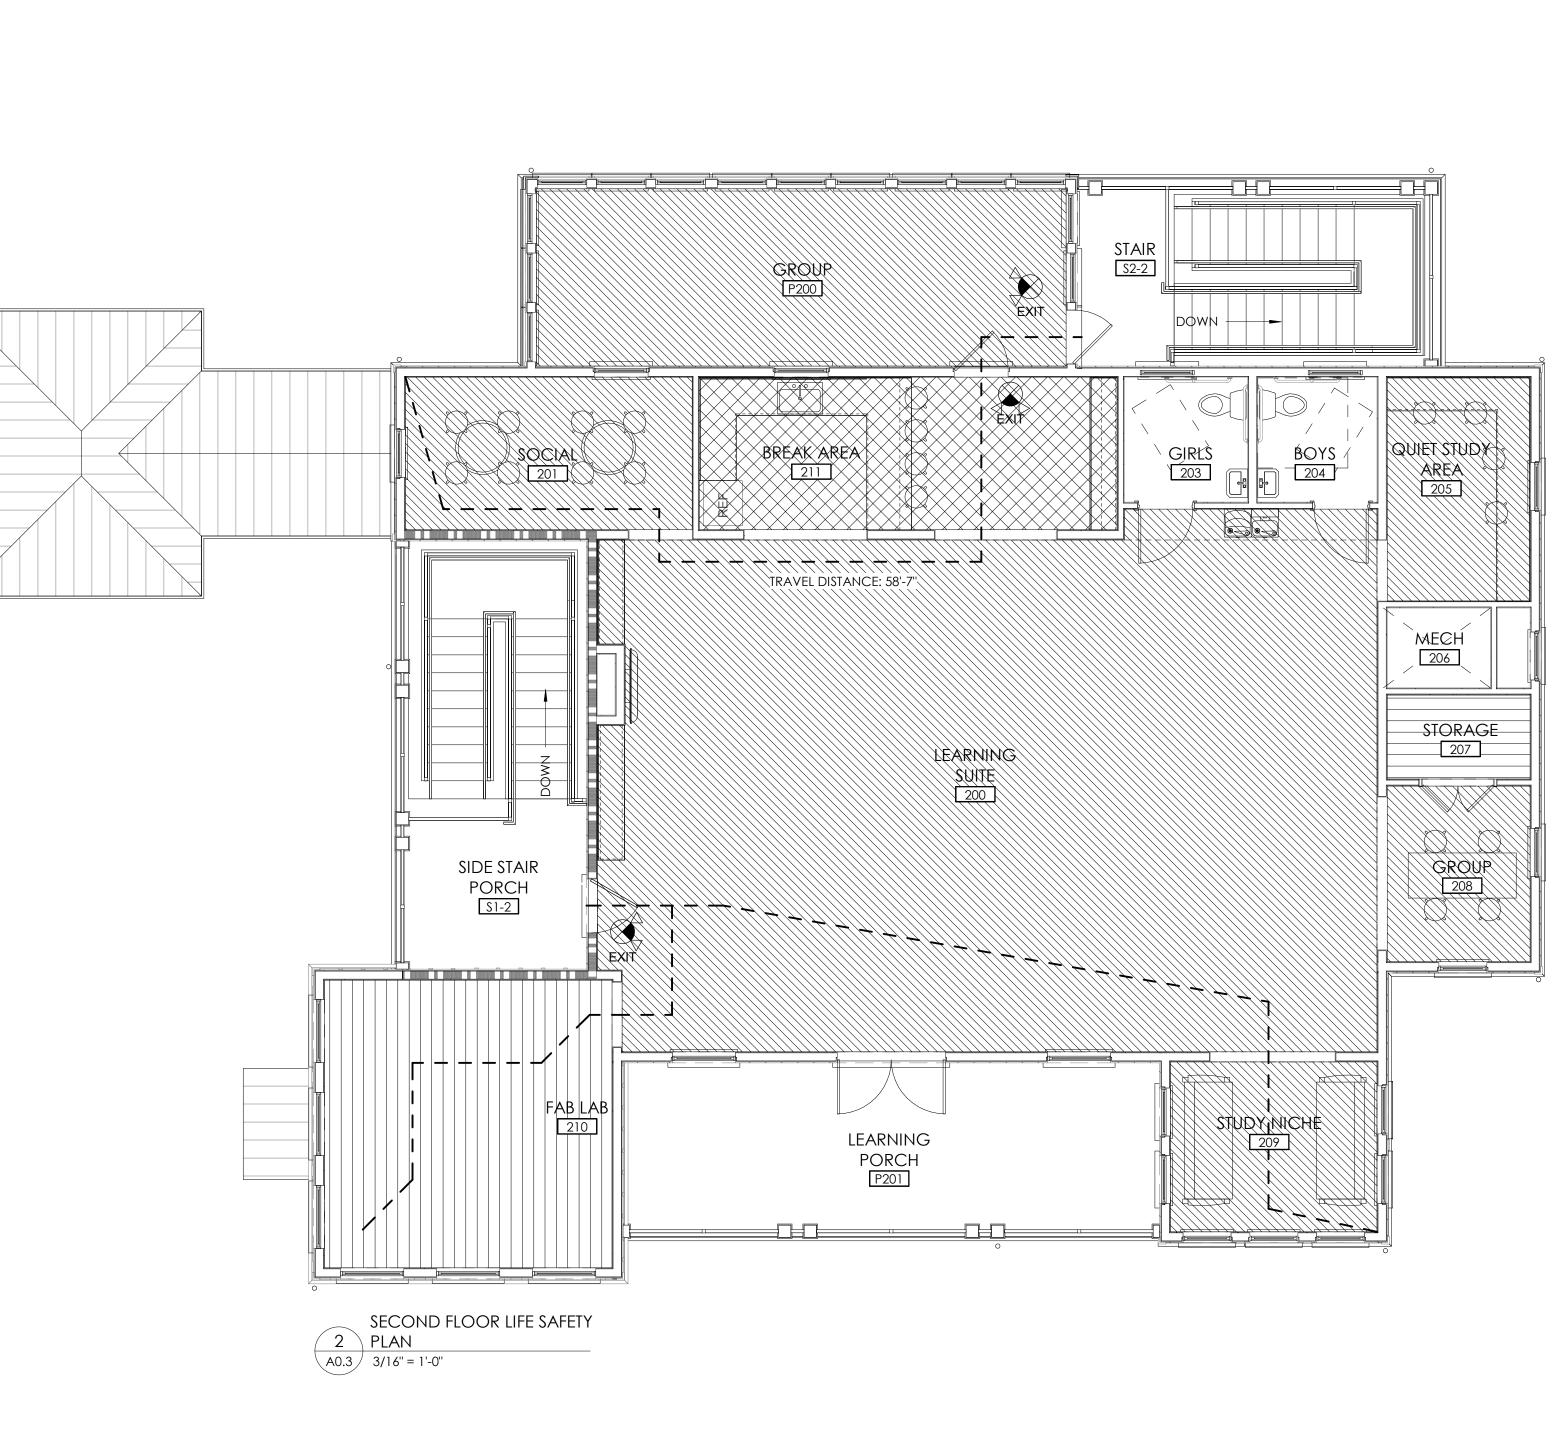LIFE SAFETY KEY					
	EDUCATIONAL (CLASSROOM AREA) 20 NET SF / OCCUPANT				
	EDUCATIONAL (VOCATIONAL AREA) 50 NET SF / OCCUPANT				
	BUSINESS 150 GROSS SF / OCCUPANT				
	STORAGE / MECHANICAL / ELECTRICAL 300 GROSS SF / OCCUPANT				
	EGRESS PATH				
FE	FIRE EXTINGUISHER - SURFACE MOUNTED ALL EXTINGUISHERS TO BE MADE OF NON-FERROUS MATERIAL TO MEET MR COMPATIBILITY				
EXIT	SELF POWERED EXIT SIGN (APPROXIMATE LOCATION). ARROW DENOTES DIRECTION OF EXIT PATH.				
EXIT	SELF POWERED COMBO EMERGENCY LIGHT / EXIT SIGN (APPROXIMATE LOCATION). ARROW DENOTES DIRECTION OF EXIT PATH.				
$\mathbf{A}$	WALL MOUTED EMERGENCY LIGHT				
LIFE SAFETY NOTES					
1. PROVIDE ILLUMINATED EXIT SIGNAGE AND EMERGENCY LIGHTING AS REQUIRED BY THE CODES LISTED ON SHEET A0.0.					

2. PROVIDE FIRE EXTINGUISHERS PER NFPA 10, INTERNATIONAL FIRE CODE AND LOCAL JURISDICTION REQUIREMENTS. LOCATION AND NUMBER TO BE DETERMINED BY FIRE MARSHAL. 3. SEE A0.0 FOR ADDITIONAL CODE ANALYSIS. 4. FOR FIRE ALARM PLAN SEE SHEET E3.1

T A0.0.



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BUILDING R  $\sim$  $\mathcal{S}$ 0 \_ Ш  $\circ$ Ζ  $\sim$ R  $\bigcirc$  $\mathcal{S}$  $\mathcal{O}$ Ш 7 Ο ~  $\sim$ Ш  $\sim$ 

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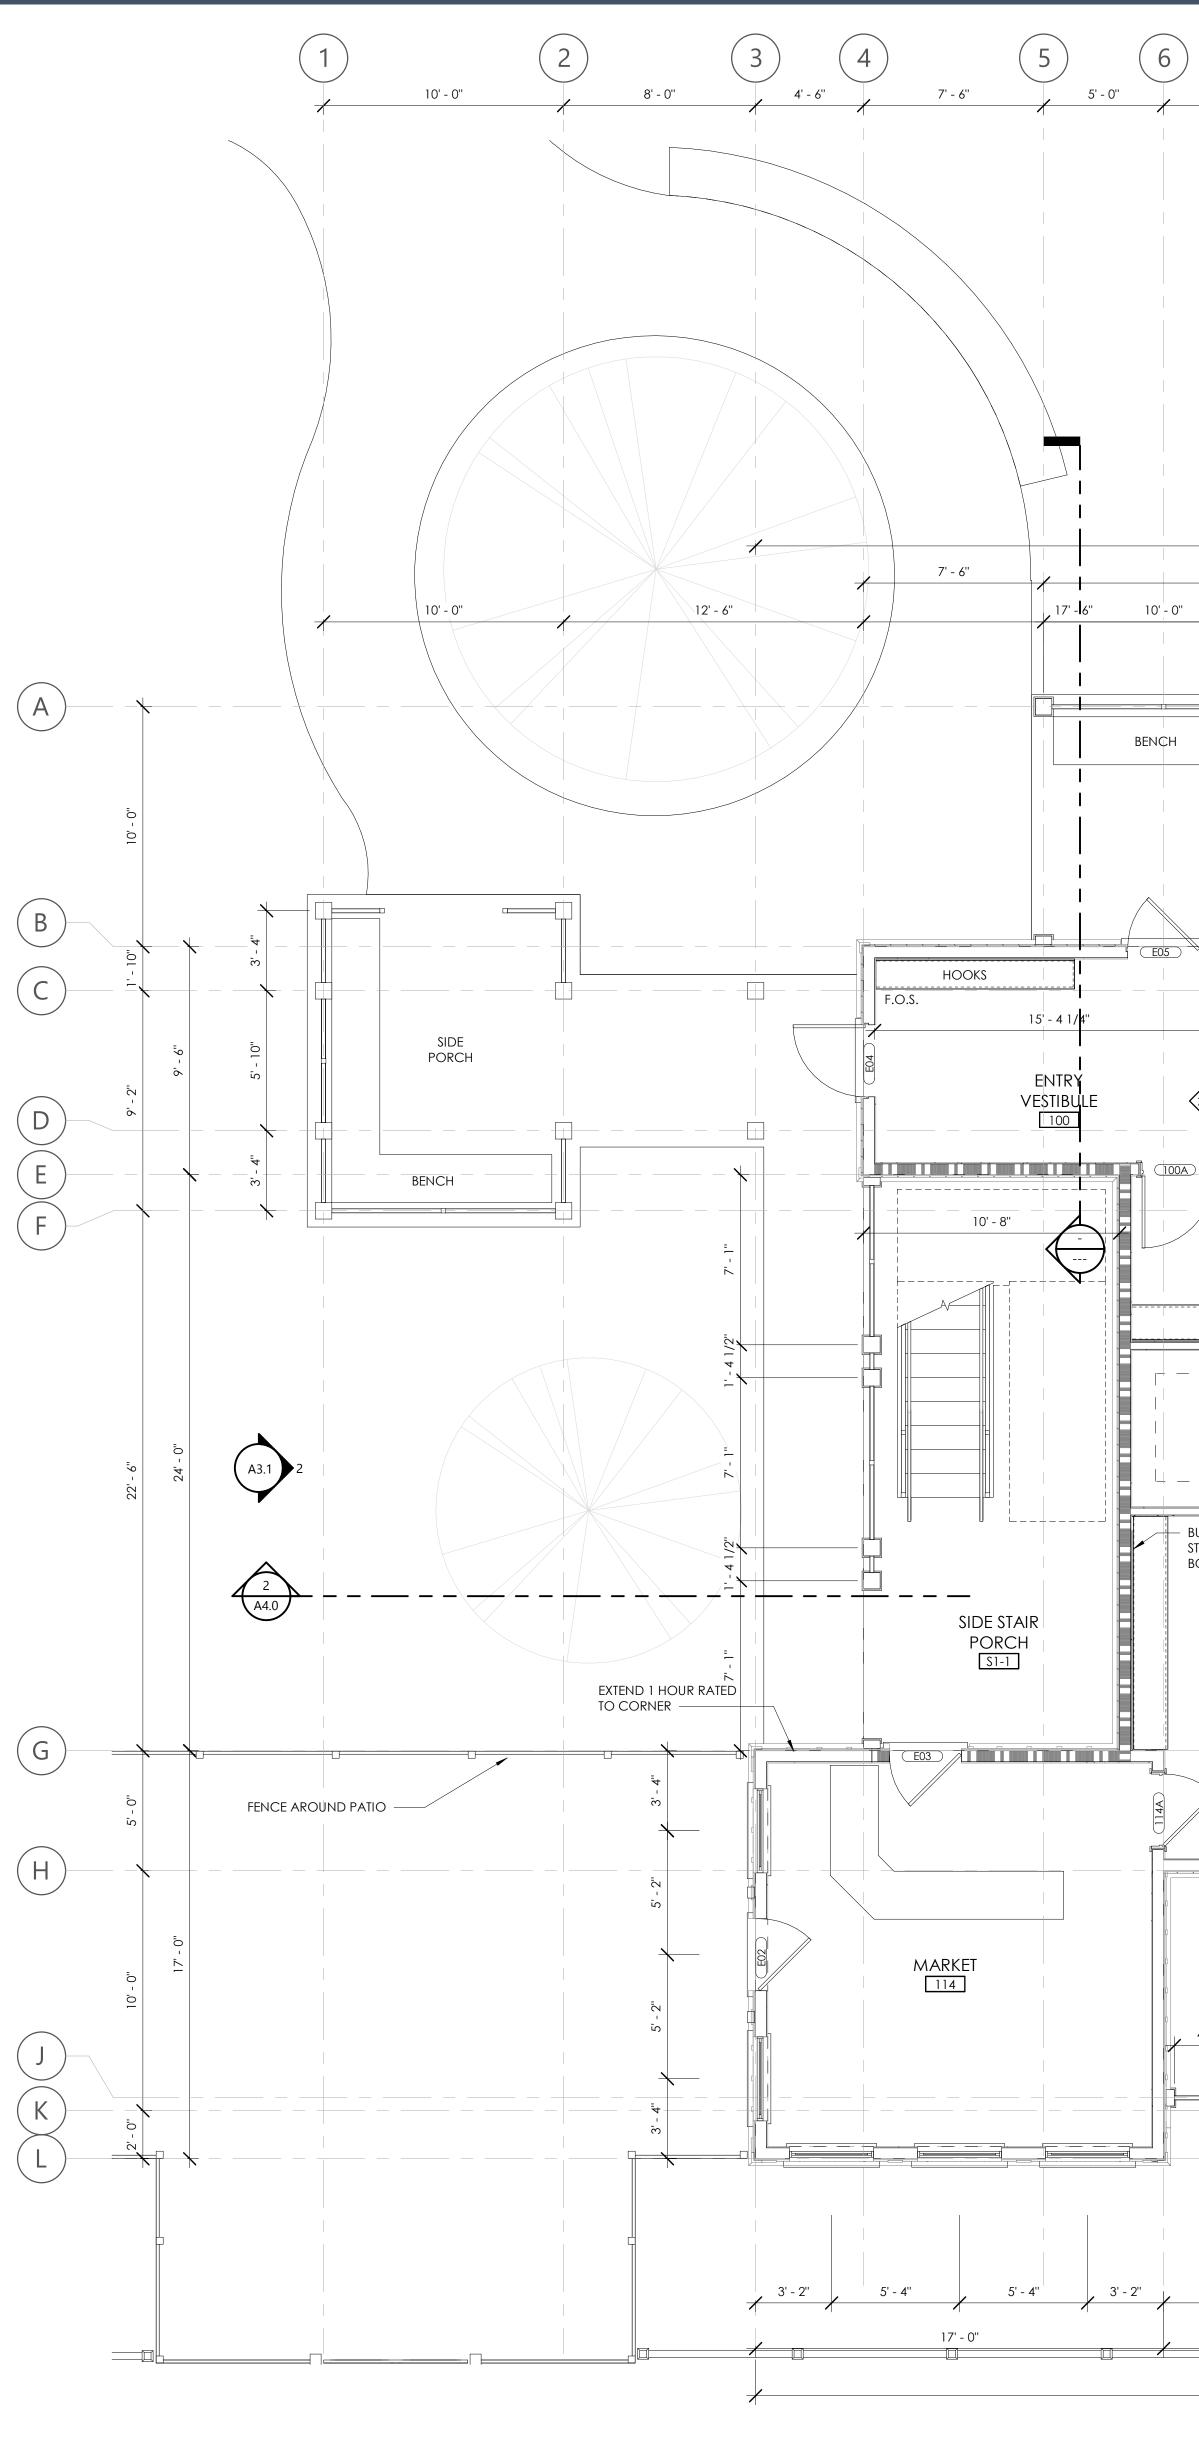
**PROJECT INFO** Date 2023.01.04 -Project No.

21-079 ISSUE

NO. REV. DATE DESCRIPTION

SHEET TITLE

LIFE SAFETY PLAN




1 FIRST FLOOR PLAN A2.1 1/4" = 1'-0"

(7)(6)(12)9 (10)(11)(8) 13 5' - 0" 5' - 0" 10' - 0'' 5' - 0'' 5' - 0'' 5' - 0'' 5' - 8'' 6' - 10'' , 2' - 6" 68' - 0'' 50' - 0'' 17' - 6" 10' - 0'' 10' - 0'' 10' - 0'' 8' - 0'' 8' - 0'' BENCH BENCH PLAY PORCH P100 ╶━╴└━╴╌━╴╶━╴╍╴┶━╴━┑ E06 E05 STORAG 104 3' - 7" GIRLS BOYS 107 - HAND WASH 9' - 2'' 11' - 10'' 7' - 4'' KITCHEN VESTIBULE 103 ABOVE -بلينيا النصب CHANGING AREA — \_ \_ \_ \_ LINE OF SOFFIT ABOVE 8 A0.2 STUDENT CUBBIES  $-\langle 2 \rangle$ \_ \_ \_ \_ \_ \_ \_ STORAGE 115 CLASSROOM BUILT IN SMART STORAGE / BOOK CASES BOARD -CONFIRM SIZE AND MODEL WITH OWNER OFFICE \_\_\_\_ \_/Þ=====th FRONT STORY TIME PORCH 112 4' - 1 3/4" , 4' - 1 3/4" , 4' - 1 3/4" , 4' - 1 3/4" \_\_\_\_de\_\_\_\_\_de\_\_\_\_d A5.1 2' - 6 1/2" 3' - 8 1/2" 3' - 8 1/2" 4' - 3" 9' - 1'' 3' - 2'' 9' - 1'' 9' - 0''

30' - 0''

68' - 0''

ATTACHMENT 4

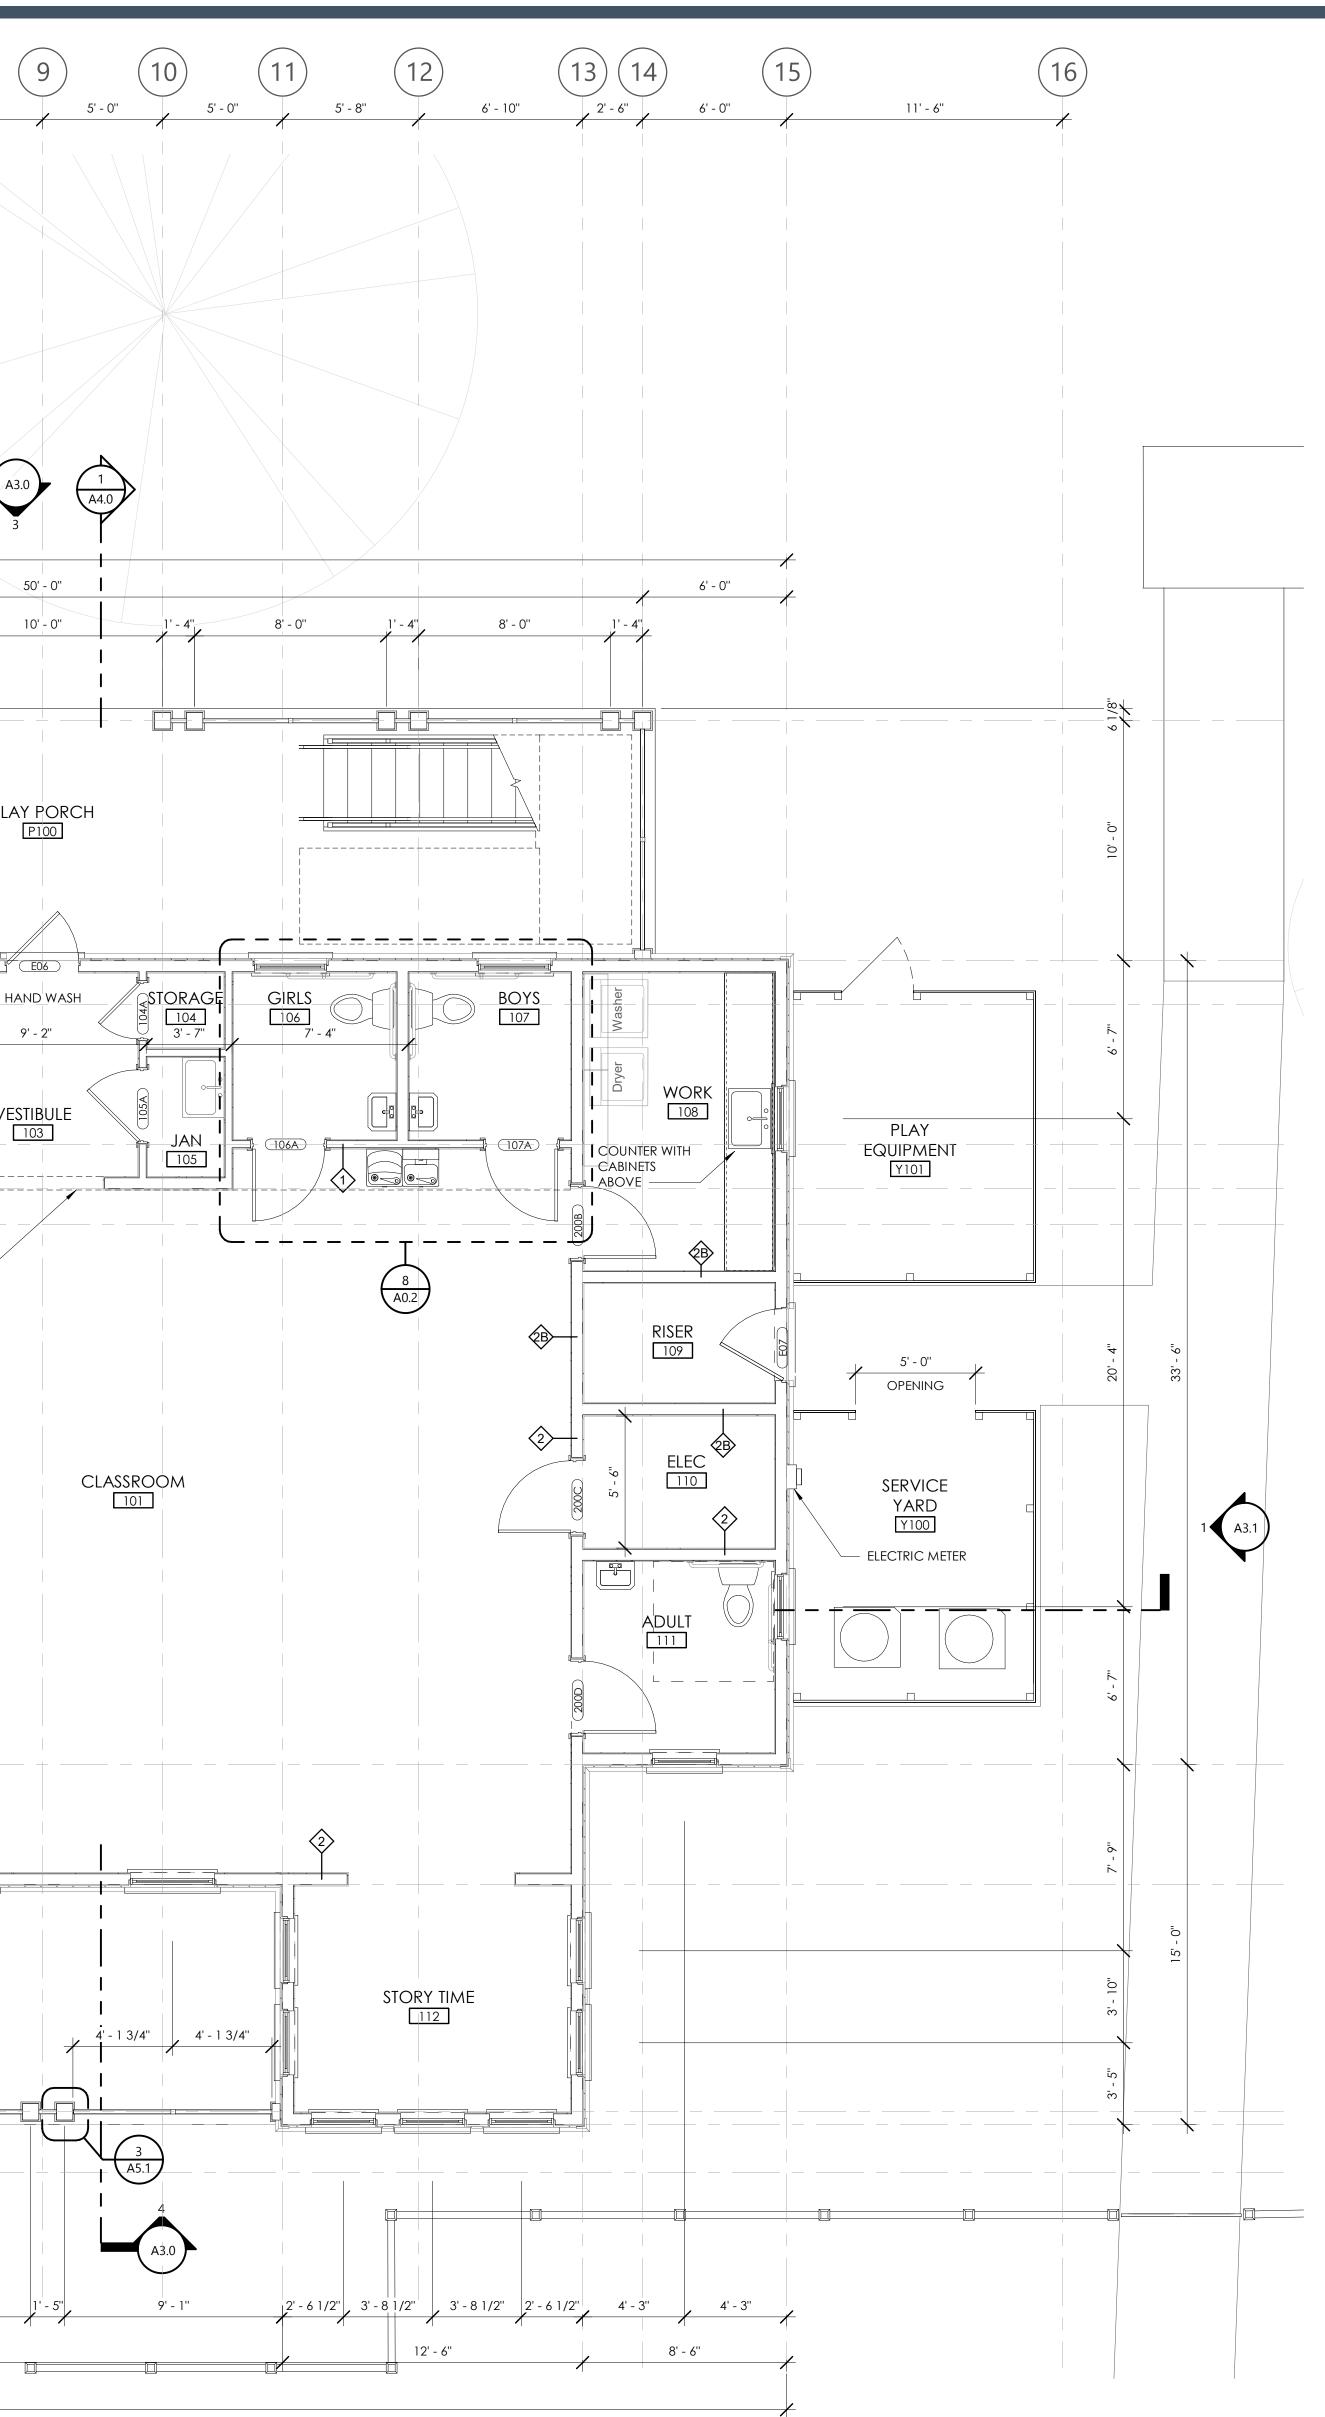

## GENERAL FLOOR PLAN NOTES:

- Exterior dimensions are to the edge of foundation and framing, unless noted OTHERWISE. DO NOT SCALE DRAWINGS. CONTACT ARCHITECT WITH ANY discrepancies.
- INTERIOR DIMENIONS ARE TO THE FACE OF FRAMING OR CENTERLINE OF FRAMING UNLESS NOTED OTHERWISE. DO NOT SCALE DRAWINGS. CONTACT ARCHITECT WITH ANY DISCREPANCIES.
- SEE COVER PAGE FOR NOTES AND LIMITATIONS TO ARCHITECTURAL SCOPE OF SERVICES. see a0.2 for ansi/ada requirements.
- ADJUST TOP OF SLAB, WALL, AND ROOF BEARING PLATES AS REQUIRED FOR CHANGES IN STRUCTURAL MEMBER SIZES OR EXISTING SITE CONDITIONS.
- GC/OWNER TO COORDINATE ALL IN-SLAB ELECTRICAL AND PLUMBING REQUIREMENTS WITH APPROPRIATE SUBCONTRACTOR TRADES PRIOR TO PLACING SLAB.
- STRUCTURAL ENGINEERING DOCUMENTS SUPERSEDE ARCHITECTURAL DOCUMENTS AND SCHEDULES WITH REGARD TO SIZE OF STRUCTURAL MEMBERS, PLACEMENT, AND CONNECTION DETAILS. CONTACT ARCHITECT WITH ANY DISCREPANCIES.
- WALL TYPE SHALL BE TYPE '1' UNLESS NOTED OTHERWISE.
- DOOR OPENINGS SET 6" OFF INTERSECTING WALL, UNLESS OTHERWISE DIMENSIONED.
- WALL TAG DESIGNATIONS ARE INTENDED FOR THE LENGTH OF THE WALL ON THE SIDE OF THE ROOM ON WHICH THE LETTER DESIGNATION IS LOCATED.
- 1. STOREFRONT / GLAZING UNITS TO BE CENTERED BETWEEN COLUMN LINES U.N.O., TYP.

## BUILDING SQUARE FOOTAGES

CONDITIONED AREAS

FIRST FLOOR PLAN	2,498 SF
SECOND FLOOR PLAN	2,819 SF
TOT	AL 5,317 SF


### COVERED PORCH AREAS

LEVEL 01	PLAY PORCH		533 SF
LEVEL 01	MIDDLE SCHOOL	_	243 SF
LEVEL 01	FRONT PORCH		278 SF
LEVEL 01	STAIR 1		256 SF
LEVEL 02	LEARNING PORC	Ή	266 SF
LEVEL 02	STAIR 1		102 SF
LEVEL 02	STAIR 2		204 SF
		TOTAL	1,882 SF

## FLOOR PLAN - SYMBOL KEY



2x4 WALL WITH 5/8" GYPSUM WALLBOARD 2x6 WALL WITH 5/8" GYPSUM WALLBOARD SOUND BATT INSULATION • • • • 1 HOUR FIRE RATED WALL (U305 & U348) NEW WINDOW

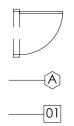


(100)

NEW DOOR



DOOR TAG

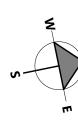



PH: 843.815.2557 FX: 843.815.2547

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 $\circ$  $\overline{\phantom{a}}$ 



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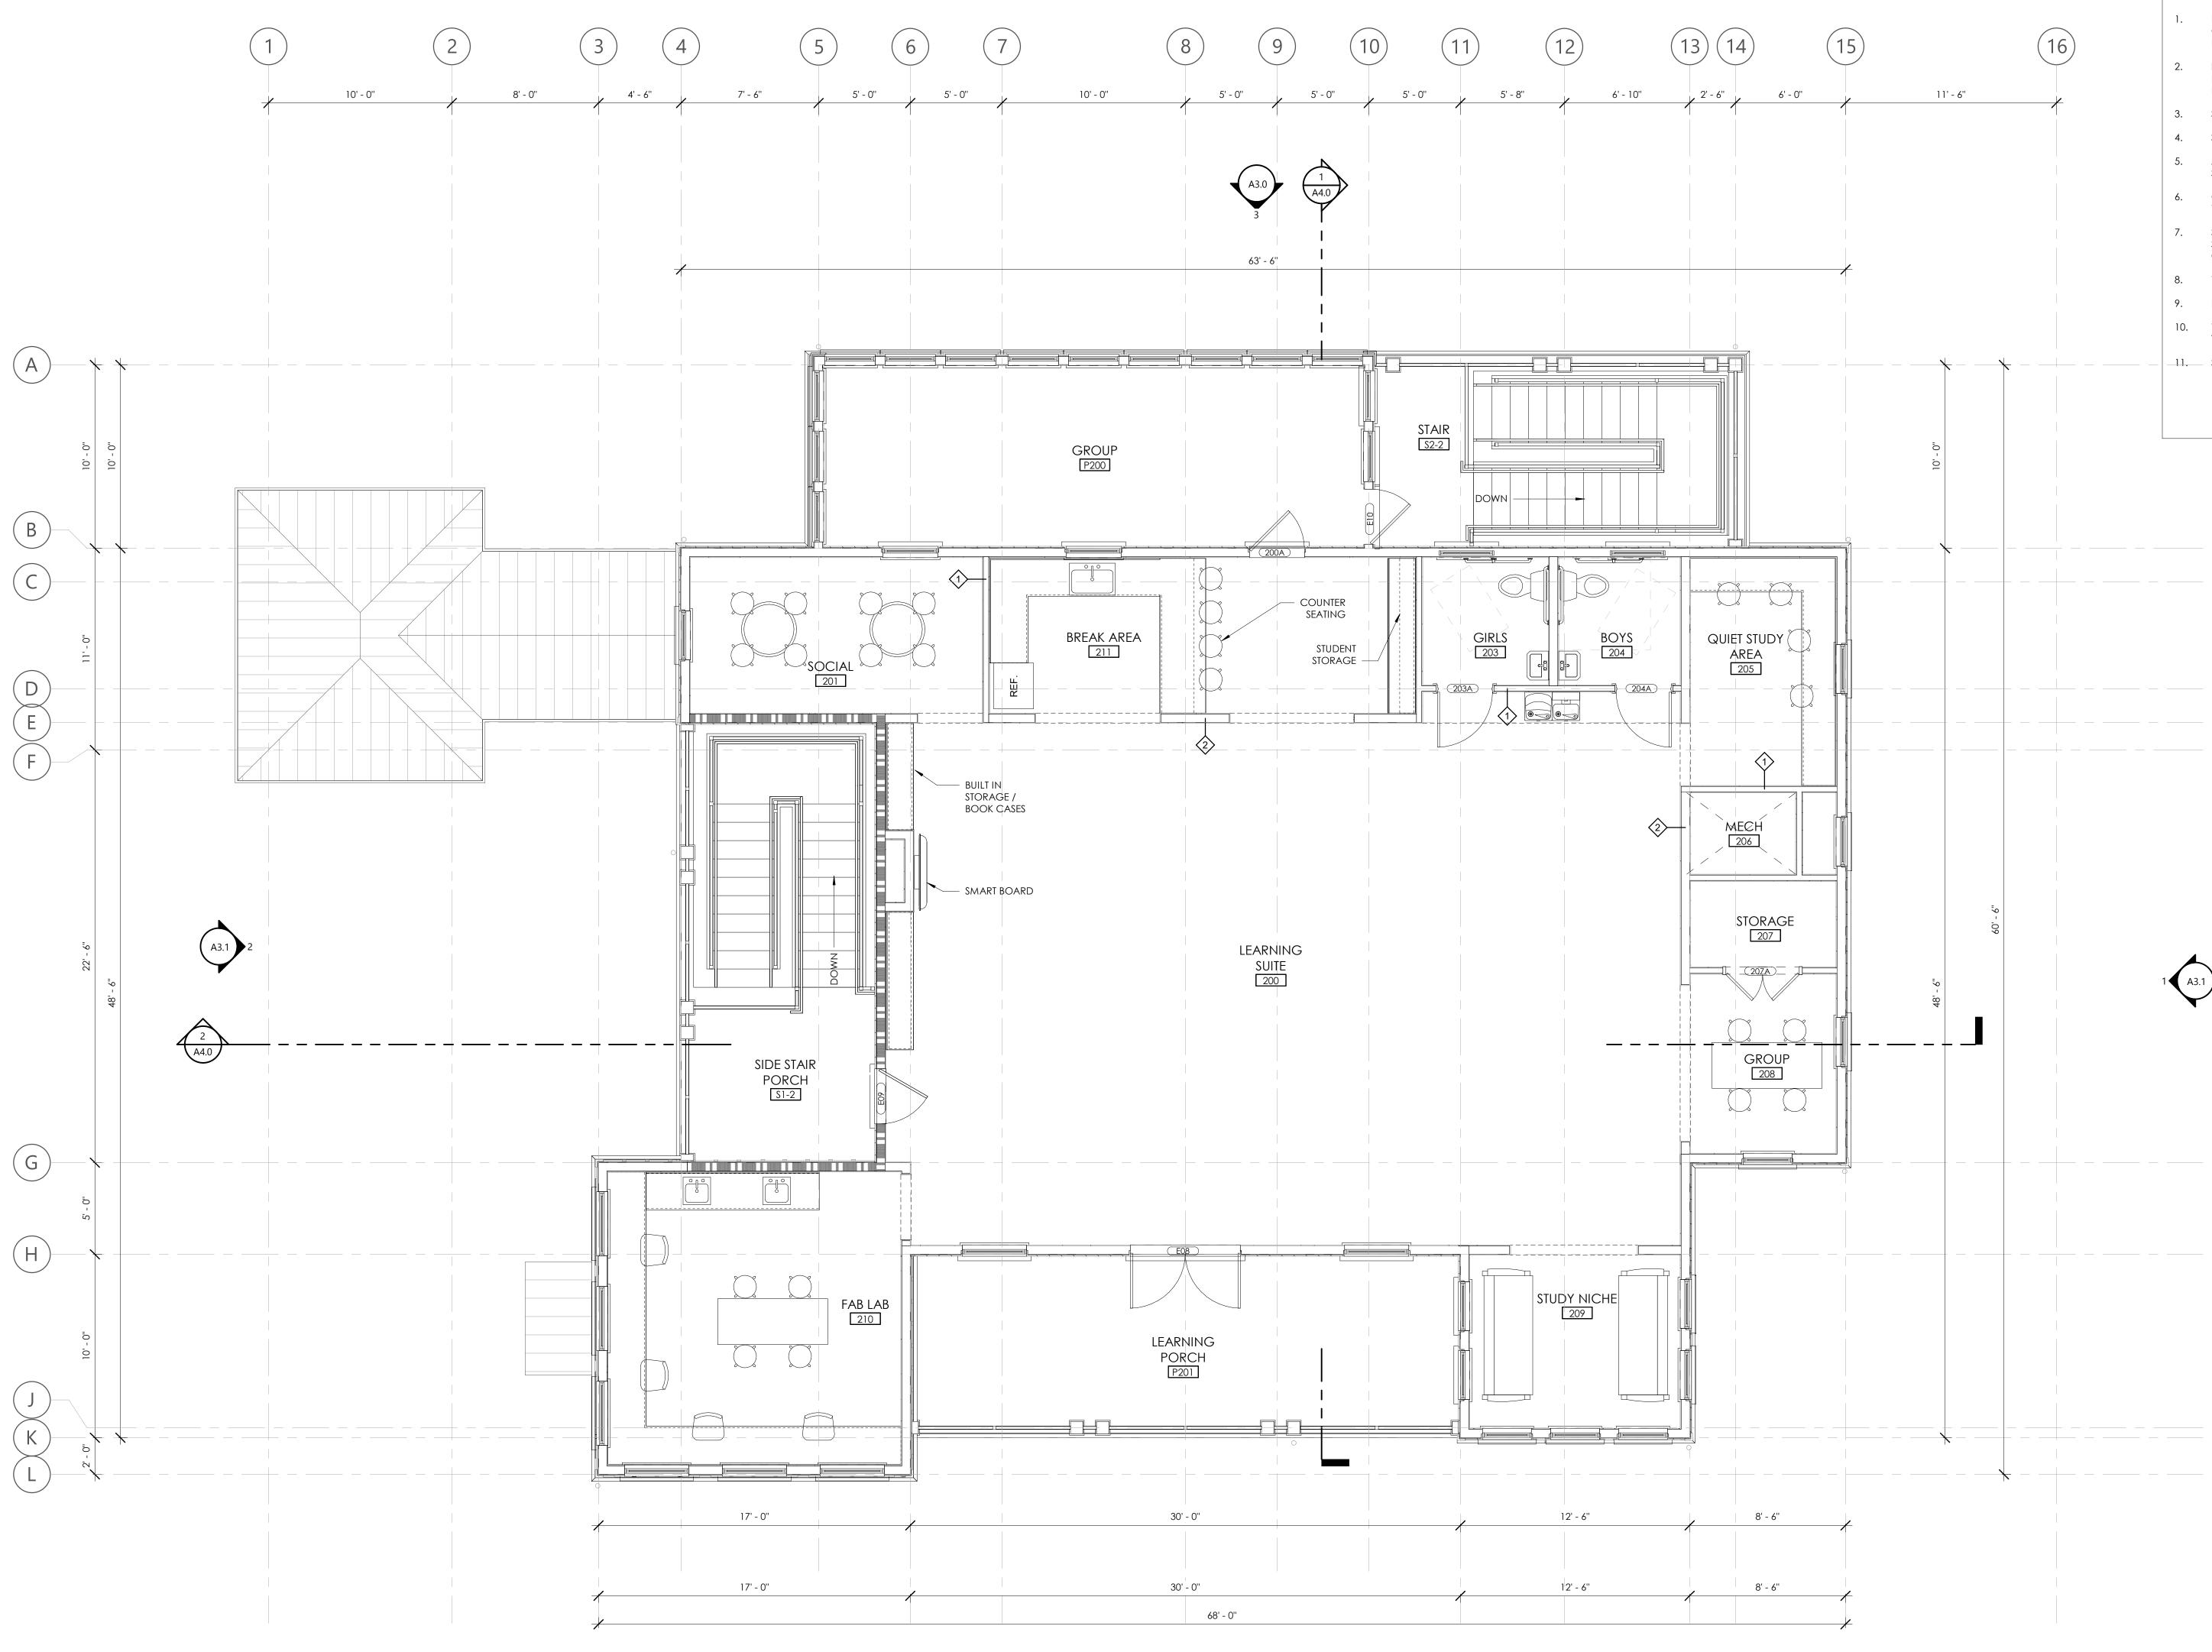
2023.01.04 -----Project No. 21-079

#### ISSUE

NO. REV. DATE DESCRIPTIO

#### SHEET TITLE

FIRST FLOOR PLAN A2.1



1 SECOND FLOOR PLAN A2.2 1/4" = 1'-0"

## ATTACHMENT 4

## GENERAL FLOOR PLAN NOTES:

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- INTERIOR DIMENIONS ARE TO THE FACE OF FRAMING OR CENTERLINE OF FRAMING UNLESS NOTED OTHERWISE. DO NOT SCALE DRAWINGS. CONTACT ARCHITECT WITH ANY discrepancies.
- 3. SEE COVER PAGE FOR NOTES AND LIMITATIONS TO ARCHITECTURAL SCOPE OF SERVICES. 4. SEE A0.2 FOR ANSI/ADA REQUIREMENTS.
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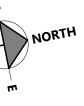
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#### **PROJECT INFO** Date


2023.01.04 -----Project No. 21-079

NO. REV. DATE DESCRIPTION

SHEET TITLE



SECOND FLOOR PLAN A2.2

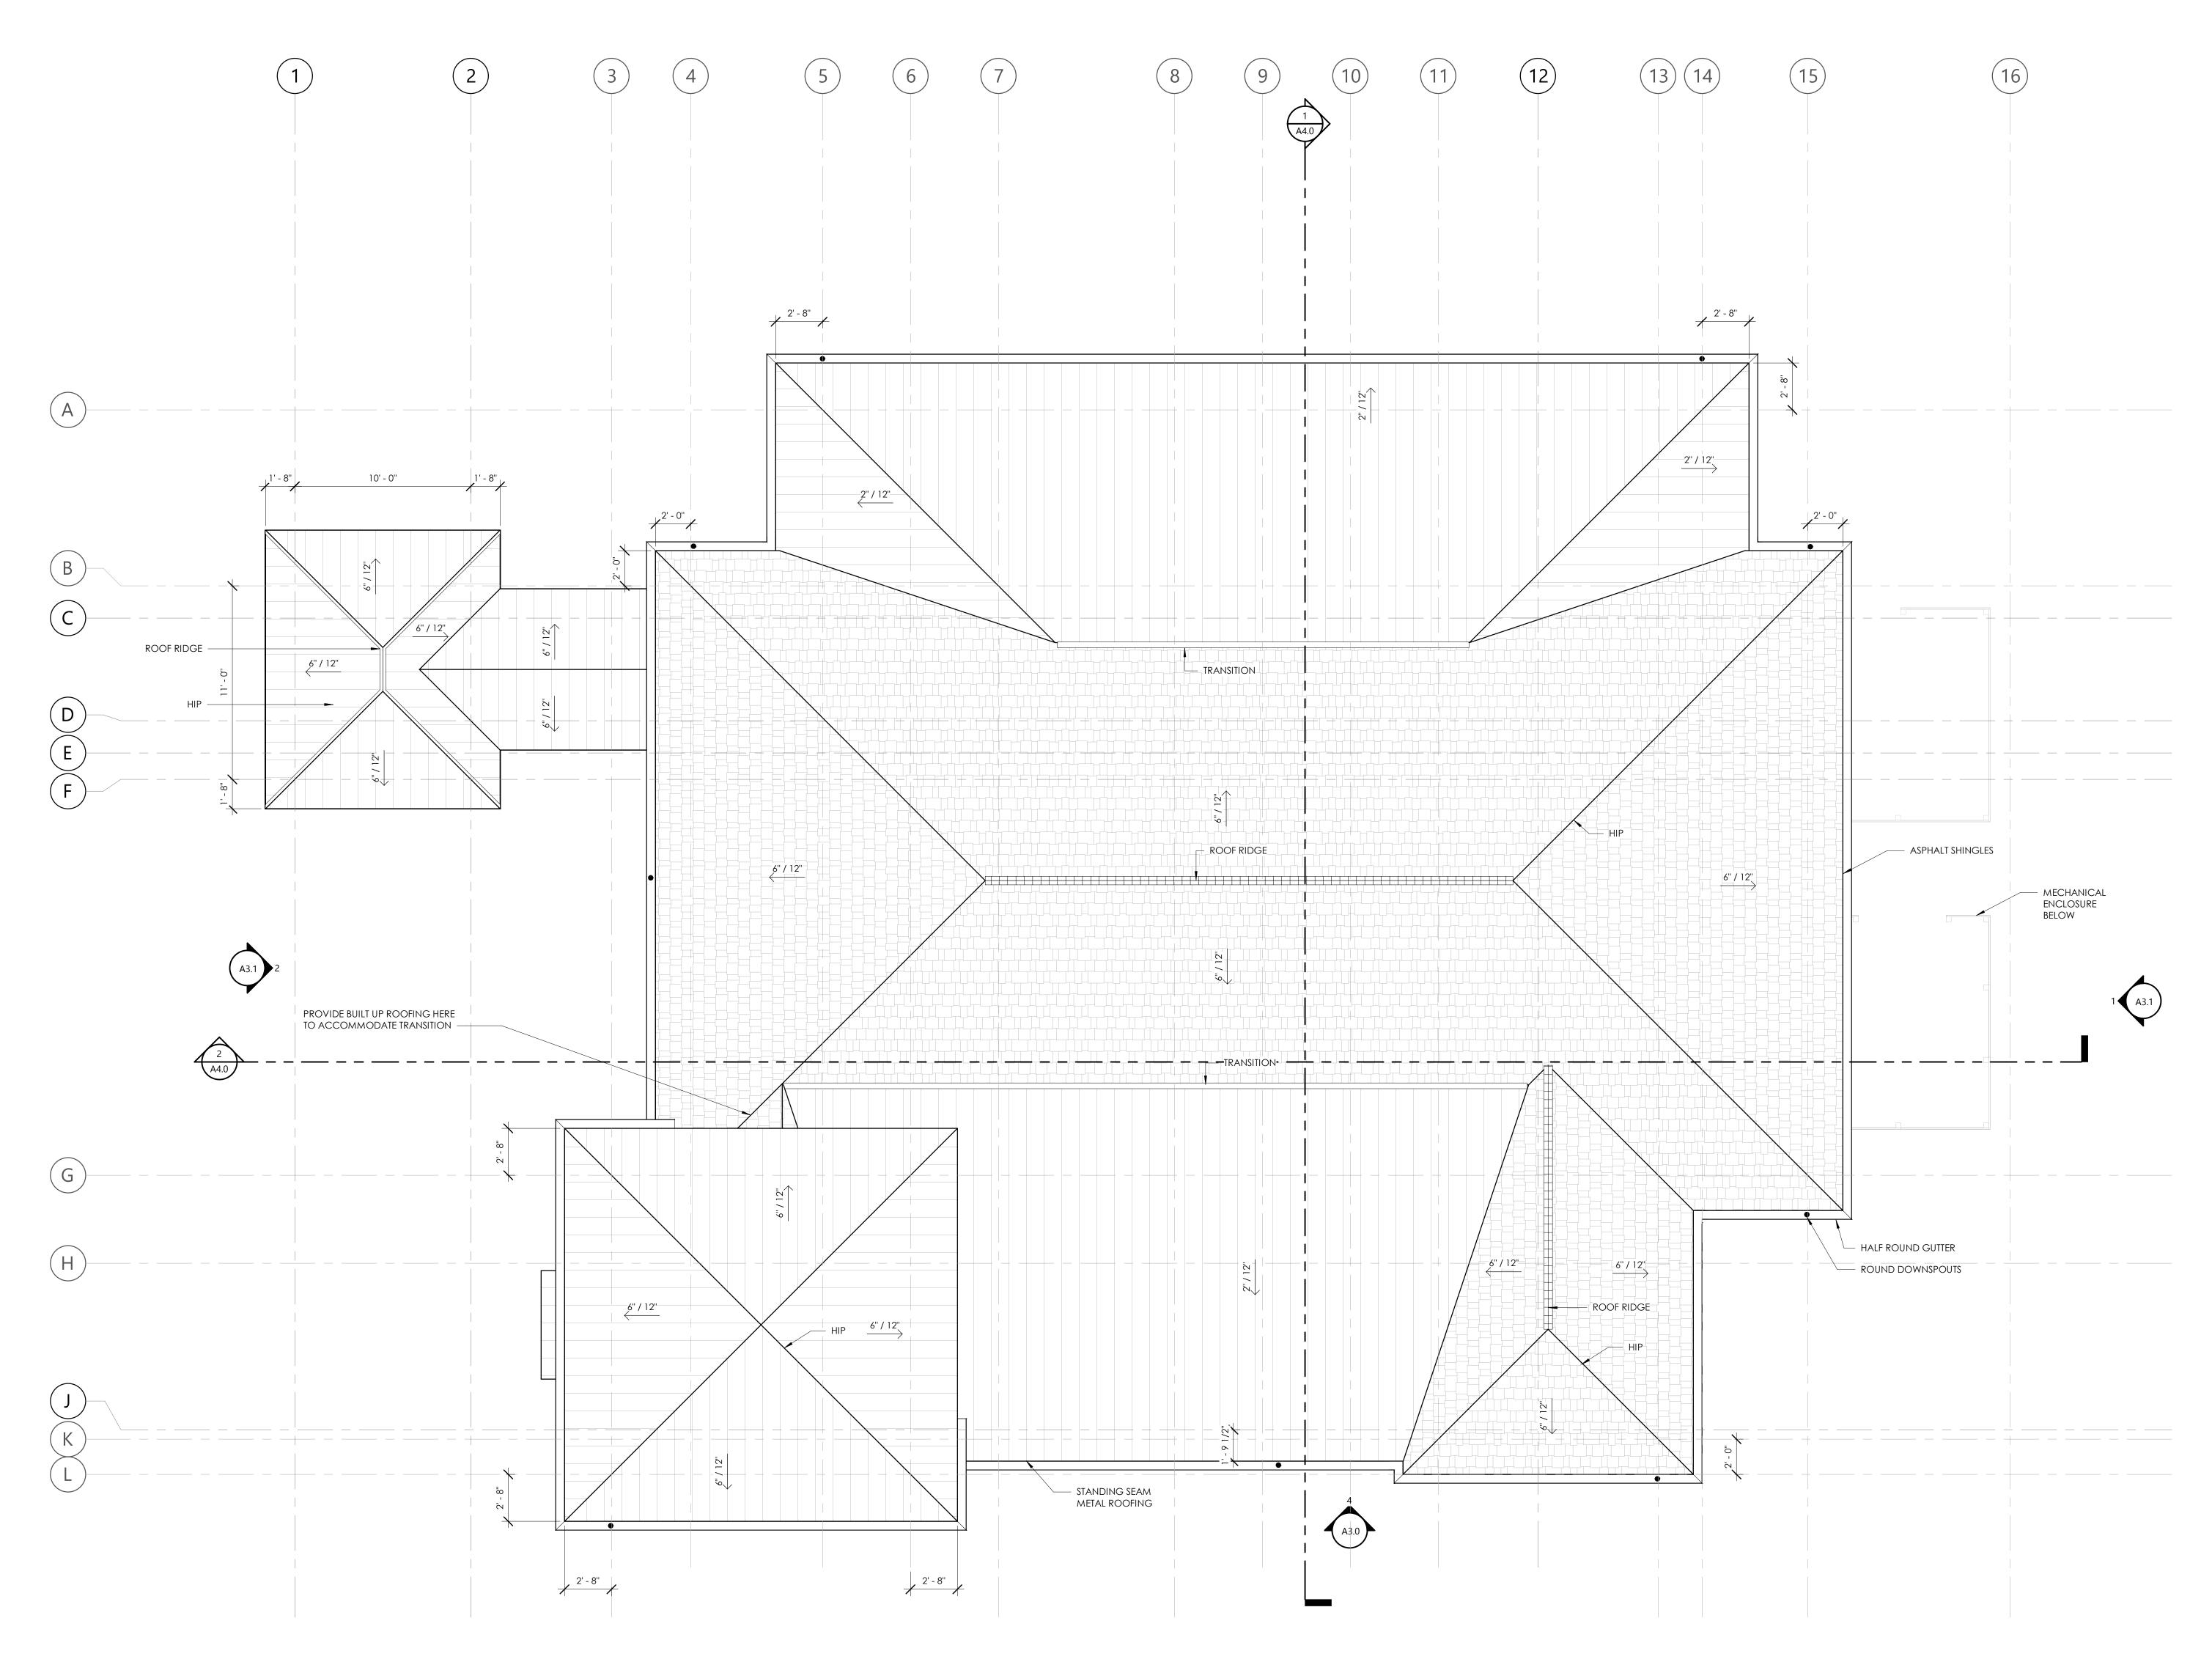

1 ROOF PLAN A2.3 1/4" = 1'-0"

## GENERAL ROOF PLAN NOTES:


- 1. AT ALL ROOF RIDGES AND HIPS USE CONTINUOUS SELF ADHERED UNDERLAYMENT CONTINUE OVER RIDGE/HIP 2" BOTH WAYS.
- 2. AT ALL ROOF VALLEYS USE 36" SELF-ADHERED MEMBRANE FLASHING CENTERED IN VALLEY 3. VERIFY ROOF TOP EQUIPMENT CLEARANCES W/ MANUFACTURERS TO VERIFY EQUIPMENT LAYOUTS.









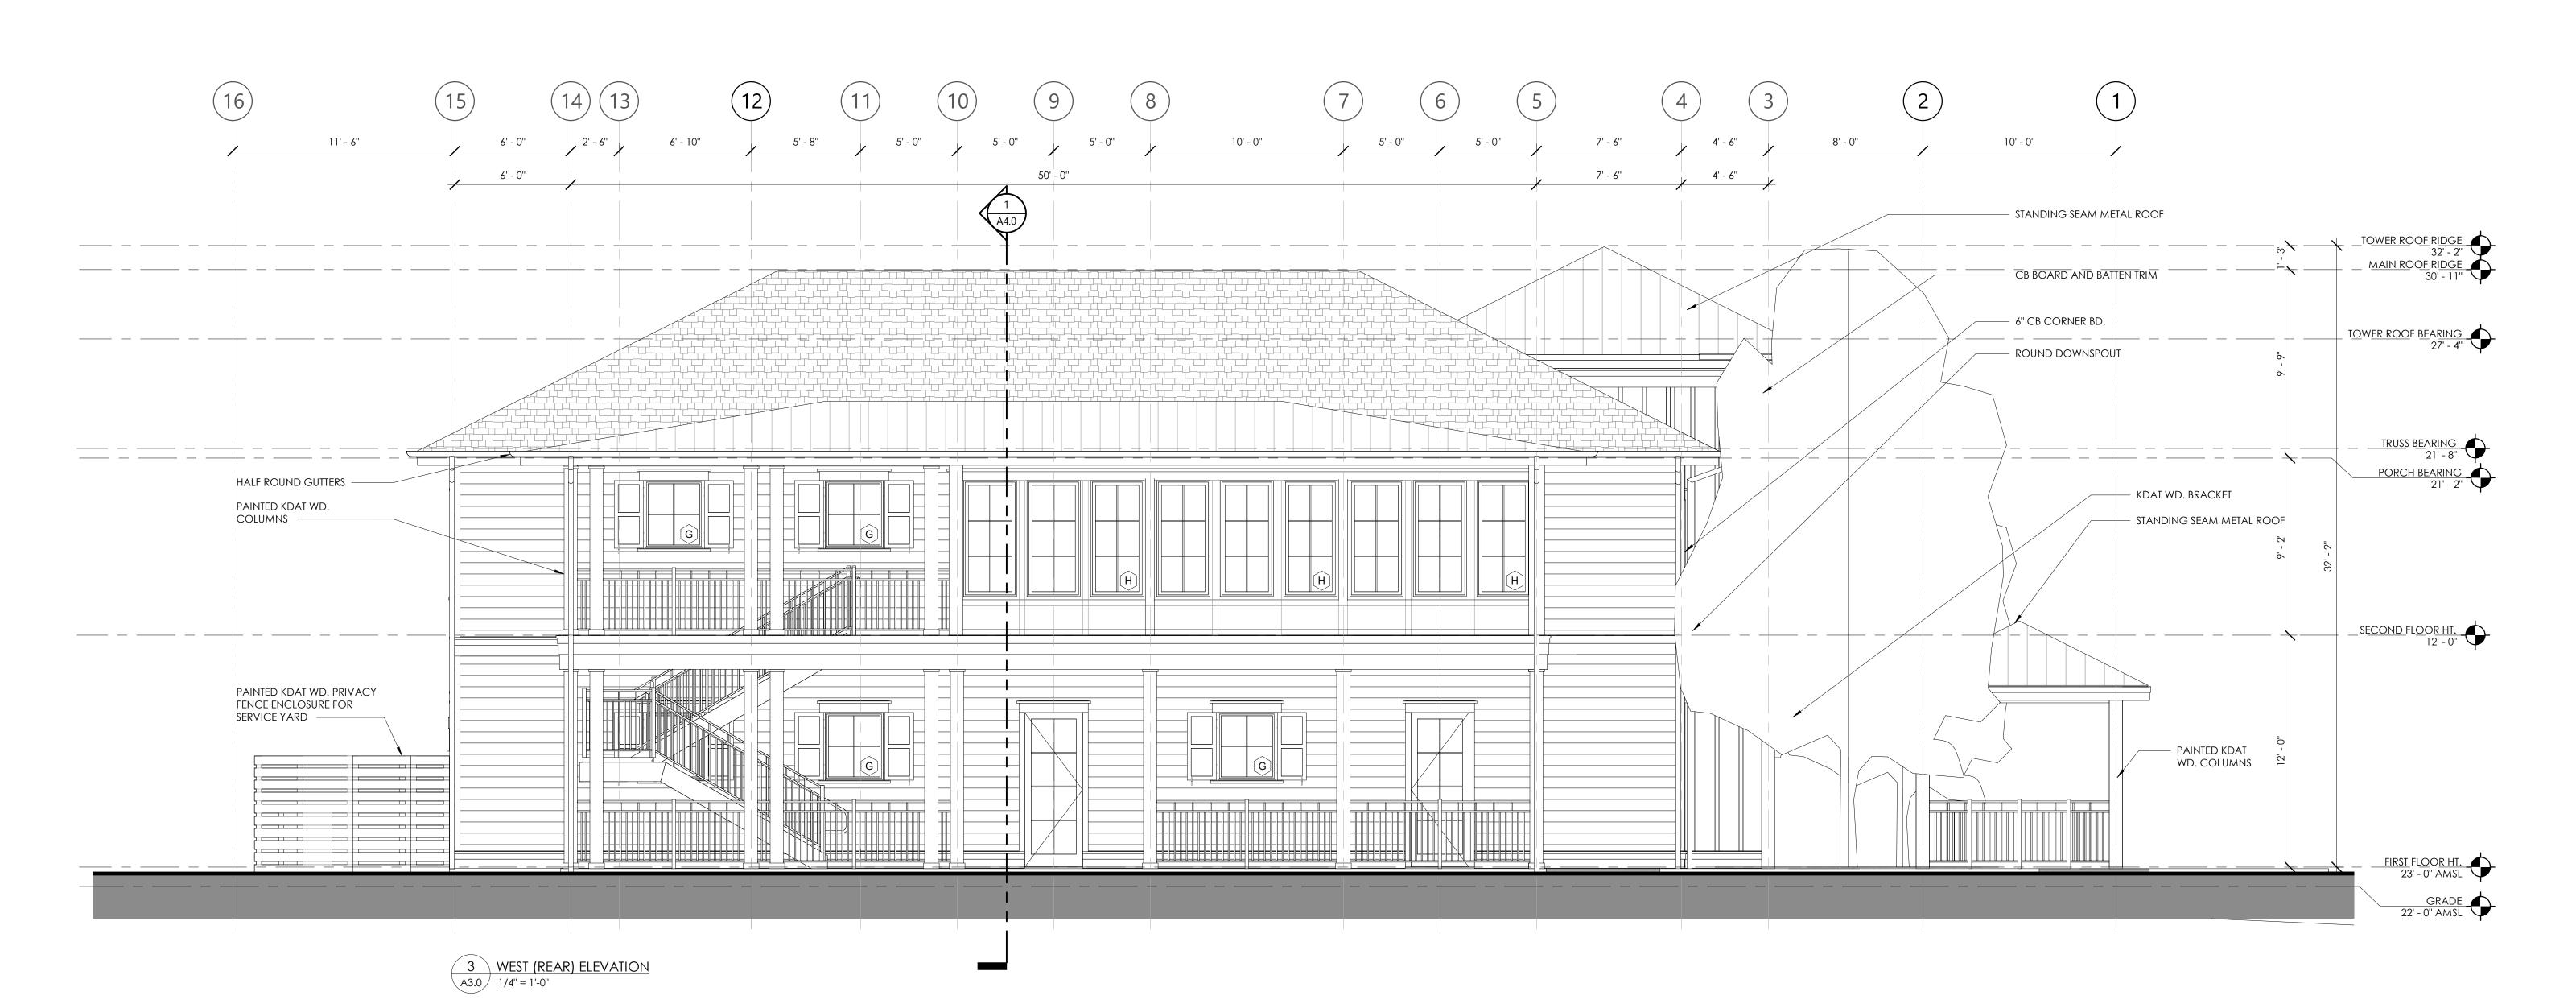



<sup>4</sup> EAST (FRONT) ELEVATION A3.0 1/4" = 1'-0"



1. G.C. / SUB-CONTRACTORS SHALL BE RESPONSIBLE FOR ALL MEANS AND METHODS OF COMPLETING THE SCOPE OF WORK

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## ABBREVIATIONS:

CB FIBER CEMENT BOARD KDAT KILN DRIED AFTER TREATMENT



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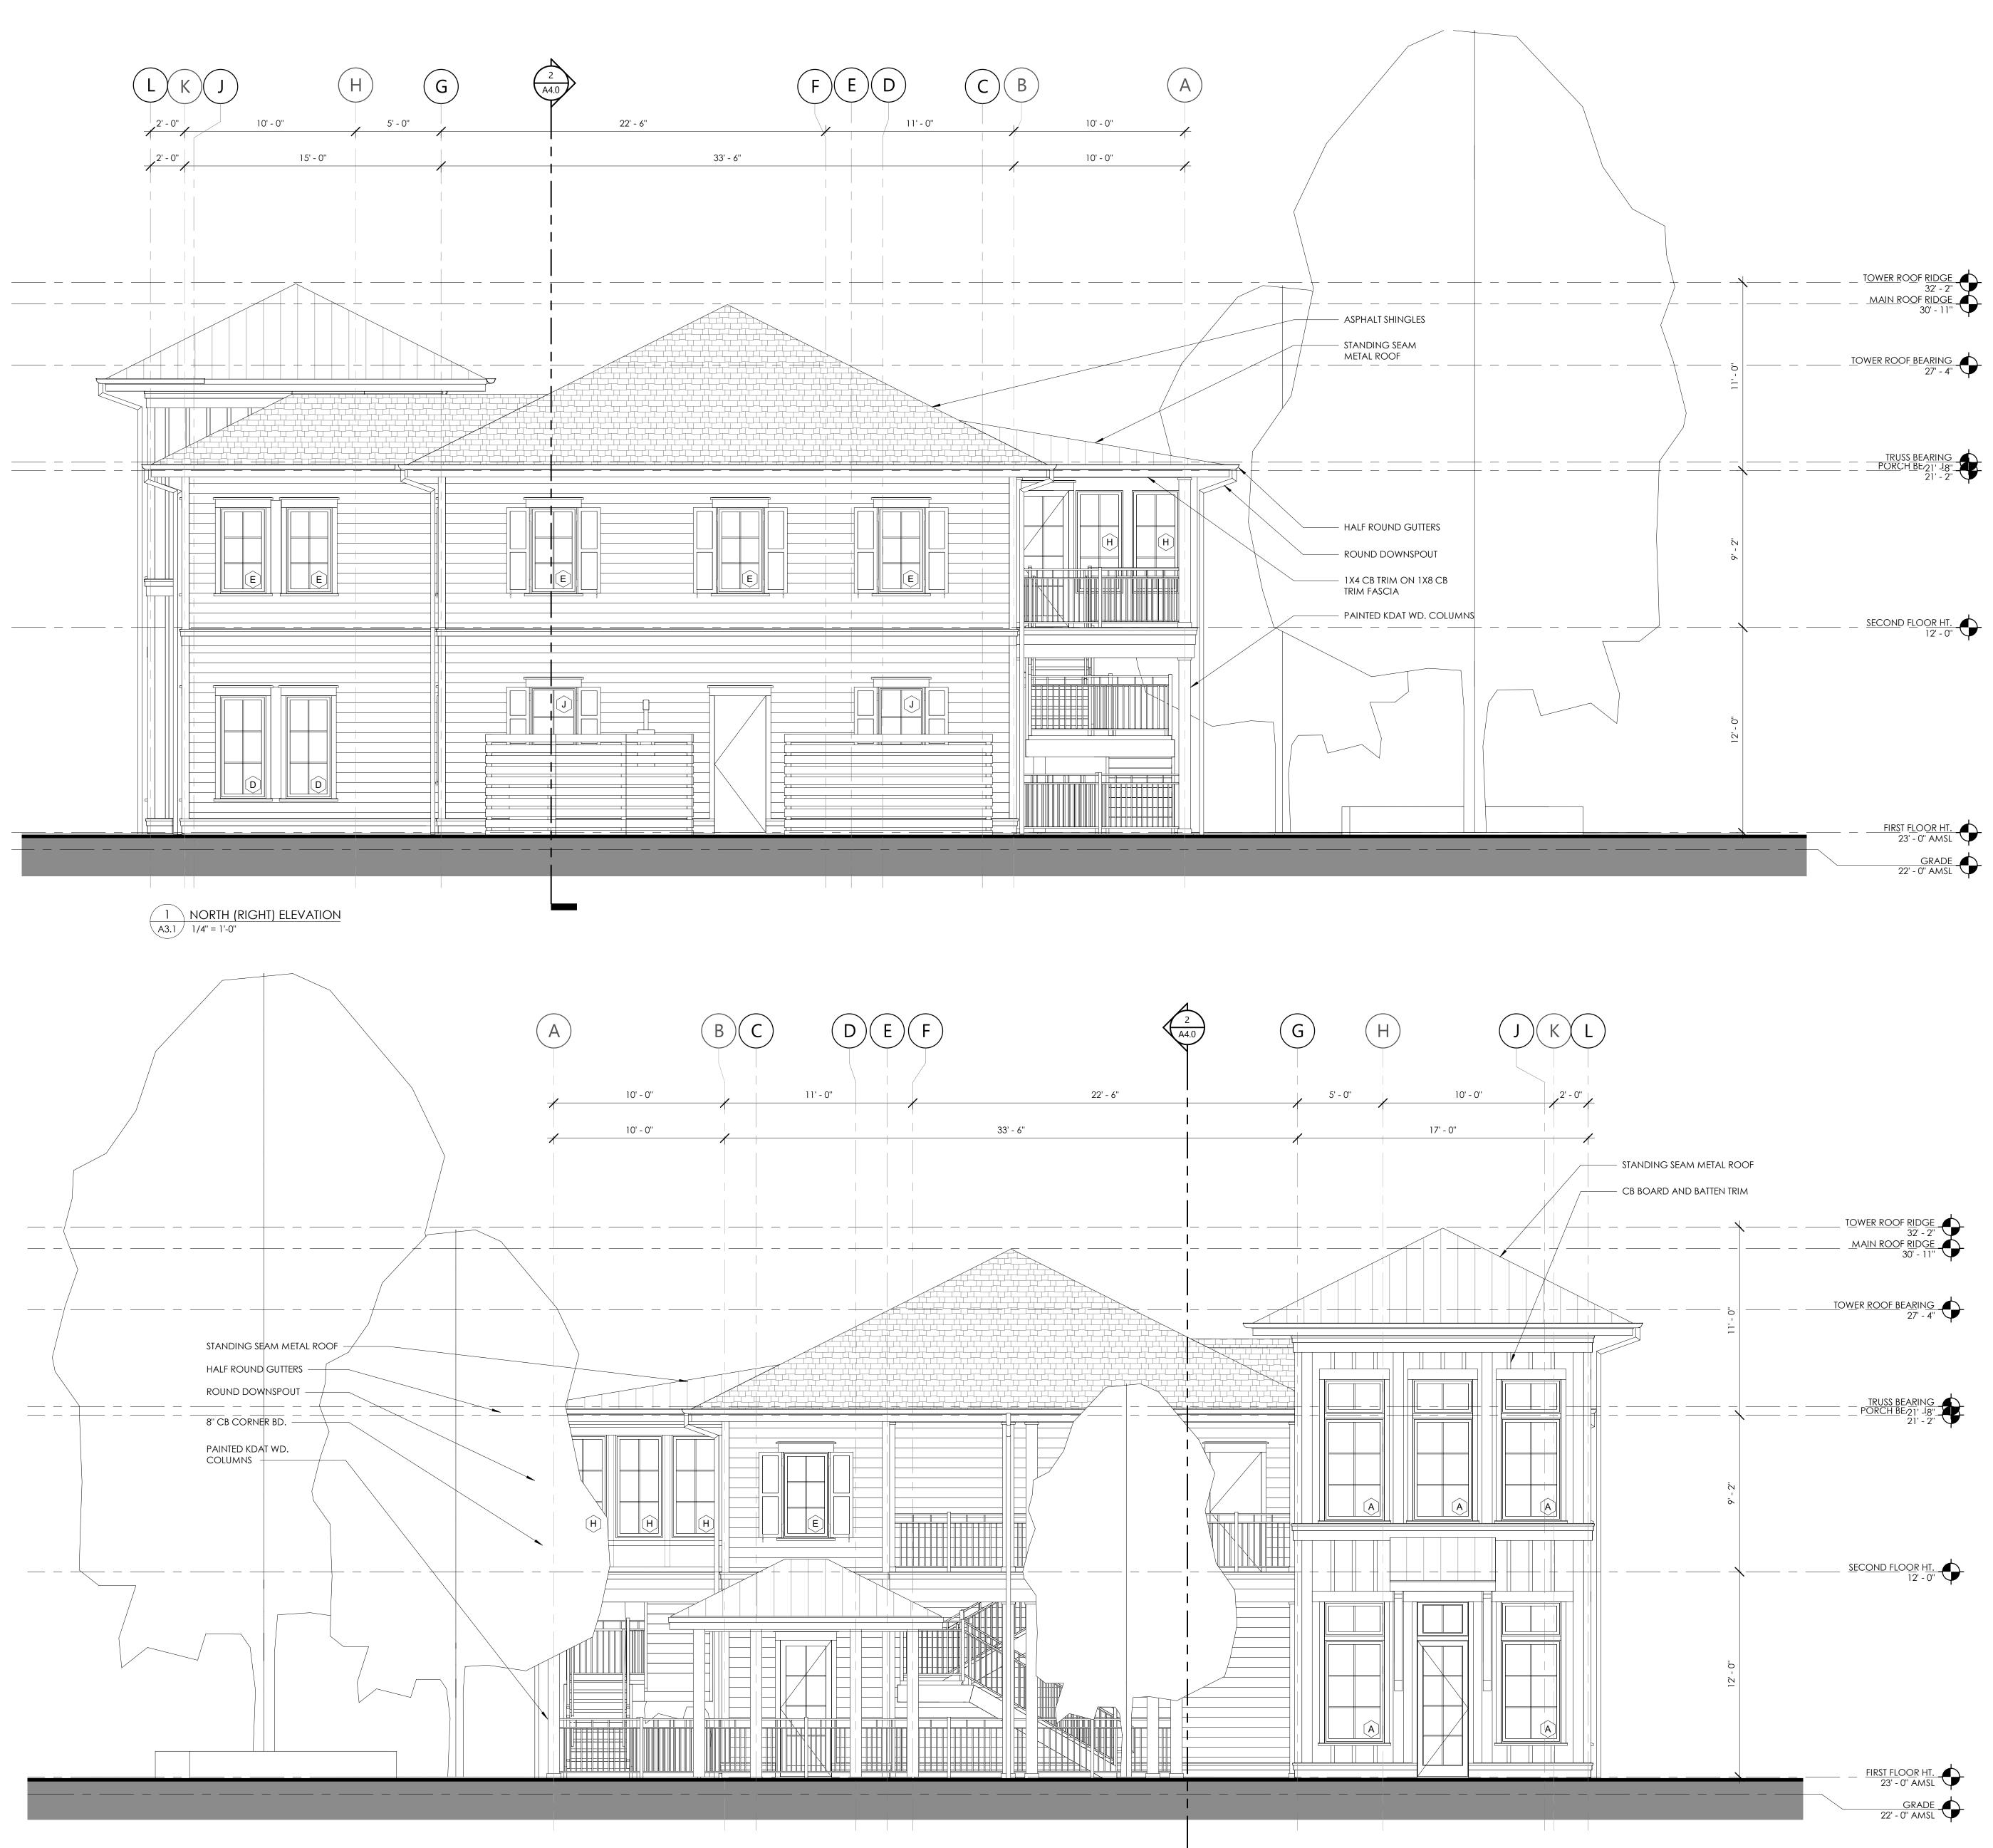
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### GENERAL EXTERIOR ELEVATION NOTES:

1. G.C. / SUB-CONTRACTORS SHALL BE RESPONSIBLE FOR ALL MEANS AND METHODS OF COMPLETING THE SCOPE OF WORK

## ABBREVIATIONS:

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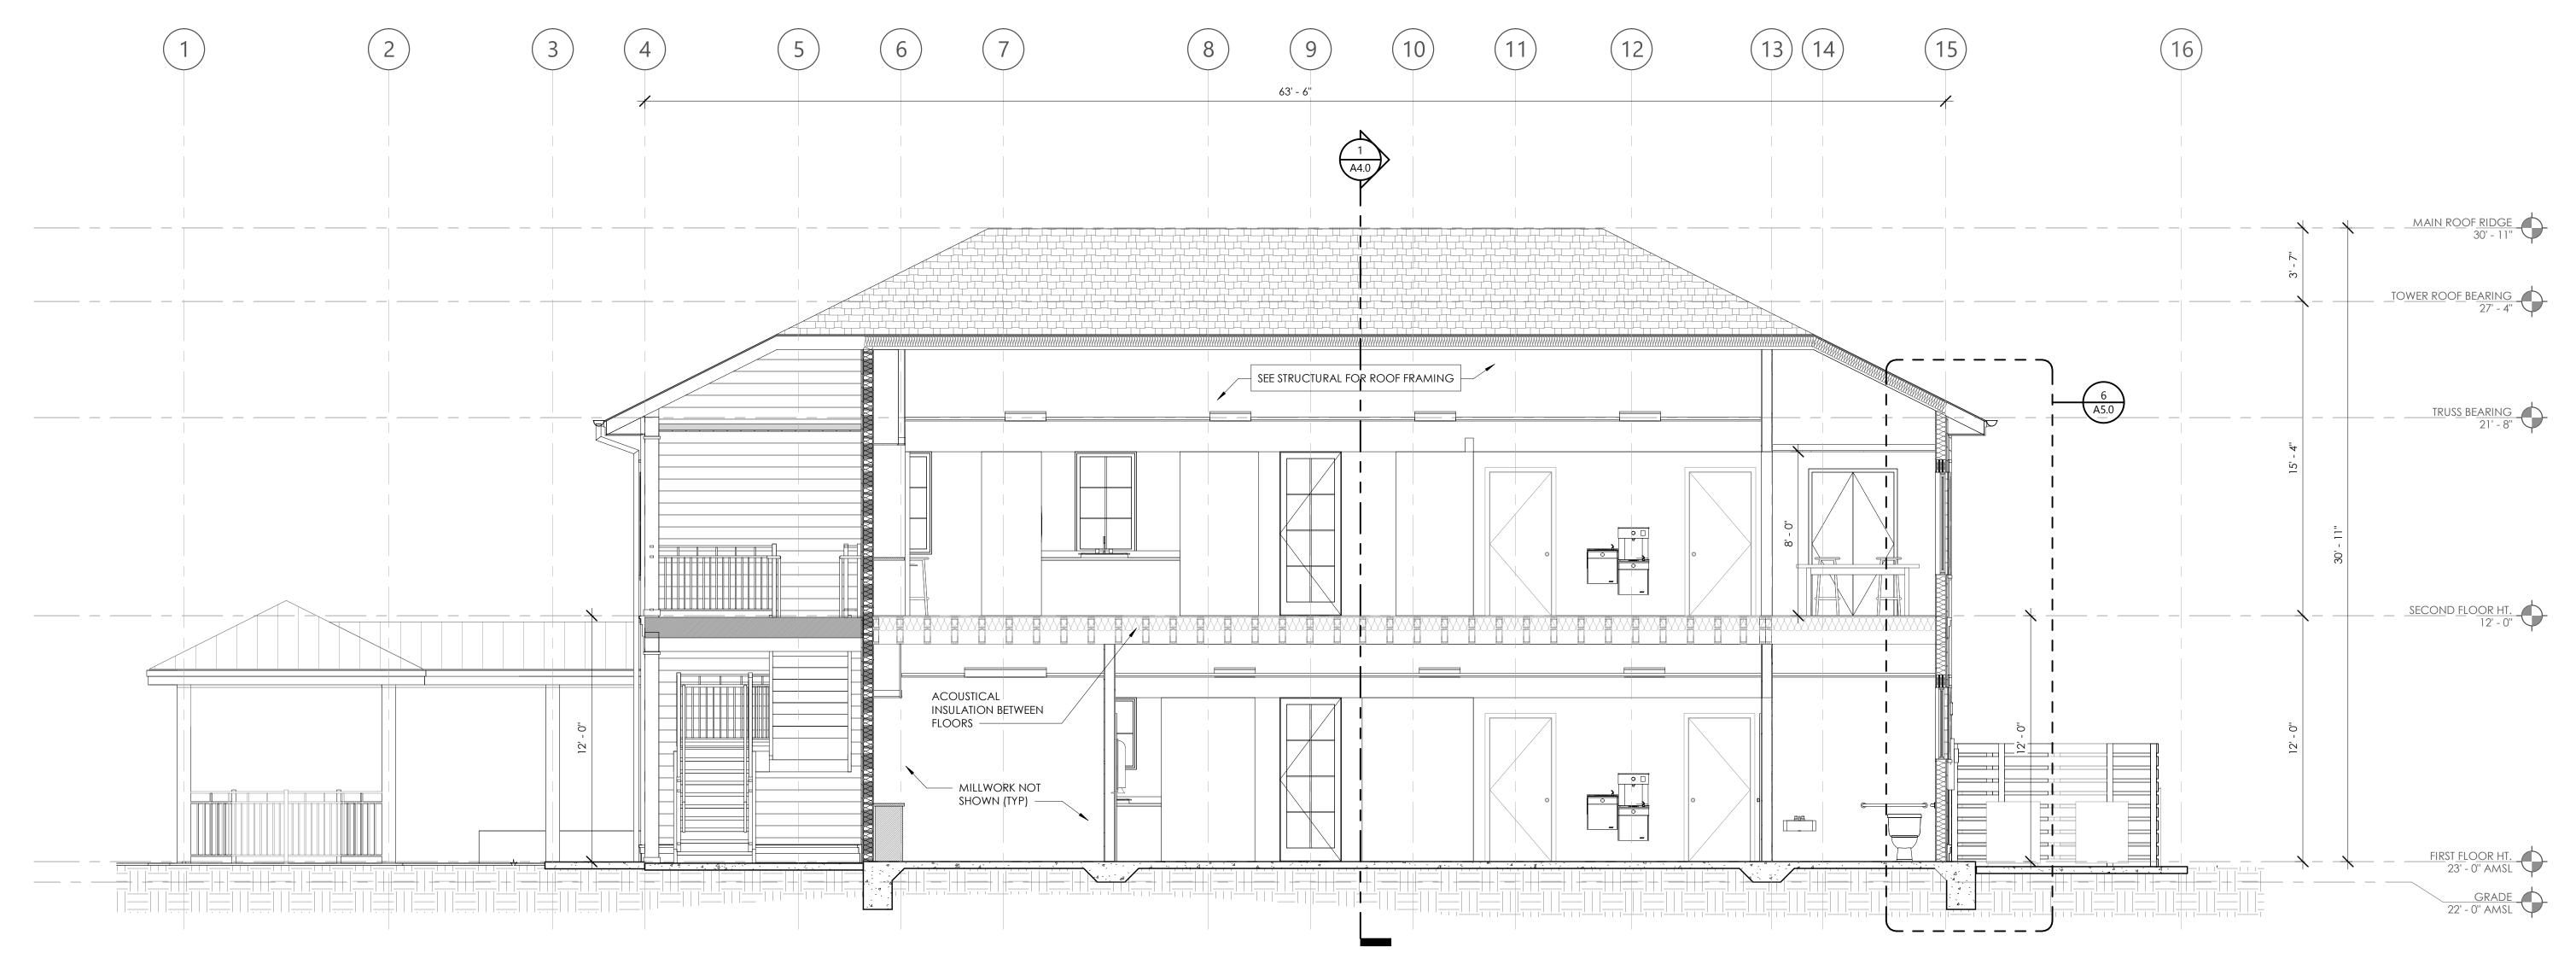







building elevations A3.1





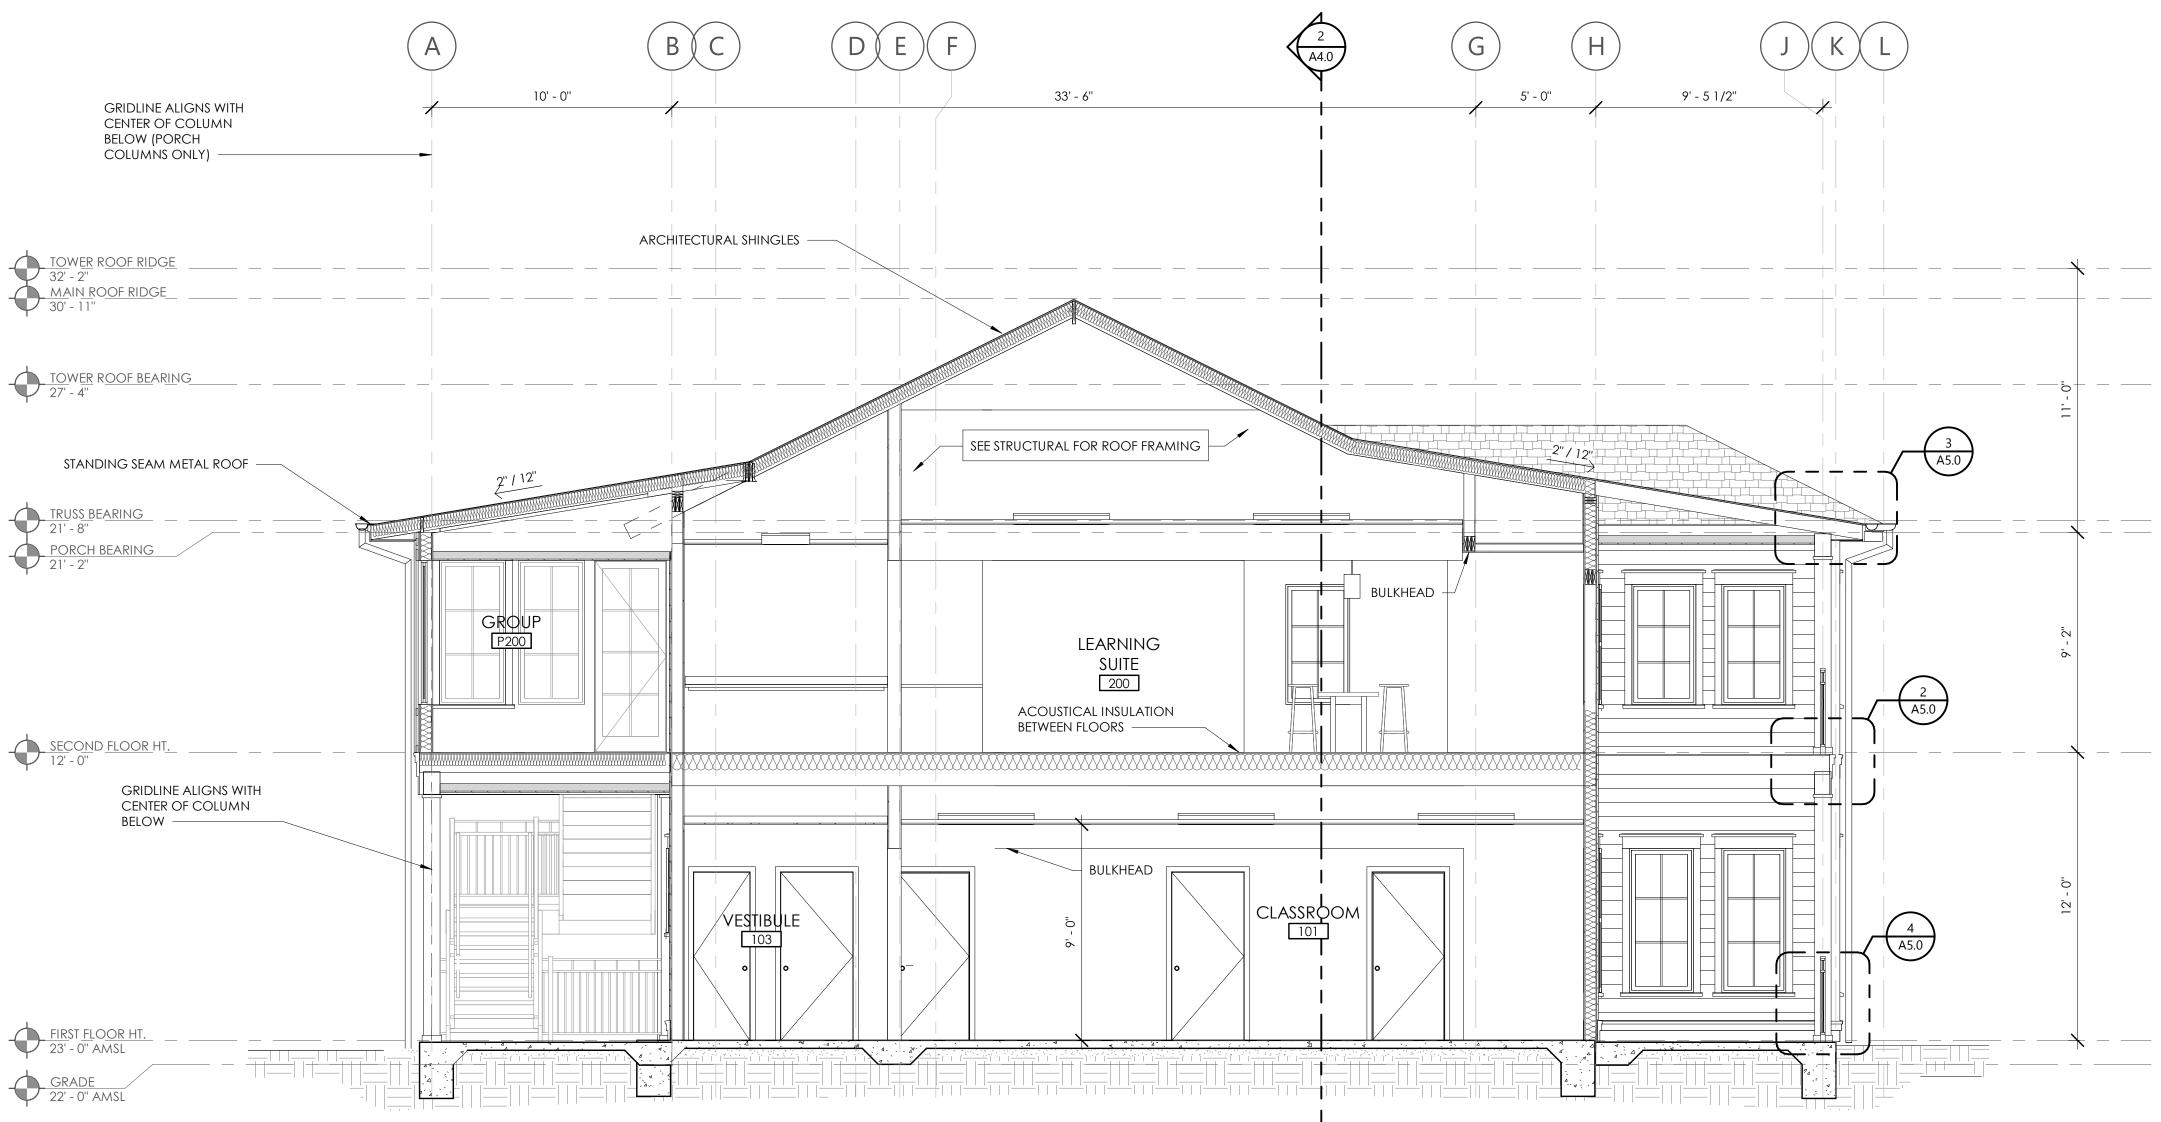



## BUILDING SECTION LOOKING 2 WEST A4.0 1/4" = 1'-0"

## BUILDING SECTION LOOKING 1 SOUTH A4.0 1/4" = 1'-0"



SHEET TITLE

NO. REV. DATE DESCRIPTION

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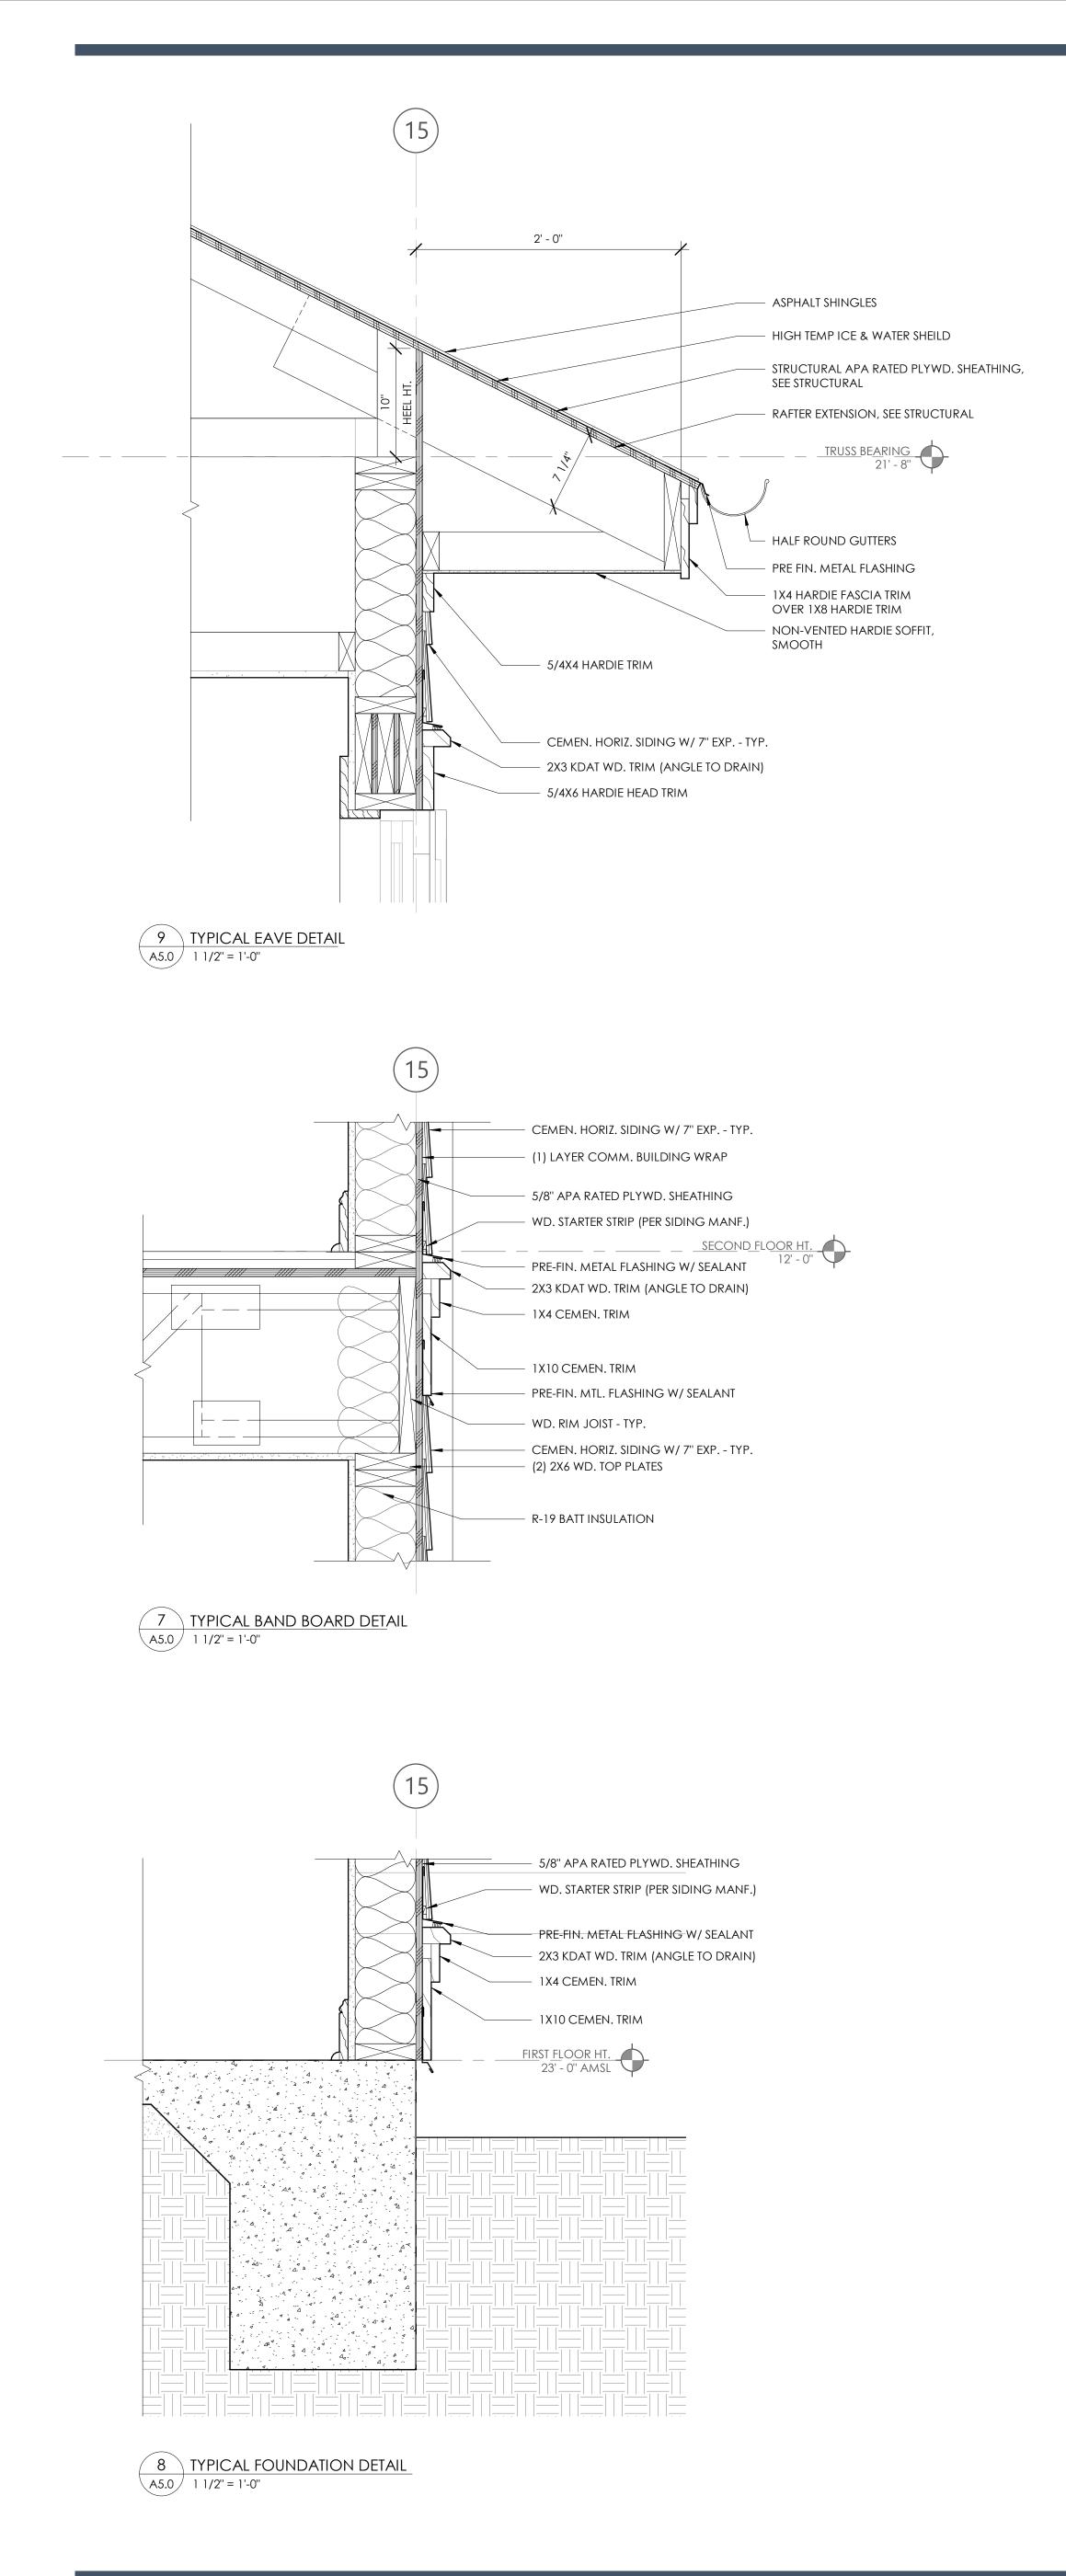
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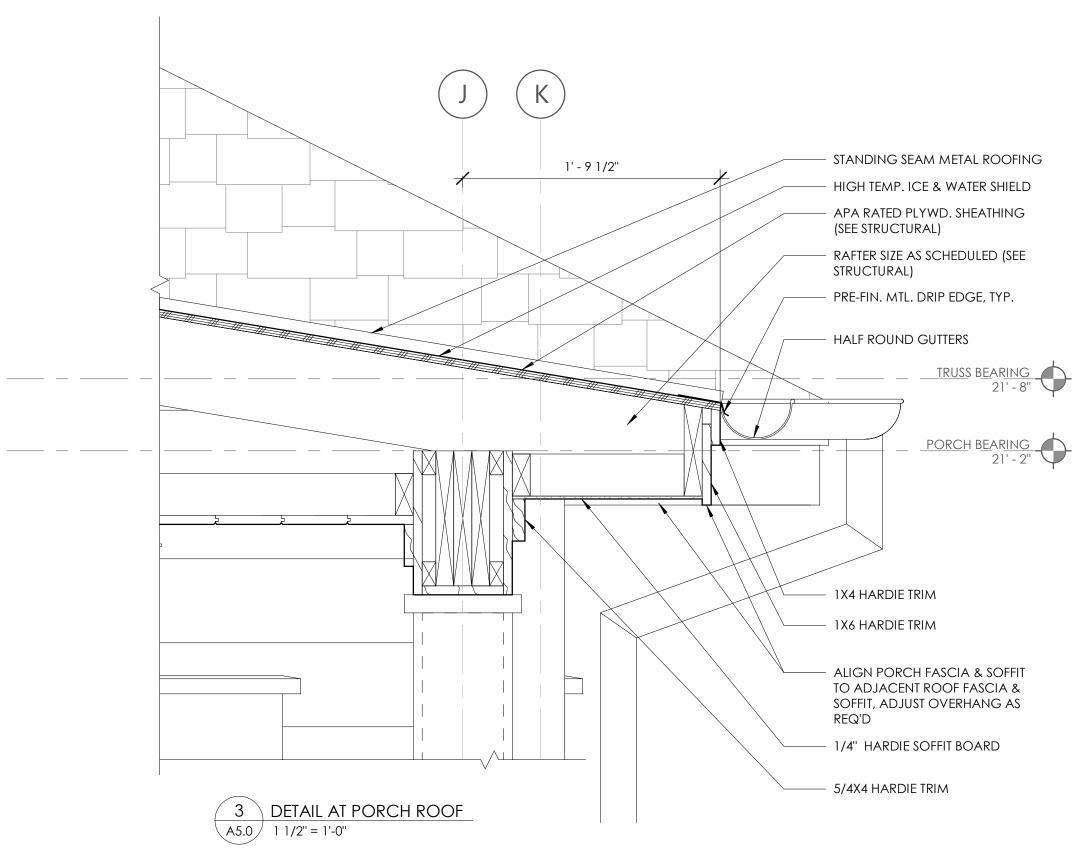
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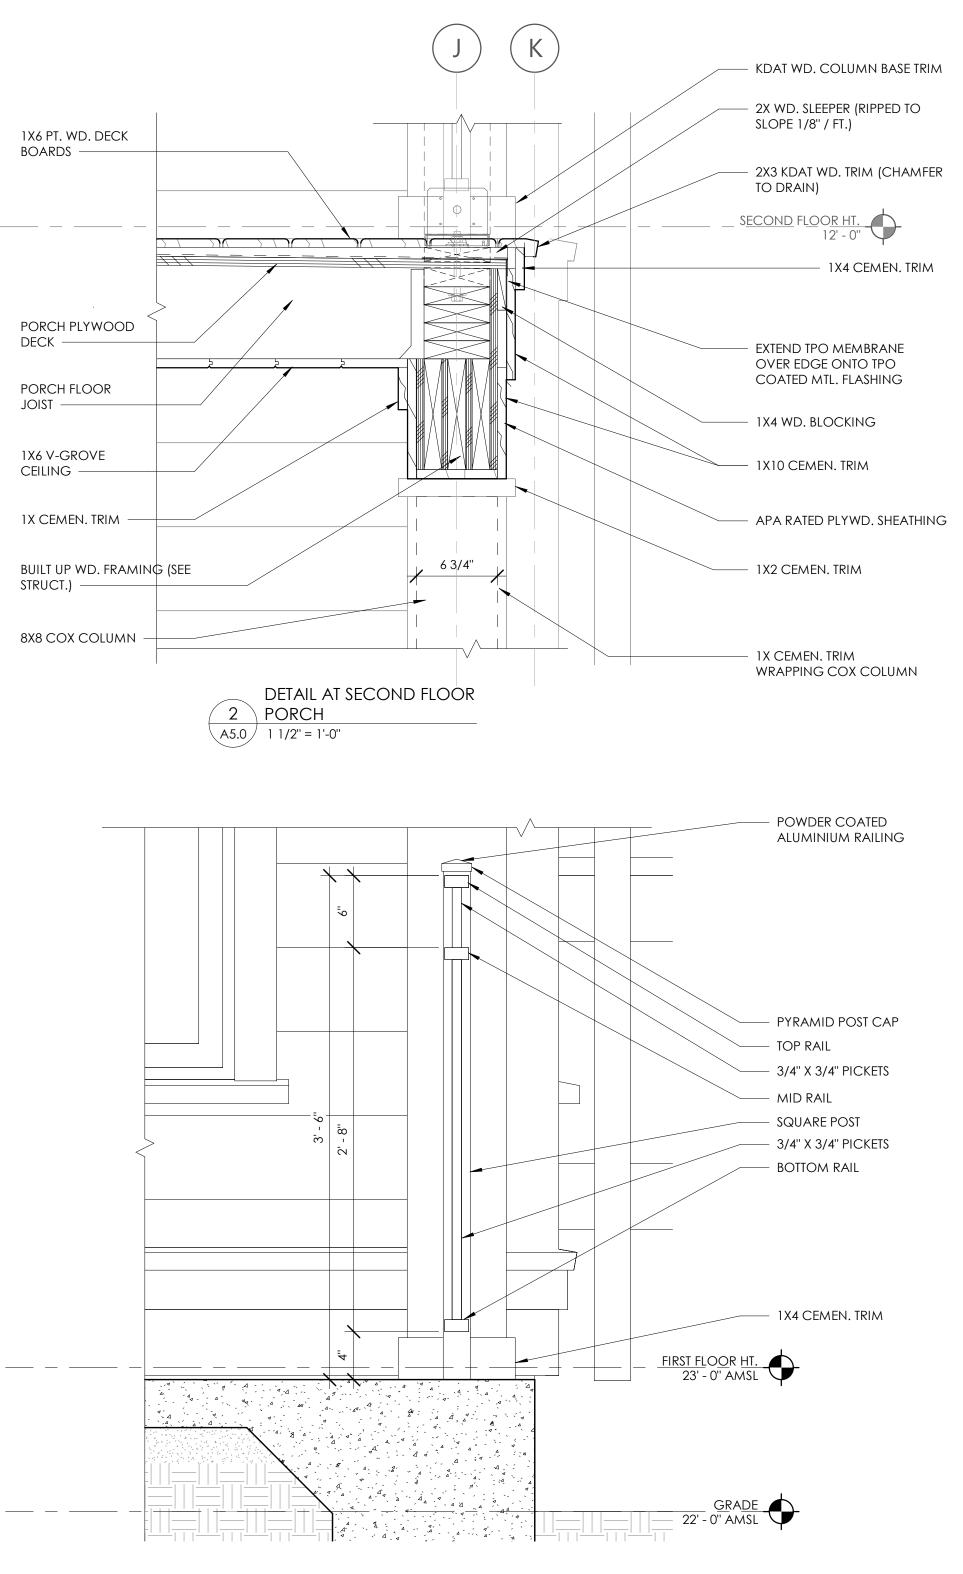
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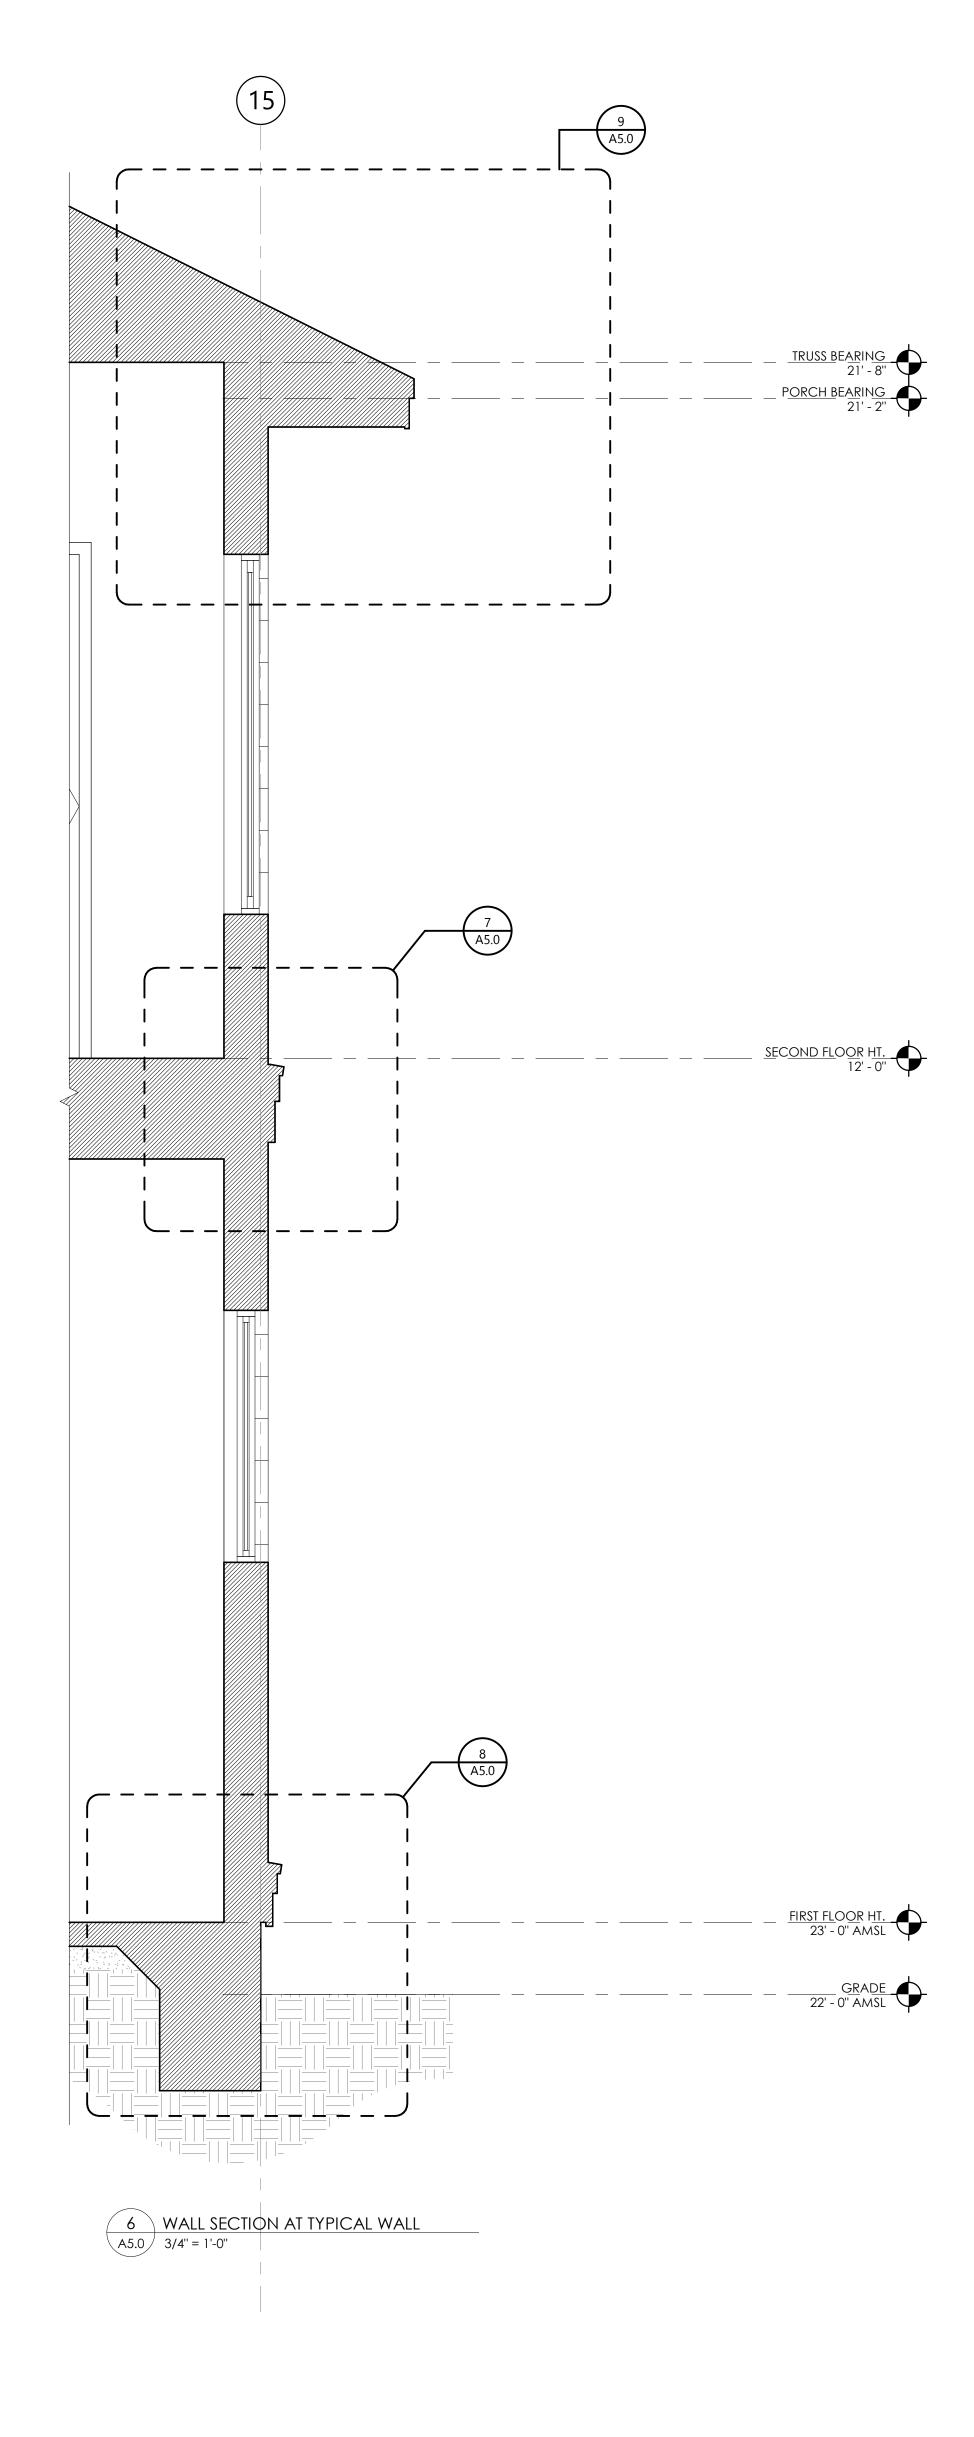







4 DETAIL AT FIRST FLOOR PORCH A5.0 1 1/2" = 1'-0"


21' - 8''





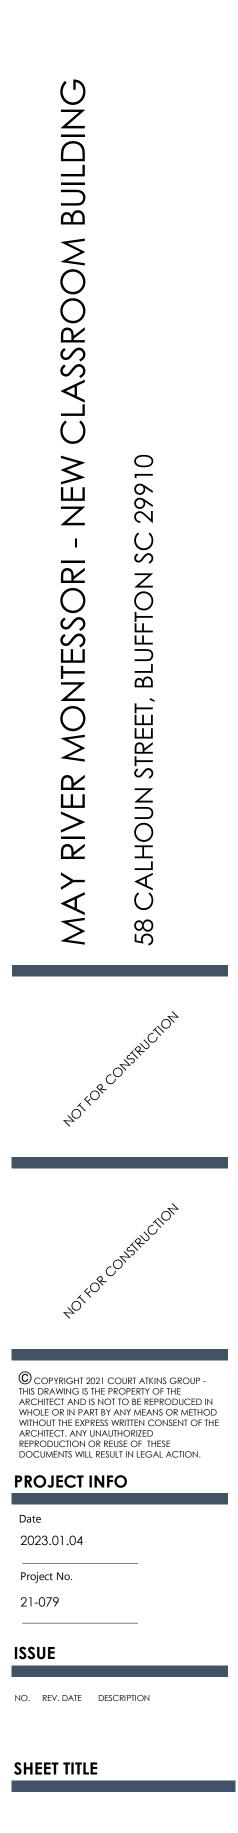

WALL SECTIONS AND DETAILS A5.0

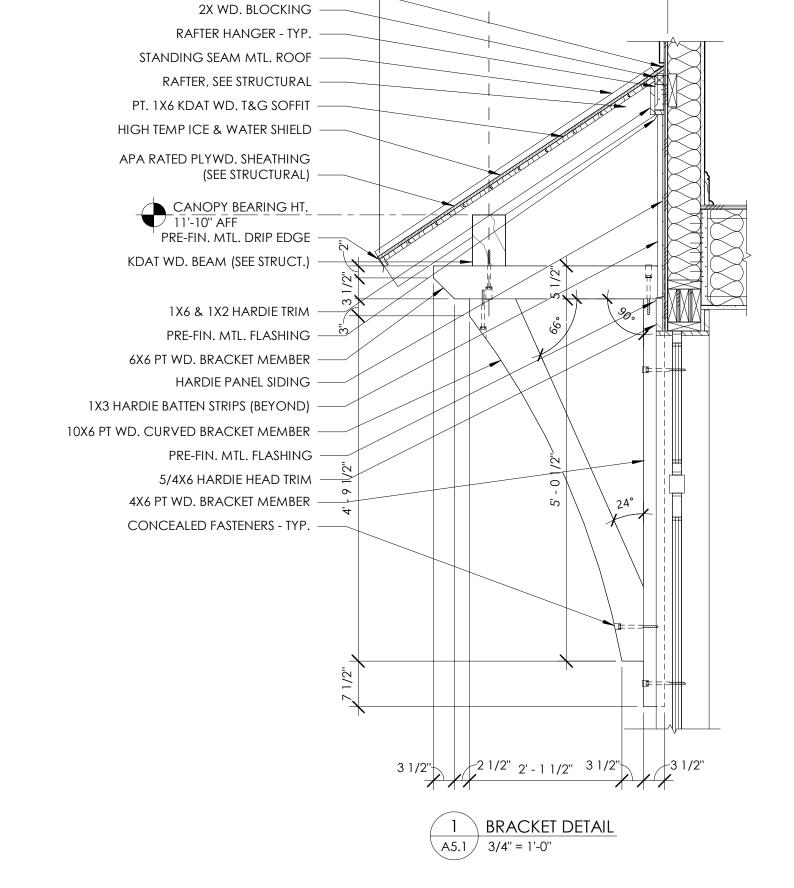

4' - 0''


1' - 6"

PRE-FIN. MTL. FLASHING -


2' - 6''

ALUMNIUM TOP RAIL




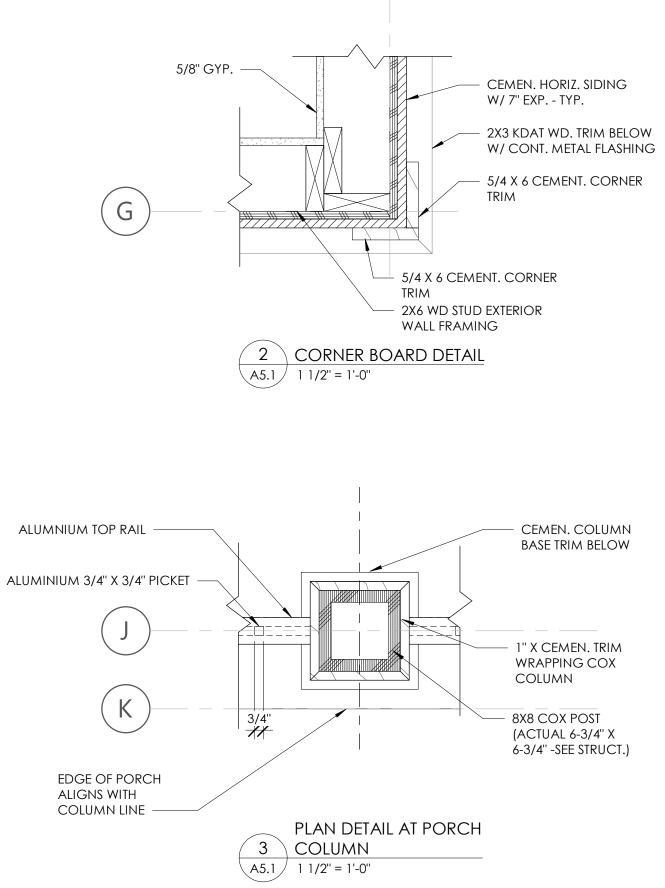


<sup>^</sup>15

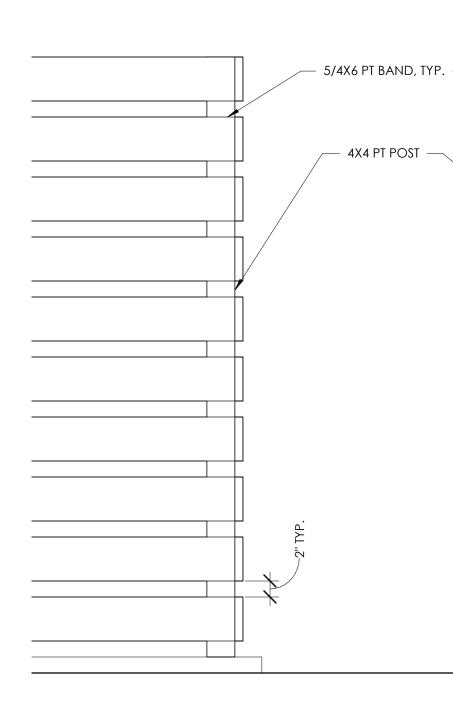

4 TYP. SERVICE YARD DETAIL A5.1 1" = 1'-0"

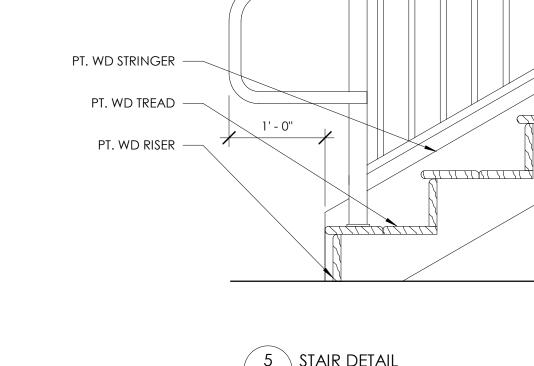

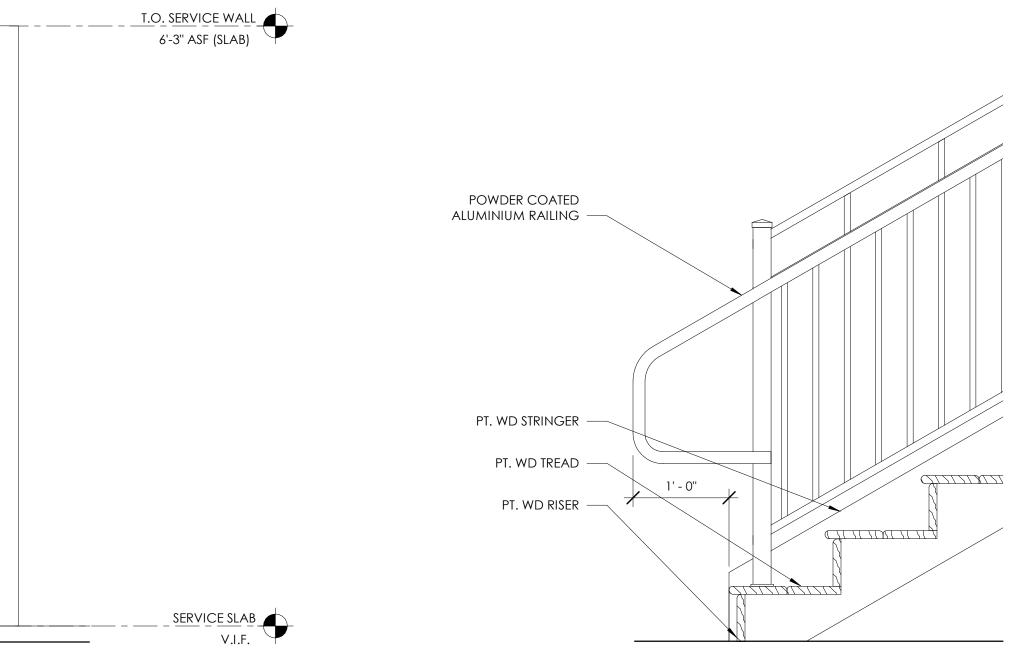


5 STAIR DETAIL A5.1 1" = 1'-0"





DETAILS

A5.1

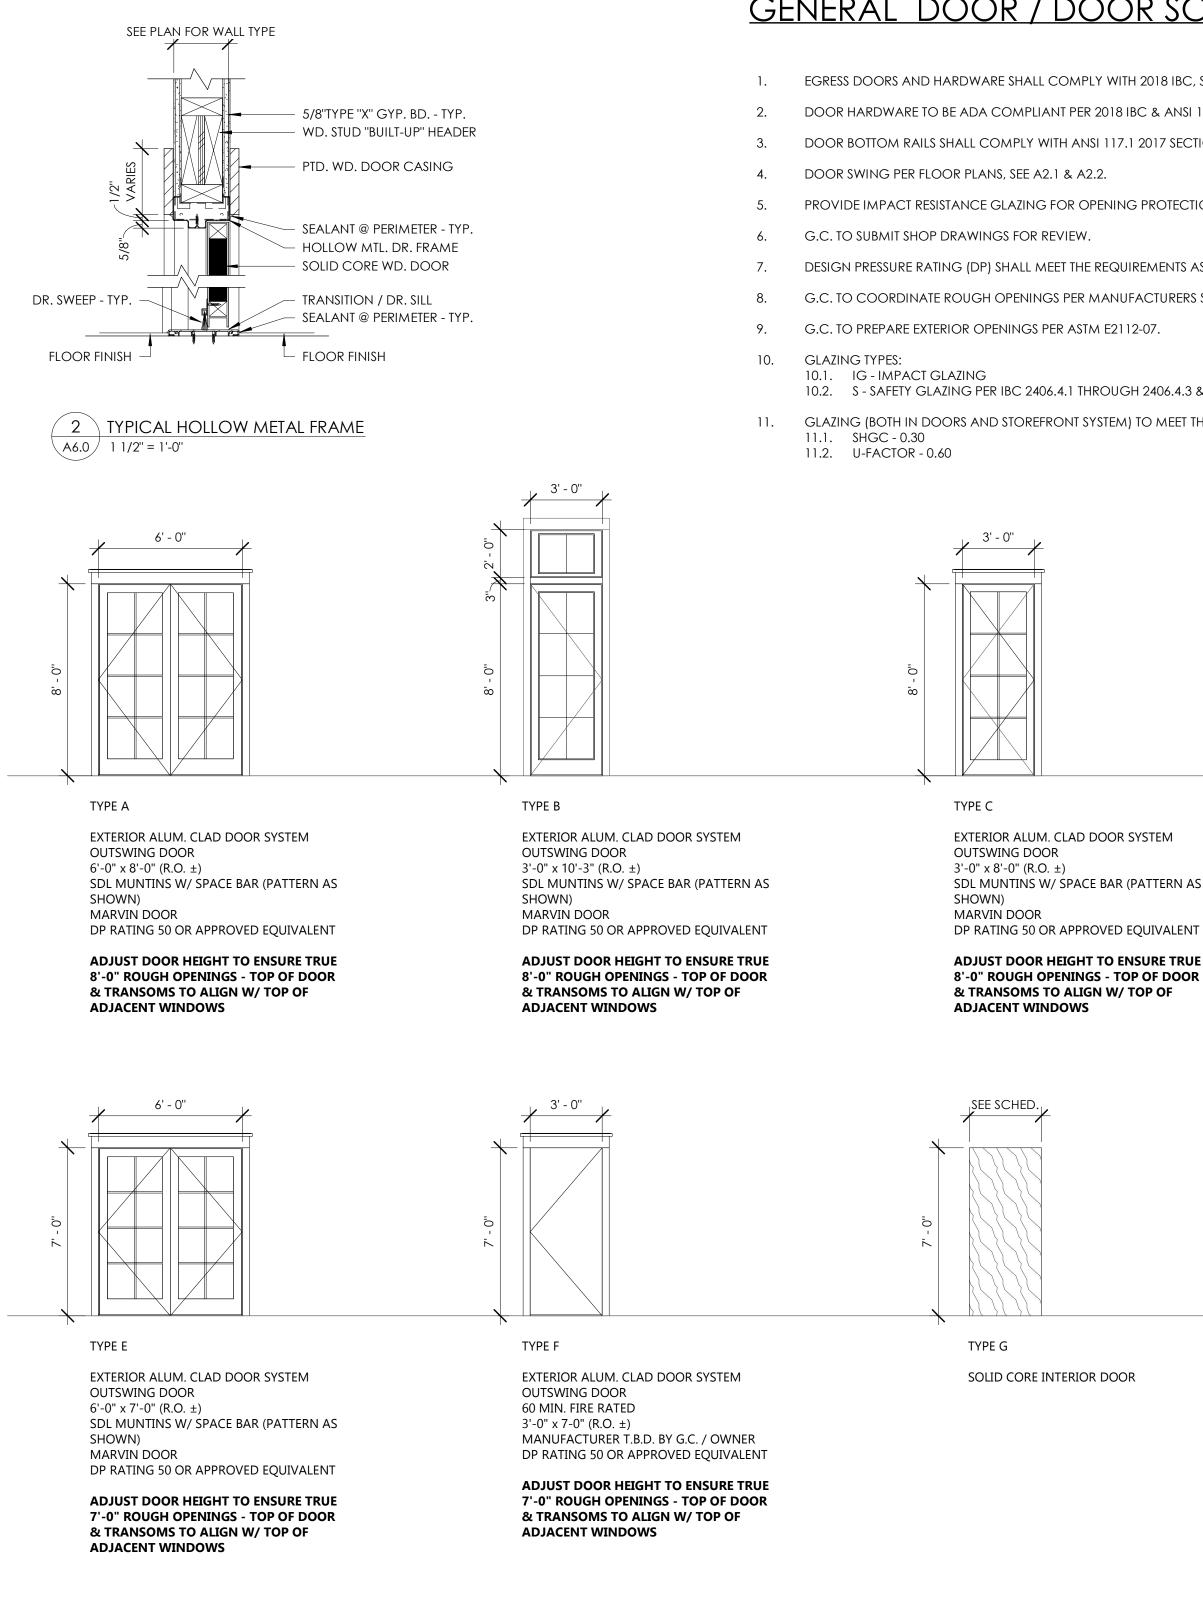

DOOR TYPES

1X KDAT WD. RAIL ——

IRON HINGES (BEYOND)
1X KDAT WD. STILE
1/2" X 1/4" KDAT WD. FLAT STOCK
1/4" KDAT WD. PANEL ———
1X KDAT WD. RAIL
5/4"X4 CEMEN. TRIM
IRON HINGES (BEYOND)

IRON SHUTTER DOG -

1X KDAT WD. RAIL —

## WINDOW NOTES:

- 1. WINDOWS TO BE MARVIN, ALUMINUM CLAD 2. GLAZING VALUES SHALL MEET THE FOLLOWING MINIMUM REQUIREMENTS: U-VALUE SOLAR HEAT GAIN COEFICIENT 0.30
- 4. ALL GAZING IN HAZARDOUS LOCATIONS SHALL UTILIZE SAFETY GLAZING
- 5. T = TEMPERED

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## ATTACHMENT 4

## <u>GENERAL DOOR / DOOR SCHEDULE, STOREFRONT & WINDOW NOTES:</u>

1. EGRESS DOORS AND HARDWARE SHALL COMPLY WITH 2018 IBC, SECTION 1010.1.9 WHEN BUILDING IS OCCUPIED.

DOOR HARDWARE TO BE ADA COMPLIANT PER 2018 IBC & ANSI 117.1 2017.

DOOR BOTTOM RAILS SHALL COMPLY WITH ANSI 117.1 2017 SECTION 404.2.9 (10" MIN. SMOOTH BOTTOM RAIL)


5. PROVIDE IMPACT RESISTANCE GLAZING FOR OPENING PROTECTION AT ALL WINDOWS AND DOORS IN ACCORDANCE WITH 2018 IBC, SECTION 1609.2.

7. DESIGN PRESSURE RATING (DP) SHALL MEET THE REQUIREMENTS AS NOTED ON THE STRUCTURAL DRAWINGS AND MEET ALL APPLICABLE BUILDING CODE REQUIREMENTS.

8. G.C. TO COORDINATE ROUGH OPENINGS PER MANUFACTURERS SPECIFICATIONS.

10.2. S - SAFETY GLAZING PER IBC 2406.4.1 THROUGH 2406.4.3 & TABLE 2406.2 (1) OR TABLE 2406.2 (2) 11. GLAZING (BOTH IN DOORS AND STOREFRONT SYSTEM) TO MEET THE FOLLOWING CRITERIA:




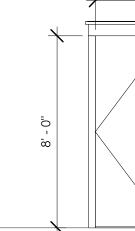

EXTERIOR ALUM. CLAD DOOR SYSTEM OUTSWING DOOR 3'-0" x 8'-0" (R.O. ±)

SDL MUNTINS W/ SPACE BAR (PATTERN AS MARVIN DOOR


#### ADJUST DOOR HEIGHT TO ENSURE TRUE 8'-0" ROUGH OPENINGS - TOP OF DOOR & TRANSOMS TO ALIGN W/ TOP OF ADJACENT WINDOWS

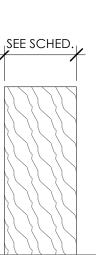


SOLID CORE INTERIOR DOOR

TYPE D EXTERIOR HM PANEL DOOR OUTSWING DOOR 3'-0" x 8'-0" (R.O. ±) MANUFACTURER T.B.D. BY G.C. / OWNER DP RATING 50 OR APPROVED EQUIVALENT

ADJUST DOOR HEIGHT TO ENSURE TRUE 8'-0" ROUGH OPENINGS - TOP OF DOOR & TRANSOMS TO ALIGN W/ TOP OF ADJACENT WINDOWS

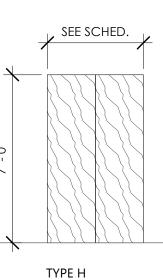


SOLID CORE INTERIOR DOUBLE DOOR

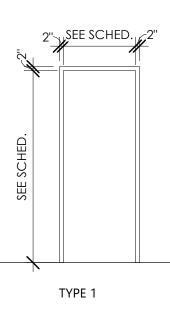

PAINTED HOLLOW METAL FRAME

HOLLOW METAL FRAME TYPES

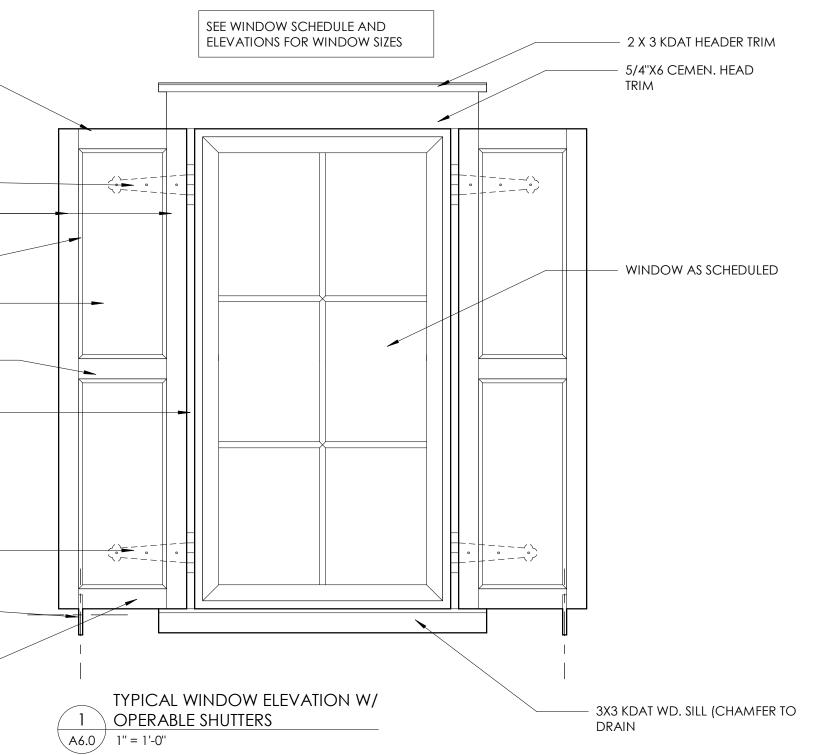

Type Mark	
A	FIXED WINDC
В	FIXED WINDC
С	FIXED WINDC
D	FIXED WINDC
E	FIXED WINDC
G	FIXED WINDC
Н	FIXED WINDC
J	FIXED WINDC
К	FIXED WINDC

0.60

3. DP 50 RATING OR APPROVED EQUIVALENT BY G.C./STRUCTURAL ENGINEER AND TO COMPLY WITH ALL APPLICABLE BUILDING CODES AND REGULATORY REQUIREMENTS.

					DOC	RSC	HEDU	LE							
				DOOR FRAME						HAR	DWAR	-			
DOOR NO.	ROOM	TYPE	WIDTH	HEIGHT	MATERIAL	FINISH	MATERIAL	FINISH	JAMB	HEAD	LOCK	CLOSER	STOP PANIC	MISC.	COMMENT
E01	FRONT PORCH	А	6' - 0''	8' - 0''	ALUM. CLAD / GLASS		ALUM. CLAD								
E02	MARKET	В	3' - 0''	10' - 3''	ALUM. CLAD / GLASS		ALUM. CLAD								
E03	SIDE STAIR PORCH	С	3' - 0''	8' - 0''	ALUM. CLAD / GLASS		HM RATED	PREFINISHED							60 MIN.
E04	ENTRY VESTIBULE	С	3' - 0''	8' - 0''	ALUM. CLAD / GLASS		ALUM. CLAD								
E05	ENTRY VESTIBULE	С	3' - 0''	8' - 0''	ALUM. CLAD / GLASS		ALUM. CLAD								
E06	PLAY PORCH	С	3' - 0''	8' - 0''	ALUM. CLAD / GLASS		ALUM. CLAD								
E07	RISER	D	3' - 0''	8' - 0''	INSULATED METAL	PAINTED		PREFINISHED							
E08	LEARNING PORCH	E	6' - 0''	7' - 0''	ALUM. CLAD / GLASS		ALUM. CLAD								
E09	LEARNING SUITE	F	3' - 0''	7' - 0''	INSULATED METAL	PAINTED	HM RATED	PREFINISHED							60 MIN.
E10	GROUP	С	3' - 0''	8' - 0''	ALUM. CLAD / GLASS		ALUM. CLAD								
100A	ENTRY VESTIBULE	G	3' - 0''	7' - 0''	SOLID CORE WOOD	PAINTED	WOOD	PAINTED							
104A	STORAGE	G	2' - 4''	7' - 0''	SOLID CORE WOOD	PAINTED	WOOD	PAINTED							
105A	JAN	G	3' - 0''	7' - 0''	SOLID CORE WOOD	PAINTED	WOOD	PAINTED							
106A	GIRLS	G	3' - 0''	7' - 0''	SOLID CORE WOOD	PAINTED	WOOD	PAINTED							
107A	BOYS	G	3' - 0''	7' - 0''	SOLID CORE WOOD	PAINTED	WOOD	PAINTED							
113A	OFFICE	G	3' - 0''	7' - 0''	SOLID CORE WOOD	PAINTED	WOOD	PAINTED							
114A	OFFICE	G	3' - 0''	7' - 0''	SOLID CORE WOOD	PAINTED	WOOD	PAINTED							
115A	STORAGE	G	3' - 0''	7' - 0''	SOLID CORE WOOD	PAINTED	WOOD	PAINTED							
200A	GROUP	С	3' - 0''	8' - 0''	ALUM. CLAD / GLASS		ALUM. CLAD								
200B	WORK	G	3' - 0''	7' - 0''	SOLID CORE WOOD	PAINTED	WOOD	PAINTED							
200C	ELEC	G	3' - 0''	7' - 0''	SOLID CORE WOOD	PAINTED	WOOD	PAINTED							
200D	ADULT	G	3' - 0''	7' - 0''	SOLID CORE WOOD	PAINTED	WOOD	PAINTED							
203A	GIRLS	G	3' - 0''	7' - 0''	SOLID CORE WOOD	PAINTED	WOOD	PAINTED							
204A	BOYS	G	3' - 0''	7' - 0''	SOLID CORE WOOD	PAINTED	WOOD	PAINTED							
207A	STORAGE	Н	4' - 0''	7' - 0''	SOLID CORE WOOD	PAINTED	WOOD	PAINTED							

## DOOR NOTES:

1. DP 50 RATING OR APPROVED EQUIVALENT BY G.C./STRUCT. ENGINEER AND TO COMPLY WITH ALL APPLICABLE BUILDING CODES AND REG. REQUIREMENTS.

3. LOCKSET TYPE, STYLE & FINISH MANUFACTURER (T.B.D.)

4. ALL DOOR HANDLES SHALL BE ADA COMPLIANT & MOUNTED 36" O.C. A.F.F. U.O.N.

5. ALL GAZING IN HAZARDOUS LOCATIONS SHALL UTILIZE SAFETY GLAZING


6. T = TEMPERED


2. HINGE TYPE, STYLE & FINISH - MANUFACTURER (T.B.D.)

7. TOP OF DOOR & TRANSOMS TO ALIGN W/ TOP OF ADJACENT WINDOWS


WIND	DOW SC	CHEDU	LE	
		R.O. +		
Window Type	Width	Height	Height	Comments
ow w/ 2'-0" transom	3' - 6''	8' - 3''	<varies></varies>	
W	3' - 6''	6' - 0''	8' - 0''	
WO	3' - 6''	5' - 0''	7' - 0''	
WO	2' - 8''	6' - 0''	8' - 0''	
WO	2' - 8''	5' - 0''	<varies></varies>	
WO	3' - 0''	3' - 6''	8' - 0''	
WO	2' - 9''	6' - 0''	8' - 0''	
W	2' - 8''	3' - 6''	8' - 6''	
WOW	3' - 0''	5' - 0''	8' - 0''	



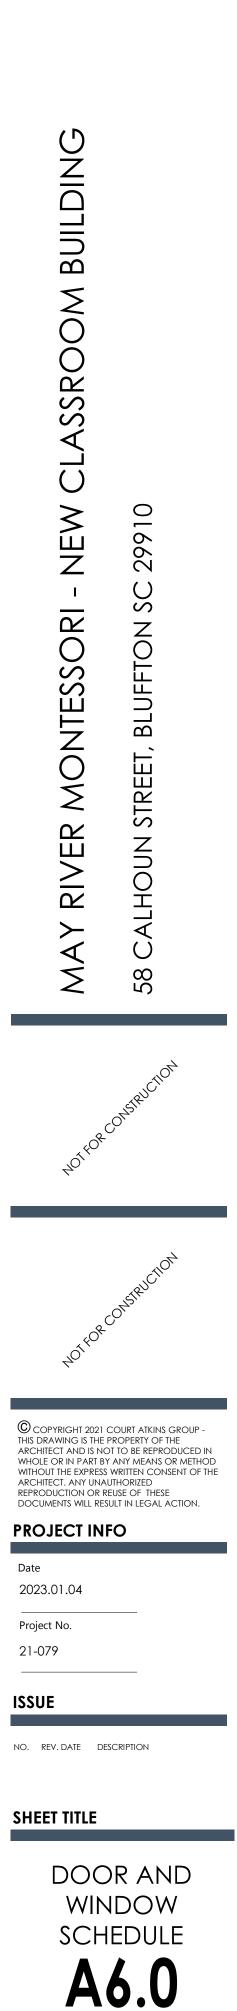

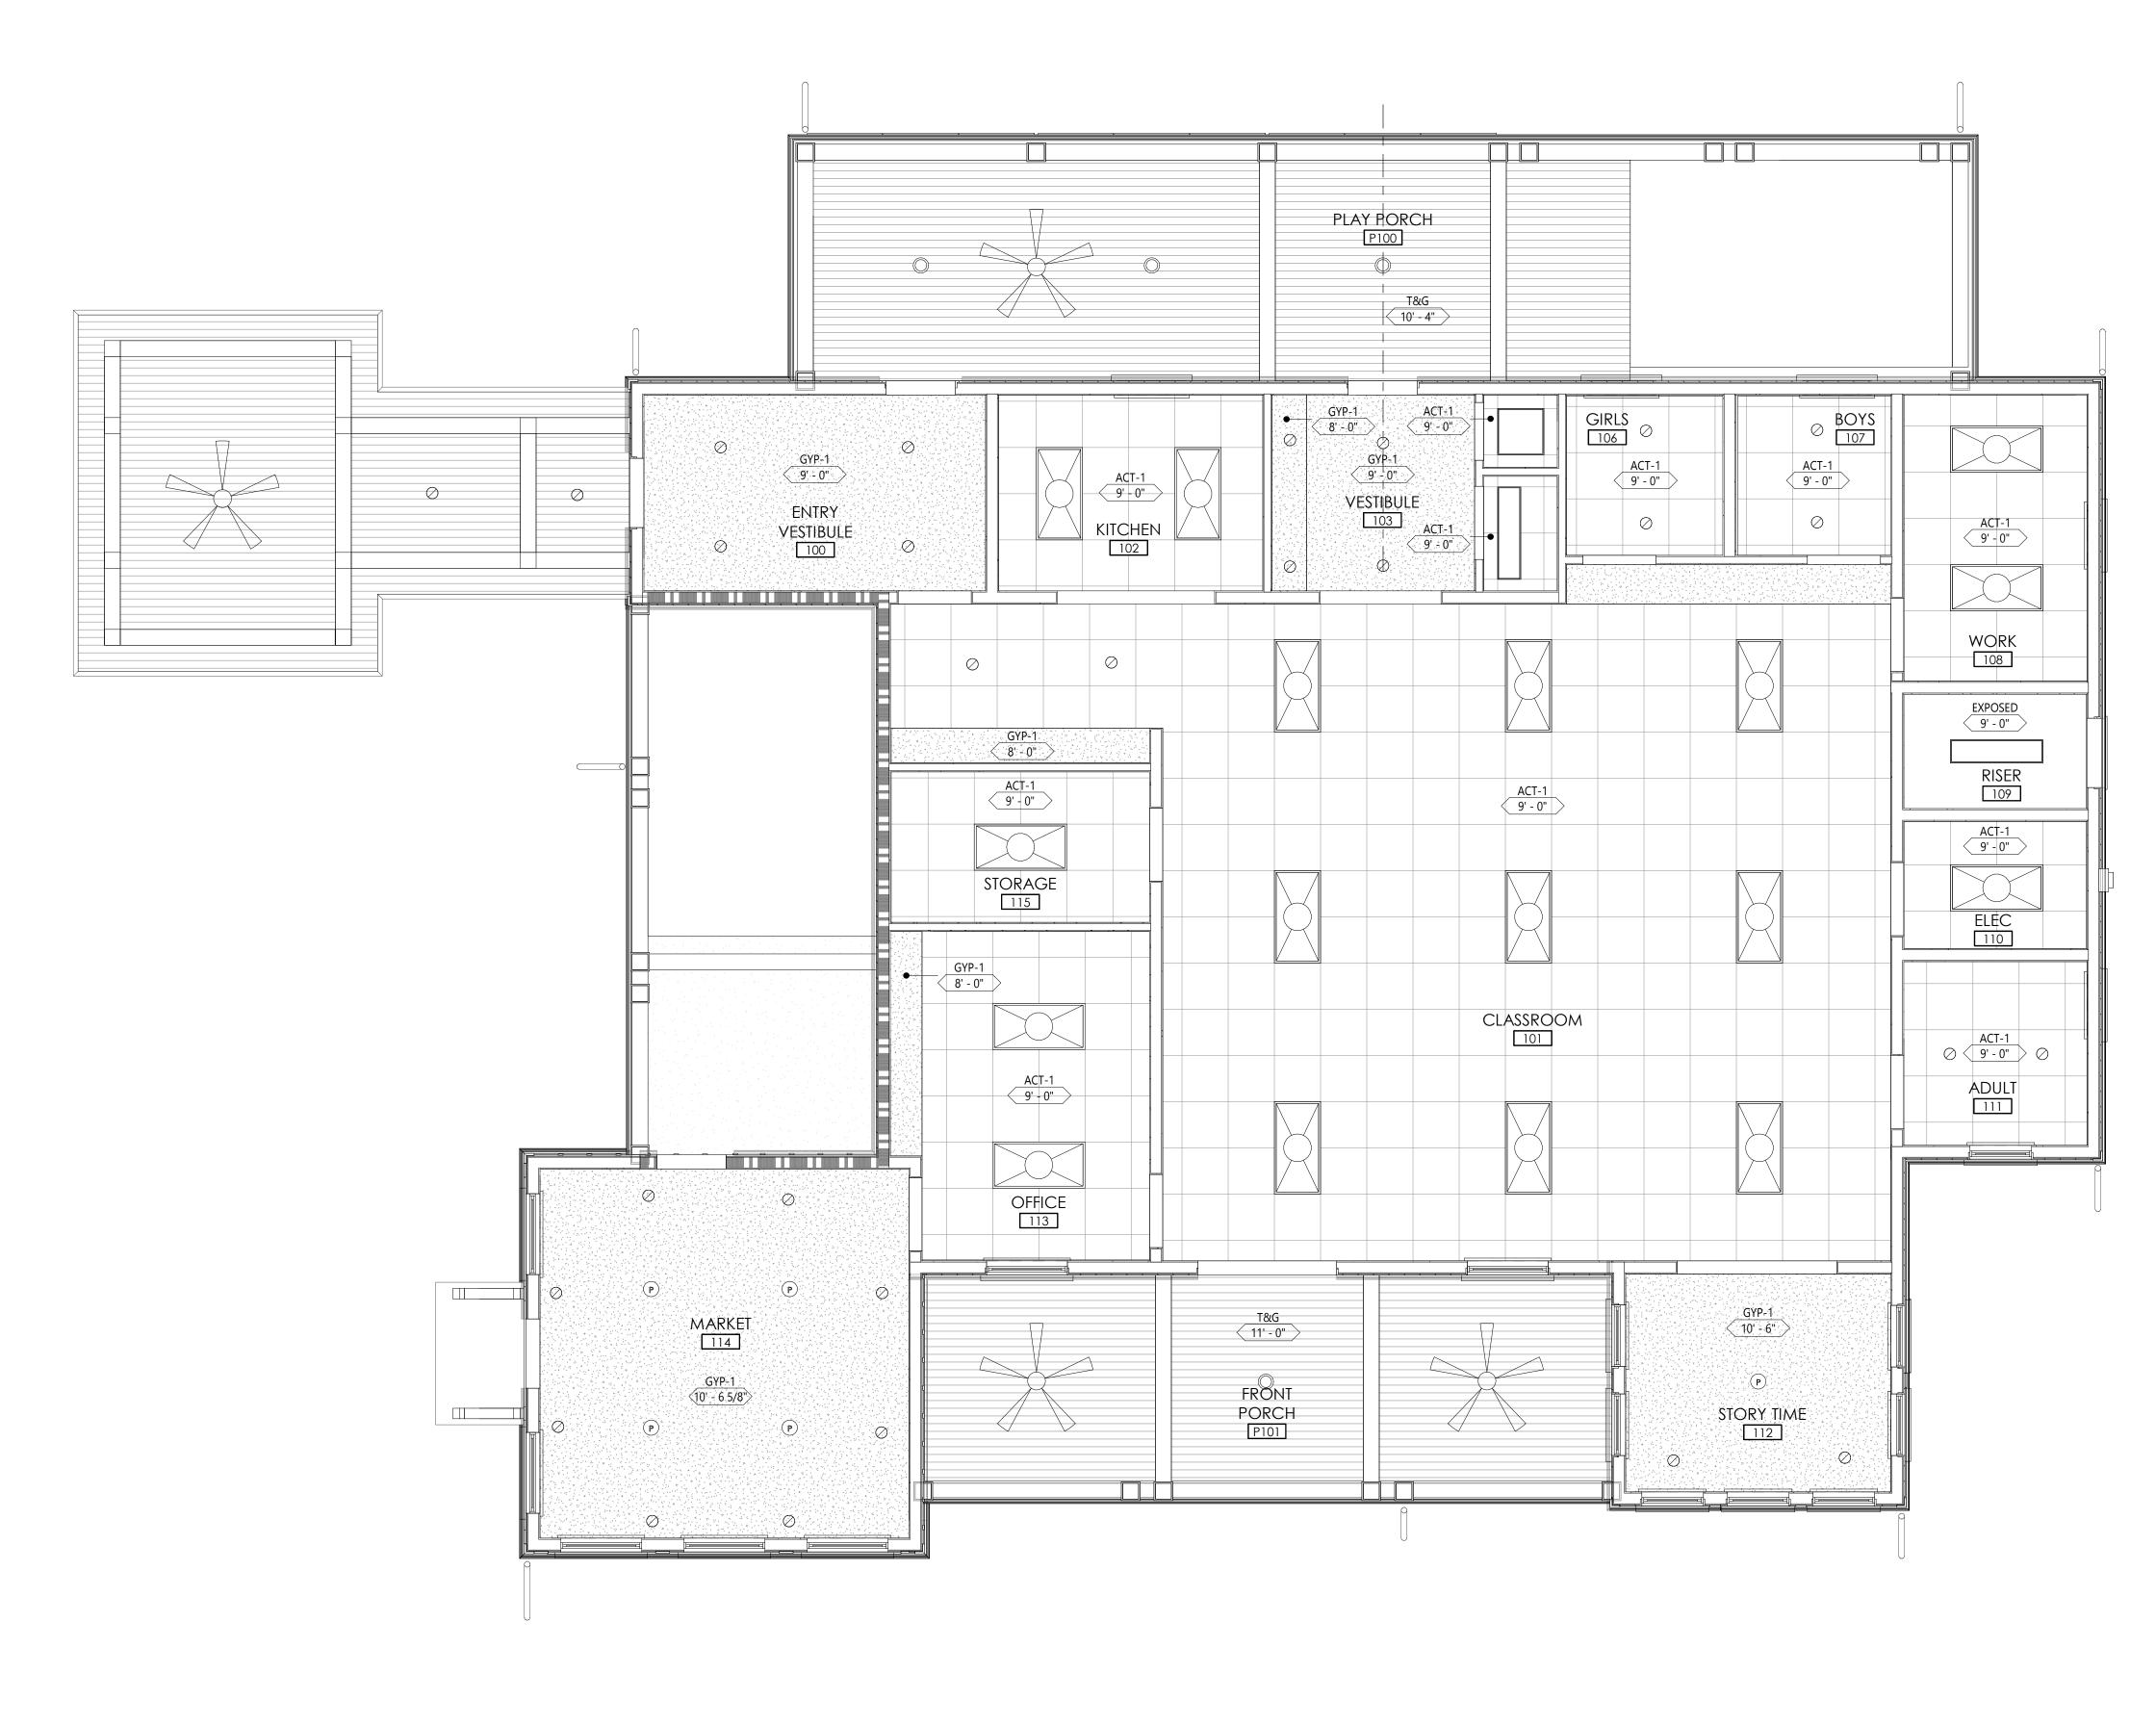




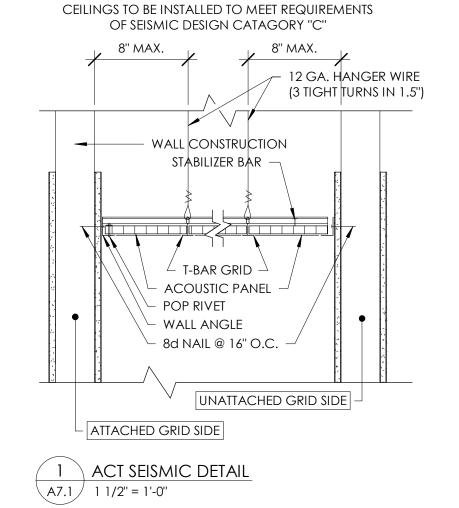



CLEARANCE PER 2015 IRC SECTION E3405.1

NOTE: SEE ELECTRICAL DERAWINGS FOR FINAL LOCATION PROVIDE

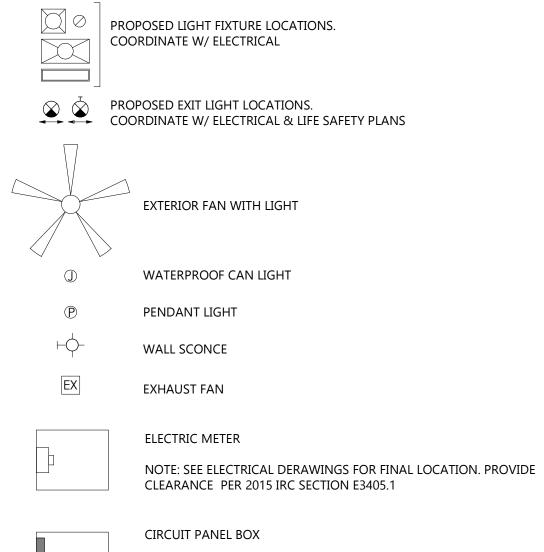



ACT-1 (10 '- 6 1/2") CEILING TAG

**REFLECTED CEILING PLAN GENERAL NOTES:** 

INFORMATION.

U.N.O.

INFORMATION AND SPECIFICATIONS.

PAINTED GYP. BD. CEILING, BULKHEAD, HEADER, OR SOFFIT

ACOUSTIC CEILING TILE. SEE FINISH LEGEND FOR MORE INFORMATION

- H. COORDINATE LOCATION OF ELECTRICAL FIXTURES, MECHANICAL GRILLES AND DIFFUSERS, SPRINKLER HEADS, AND OTHER CEILING MOUNTED ITEMS, NOTIFY ARCHITECT OF CONFLICTS PRIOR TO FINAL INSTALLATION.
- G. SEE MECHANICAL DRAWINGS FOR DUCT AND EQUIPMENT LAYOUT.

A. THIS DRAWING INDICATES THE GENERAL LOCATION OF FIXTURES, ARCHITECTURAL DETAILS AND FINISHES. REFER TO ENGINEERING DRAWINGS FOR ADDITIONAL

B. SEE FINISH SCHEDULE, FINISH PLANS, AND SPECIFICATIONS FOR ADDITIONAL

C. PROVIDE ACT HOLD DOWN CLIPS WITHIN 20'-0" OF ENTRY DOORS

- U.N.O.

- F. ALL DOWN LIGHTS AND WALL WASHERS TO BE CENTERED IN CEILING TILE OR SOFFIT,

DECORATIVE FIXTURES WITH ARCHITECT PRIOR TO INSTALLATION.

