

Cypress Ridge Mill Creek Blvd. Bluffton, South Carolina

Issued for:

 Site Plan Review
 03/29/2023


 Site Plan Review
 05/12/2023

 Site Plan Review
 07/24/2023

 Site Plan Review
 10/25/2023

 Site Plan Review
 10/30/2023

Roof Plan marches Option 2

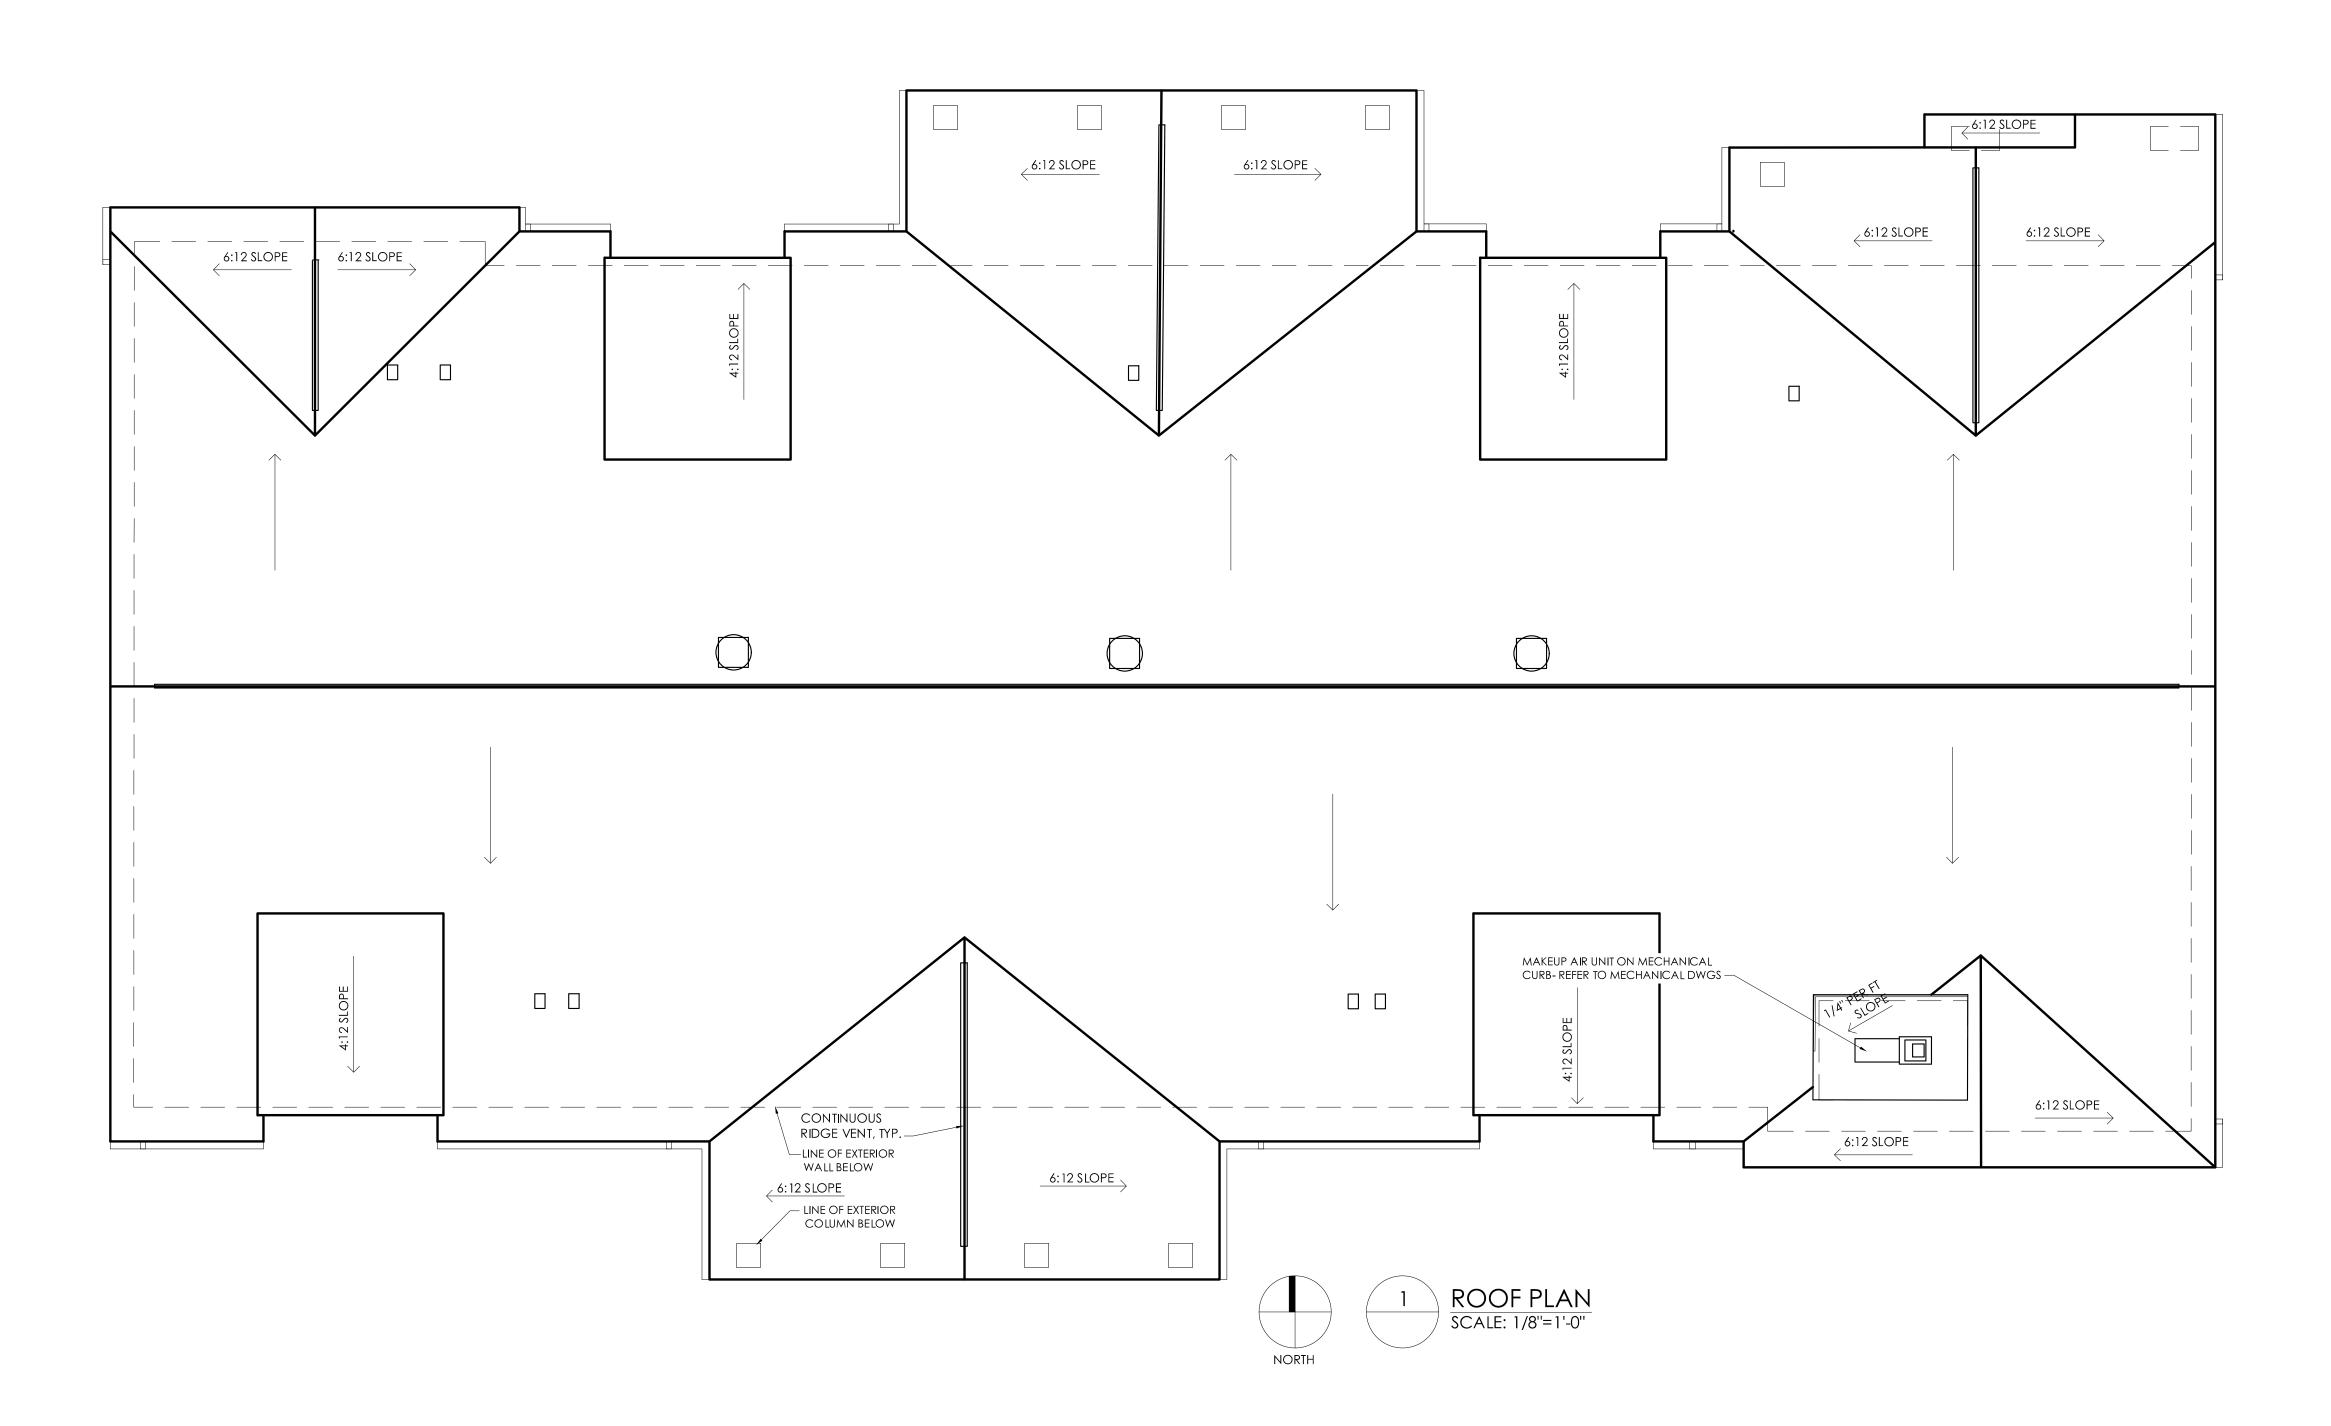

Subject:

ROOF PLANS

Project Owner:



Project Consultants:



Design Group

10913 Marcello Lane
Whitmore Lake, MI 48189





Job No. 20211019

Sheet No.



MATERIAL	MANUFACTURER	DESCRIPTION AND COLOR
ROOF		
ASPHALT SHINGLES	GAF	STYLE: TIMBERLINE HDZ COLOR: OYSTER GREY
SOFFIT PANELS	JAMES HARDIE	STYLE: HARDIESOFFIT PANELS, VENTED CEDARMILL COLOR: WHITE
WALL		
HORIZONTAL LAP SIDING	JAMES HARDIE	STYLE: HARDIEPLANK LAP SIDING, CEDARMILL COLOR: MONTEREY TAUPE
SIDING TRIM	JAMES HARDIE	STYLE: SMOOTH COLOR: WHITE WINDOWS AND DOOR SURROUNDS, SOFFIT
BRICK	GENERAL SHALE	STYLE: MODULAR BRICK, RUNNING BOND COLOR: SAVANNAH GREY
FIBERGLASS COLUMNS	ENDURA-CRAFT	STYLE: CRAFTSMAN STYLE, TAPERED, RECESSED PANEL COLOR: WHITE
LOUVER	FYPON	STYLE: 33" ROUND, POLYURETHANE COLOR: WHITE
SCREEN WALL A/C UNITS AT GRADE		STYLE: VINYL COLOR: BEIGE, HEIGHT: 3'-2" (MIN)

DO NOT SCALE PRINTS. USE FIGURED DIMENSIONS. © 2023 FSDG


Project:




Cypress Ridge Mill Creek Blvd. Bluffton, South Carolina

Issued for:


03/29/2023 05/12/2023 07/24/2023 09/25/2023 10/25/2023
10/25/2023 10/29/2023

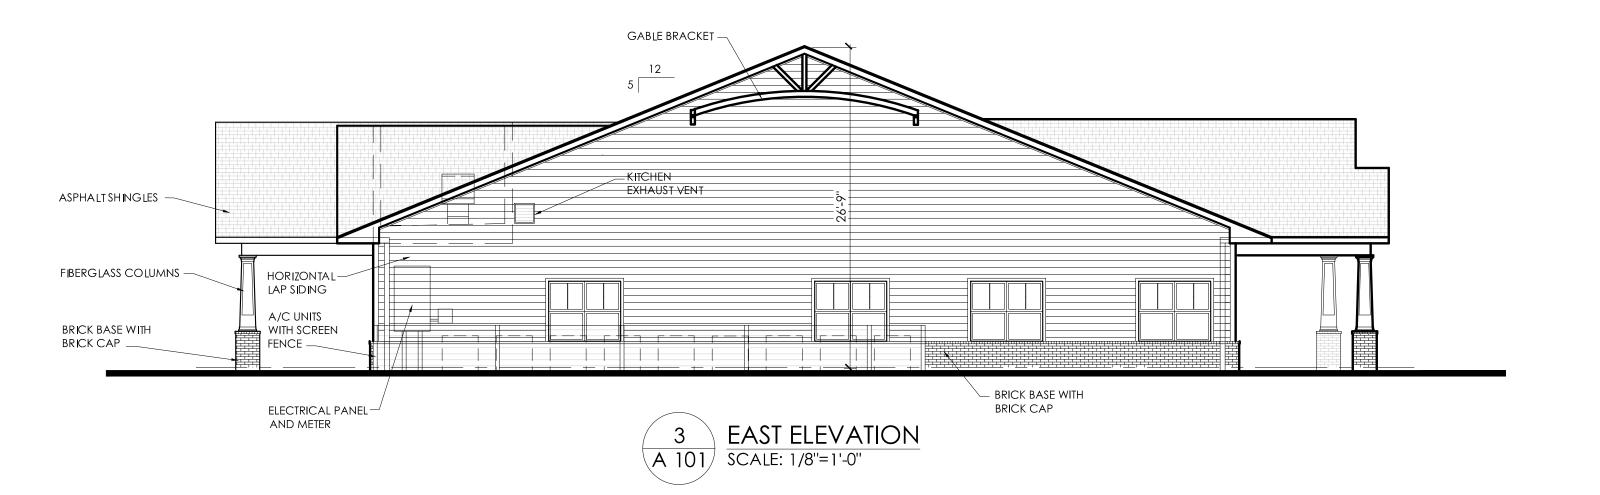

Option 1

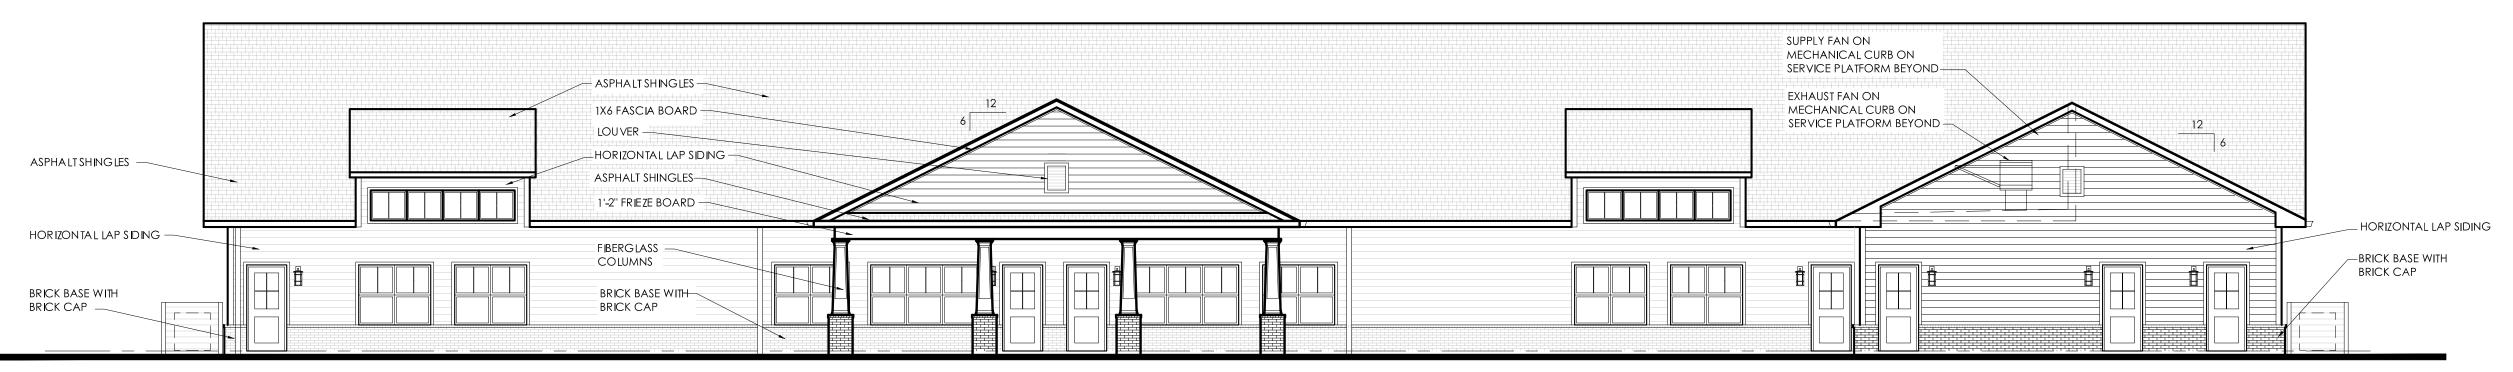



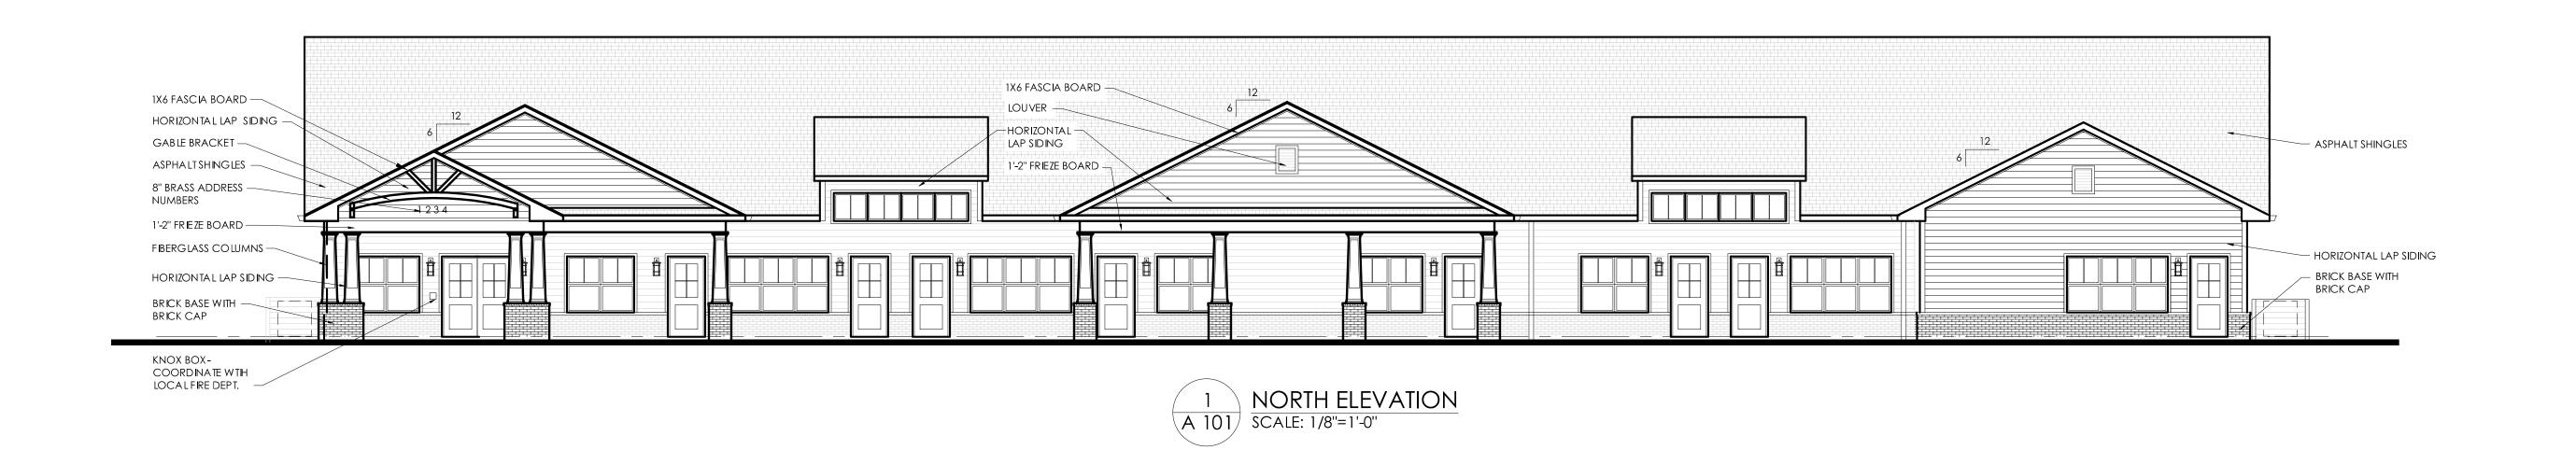

Subject:

ELEVATIONS

Project Owner:



Project Consultants:



conn engineering consultants, inc. commercial+industrial+institutional+residential structural engineering

107 n. bridge linden, mi 48451 p. 810.458.4350 www.connengineering.com



Job No.
20211019
Sheet No.

A 201

— BRICK BASE WITH BRICK CAP



---KITCHEN EXHAUST VENT

ASPHALT SHINGLES —

FIBERGLASS COLUMNS —

BRICK BASE WITH

BRICK CAP _

HORIZONTAL— LAP SIDING

A/C UNITS WITH SCREEN

ELECTRICAL PANEL — AND METER

MATERIAL	MANUFACTURER	DESCRIPTION AND COLOR
ROOF		
ASPHALT SHINGLES	GAF	STYLE: TIMBERLINE HDZ COLOR: OYSTER GREY
SOFFIT PANELS	JAMES HARDIE	STYLE: HARDIESOFFIT PANELS, VENTED CEDARMILL COLOR: WHITE
WALL		
HORIZONTAL LAP SIDING	JAMES HARDIE	STYLE: HARDIEPLANK LAP SIDING, CEDARMILL COLOR: MONTEREY TAUPE
SIDING TRIM	JAMES HARDIE	STYLE: SMOOTH COLOR: WHITE WINDOWS AND DOOR SURROUNDS, SOFFIT
BRICK	GENERAL SHALE	STYLE: MODULAR BRICK, RUNNING BOND COLOR: SAVANNAH GREY
FIBERGLASS COLUMNS	ENDURA-CRAFT	STYLE: CRAFTSMAN STYLE, TAPERED, RECESSED PANEL COLOR: WHITE
LOUVER	FYPON	STYLE: 33" ROUND, POLYURETHANE COLOR: WHITE
SCREEN WALL A/C UNITS AT GRADE		STYLE: VINYL COLOR: BEIGE, HEIGHT: 3'-2" (MIN)

DO NOT SCALE PRINTS. USE FIGURED DIMENSIONS. © 2023 FSDG

Project:




Cypress Ridge Mill Creek Blvd. Bluffton, South Carolina

Issued for:


Site Plan Review 10/29/2023

Option 2

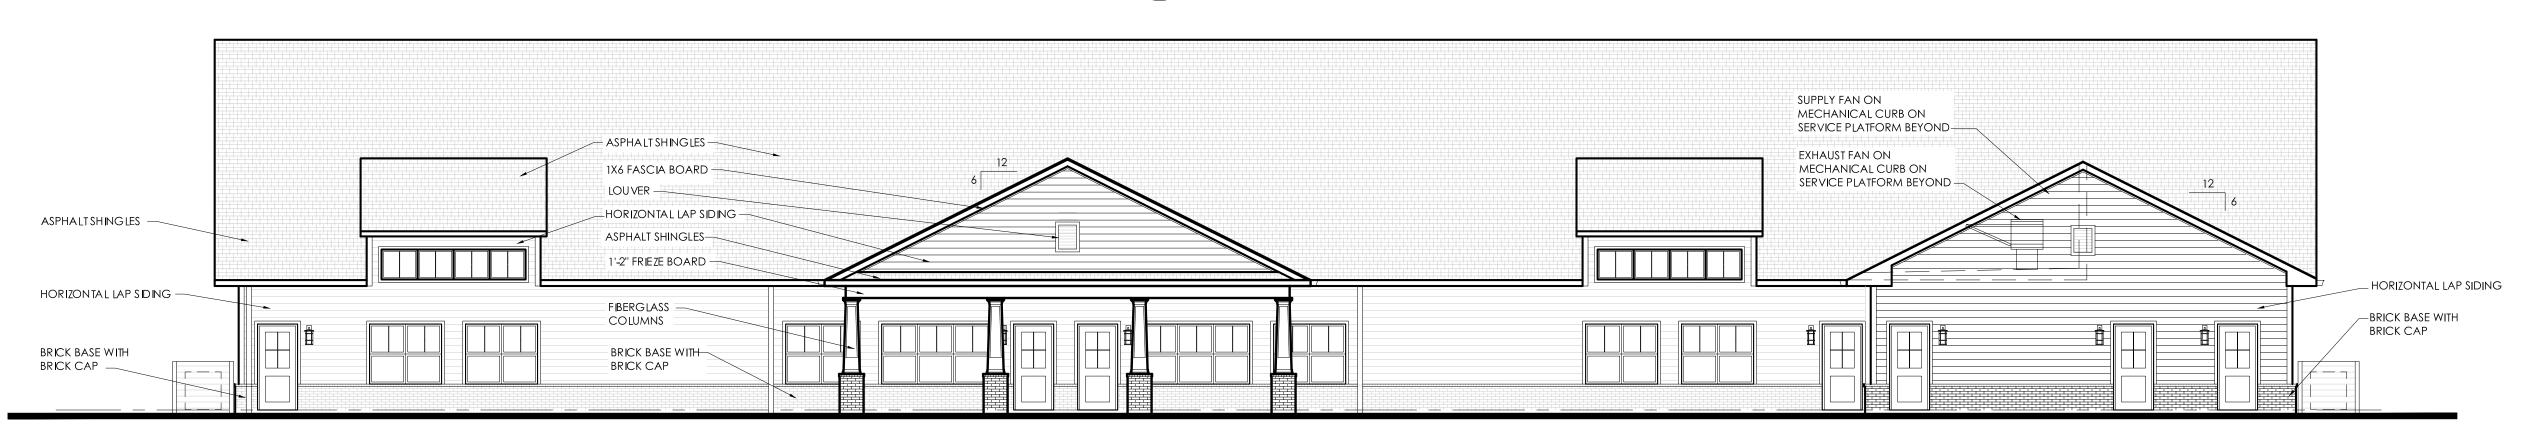

A 101 EAST ELEVATION SCALE: 1/8"=1'-0"



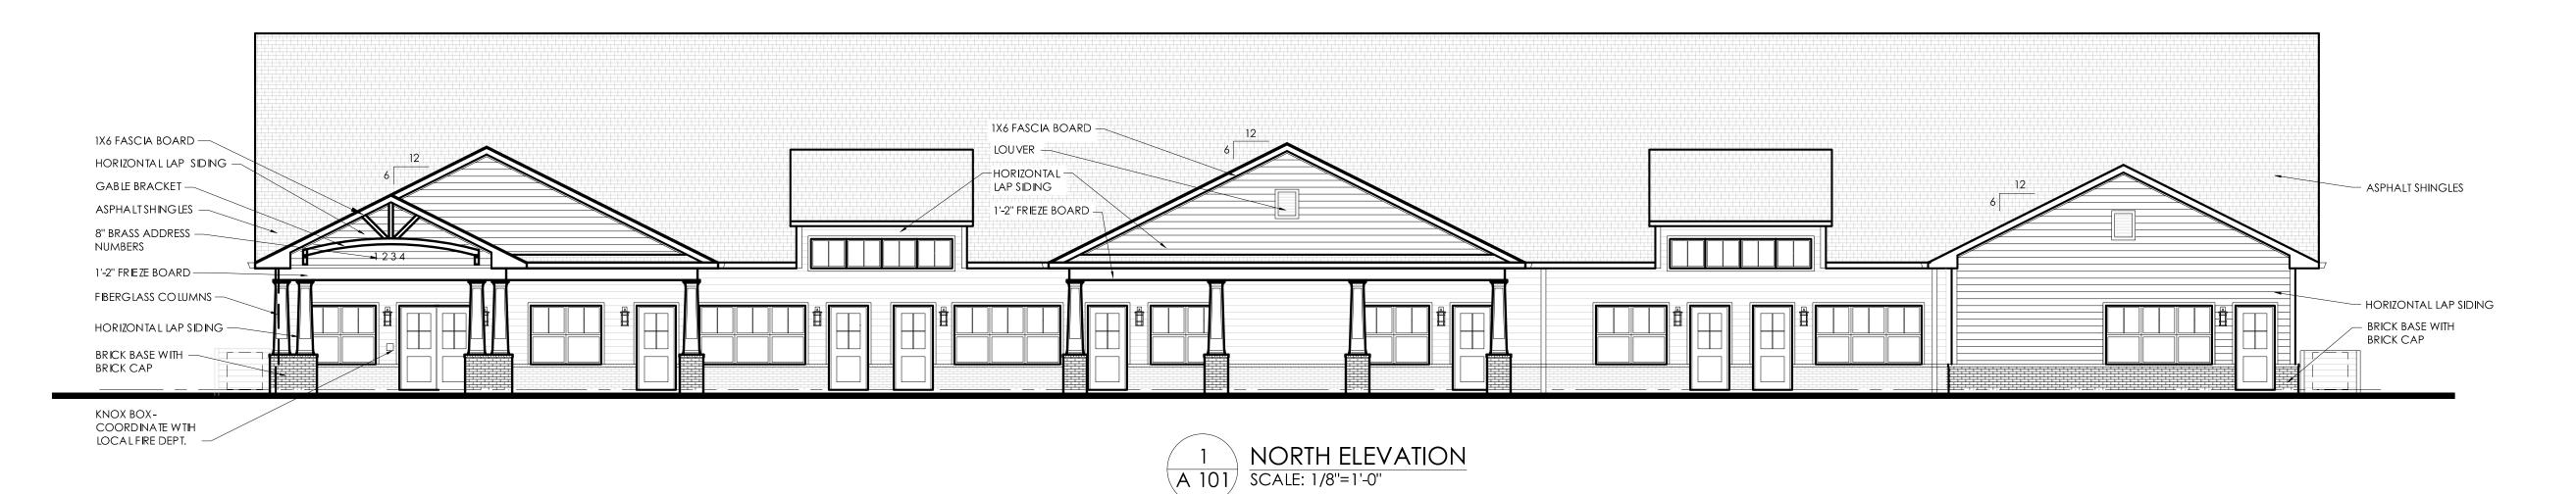

Subject:

ELEVATIONS

Project Owner:



Project Consultants:




conn engineering consultants, inc.
commercial+industrial+institutional+residential structural engineering
107 n. bridge linden, mi 48451 p. 810.458,4350 www.connengineering.com



Job No.
20211019
Shoot No.

Sheet No.
A 201

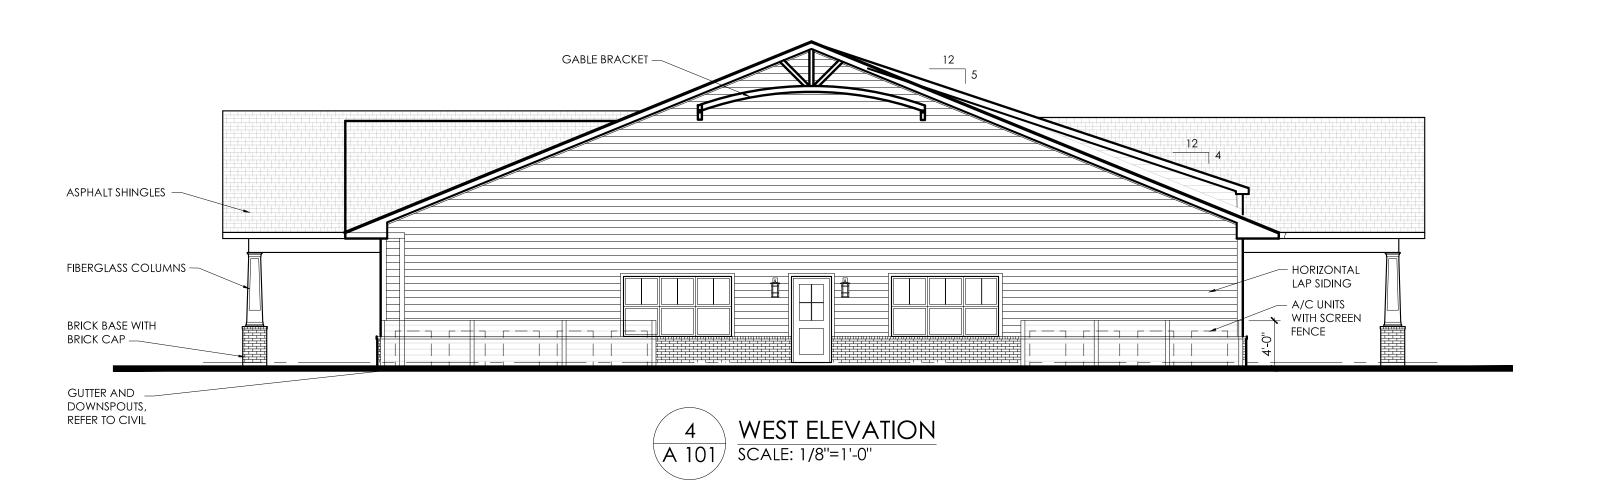

MATERIAL	MANUFACTURER	DESCRIPTION AND COLOR
ROOF		
ASPHALT SHINGLES	GAF	STYLE: TIMBERLINE HDZ COLOR: OYSTER GREY
SOFFIT PANELS	JAMES HARDIE	STYLE: HARDIESOFFIT PANELS, VENTED CEDARMILL COLOR: WHITE
WALL	1	
HORIZONTAL LAP SIDING	JAMES HARDIE	STYLE: HARDIEPLANK LAP SIDING, CEDARMILL COLOR: MONTEREY TAUPE
SIDING TRIM	JAMES HARDIE	STYLE: SMOOTH COLOR: WHITE WINDOWS AND DOOR SURROUNDS, SOFFIT
BRICK	GENERAL SHALE	STYLE: MODULAR BRICK, RUNNING BOND COLOR: SAVANNAH GREY
FIBERGLASS COLUMNS	ENDURA-CRAFT	STYLE: CRAFTSMAN STYLE, TAPERED, RECESSED PANEL COLOR: WHITE
LOUVER	FYPON	STYLE: 33" ROUND, POLYURETHANE COLOR: WHITE
SCREEN WALL A/C UNITS AT GRADE		STYLE: VINYL COLOR: BEIGE, HEIGHT: 3'-2" (MIN)

DO NOT SCALE PRINTS. USE FIGURED DIMENSIONS. © 2023 FSDG


Project:



Cypress Ridge Mill Creek Blvd. Bluffton, South Carolina

Issued for:


Site Plan Review 11/08/2023

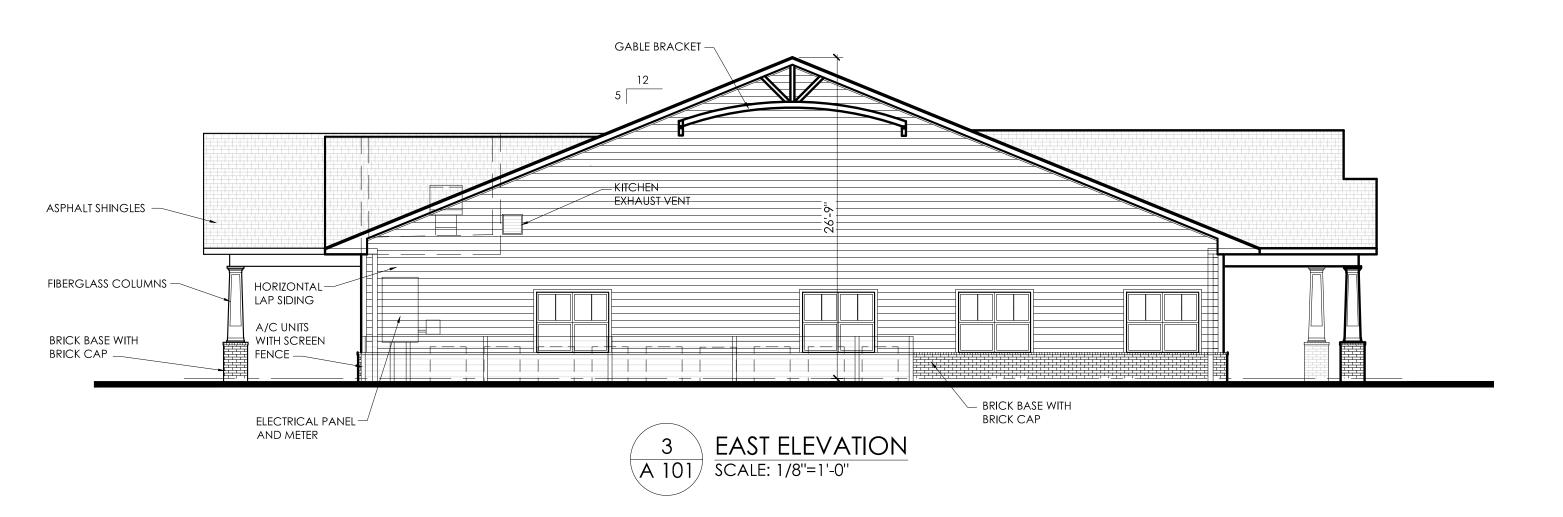

Option 3





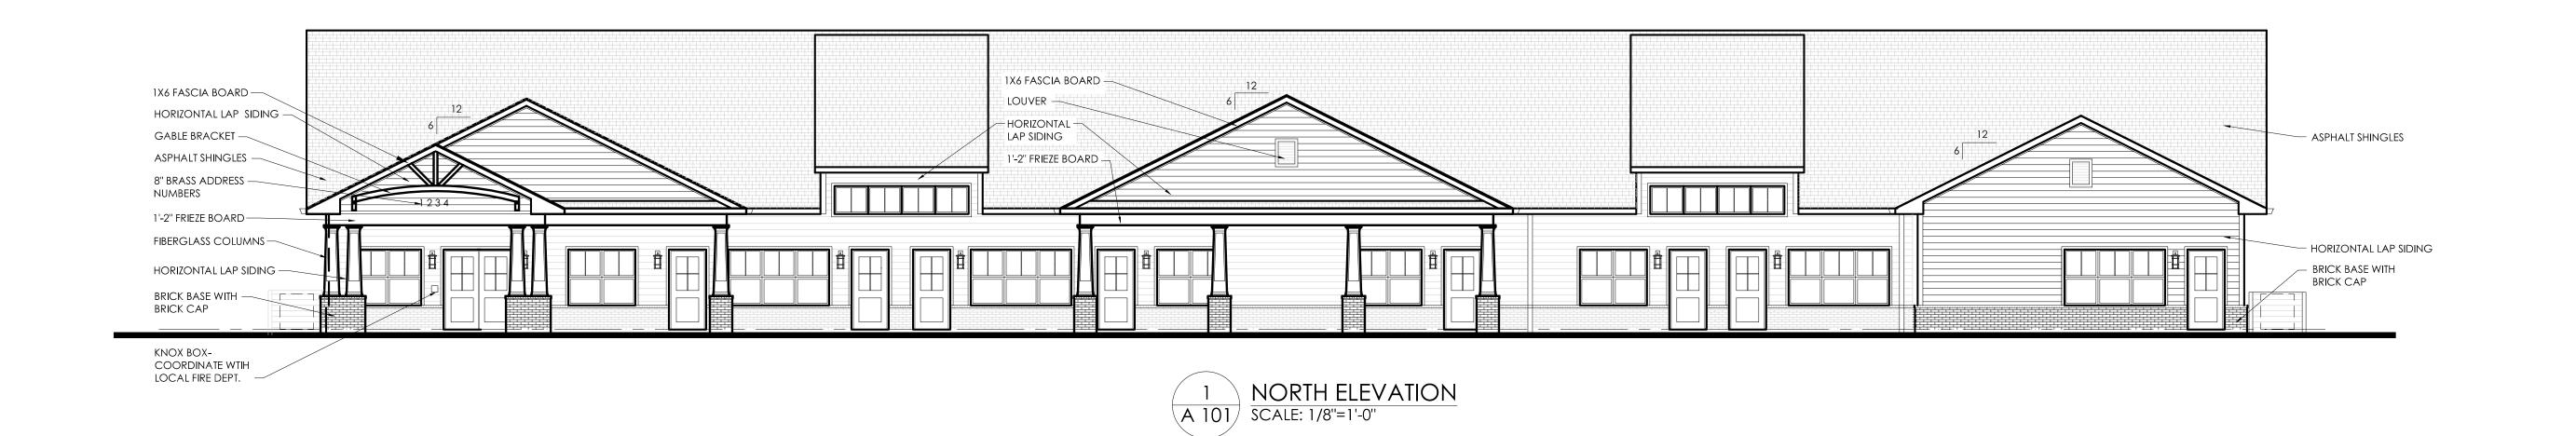

Subject:

ELEVATIONS

Project Owner:



Project Consultants:



conn engineering consultants, inc.
commercial+industrial+institutional+residential structural engineering
107 n. bridge linden, mi 48451 p. 810.458.4350 www.connengineering.com



Job No.
20211019


Sheet No.


A 201


FAN #2 K-A1-G10D - SUPPLY FAN (KSF) 1. DIRECT DRIVE UNTEMPERED SUPPLY UNIT WITH 10" BLOWER IN SIZE #1 HOUSING WITH SPEED CONTROL, DISCONNECT SWITCH. 1. DIRECT DRIVE UNTEMPERED SUPPLY UNIT WITH 10" BLOWER IN SIZE #1 HOUSING WITH SPEED CONTROL, DISCONNECT SWITT 2. INTAKE HOOD WITH EZ FILTERS.
3. DOWN DISCHARGE - AIR FLOW RIGHT -> LEFT.
4. MOTORIZED BACK DRAFT DAMPER 16" X 18" FOR SIZE 1 UNTEMPERED UNITS W/EXTENDED SHAFT, STANDARD GALVANIZED CONSTRUCTION, 3/4" REAR FLANGE, LOW LEAKAGE, TFB120S ACTUATOR INCLUDED.
5. ECM WIRING PACKAGE FOR SUPPLY MOTORS WITH PWM SIGNAL FROM ECPM03 PREWIRE.
6. HINGED DOUBLE WALL INSULATED DOOR ASSEMBLY (BURNER/BLOWER SECTION).
7. 2 YEAR PARTS WARRANTY


*NOTE: SUPPLY DUCT MUST BE INSTALLED TO MEET SMACNA STANDARDS. A MINIMUM STRAIGHT DUCT LENGTH MUST BE MAINTAINED DOWNSTREAM OF UNIT DISCHARGE AS OUTLINED IN AMCA PUBLICATION 201. WHEN USING RECTANGULAR DUCTWORK, ELBOWS MUST BE RADIUS THROAT, RADIUS BACK WITH TURNING VANES. FLEXIBLE DUCTWORK AND SQUARE THROAT/SQUARE BACK ELBOWS SHOULD NOT BE USED. ANY TRANSITION AND/OR TURNS IN THE DUCTWORK WILL CAUSE SYSTEM EFFECT. SYSTEM EFFECT WILL DRASTICALLY INCREASE STATIC PRESSURE AND REDUCE AIRFLOW. DO NOT RELY ON UNIT TO SUPPORT DUCT IN ANY WAY. FAILURE TO PROPERLY SIZE DUCTWORK MAY CAUSE SYSTEM EFFECTS AND REDUCE PERFORMANCE OF THE EQUIPMENT. SUGGESTED STRAIGHT DUCT SIZE IS 14" × 14".




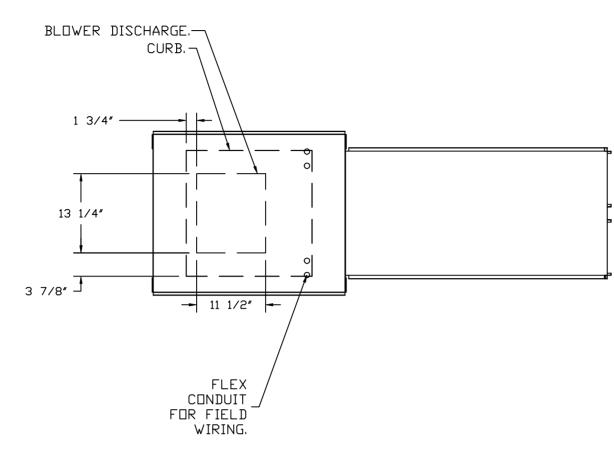

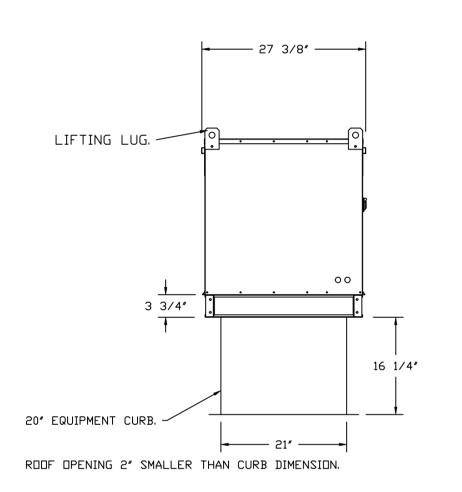

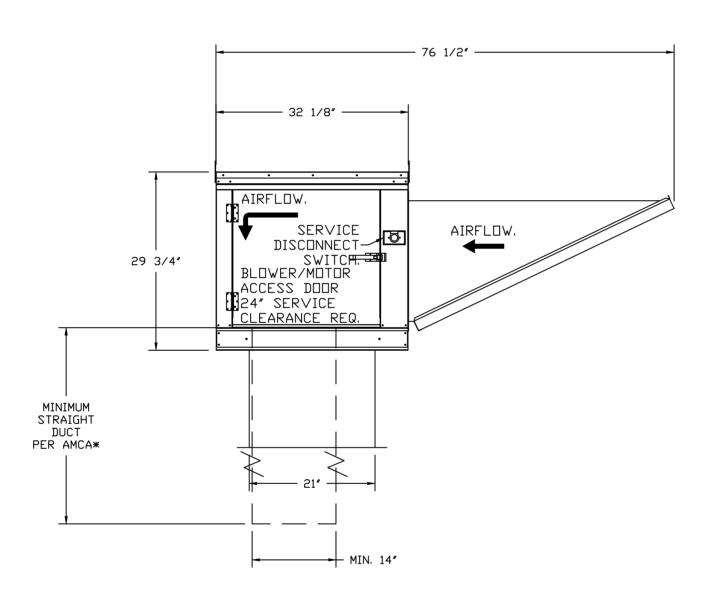

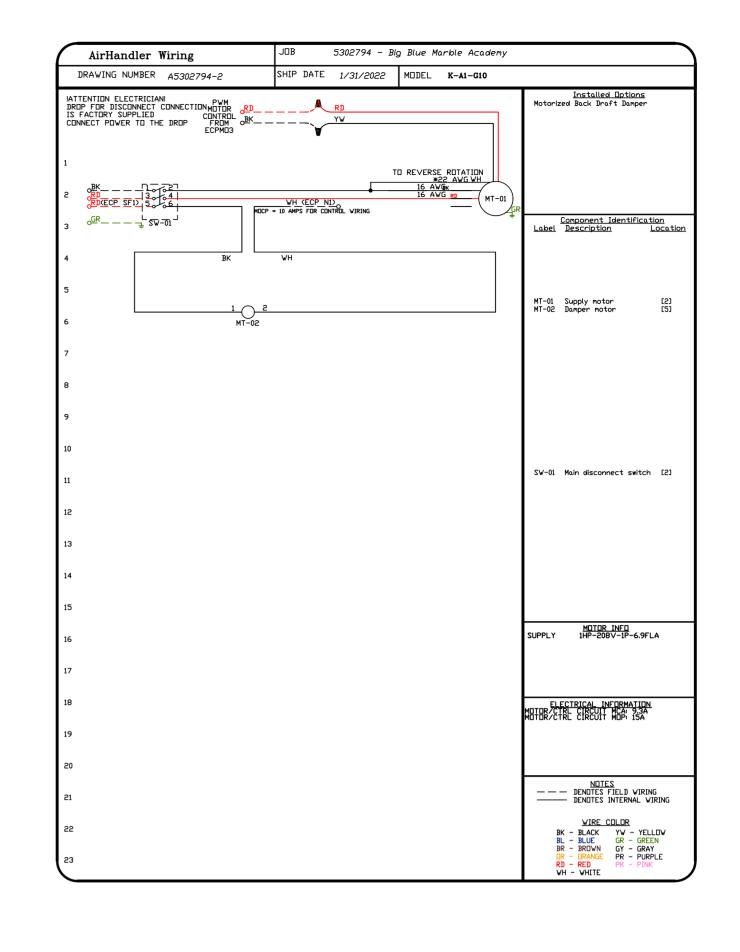

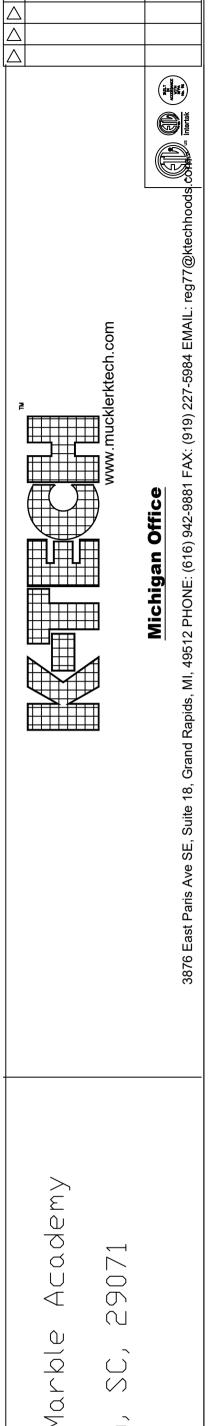

REVISIONS DESCRIPTION DATE:

Lexington, Blue Big

DATE: 1/31/2022 DWG.#:

5302794 DRAWN RJF

SCALE: 3/4" = 1'-0"

MASTER DRAWING

SHEET NO.

Unit Report For HP-2

Project: CTR - Big Blue Marble Prepared By: Jason Koroniotis

01/26/2022





Outdoor Unit Parameters

Unit Model:	25HCE	
Unit Size:	3 Tons (Size 36)	
Voltage:	208/230-3-60	V-Ph-Hz

Outdoor Unit Dimensions and Weight	
Unit Length:31.1875	in
Unit Width:31.1875	in
Unit Height:28.6875	in
Unit Shipping Weight:201.	lb

Indoor Coil Parameters

Unit Model:	FV4C
Unit Size: Size 00	
Cabinet Insulation: Modular	
insulation	
Voltage:	
Refrigerant Type:	Puron
Heating Size:	No Heat

Indoor Coil Dimensions and Weight		
Unit Length:	22.0625	in
Unit Width:	24.6875	in
Unit Height:	59.1875	in
Unit Shipping Weight:	207.	lb

RESIDENTIAL APPLICATIONS

This warranty is to the original purchasing owner and subsequent owners only to the extent and as stated in the Warranty Conditions and below. The limited warranty period in years, depending on the part and the claimant, is as shown in the table below.

Limited Warranty (Years)		
Item	Original Owner	Subsequent Owner
Parts	10* (or 5)	5
Compressor	10* (or 5)	5

*If properly registered within 90 days of original installation, otherwise 5 years (except in California and Quebec and other jurisdictions that prohibit warranty benefits conditioned on registration). See Warranty Conditions below.

OTHER APPLICATIONS

The warranty period is five (5) years on the compressor, and one (1) year on all other parts. The warranty is the original owner only and is not available for subsequent owners.

Ordering Information

Part Number	Description	Quantity
Outdoor Unit		
25HCE436AP05	Comfort Series Heat Pump with Puron 3 Tons Cooling	1
	14 SEER @ ARI Conditions	
	Std Offering (NO High Press Switch)	
Indoor Coil		
FV4CNB006L00	FV4C Performance Series Fan Coil with Puron 6 Tons Cooling 208/230-1-60	1
	Modular with 1-in. super thick insulation	
	Aluminum	
Accessories		
KFCEH2601C10	10 kW Electric Heater with Circuit Breaker for Indoor Unit	