


DRAWINGS ARE NOT INTENDED TO BE SCALED.

# New Construction For: Dylan & Amanda Mingard 41 Stock Farm Road Bluffton, SC 29910

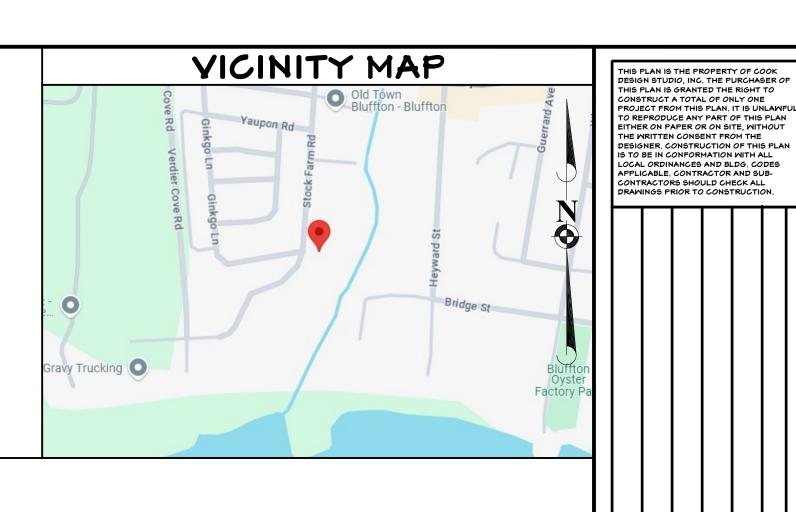

SHEET INDEX:

FLOOR PLAN, SCHEDULES, & DETAILS

FRONT & REAR ELEVATIONS

LEFT & RIGHT ELEVATIONS

3D EXTERIOR RENDERINGS

ELECTRICAL PLAN

FOUNDATION PLAN

STRUCTURAL DETAILS

STRUCTURAL DETAILS

STRUCTURAL DETAILS

**ROOF PLAN** 

NAME

C001

**S101** 

**S102** 

5103


COVER PAGE


SITE PLAN



# CONCEPTUAL RENDERING

		<u>N.T.5.</u>					
GENERAL NOTES		CODES - REGULATIONS - STANDARDS	SQUARE FOOTAGE	DESIG	DESIGN CRITERIA		
1. 2. 3.	ALL WORK SHALL COMPLY WITH FEDERAL, STATE, AND LOCAL BUILDING CODES AND REGULATIONS.  MECHANICAL, ELECTRICAL, AND PLUMBING WORK REQUIRED ON THIS PERMIT APPLICATION TO BE PERFORMED BY SUBCONTRACTORS LICENSED IN THE STATE AND MUNICIPALITY IN WHICH WORK IS BEING PERFORMED. SUBCONTRACTORS SHALL PROVIDE CERTIFICATION OF GENERAL LIABILITY INSURANCE AND WORKMAN'S COMPENSATIONS COVERAGE, AS REQUIRED BY THE GENERAL CONTRACTOR.	1. THE GENERAL CONTRACTOR IS RESPONSIBLE FOR ENSURING BUILT COMPLIANCE WITH ALL CODES, REGULATIONS, AND STANDARDS SUCH AS MAY BE IN FORCE. THESE CODES INCLUDE BUT MAY NOT BE LIMITED TO:  2021 International Residential Code With SC Modifications	1ST FLOOR = N/A 2ND FLOOR = N/A TOTAL HEATED = N/A	DESIGN CODE: ICC 600 & IRC 2021 WITH SC MODIFICATIONS & ASCET-16 SCOPE OF WORK: NEW CONSTRUCTION OCCUPANCY GROUP: SINGLE-FAMILY DWELLING CONSTRUCTION TYPE: YB FIRE PROTECTION SYSTEMS: NO TOTAL AREA: 1091 SQ. FT.	WINDOW AND DOOR DESIGN PRESSURE RATINGS PER 2021 INTERNATIONAL RESIDENTIAL CODE. DESIGN PRESSURE VALUES LISTED IN THE TABLE ARE IN POUNDS PER SQUARE FOOT (PSF) BASIC WIND SPEED: 140 MPH	MEMBER  A	
4. 5. 6. 7. 8. 9. 10	THE CONTRACTOR SHALL COORDINATE AND/OR OBTAIN ALL BUILDING PERMITS REQUIRED FOR CONSTRUCTION AND CERTIFICATES OF OCCUPANCY.  THE CONTRACTOR SHALL BE SOLELY RESPONSIBLE FOR ALL CONSTRUCTION MEANS, METHODS, TECHNIQUES, AND PROCEDURES. THE CONTRACTOR SHALL BE RESPONSIBLE FOR ASPECTS OF SAFETY DURING CONSTRUCTION AND SHALL PROVIDE ADEQUATE SHORING AND BRACING TO ENSURE SUCH SAFETY.  ALL DIMENSIONS AND SITE CONDITIONS TO BE FIELD VERIFIED AND SHALL BE THE RESPONSIBILITY OF THE CONTRACTOR. NOTIFY THE DESIGNER OF ANY DISCREPANCY PRIOR TO COMMENCEMENT OF WORK. IT SHALL BE THE RESPONSIBILITY OF THE CONTRACTOR TO LOCATE ALL EXISTING UTILITIES WHETHER INDICATED ON PLANS OR NOT, AND TO PROTECT THEM FROM DAMAGE.  ALL DETAILS, SECTIONS, NOTES, OR REFERENCES TO OTHER DRAWINGS ARE INTENDED TO BE TYPICAL.  DURING CONSTRUCTION, AND PRIOR TO THE INCORPORATION OF ANY CHANGES, REVISIONS, MODIFICATIONS OR DEVIATIONS FROM THE CONSTRUCTION DOCUMENTS, THE CONTRACTOR SHALL NOTIFY THE DESIGNER AND OBTAIN APPROVAL FROM THE GOVERNING BUILDING OFFICIAL BEFORE PROCEEDING WITH THE WORK.  THE MANUFACTURERS, PRODUCTS AND EQUIPMENT LISTED ESTABLISH PERFORMANCE REQUIREMENTS. SUBSTITUTIONS OF EQUAL PERFORMANCE MAY BE SUBMITTED TO THE DESIGNER FOR APPROVAL.  ALL MATERIALS SHALL BE INSTALLED PER MANUFACTURER'S INSTRUCTIONS, SPECIFICATIONS, AND WARRANTY REQUIREMENTS UNLESS	<ol> <li>SHOULD THE GENERAL CONTRACTOR BECOME AWARE OF A CONDITION SHOWN OR DEPICTED IN THE CONTRACT DOCUMENTS THAT WOULD RESULT IN A VIOLATION OF ANY CODE OR REGULATION LISTED ABOVE, THE GENERAL CONTRACTOR SHALL CONTACT THE HOMEOWNER IMMEDIATELY FOR RESOLUTION.</li> <li>THE GENERAL CONTRACTOR SHALL BE RESPONSIBLE FOR OBTAINING ANY PERMIT NOT PROVIDED BEFOREHAND BY THE HOMEOWNER.</li> <li>THE GENERAL CONTRACTOR AND/OR HIS/HER SUBCONTRACTORS SHALL BE RESPONSIBLE FOR COORDINATING ALL REQUIRED INSPECTIONS.</li> <li>NEITHER THE HOMEOWNER NOR THE DESIGNER SHALL BE CONSIDERED TO ACT IN THE ROLE OF AN INSPECTOR. WHILE THE HOMEOWNER AND THE DESIGNER SHALL ENDEAVOR TO ALERT THE GENERAL CONTRACTOR TO ANY PERCEIVED OR OBSERVED DEFECT IN THE CONSTRUCTION, FAILURE TO DO SO SHALL NOT IN ANY WAY RELIEVE THE GENERAL CONTRACTOR FROM HIS/HER OBLIGATION TO ENSURE THAT THE BUILT WORK IS SAFE, OF GOOD QUALITY, AND COMPLIANT WITH ALL RELEVANT CODES AND REGULATIONS.</li> <li>THE GENERAL CONTRACTOR IS RESPONSIBLE FOR ENSURING THAT ALL WORK, WHETHER PERFORMED BY SUBCONTRACTORS OR BY THE GENERAL CONTRACTOR HIM/HERSELF, IS OF GOOD WORKMANSHIP AND QUALITY.</li> </ol>	STORAGE = 264 CARPORT = 528 BREEZEWAY = 299 GARAGE = N/A TOTAL AREA = 1091	HEIGHT: 20'-3 7/16" +/- NUMBER OF STORIES: 1 FLOOD ZONE: X  1. FLOOR DEAD LOADS: PARTITIONS 20 PSF FIXED EQUIPMENT ACTUAL WEIGHT FINISHES ACTUAL WEIGHT 2. FLOOR LIVE LOADS: LIVING ROOMS 40 PSF SLEEPING ROOMS 40 PSF ATTIC W/ STORAGE 20 PSF ATTIC W/O STORAGE 10 PSF DECKS 40 PSF BALCONIES 60 PSF GUARDRAILS & HANDRAILS 200#  3. ROOF DEAD LOAD: TOTAL 15.0 PSF ROOFING 2.0 PSF INSULATION 1.0 PSF FRAMING 5.0 PSF CEILING 5.0 PSF 4. ROOF LIVE LOADS: 20 PSF	MEAN ROOF HEIGHT INLAND LOCATION  (MRH) ZONE (4)ZONE (5)  15' DP 35 DP 45  20' DP 35 DP 45  20' DP 35 DP 45  30' DP 35 DP 45  35' DP 35 DP 45  40' DP 40 DP 50  50' DP 40 DP 50  MEAN ROOF HEIGHT OCEAN/MARSH LOCATION  (MRH) ZONE (4)ZONE (5)  15' DP 40 DP 50  20' DP 45 DP 50  20' DP 45 DP 50  20' DP 45 DP 50  30' DP 50 DP 55  35' DP 50 DP 55  40' DP 50 DP 55  50' DP 55 DP 65  50' DP 55 DP 65	BD  AMERICAN INSTITUTE of BUILDING DESIGN  N·C·B·D·C  NATIONAL COUNCIL OF  SCOTT COOK CERTIFICATION NO. 41-117  SEAL DATE: 04-30-2025  COOK DESIGN STUDIO, Inc.  804 WICHMAN STREET	
14	OTHERWISE SPECIFIED BY THE DESIGNER.  SPECIFIC NOTES AND DETAILS ON DRAWINGS SHALL TAKE PRECEDENCE OVER GENERAL NOTES AND TYPICAL DETAILS. WHERE NO DETAILS ARE SHOWN, CONSTRUCTION SHALL CONFORM TO SIMILAR WORK ON THE PROJECT.  ALL WORK SHALL BE EXECUTED IN A SKILLED MANNER WITH REGARD TO CUTS, JOINTS, PLACEMENT OF FASTENERS, PLUMBNESS, LEVELNESS, ALIGNMENT, PREPARATION, AND FINISH.			5. ROOF SNOW LOAD: 5.0 PSF GROUND 6. WIND EXPOSURE: B 7. BASIC WIND SPEED: 140 8. SEISMIC CRITERIA SITE CLASS: D DESIGN CATEGORY: C	WILLIAM H. BRANHAM III, P.E. PO BOX 147 MT. PLEASANT, SC 29465	MALTERBORO, SC 29488 (843) 782-4077  DRAWN BY: BSC CHECK BY: WHE  JOB: 6858-177-202!  DATE: 04-30-202!	
15	IT SHALL BE THE RESPONSIBILITY OF THE CONTRACTOR TO VERIFY THE COMPATIBILITY OF ALL MATERIALS AND PRODUCTS PRIOR TO			9. THE DESIGN SOIL BEARING PRESSURE IS PSF 2000 (ASSUMED)	(843) 830-0418	G001	

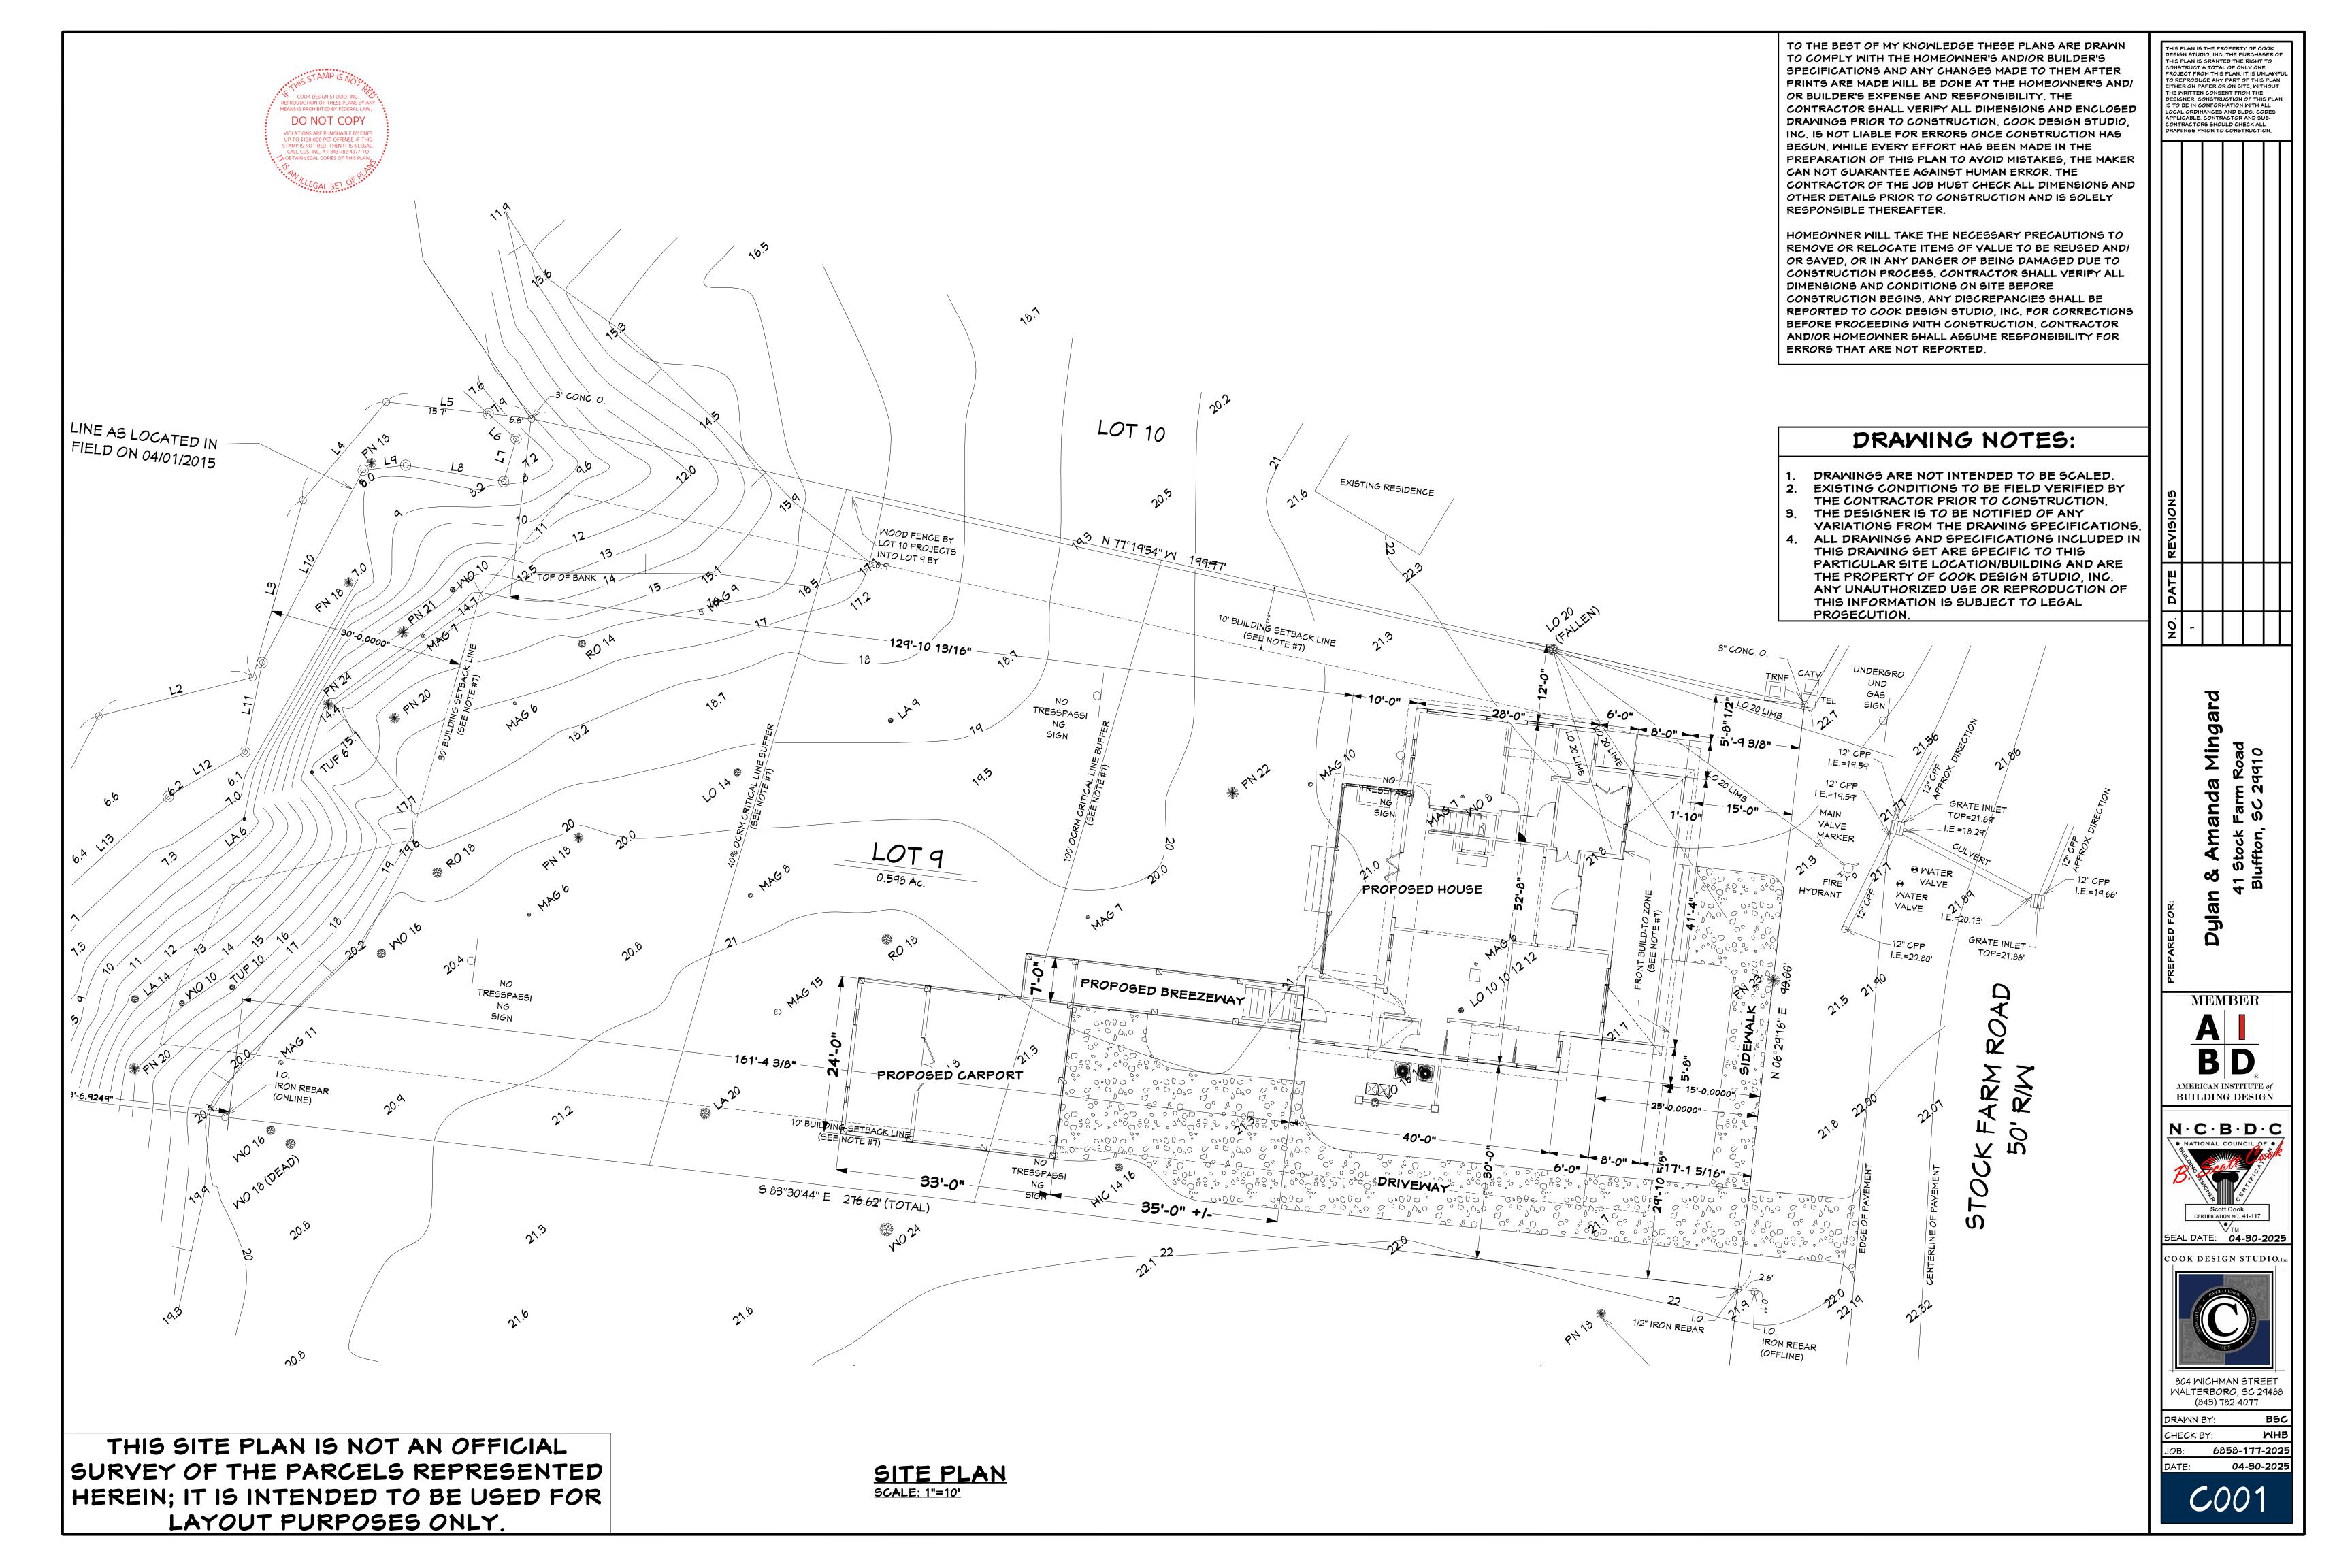

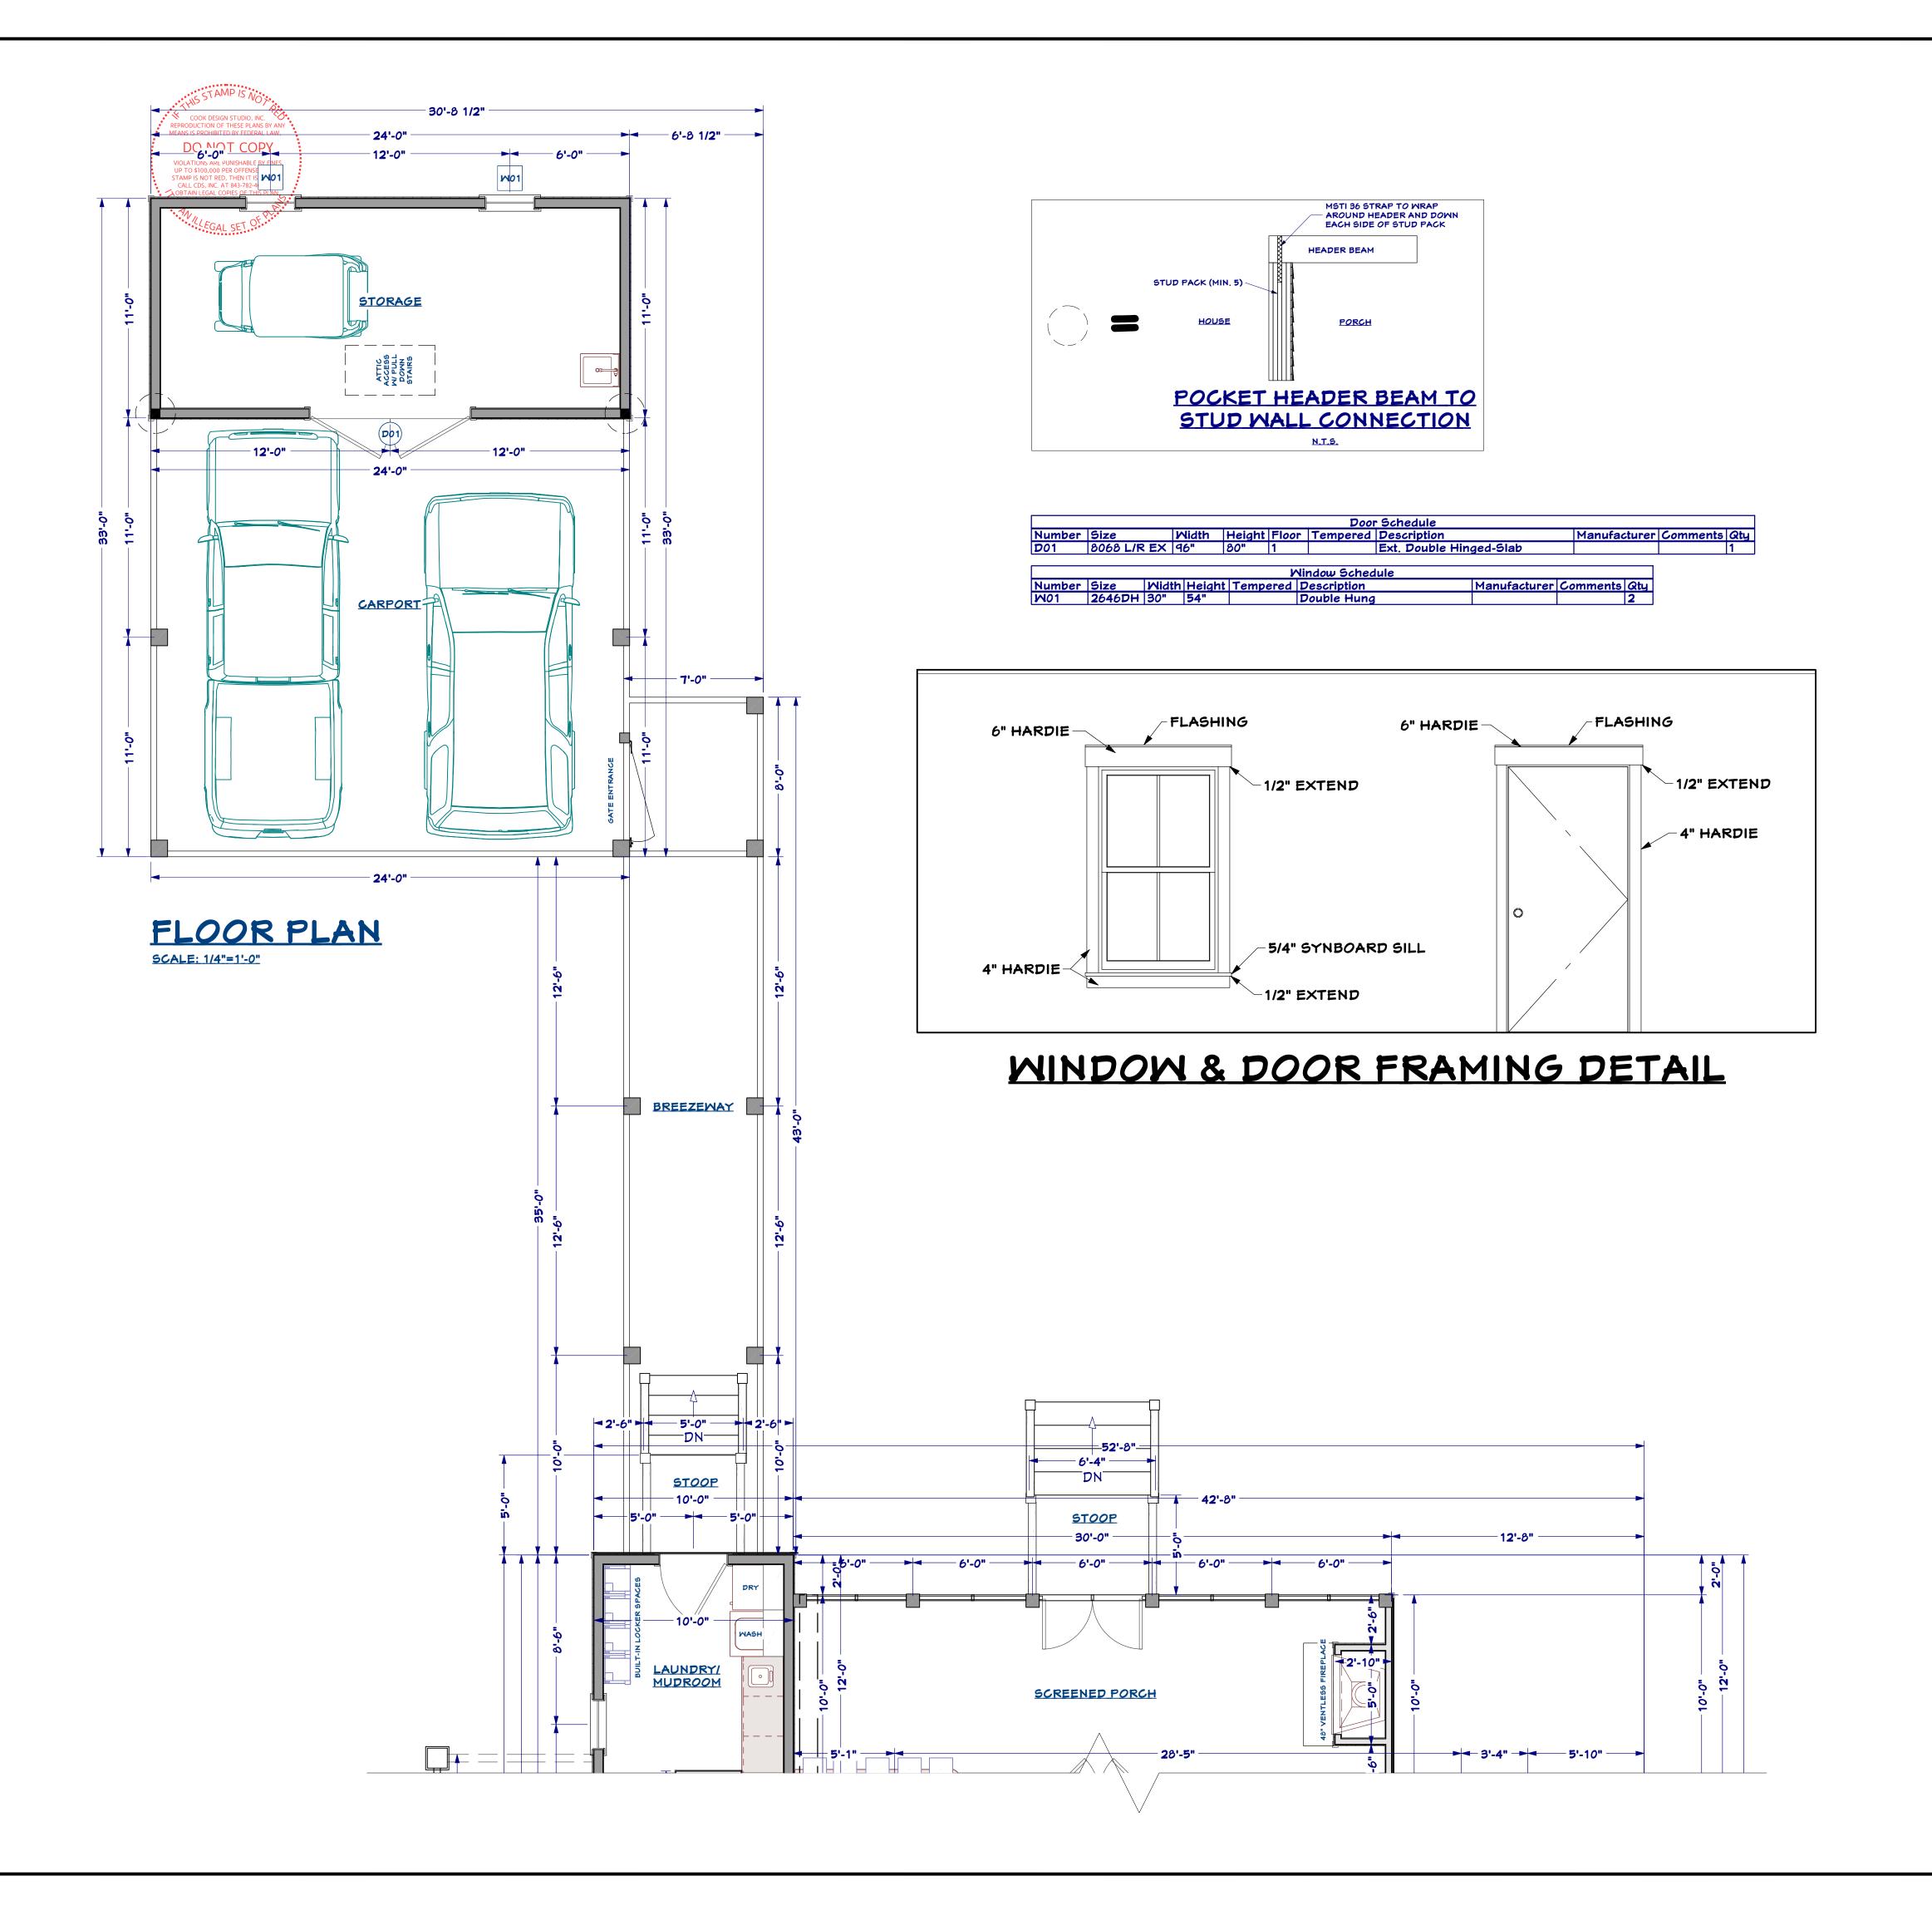


TO THE BEST OF MY KNOWLEDGE THESE PLANS ARE DRAWN TO COMPLY WITH THE HOMEOWNER'S AND/OR BUILDER'S SPECIFICATIONS AND ANY CHANGES MADE TO THEM AFTER PRINTS ARE MADE WILL BE DONE AT THE HOMEOWNER'S AND/ OR BUILDER'S EXPENSE AND RESPONSIBILITY. THE CONTRACTOR SHALL VERIFY ALL DIMENSIONS AND ENCLOSED DRAWINGS PRIOR TO CONSTRUCTION. COOK DESIGN STUDIO, INC. IS NOT LIABLE FOR ERRORS ONCE CONSTRUCTION HAS BEGUN. WHILE EYERY EFFORT HAS BEEN MADE IN THE PREPARATION OF THIS PLAN TO AVOID MISTAKES, THE MAKER CAN NOT GUARANTEE AGAINST HUMAN ERROR. THE CONTRACTOR OF THE JOB MUST CHECK ALL DIMENSIONS AND OTHER DETAILS PRIOR TO CONSTRUCTION AND IS SOLELY RESPONSIBLE THEREAFTER.

HOMEOWNER WILL TAKE THE NECESSARY PRECAUTIONS TO REMOVE OR RELOCATE ITEMS OF VALUE TO BE REUSED AND/ OR SAVED, OR IN ANY DANGER OF BEING DAMAGED DUE TO CONSTRUCTION PROCESS. CONTRACTOR SHALL VERIFY ALL DIMENSIONS AND CONDITIONS ON SITE BEFORE CONSTRUCTION BEGINS. ANY DISCREPANCIES SHALL BE REPORTED TO COOK DESIGN STUDIO, INC. FOR CORRECTIONS BEFORE PROCEEDING WITH CONSTRUCTION. CONTRACTOR AND/OR HOMEOWNER SHALL ASSUME RESPONSIBILITY FOR ERRORS THAT ARE NOT REPORTED.

### DRAWING NOTES:

- DRAWINGS ARE NOT INTENDED TO BE SCALED. EXISTING CONDITIONS TO BE FIELD VERIFIED BY THE CONTRACTOR PRIOR TO CONSTRUCTION.
- THE DESIGNER IS TO BE NOTIFIED OF ANY VARIATIONS FROM THE DRAWING SPECIFICATIONS. 4. ALL DRAWINGS AND SPECIFICATIONS INCLUDED IN
- THIS DRAWING SET ARE SPECIFIC TO THIS PARTICULAR SITE LOCATION/BUILDING AND ARE THE PROPERTY OF COOK DESIGN STUDIO, INC. ANY UNAUTHORIZED USE OR REPRODUCTION OF THIS INFORMATION IS SUBJECT TO LEGAL PROSECUTION.

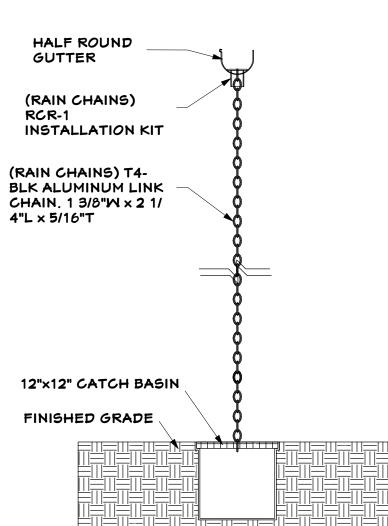

# RAIN CHAIN DETAIL

THIS PLAN IS THE PROPERTY OF COOK DESIGN STUDIO, INC. THE PURCHASER OF THIS PLAN IS GRANTED THE RIGHT TO CONSTRUCT A TOTAL OF ONLY ONE PROJECT FROM THIS PLAN, IT IS UNLAWF TROJECT FROM THIS PLAN, IT IS UNLAWFUL
TO REPRODUCE ANY PART OF THIS PLAN
EITHER ON PAPER OR ON SITE, WITHOUT
THE WRITTEN CONSENT FROM THE
DESIGNER, CONSTRUCTION OF THIS PLAN
IS TO BE IN CONFORMATION WITH ALL
LOCAL ORDINANCES AND BLDG, CODES
APPLICABLE, CONTRACTOR AND SUB-

CONTRACTORS SHOULD CHECK ALL DRAWINGS PRIOR TO CONSTRUCTION

MEMBER BD BUILDING DESIGN



COOK DESIGN STUDIO,

WALTERBORO, SC 29488 (843) 782-4077

DRAWN BY:

6858-177-2025 04-30-2025

A101



FRONT ELEVATION

SCALE: 1/4"=1'-0"



REAR ELEVATION


SCALE: 1/4"=1'-0"

TO THE BEST OF MY KNOWLEDGE THESE PLANS ARE DRAWN TO COMPLY WITH THE HOMEOWNER'S AND/OR BUILDER'S SPECIFICATIONS AND ANY CHANGES MADE TO THEM AFTER PRINTS ARE MADE WILL BE DONE AT THE HOMEOWNER'S AND/OR BUILDER'S EXPENSE AND RESPONSIBILITY. THE CONTRACTOR SHALL VERIFY ALL DIMENSIONS AND ENCLOSED DRAWINGS PRIOR TO CONSTRUCTION. COOK DESIGN STUDIO, INC. IS NOT LIABLE FOR ERRORS ONCE CONSTRUCTION HAS BEGUN. WHILE EVERY EFFORT HAS BEEN MADE IN THE PREPARATION OF THIS PLAN TO AVOID MISTAKES, THE MAKER CAN NOT GUARANTEE AGAINST HUMAN ERROR. THE CONTRACTOR OF THE JOB MUST CHECK ALL DIMENSIONS AND OTHER DETAILS PRIOR TO CONSTRUCTION AND IS SOLELY RESPONSIBLE THEREAFTER.

HOMEOWNER WILL TAKE THE NECESSARY PRECAUTIONS TO REMOVE OR RELOCATE ITEMS OF VALUE TO BE REUSED AND/OR SAYED, OR IN ANY DANGER OF BEING DAMAGED DUE TO CONSTRUCTION PROCESS. CONTRACTOR SHALL VERIFY ALL DIMENSIONS AND CONDITIONS ON SITE BEFORE CONSTRUCTION BEGINS. ANY DISCREPANCIES SHALL BE REPORTED TO COOK DESIGN STUDIO, INC. FOR CORRECTIONS BEFORE PROCEEDING WITH CONSTRUCTION. CONTRACTOR AND/OR HOMEOWNER SHALL ASSUME RESPONSIBILITY FOR ERRORS THAT ARE NOT REPORTED.

## DRAWING NOTES:

- DRAWINGS ARE NOT INTENDED TO BE SCALED.
   EXISTING CONDITIONS TO BE FIELD VERIFIED BY THE CONTRACTOR PRIOR TO CONSTRUCTION.
- 3. THE DESIGNER IS TO BE NOTIFIED OF ANY VARIATIONS FROM THE DRAWING SPECIFICATIONS.
- 4. ALL DRAWINGS AND SPECIFICATIONS INCLUDED IN THIS DRAWING SET ARE SPECIFIC TO THIS PARTICULAR SITE LOCATION/BUILDING AND ARE THE PROPERTY OF COOK DESIGN STUDIO, INC. ANY UNAUTHORIZED USE OR REPRODUCTION OF THIS INFORMATION IS SUBJECT TO LEGAL PROSECUTION.

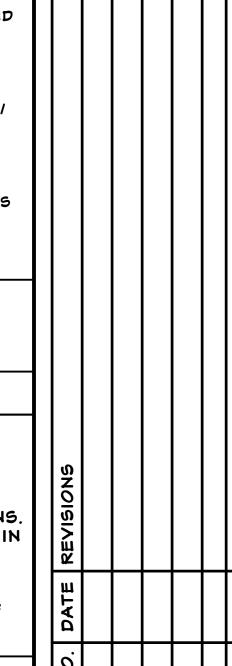

THIS PLAN IS THE PROPERTY OF COOK
DESIGN STUDIO, INC. THE PURCHASER OF
THIS PLAN IS GRANTED THE RIGHT TO
CONSTRUCT A TOTAL OF ONLY ONE
PROJECT FROM THIS PLAN. IT IS UNLAWFUL
TO REPORT INC. ANY PRAFT OF THIS PLAN.

TROJECT FROM THIS PLAN, IT IS UNLAWFUL
TO REPRODUCE ANY PART OF THIS PLAN
EITHER ON PAPER OR ON SITE, WITHOUT
THE WRITTEN CONSENT FROM THE
DESIGNER. CONSTRUCTION OF THIS PLAN
IS TO BE IN CONFORMATION WITH ALL
LOCAL ORDINANCES AND BLDG. CODES
APPLICABLE. CONTRACTOR AND SUB-

CONTRACTORS SHOULD CHECK ALL DRAWINGS PRIOR TO CONSTRUCTION

> Jian & Amanda Mingard 41 Stock Farm Road Bluffton, SC 29910

MEMBER

A

B

D

BD R

AMERICAN INSTITUTE of
BUILDING DESIGN



SEAL DATE: 04-30-2025

COOK DESIGN STUDIO,


804 WICHMAN STREET WALTERBORO, SC 29488 (843) 782-4077

DRAWN BY:
CHECK BY:

6858-177-2025 E: 04-30-2025

A201




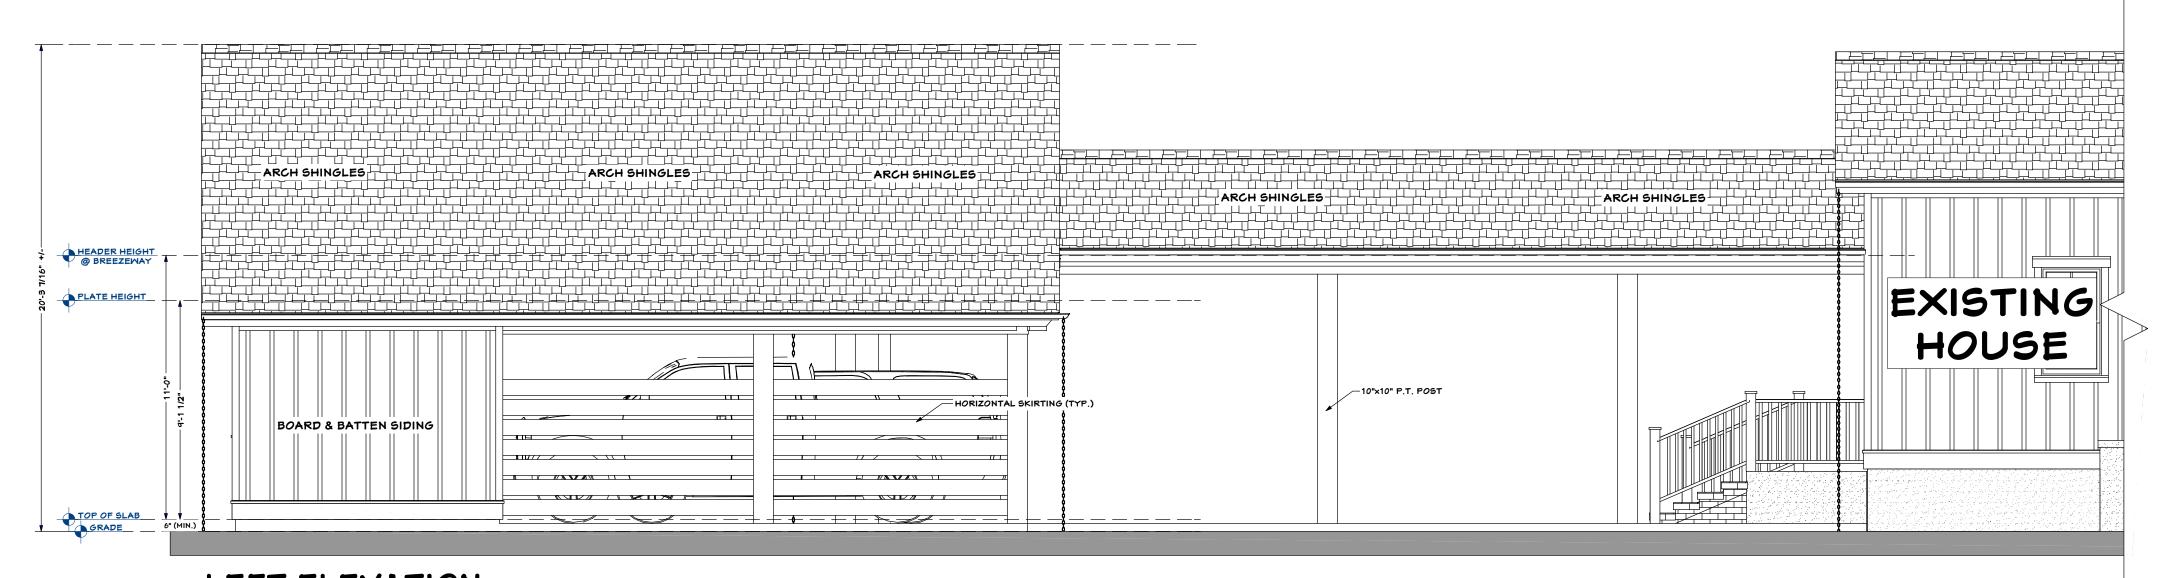

LEFT ELEVATION

SCALE: 1/4"=1'-0"

SCALE: 1/4"=1'-0"

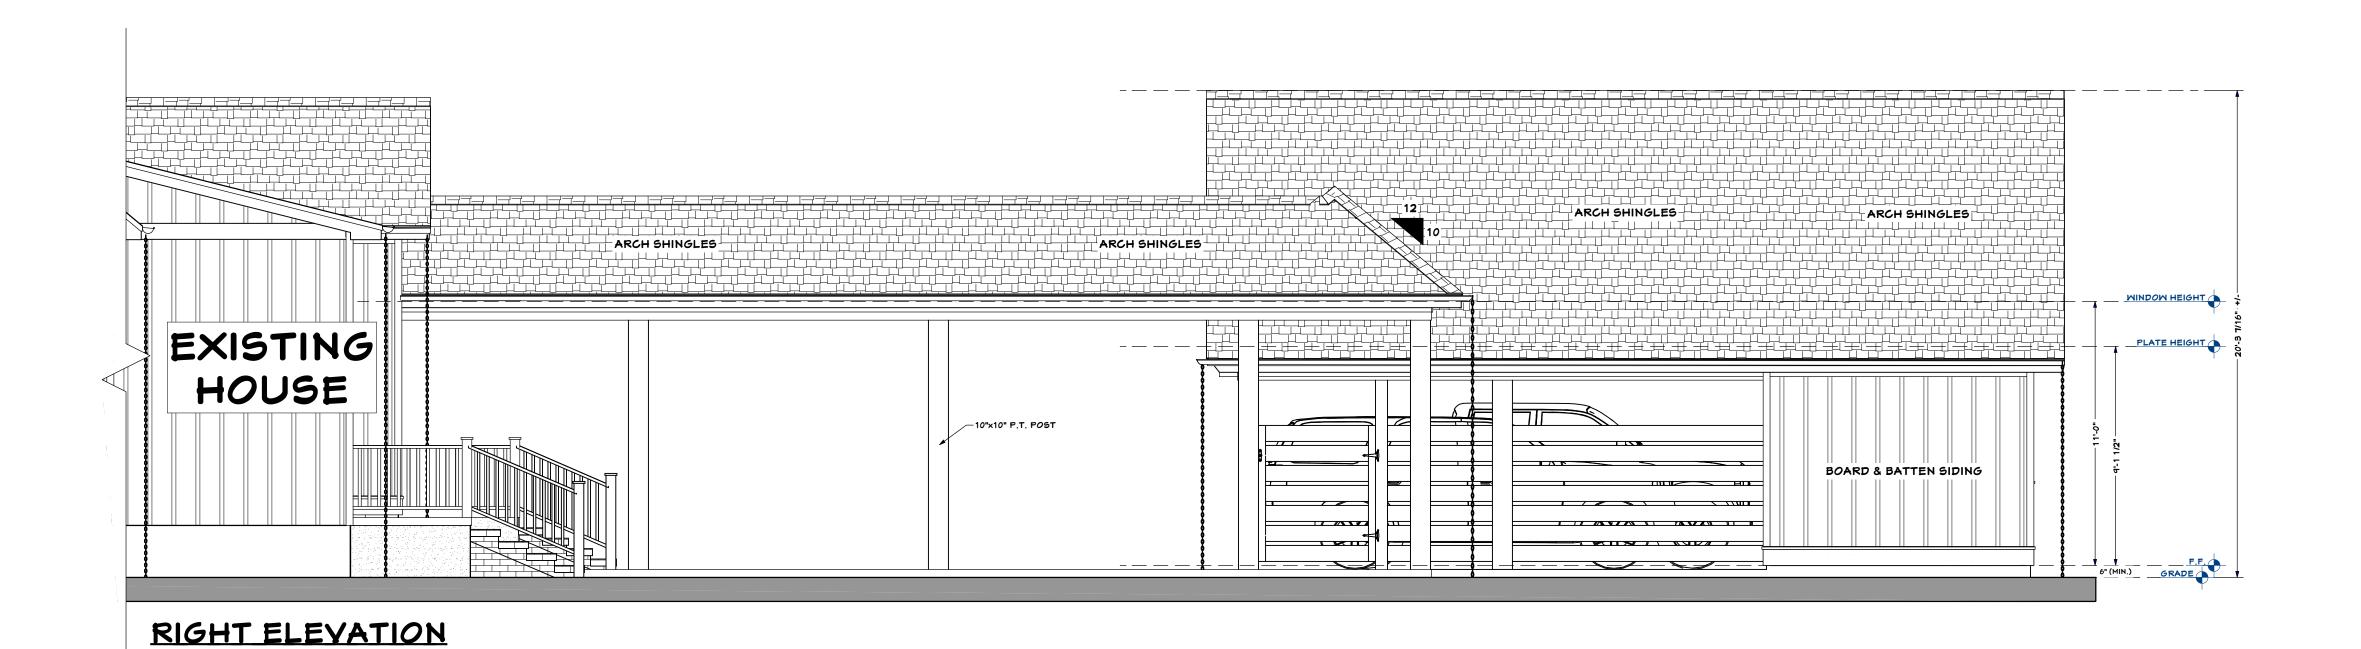

TO THE BEST OF MY KNOWLEDGE THESE PLANS ARE DRAWN TO COMPLY WITH THE HOMEOWNER'S AND/OR BUILDER'S SPECIFICATIONS AND ANY CHANGES MADE TO THEM AFTER PRINTS ARE MADE WILL BE DONE AT THE HOMEOWNER'S AND/OR BUILDER'S EXPENSE AND RESPONSIBILITY. THE CONTRACTOR SHALL VERIFY ALL DIMENSIONS AND ENCLOSED DRAWINGS PRIOR TO CONSTRUCTION. COOK DESIGN STUDIO, INC. IS NOT LIABLE FOR ERRORS ONCE CONSTRUCTION HAS BEGUN. WHILE EVERY EFFORT HAS BEEN MADE IN THE PREPARATION OF THIS PLAN TO AVOID MISTAKES, THE MAKER CAN NOT GUARANTEE AGAINST HUMAN ERROR. THE CONTRACTOR OF THE JOB MUST CHECK ALL DIMENSIONS AND OTHER DETAILS PRIOR TO CONSTRUCTION AND IS SOLELY RESPONSIBLE THEREAFTER.

HOMEOWNER WILL TAKE THE NECESSARY PRECAUTIONS TO REMOVE OR RELOCATE ITEMS OF VALUE TO BE REUSED AND/OR SAVED, OR IN ANY DANGER OF BEING DAMAGED DUE TO CONSTRUCTION PROCESS. CONTRACTOR SHALL VERIFY ALL DIMENSIONS AND CONDITIONS ON SITE BEFORE CONSTRUCTION BEGINS. ANY DISCREPANCIES SHALL BE REPORTED TO COOK DESIGN STUDIO, INC. FOR CORRECTIONS BEFORE PROCEEDING WITH CONSTRUCTION. CONTRACTOR AND/OR HOMEOWNER SHALL ASSUME RESPONSIBILITY FOR ERRORS THAT ARE NOT REPORTED.

## DRAWING NOTES:

- DRAWINGS ARE NOT INTENDED TO BE SCALED.
   EXISTING CONDITIONS TO BE FIELD VERIFIED BY THE CONTRACTOR PRIOR TO CONSTRUCTION.
   THE DESIGNER IS TO BE NOTIFIED OF ANY
- VARIATIONS FROM THE DRAWING SPECIFICATIONS.

  4. ALL DRAWINGS AND SPECIFICATIONS INCLUDED IN THIS DRAWING SET ARE SPECIFIC TO THIS PARTICULAR SITE LOCATION/BUILDING AND ARE THE PROPERTY OF COOK DESIGN STUDIO, INC. ANY UNAUTHORIZED USE OR REPRODUCTION OF THIS INFORMATION IS SUBJECT TO LEGAL

PROSECUTION.

THIS PLAN IS THE PROPERTY OF COOK DESIGN STUDIO, INC. THE PURCHASER OF THIS PLAN IS GRANTED THE RIGHT TO CONSTRUCT A TOTAL OF ONLY ONE PROJECT FROM THIS PLAN. IT IS UNLAWFUL TO REPRODUCE ANY PART OF THIS PLAN EITHER ON PAPER OR ON SITE, WITHOUT THE WRITTEN CONSENT FROM THE DESIGNER, CONSTRUCTION OF THIS PLAN IS TO BE IN CONFORMATION WITH ALL LOCAL ORDINANCES AND BLDG. CODES APPLICABLE. CONTRACTOR AND SUB-CONTRACTOR AND SUB-

CONTRACTORS SHOULD CHECK ALL DRAWINGS PRIOR TO CONSTRUCTION

NO. DATE REVISIONS

Dylan & Amanda Mings 41 Stock Farm Road Bluffton, SC 24410

MEMBER
A
B
D

AMERICAN INSTITUTE of BUILDING DESIGN

I · C · B · D · C

NATIONAL COUNCIL OF OR STATE OF STA

Scott Cook
CERTIFICATION NO. 41-117

TM

EAL DATE: 04-30-20

SEAL DATE: 04-30-202


PISION CONTINUED CONTINUED

804 WICHMAN STREET WALTERBORO, SC 29488 (843) 782-4077


DRAWN BY:
CHECK BY:

B: **6858-177-2025**TE: **04-30-2025** 

A202

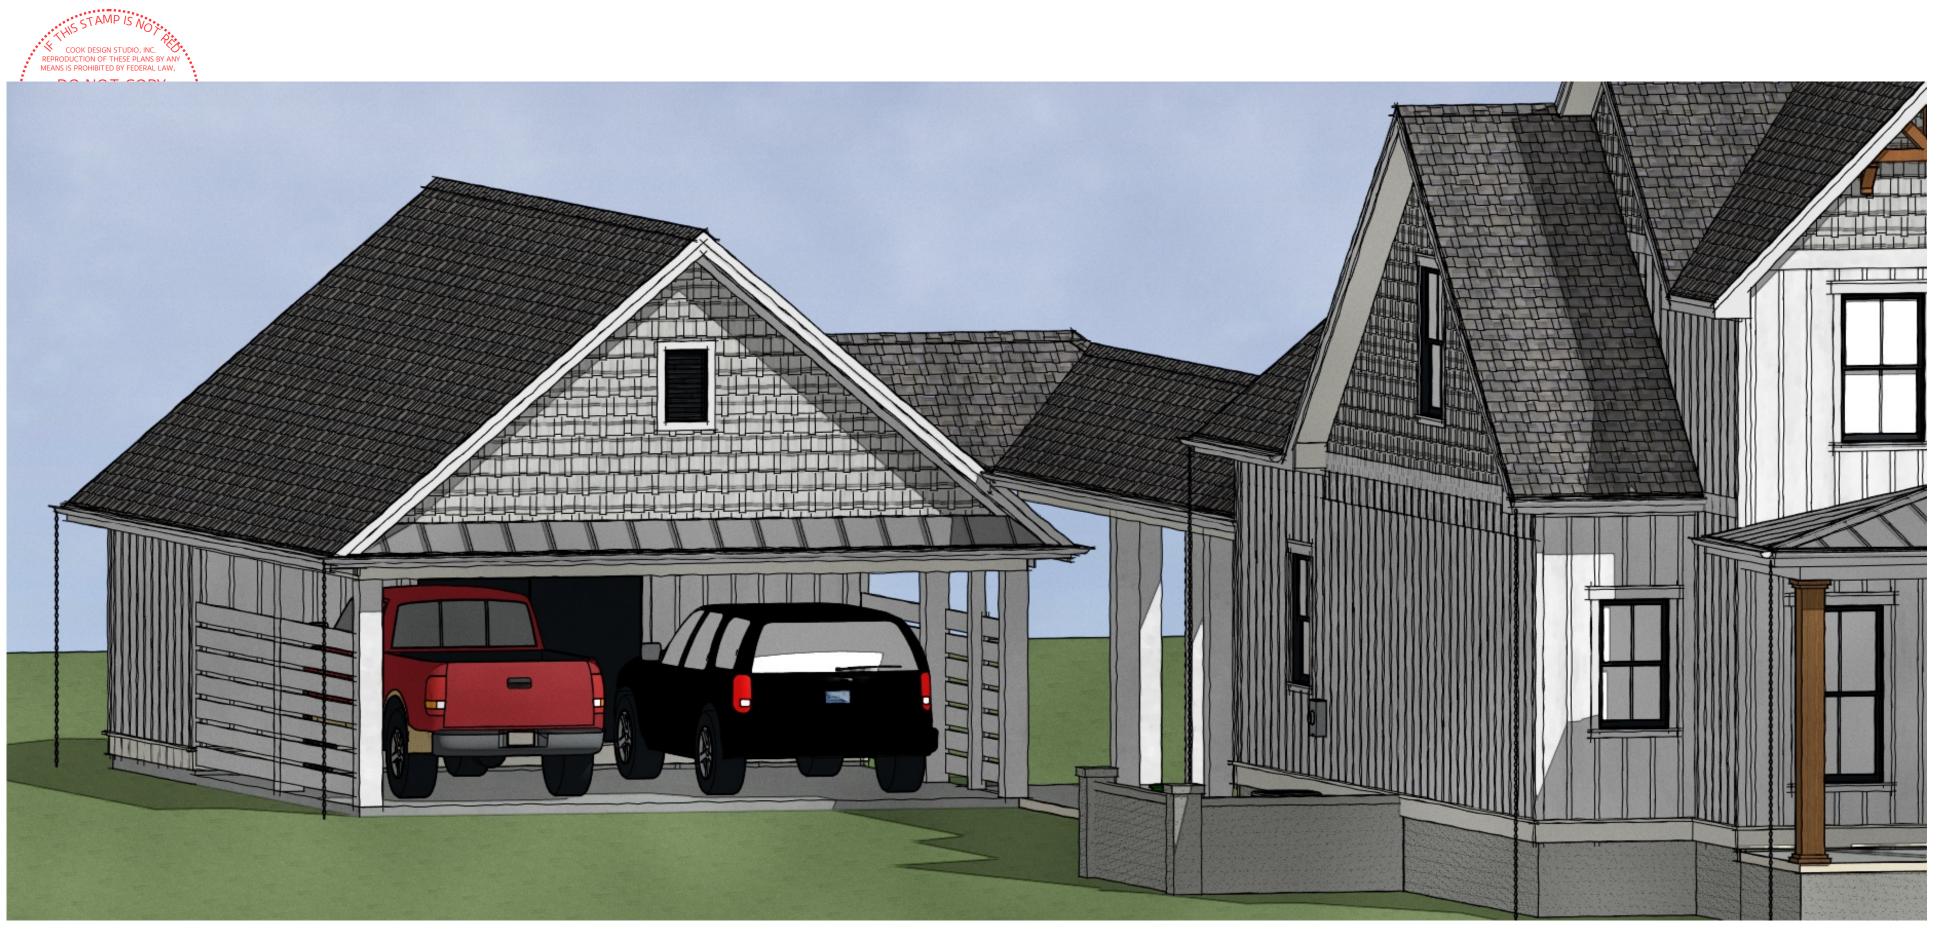

3D FRONT EXTERIOR RENDERING

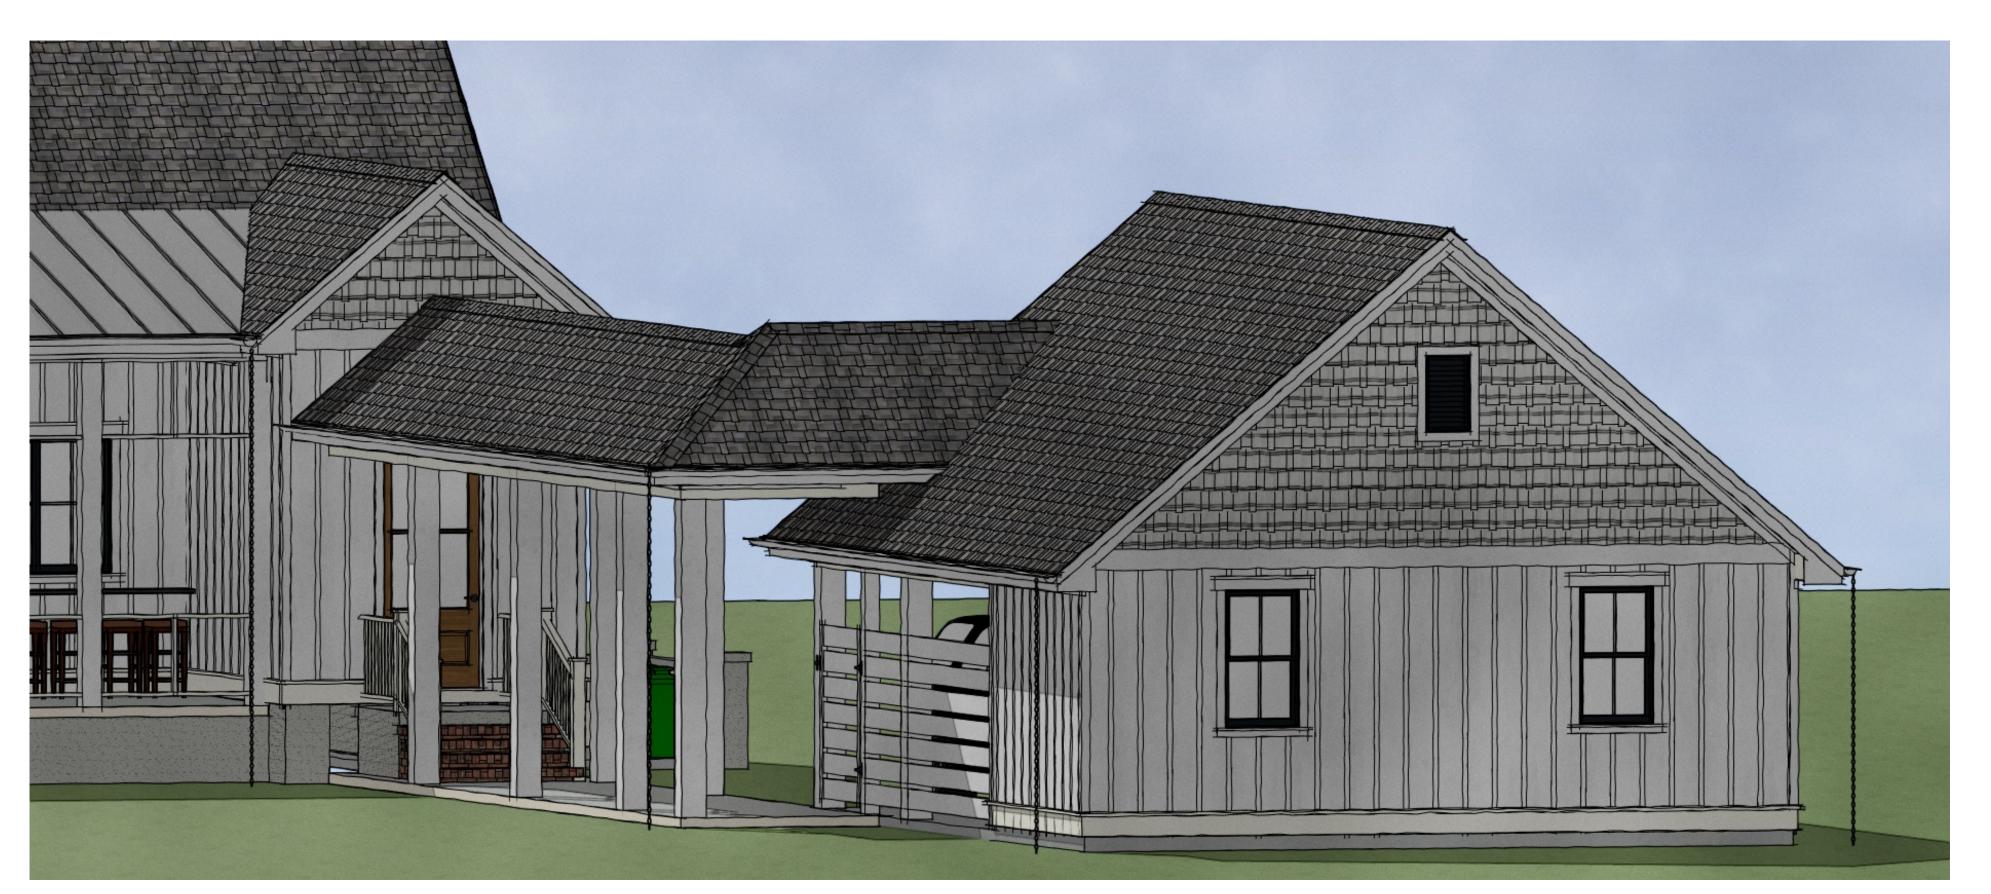

3D REAR EXTERIOR RENDERING

N.T.S.

N.T.S.

TO THE BEST OF MY KNOWLEDGE THESE PLANS ARE DRAWN TO COMPLY WITH THE HOMEOWNER'S AND/OR BUILDER'S SPECIFICATIONS AND ANY CHANGES MADE TO THEM AFTER PRINTS ARE MADE WILL BE DONE AT THE HOMEOWNER'S AND/OR BUILDER'S EXPENSE AND RESPONSIBILITY. THE CONTRACTOR SHALL VERIFY ALL DIMENSIONS AND ENCLOSED DRAWINGS PRIOR TO CONSTRUCTION. COOK DESIGN STUDIO, INC. IS NOT LIABLE FOR ERRORS ONCE CONSTRUCTION HAS BEGUN. WHILE EVERY EFFORT HAS BEEN MADE IN THE PREPARATION OF THIS PLAN TO AVOID MISTAKES, THE MAKER CAN NOT GUARANTEE AGAINST HUMAN ERROR. THE CONTRACTOR OF THE JOB MUST CHECK ALL DIMENSIONS AND OTHER DETAILS PRIOR TO CONSTRUCTION AND IS SOLELY RESPONSIBLE THEREAFTER.

HOMEOWNER WILL TAKE THE NECESSARY PRECAUTIONS TO REMOVE OR RELOCATE ITEMS OF VALUE TO BE REUSED AND/OR SAVED, OR IN ANY DANGER OF BEING DAMAGED DUE TO CONSTRUCTION PROCESS. CONTRACTOR SHALL VERIFY ALL DIMENSIONS AND CONDITIONS ON SITE BEFORE CONSTRUCTION BEGINS. ANY DISCREPANCIES SHALL BE REPORTED TO COOK DESIGN STUDIO, INC. FOR CORRECTIONS BEFORE PROCEEDING WITH CONSTRUCTION. CONTRACTOR AND/OR HOMEOWNER SHALL ASSUME RESPONSIBILITY FOR ERRORS THAT ARE NOT REPORTED.

## DRAWING NOTES:

- DRAWINGS ARE NOT INTENDED TO BE SCALED.
   EXISTING CONDITIONS TO BE FIELD VERIFIED BY THE CONTRACTOR PRIOR TO CONSTRUCTION.
   THE DESIGNER IS TO BE NOTIFIED OF ANY
- VARIATIONS FROM THE DRAWING SPECIFICATIONS.

  4. ALL DRAWINGS AND SPECIFICATIONS INCLUDED IN THIS DRAWING SET ARE SPECIFIC TO THIS PARTICULAR SITE LOCATION/BUILDING AND ARE THE PROPERTY OF COOK DESIGN STUDIO, INC. ANY UNAUTHORIZED USE OR REPRODUCTION OF

THIS INFORMATION IS SUBJECT TO LEGAL

PROSECUTION.

THIS PLAN IS THE PROPERTY OF COOK DESIGN STUDIO, INC. THE PURCHASER OF THIS PLAN IS GRANTED THE RIGHT TO CONSTRUCT A TOTAL OF ONLY ONE PROJECT FROM THIS PLAN. IT IS UNLAWFUL TO REPRODUCE ANY PART OF THIS PLAN EITHER ON PAPER OR ON SITE, WITHOUT THE WRITTEN CONSENT FROM THE DESIGNER. CONSTRUCTION OF THIS PLAN IS TO BE IN CONFORMATION WITH ALL LOCAL ORDINANCES AND BLDG. CODES APPLICABLE. CONTRACTOR AND SUBCONTRACTORS SHOULD CHECK ALL DRAWINGS PRIOR TO CONSTRUCTION.


	NO. DATE REVISIONS				
	DATE				
	NO.	1			

Jan & Amanda Minga 41 Stock Farm Road

MEMBER
A I

B D

AMERICAN INSTITUTE of
BUILDING DESIGN

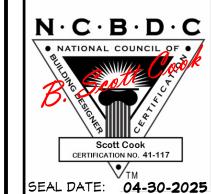

COOK DESIGN STUDIO,



804 WICHMAN STREET WALTERBORO, SC 29488 (843) 782-4077

 DRAWN BY:
 BSC


 CHECK BY:
 WHB


 JOB:
 6858-177-2025

A301

04-30-2025



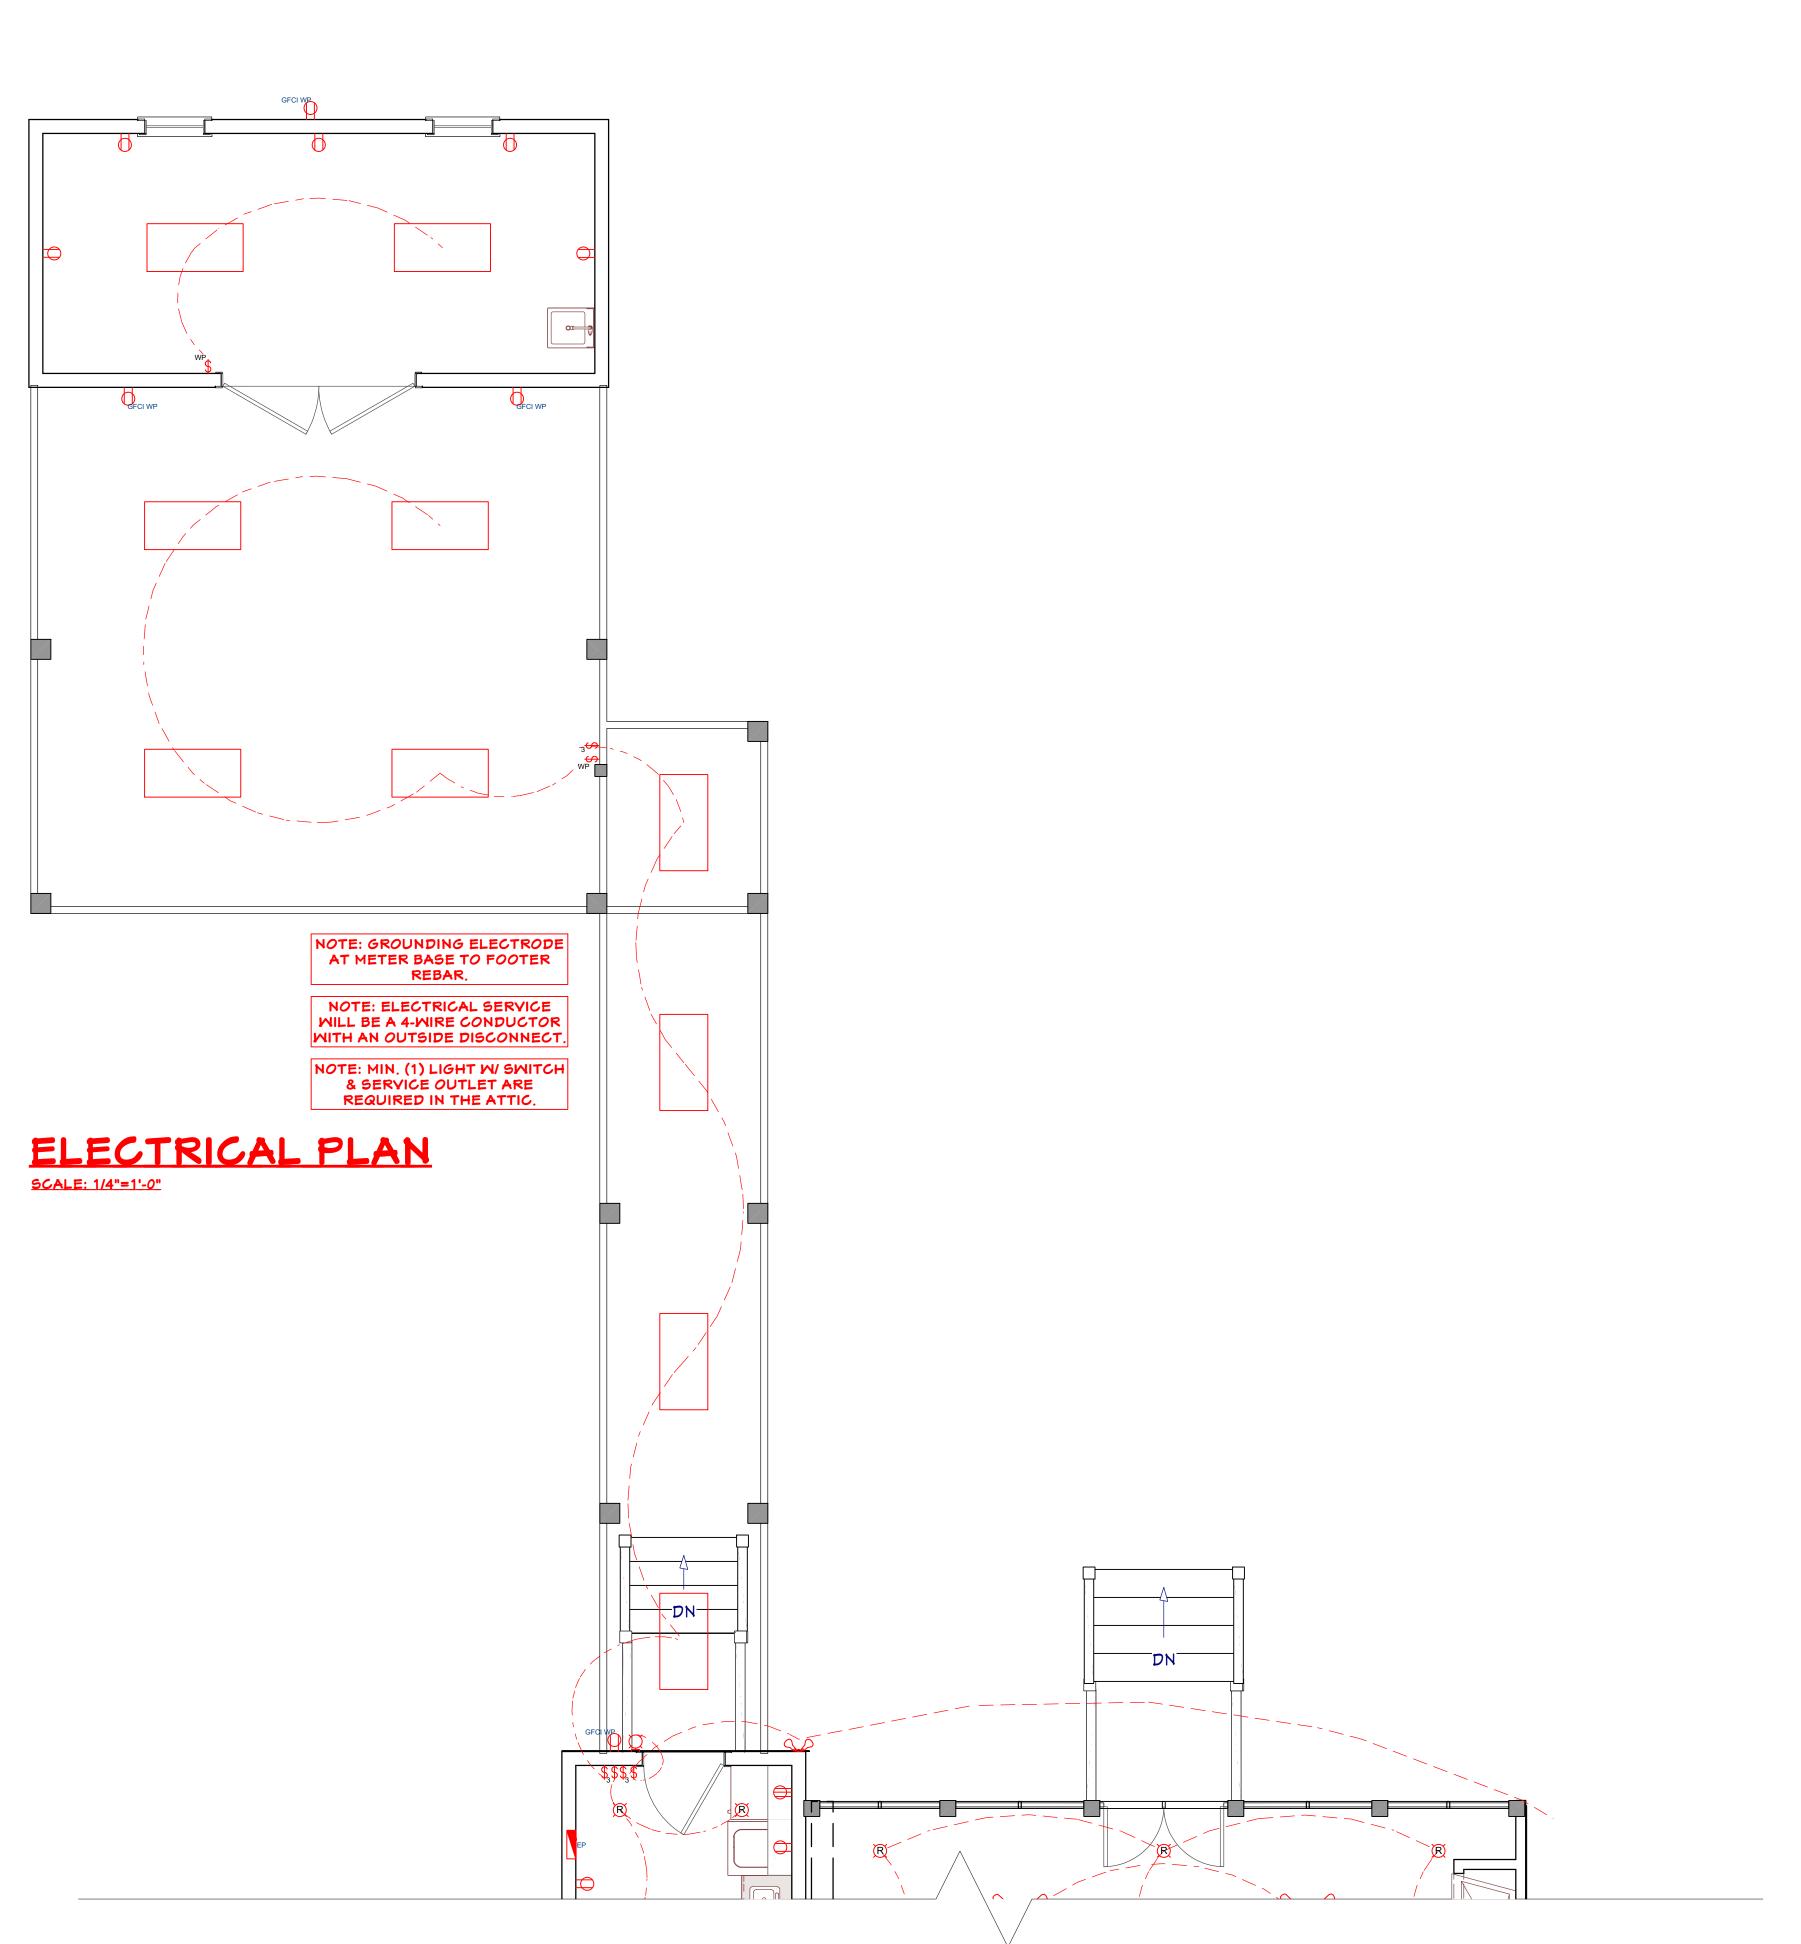

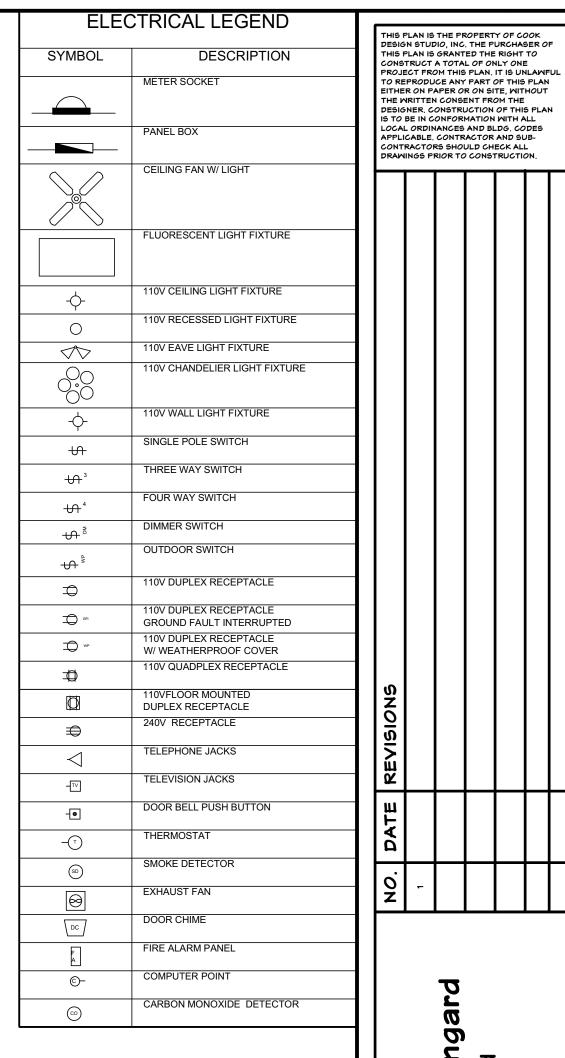

Dylan & Amanda Mingar


MEMBER

A

B

B

AMERICAN INSTITUTE of
BUILDING DESIGN

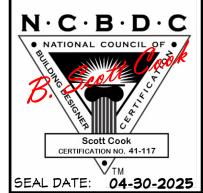

COOK DESIGN STUDIO, Inc.




804 WICHMAN STREET WALTERBORO, SC 29488 (843) 782-4077

 DRAWN BY:
 BSC

 CHECK BY:
 WHB


 JOB:
 6858-177-2025

04-30-2025

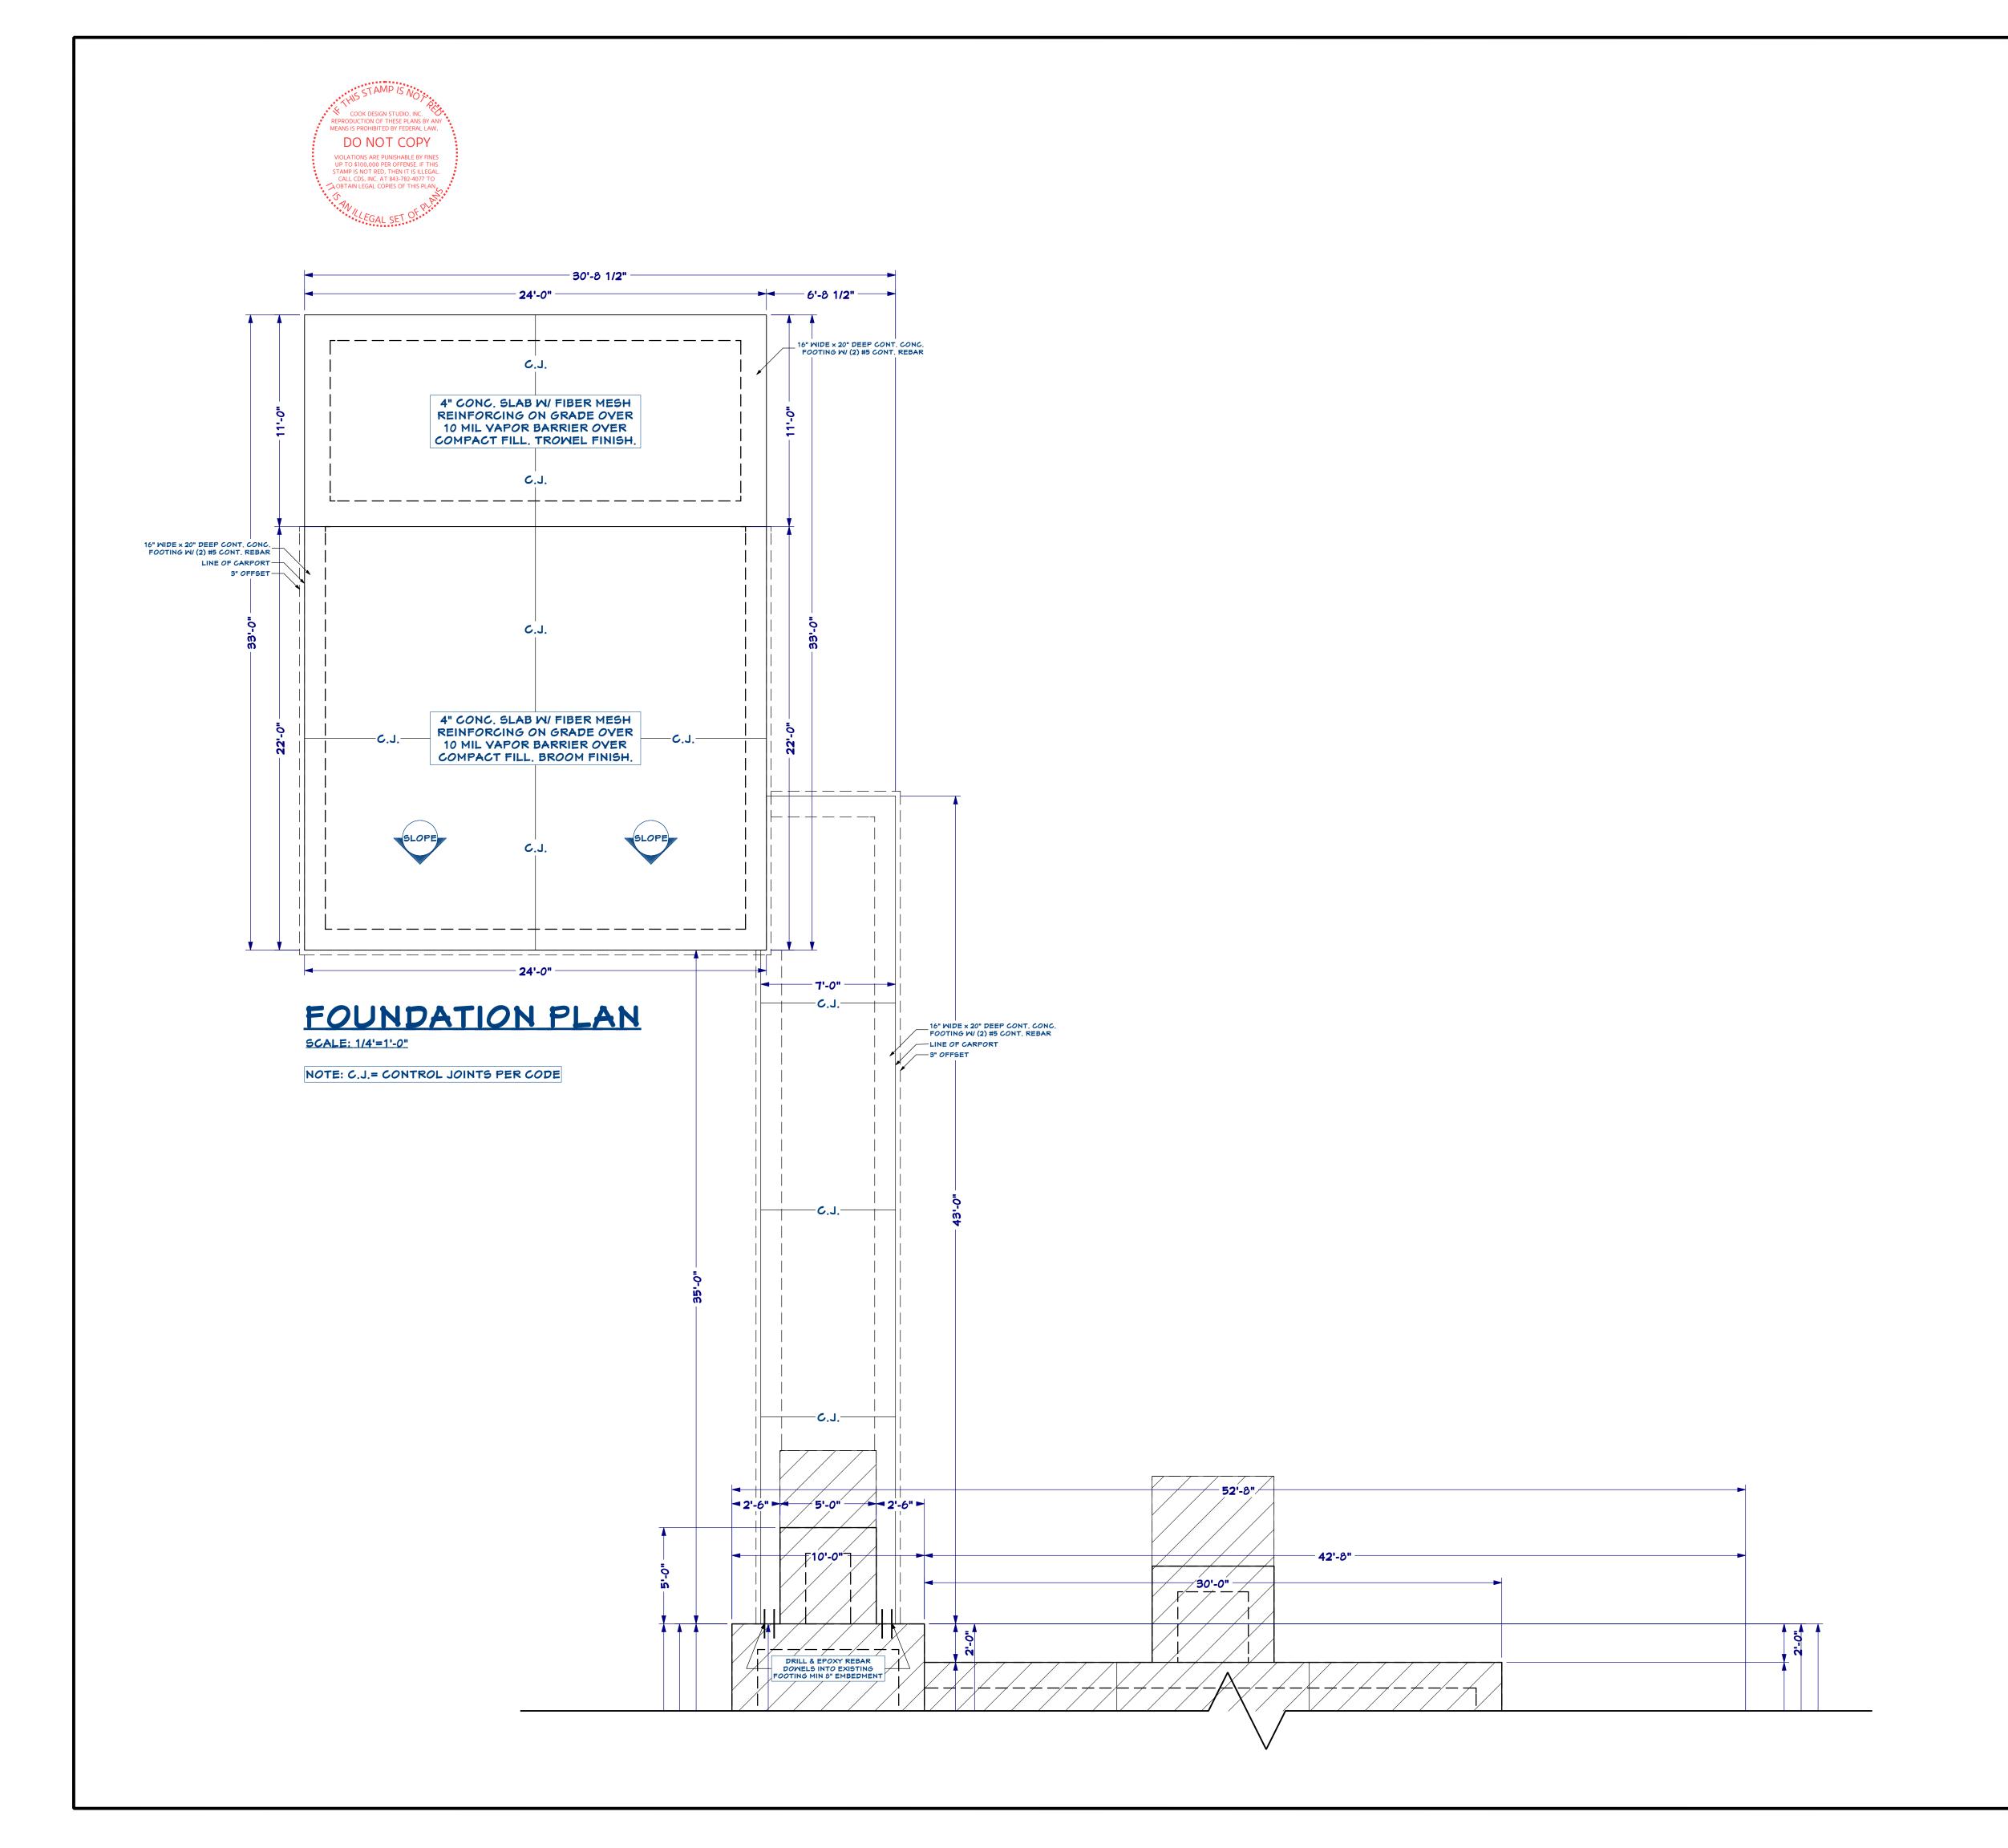



THIS PLAN IS THE PROPERTY OF WILLIAM H. BRANHAM III, P.E. THE PURCHASER OF THIS PLAN IS GRANTED THE RIGHT TO CONSTRUCT A TOTAL OF ONLY ONE PROJECT FROM THIS PLAN. IT IS UNLAWFUL TO REPRODUCE ANY PART OF THIS PLAN EITHER ON PAPER OR ON SITE, WITHOUT THE WRITTEN CONSENT FROM WILLIAM H. BRANHAM III, P.E. CONSTRUCTION OF THIS PLAN IS TO BE IN CONFORMATION WITH ALL LOCAL ORDINANCES AND BLDG. CODES APPLICABLE. CONTRACTOR AND SUBCONTRACTORS SHOULD CHECK ALL DRAWINGS PRIOR TO CONSTRUCTION.			
NO. DATE REVISIONS			
DATE			
NO.	-		
PREPARED FOR:	Dylan & Amanda Mingard 41 Stock Farm Road Bluffton, SC 29910		
SFA	No.16901 BO		
DRA	## WILLIAM H. BRANHAM III, P.E SOS 141 P.E SOS 147 P.E SOS 147 P.E SOS 147 P.E SOS 147 P.E SOS 1465 P.E P.E SOS 1465 P.E		
	3101		



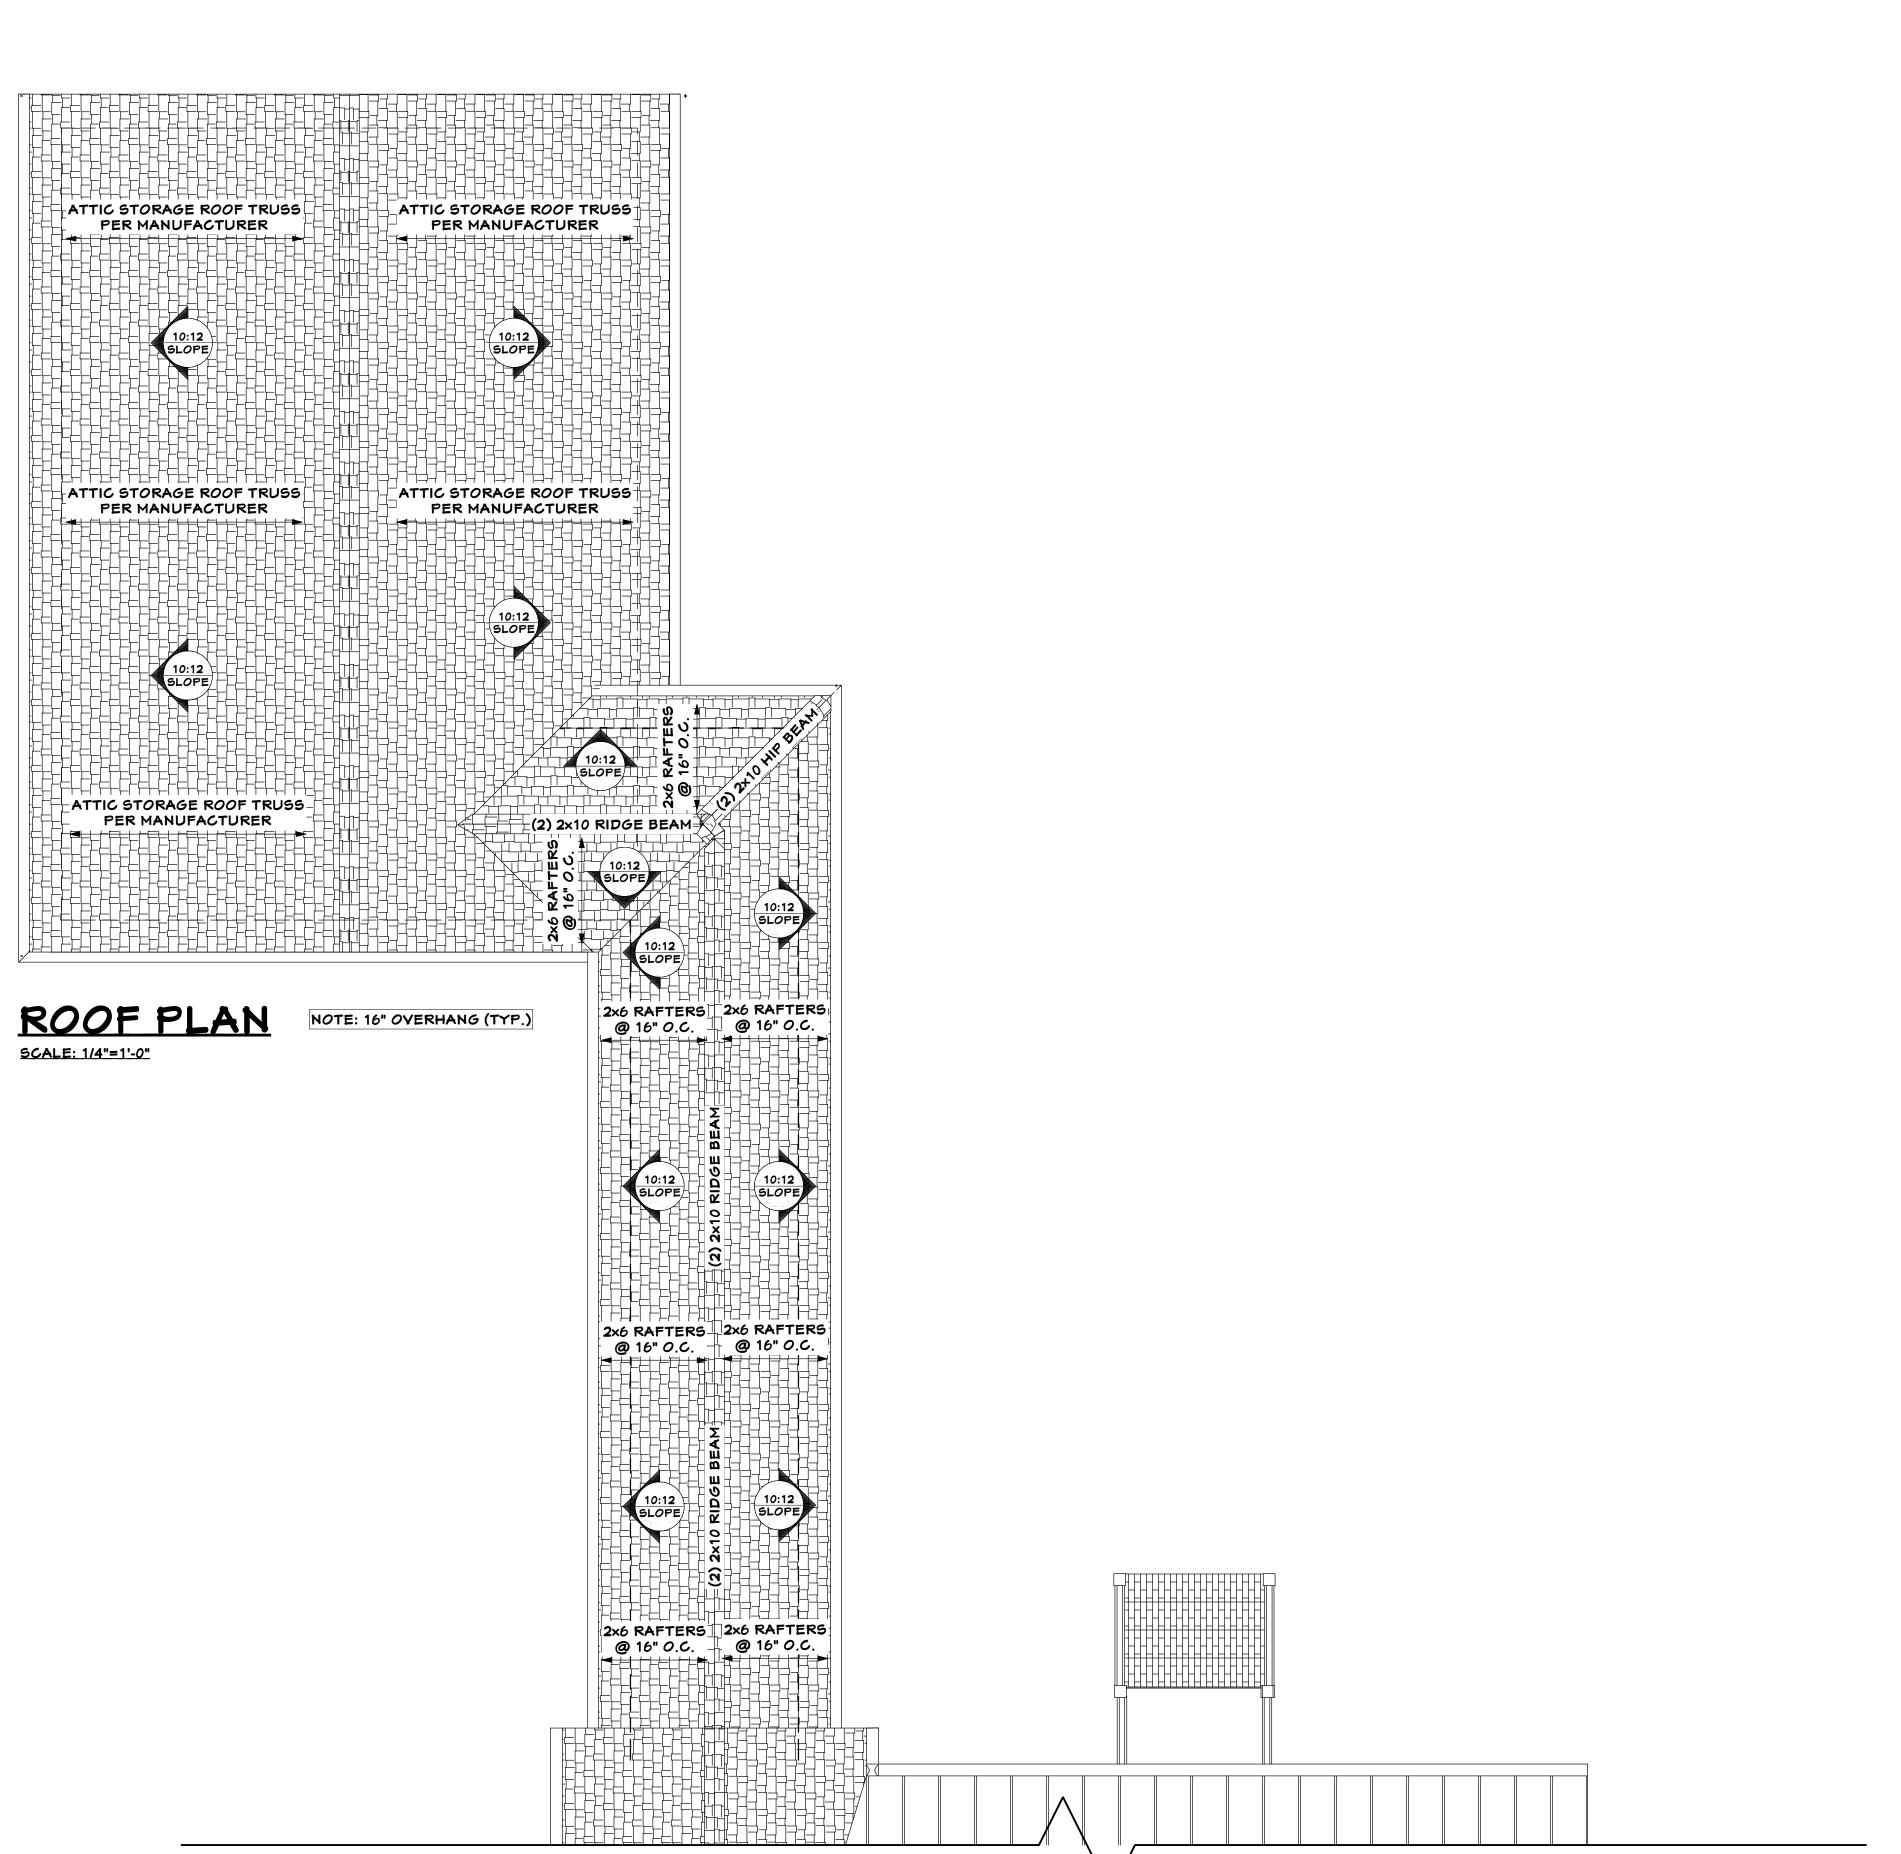

THIS PLAN IS THE PROPERTY OF WILLIAM H. BRANHAM III, P.E. THE PURCHASER OF THIS PLAN IS GRANTED THE RIGHT TO CONSTRUCT A TOTAL OF ONLY ONE PROJECT FROM THIS PLAN. IT IS UNLAWFUL TO REPRODUCE ANY PART OF THIS PLAN EITHER ON PAPER OR ON SITE, WITHOUT THE WRITTEN CONSENT FROM WILLIAM H. BRANHAM III, P.E. CONSTRUCTION OF THIS PLAN IS TO BE IN CONFORMATION WITH ALL LOCAL ORDINANCES AND BLDG. CODES APPLICABLE. CONTRACTOR AND SUBCONTRACTORS SHOULD CHECK ALL DRAWINGS PRIOR TO CONSTRUCTION. Ming Dylan SEAL DATE: 04-30-2025 DRAWN BY: CHECK BY: 6858-177-2025 04-30-2025 5102

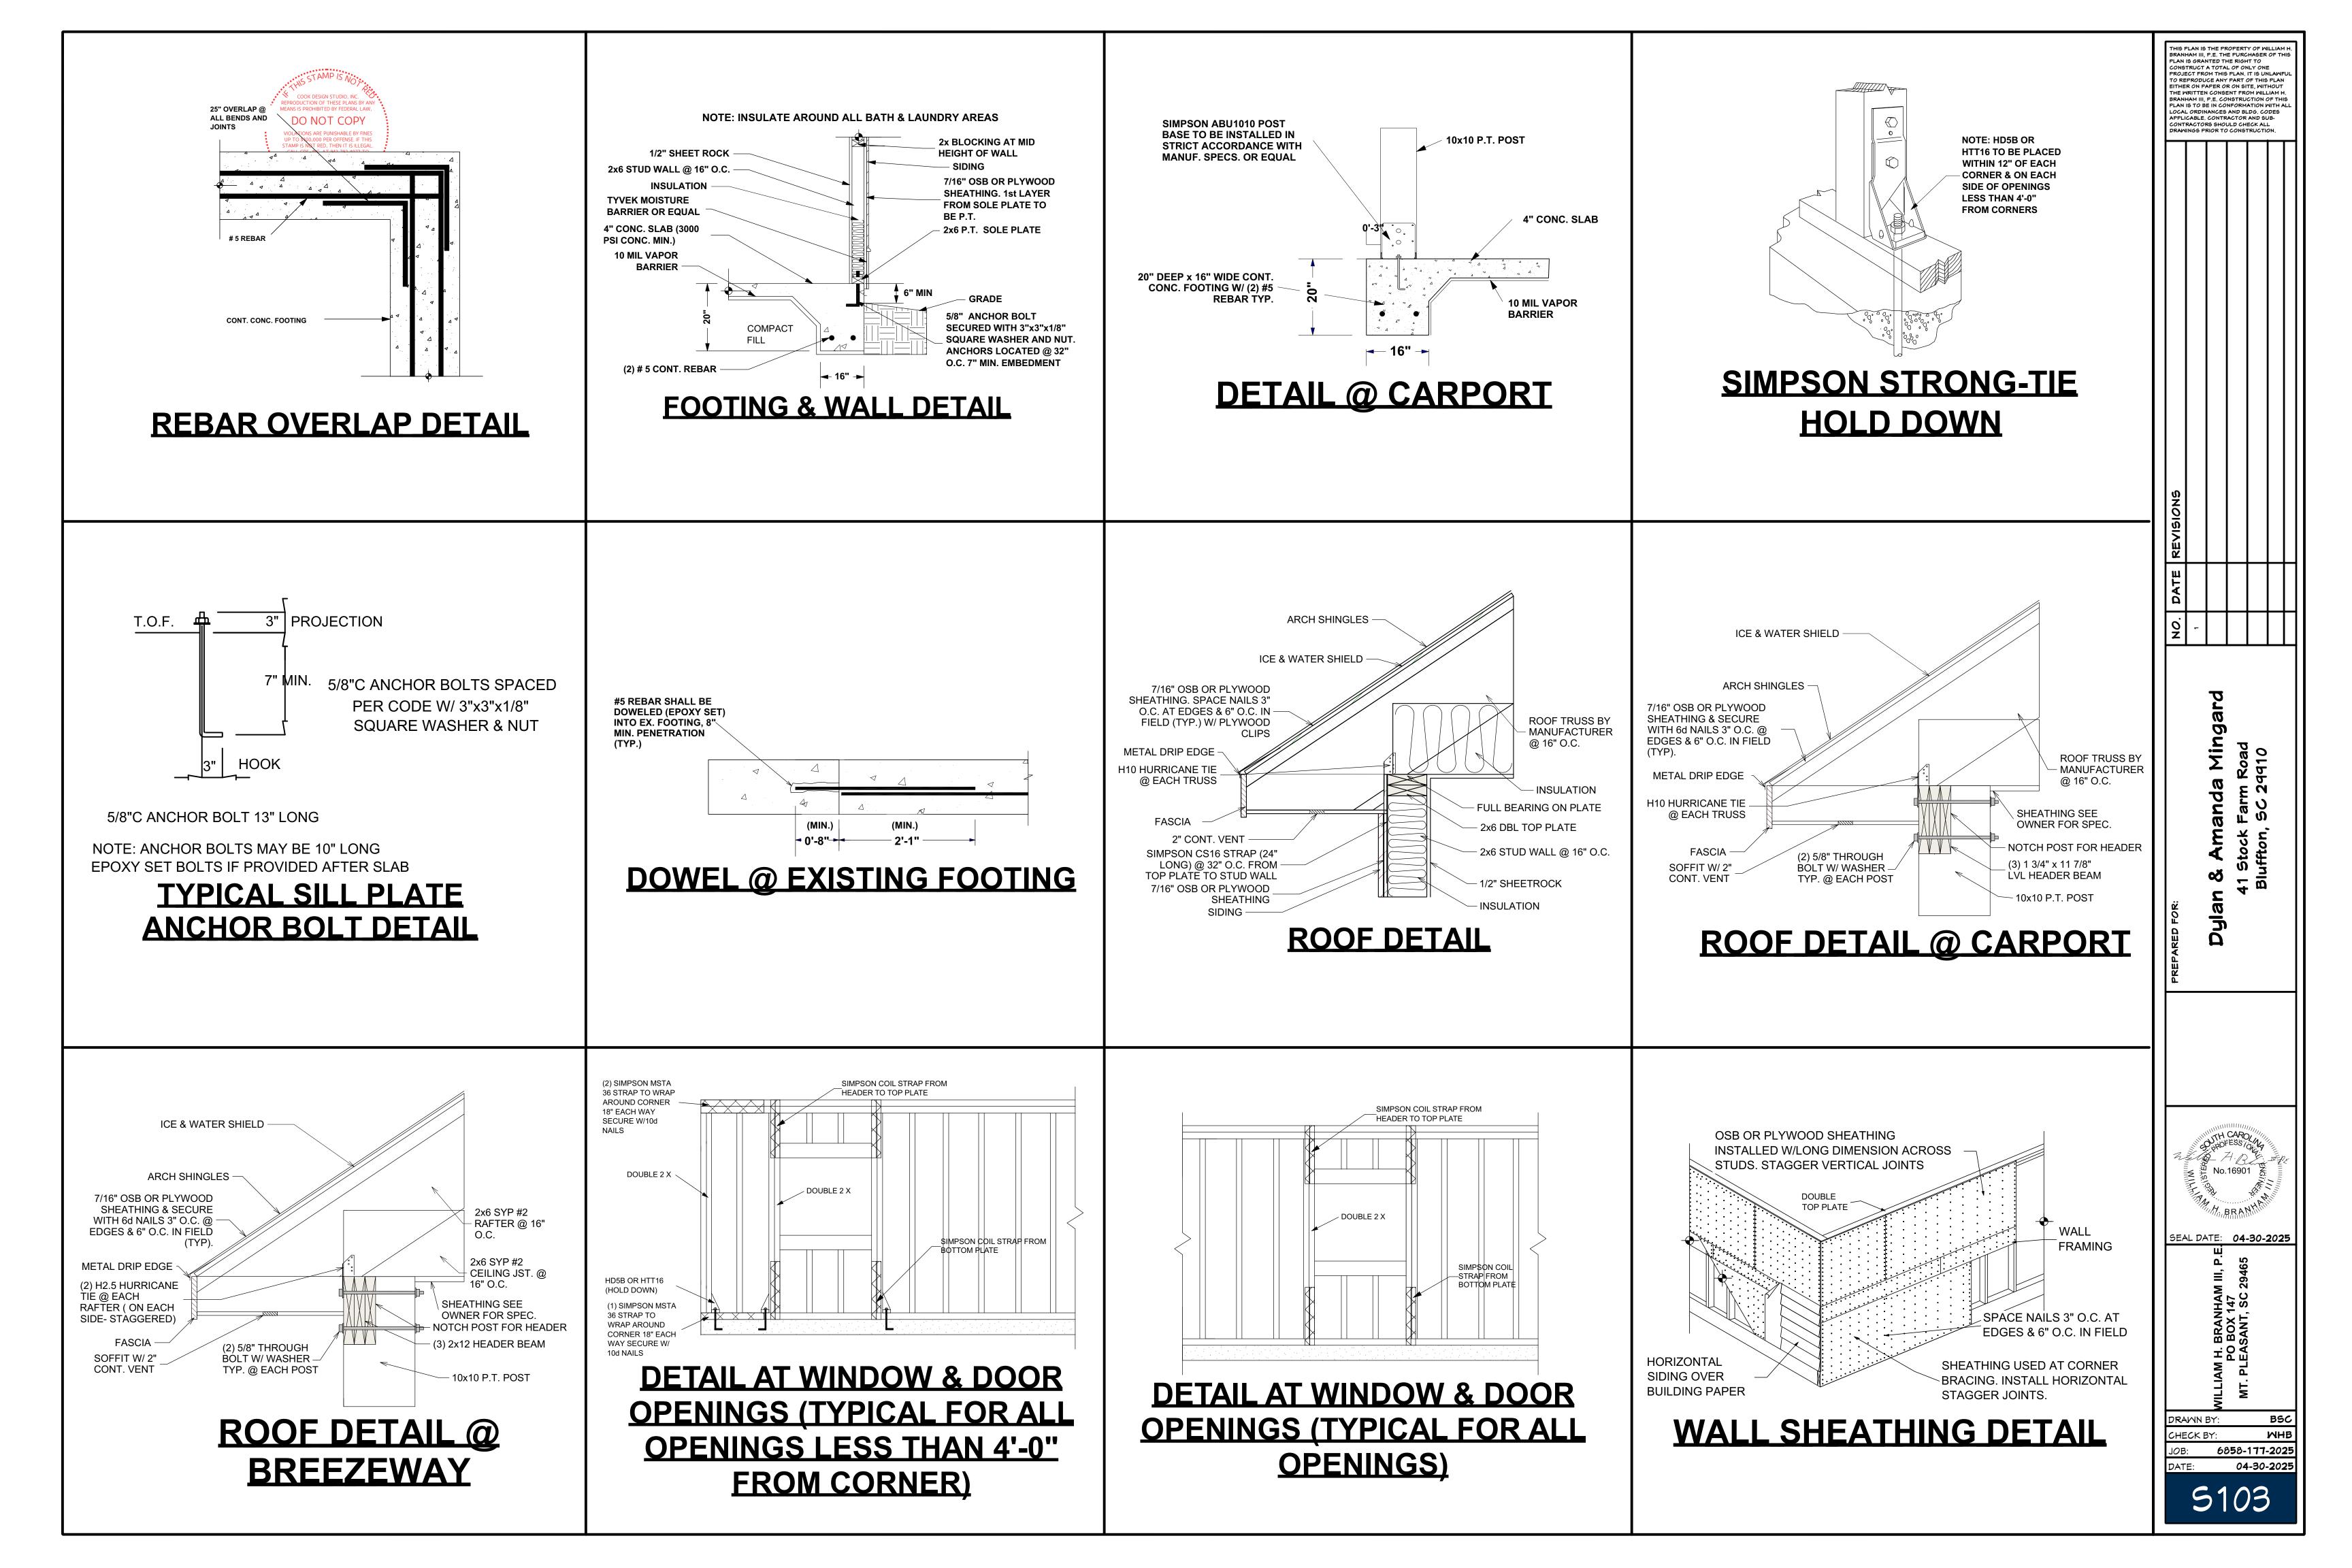

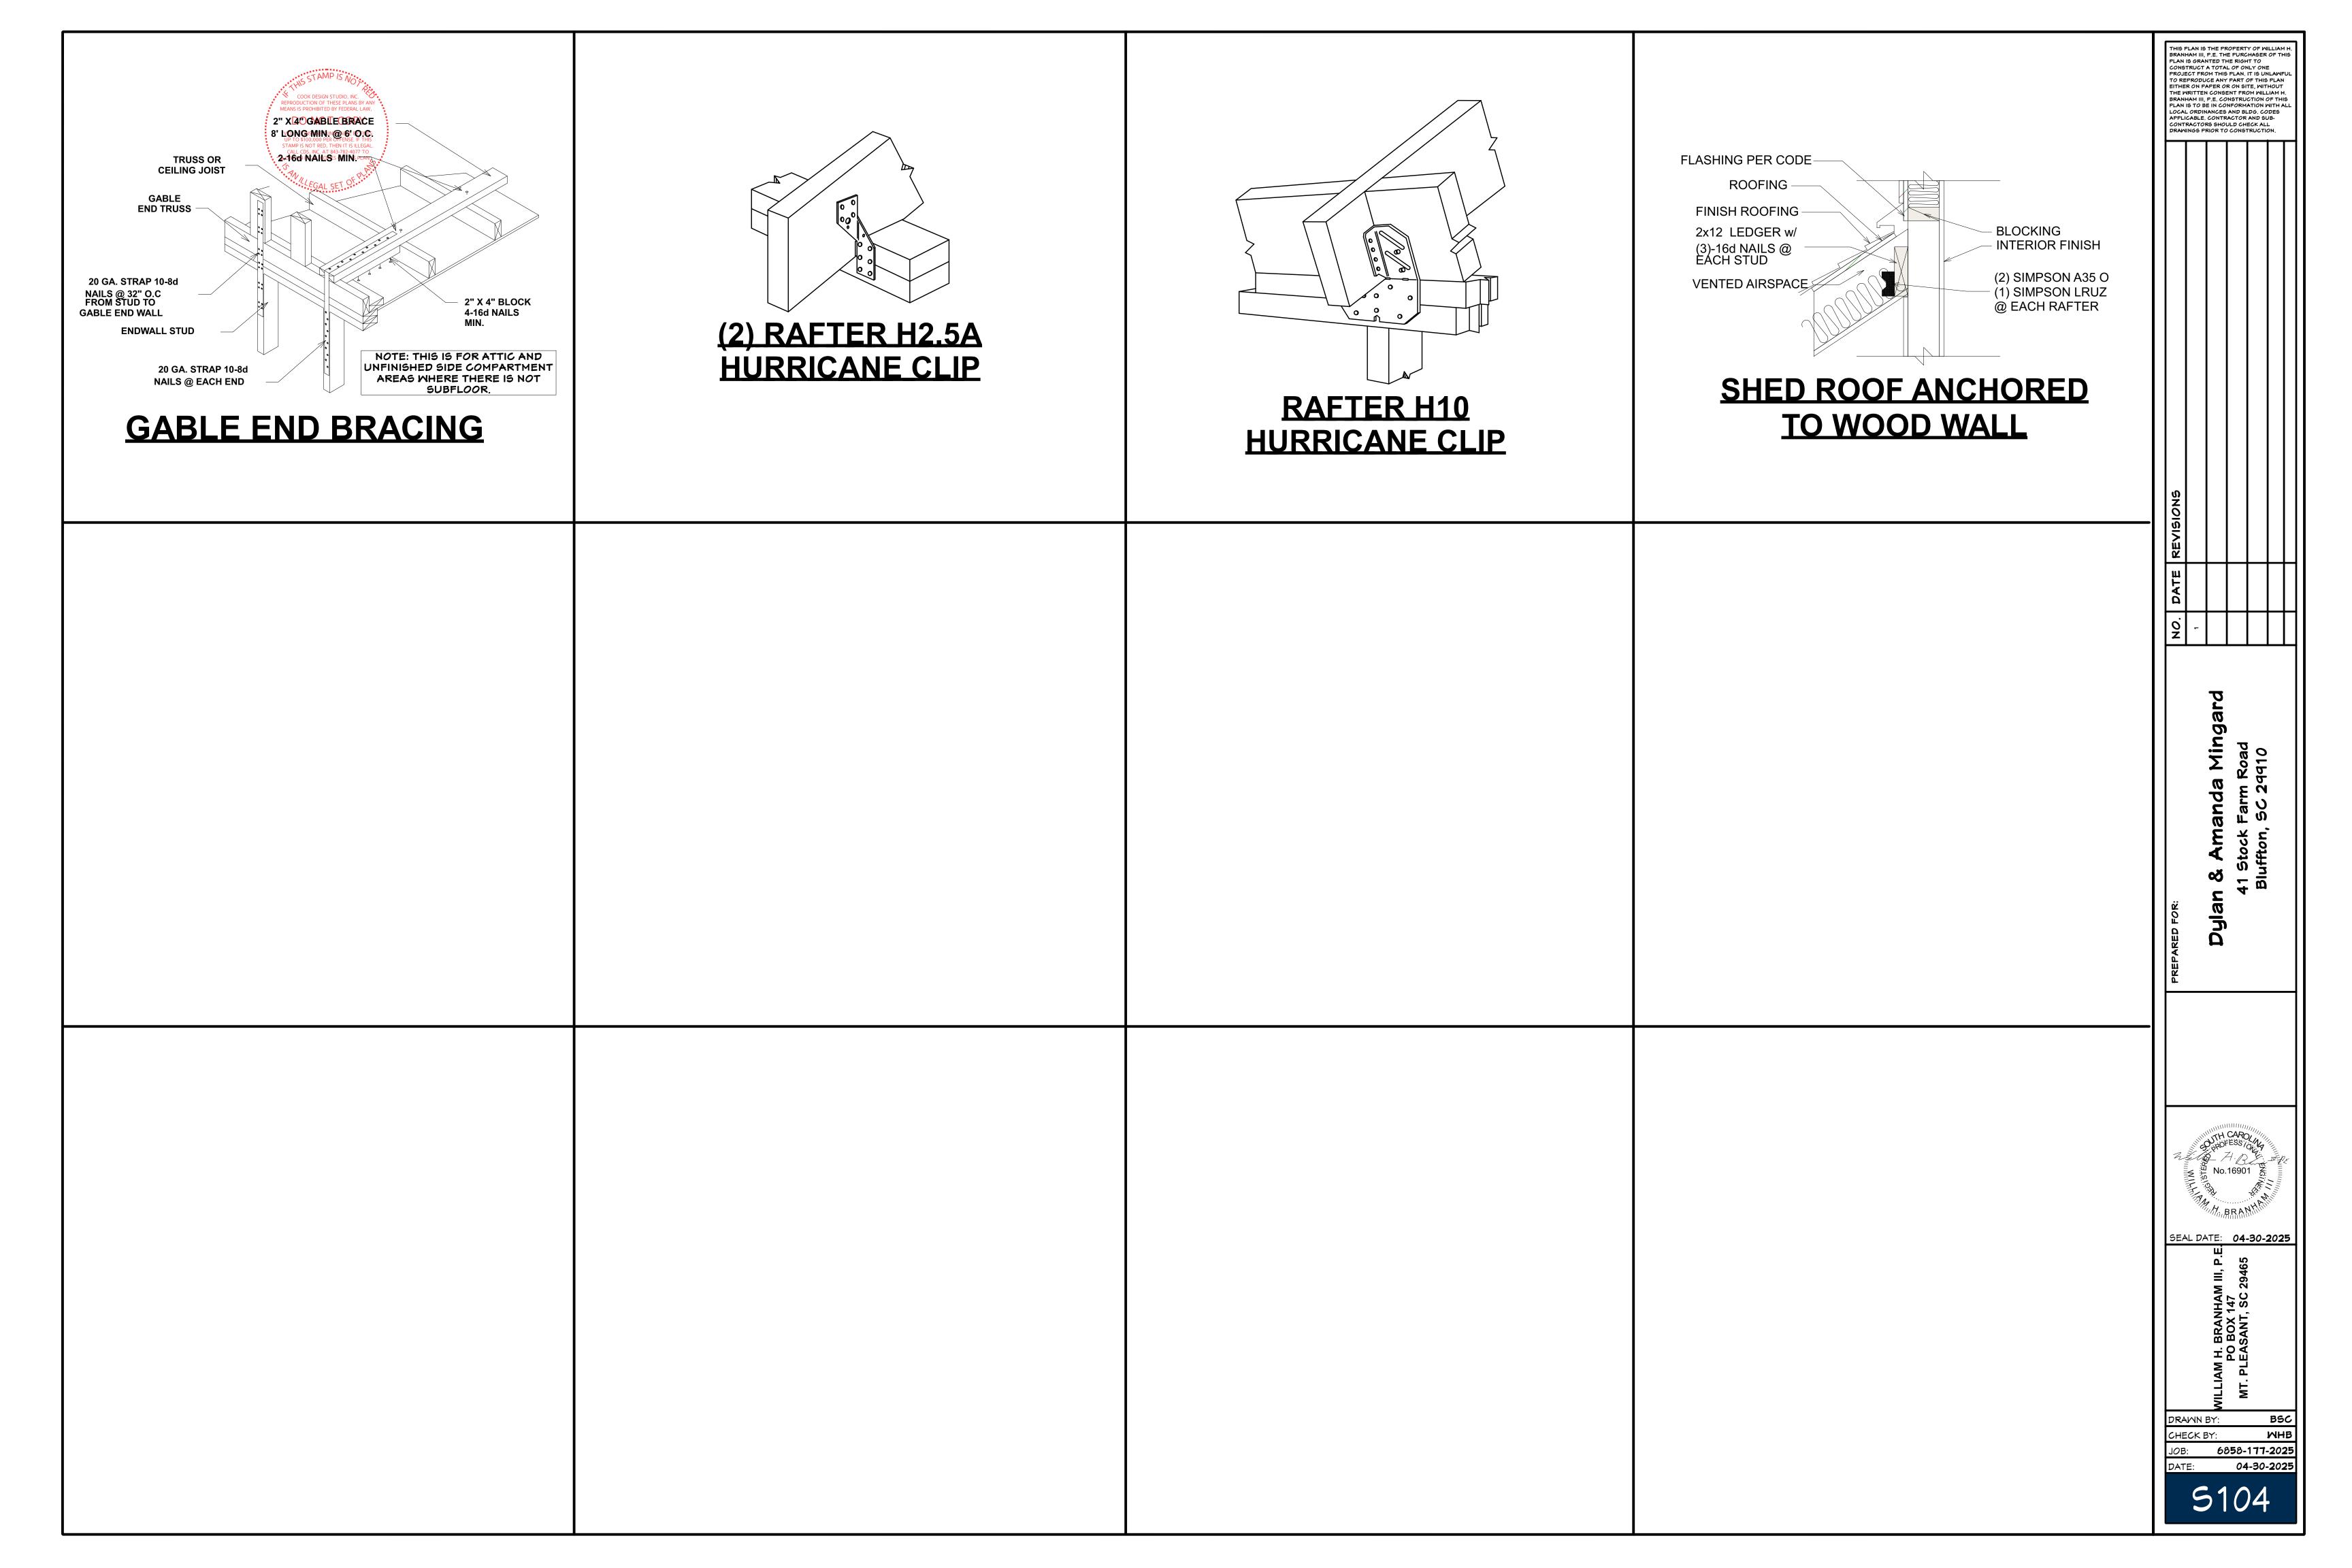



WINDOWS, GLASS DOORS & SKYLIGHTS SHALL BE ARRIVOVED AND INSTALLED TO COMPLY WITH BOTH NEGATIVE AND POSITIVE PRESSURES AS REQUIRED BY ICC 600. DOCUMENTATION OF COMPLIANCE SHALL BE AVAILABLE ON SITE FOR EACH WINDOW, DOOR OR SKYLIGHT AT THE FRAMING INSPECTION. (ICC 600)

ALL GLAZING IN DOORS, WINDOWS, OR SKYLIGHTS SHALL BE TESTED FOR 'LARGE MISSILE IMPACT RESISTANCE' AS NOTED BELOW. OPTION: PROVIDE WOOD STRUCTURAL PANELS FOR EACH OPENING. PANELS WILL HAVE A MINIMUM THICKNESS OF 7/16 INCHES AND A MAXIMUM SPAN OF 8'.

PANELS MUST BE PRECUT TO SIZE, AND ATTACHMENT HARDWARE PROVIDED, (PERMANENTLY INSTALLED ON THE STRUCTURE). EACH PANEL SHALL BE NUMBERED OR MARKED TO INDICATE WHICH WINDOW IT SHALL BE INSTALLED OVER.

TEST REQUIREMENTS NOTES:

- WINDOWS ARE TESTED IN ACCORDANCE WITH AAMA 101/I.S.2. 97 SPECIFICATIONS.
- TESTED LARGE MISSILE IMPACT RESISTANCE TO ASTM E1886/E1996.
- TESTED FORCED ENTRY RESISTANCE TO AAMA 1303.2.
- DEGLAZING TESTED TO ASTM E987.
- TESTED WATER RESISTANCE TO ASTM E547/331.
- TESTED AIR INFILTRATION TO ASTM E 283
- TEST REPORTS AVAILABLE UPON REQUEST.

IF APPROVED DOORS, WINDOWS, OR SKYLIGHTS ARE NOT USED, THEN WOOD STRUCTURAL PANELS MUST BE PROVIDED FOR EACH OPENING. PANELS WILL HAVE A MINIMUM THICKNESS OF 7/16 INCHES AND A MAXIMUM SPAN OF 8 FEET. PANELS MUST BE PRECUT TO SIZE WITH ATTACHMENT HARDWARE PROVIDED AND NUMBERED SO THAT A HOMEOWNER WILL BE ABLE TO IDENTIFY THE PROPER LOCATION FOR EACH PANEL.

1. PREDOMINANT "R-VALUES" OF INSULATION INSTALLED IN OF OR CEILING, ROOF, WALLS, FOUNDATION (SLAB, BASEMENT WALL, CRAWLSPACE WALL AND OR FLOOR) AND DUCTS OUTSIDE CONDITIONED SPACES.

2. "U-FACTORS FOR FENESTRATION"; AND THE SOLAR HEAT GAIN COEFFICIENT (SHGC) OF FENESTRATION. WHERE THERE IS MORE THAN ONE VALUE FOR EACH COMPONENT, THE CERTIFICATE SHALL LIST THE VALUE COVERING THE LARGEST AREA.

3. THE CERTIFICATE SHALL LIST THE TYPE AND EFFICIENCY OF HEATING, COOLING AND SERVICE WATER HEATING EQUIPMENT.

4. MUST SEAL AROUND EXTERIOR JOINTS AT WALL AND FLOOR.

5. ALL DUCTS SHALL BE SEALED RCP#6 AND INSULATED WITH R-8 INSULATION.

6. SEAL ALL DUCT WORK, VENTS, PIPING, CABLES, UTILITIES, AND RECESSED LIGHT FIXTURES PENETRATIONS.

7. SEAL ALL PERIMETER OF WINDOWS AND DOORS.

INSULATION (MIN.)
SLOPE CEILINGS --- R19
ATTIC AREAS --- R30
2 X 4 WALLS --- R13
2 X 6 WALLS --- R19
FLOORS --- R19

INSULATE AROUND ALL BATHS AND UTILITY ROOMS.


ATTIC TO BE VENTED PER CODE THROUGH SOFFIT VENTS COMBINED WITH RIDGE VENTS OR GABLE VENTS.

#### MINIMUM WALL AND HEADER STUD REQUIREMENTS


		MAXIMUM HEADER SPAN (FT.)			
		3 ft	6 ft	9 ft	12 ft
	NUMBER OF HEADER STUDS SUPPORTING EACH END OF THE HEADER				
		1	1	2	2
UNSUPPORTED WALL HEIGHT	STUD SPACING	NUMBER OF FULL LENGTH STUDS AT EACH END OF THE HEADER			
10 FEET OR LESS	16"o/c	2	2	3	3
GREATER THAN 10 FEET	16"o/c	2	2	3	3


#### DOOR AND WINDOW HEADER SCHEDULE: (WALLS 2x6's @ 16" O.C.)

- (3) 2x8's W/ (1/2) PLYWOOD FILLERS FOR UP TO 4'-0" OPENINGS (3) 2x10's W/ (1/2) PLYWOOD FILLERS FOR UP TO 8'-0" OPENINGS (3) 2x12's W/ (1/2) PLYWOOD FILLERS FOR UP TO 10'-0" OPENINGS
- DOOR AND WINDOW HEADER SCHEDULE: (WALLS 2x4's @ 16" O.C.)
- (2) 2x8's W/ (1/2) PLYWOOD FILLERS FOR UP TO 4'-0" OPENINGS (2) 2x10's W/ (1/2) PLYWOOD FILLERS FOR UP TO 8'-0" OPENINGS (2) 2x12's W/ (1/2) PLYWOOD FILLERS FOR UP TO 10'-0" OPENINGS

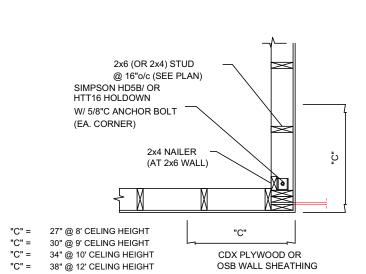


# WALL SHEATHING AT TYPICAL 90D CORNER

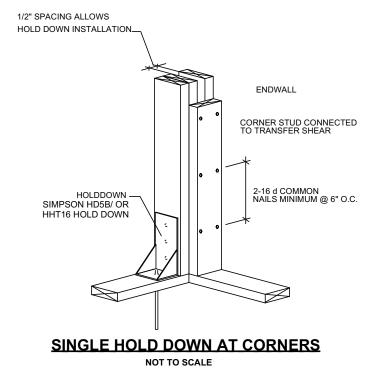


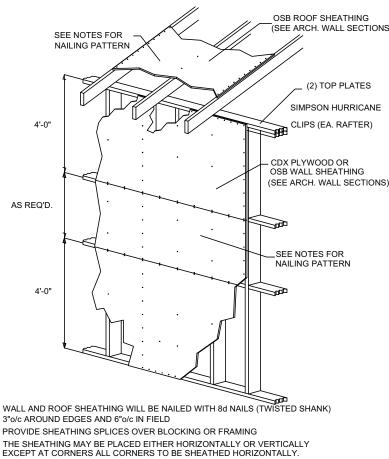

#### SHEATHING NAILING PATTERN

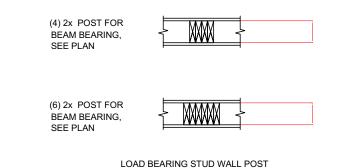

#### LOAD BEARING STUD WALL POST DETAILS

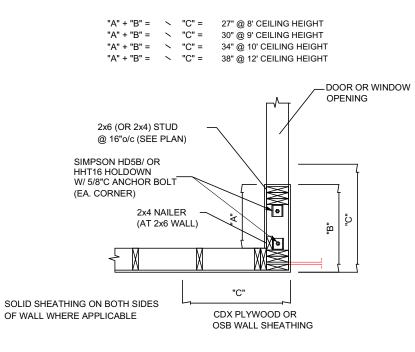

WALL SHEATHING AT 90D CORNER AT WINDOW

# STUD HEIGHT / SPACING TABLE UNSUPPORTED WALL HEIGHT (feet) STUD SIZE/SPACING (SPECIES/SPECIFICATION) UP TO 9'-0" 2x4 @ 16" O.C. (SPF#2) 9'-1" - 10'-4" 2x4 @ 12" O.C. (SPF #2) -OR- 2x6 @ 16" O.C. (SPF #2) 10'-5" - 15'-0" (2) 2x4 @ 16" O.C. (SPF #2) -OR- 2x6 @ 12" O.C. (SPF #2)

15'-1" - 16'-7" 2x6 @ 12" O.C. (SPF #2) -OR- 2x8 @ 16" O.C. (SPF #2)

16'-8" - 18'-6" 2x8 @ 16" O.C. (SPF #2)

18'-7" - 20'-0" (2) 2x6 @ 12" O.C. (SPF #2) -OR- 2x8 @ 12" O.C. (SPF #2)

DOUBLE STUDS TO BE NAILED TOGETHER WITH 12d COMMON NAILS @ 3" O.C. FROM EACH SIDE, STAGGERED PATTERN.
 STUD HEIGHTS EXCEEDING 20' SHALL REQUIRE SPECIFIC ENGINEERING.

DOOR AND WINDOW HEADER SCHEDULE: (WALLS 2x6's @ 16" O.C.)

(3) 2x8's W/ (1/2) PLYWOOD FILLERS FOR UP TO 4'-0" OPENINGS
(3) 2x10's W/ (1/2) PLYWOOD FILLERS FOR UP TO 8'-0" OPENINGS
(3) 2x12's W/ (1/2) PLYWOOD FILLERS FOR UP TO 10'-0" OPENINGS

DOOR AND WINDOW HEADER SCHEDULE: (WALLS 2x4's @ 16" O.C.)

(2) 2x8's W/ (1/2) PLYWOOD FILLERS FOR UP TO 4'-0" OPENINGS
(2) 2x10's W/ (1/2) PLYWOOD FILLERS FOR UP TO 8'-0" OPENINGS
(2) 2x12's W/ (1/2) PLYWOOD FILLERS FOR UP TO 10'-0" OPENINGS

THE CEILING / ATTIC JOISTS WILL BE: 2x6's @ 16"o/c UP TO 10' SPAN

2x8's @ 16"o/c UP TO 13'-6" SPAN 2x10's @ 16"o/c UP TO 16' SPAN

2x12's @ 16"o/c UP TO 20' SPAN

THE ROOF RAFTERS WILL BE:

2x6's @ 16"o/c UP TO 8'-0" (UNSHORED) SPAN
2x8's @ 16"o/c UP TO 12'-0" (UNSHORED) SPAN
2x10's @ 16"o/c UP TO 15'-0" (UNSHORED) SPAN

THE EXTERIOR WALL STUDS SCHEDULE:

2x12's @ 16"o/c UP TO 18'-0" (UNSHORED) SPAN

2x4's @ 16" o/c AT THE WALLS WITH THE PLATE HEIGHT UP TO 9'-1 2x6's @ 16" o/c AT THE WALLS WITH THE PLATE HEIGHT UP TO 12'-1 2x8's @ 16" o/c AT THE WALLS WITH THE PLATE HEIGHT UP TO 18'-1

