

ARTISTIC RENDERING NOT FOR REFERENCE

ARCHITECTURAL & SITE: C.1.0 TITLE SHEET S.1.1 SITE PLAN - AS BUILT S.1.2 SITE PLAN - OVERLAY OLD HOUSE S.1.3 SITE PLAN - NEW WORK A.1.1 FIRST FLOOR PLAN A.1.2 SECOND FLOOR A.1.3 ATTIC PLAN A.1.4 CARRIAGE HOUSE #2 PLAN A.1.5 ROOF PLAN A.1.6 SCHEDULES A.2.0 1/8" BUILDING ELEVATIONS A.2.1 ENTRY ELEVATION A.2.2 RIVER ELEVATION A.2.3 LEFT SIDE ELEVATION A.2.4 RIGHT SIDE ELEVATION A.2.5 CARRIAGE 1 & 2 ELEVATIONS A.4.0 WALL SECTIONS A.4.1 WALL SECTIONS

A.5.0 EXTERIOR DETAILS

INDEX OF DRAWINGS:

E.1.1 1ST FLOOR ELECTRICAL PLAN

- E.1.2 2ND FLOOR ELECTRICAL PLAN
- E.1.3 ATTIC LEVEL ELECTRICAL PLAN

LANDSCAPE:

ELECTRICAL:

- L.1 DEVELOPMENT PLAN
- L.2 PLANTING PLAN
- L.3 PLANTING PLAN
- L.4 PLAN DETAILS
- L.5 GRADINGPLAN


GENERAL NOTES:

SECTION 4002.14

- 1. THE HVAC INSTALLER WILL PROVIDE MANUAL J, S, AND D CALCULATIONS SHOWING THE PROPER SIZING OF THE HVACUNITS AS PER IECC SECTION 403.6 BEFORE INSTALLATION
- 2. THE THERMOSTATS WILL BE PROGRAMMABLE TYPE PER IECC SECTION
- 3. ROOFING SHINGLES WILL MEET ASTM 316D, CLASS F PER IRC SECTION
- 4. 50% OF ALL PERMANENTLY INSTALLED LIGHTING FIXTURES WILL HAVE HIGH-EFFICACY LAMPS PROVIDED PER IECC SECTION 404.
- 5. ALL OUTLETS WILL BE ARC-FAULT PROTECTED PER IRC SECTION 3802.12. 6. ALL NEW RECEPTACLES WILL BE TAMPERED RESISTANT PER IRC
- 7. CO2 DETECTORS WILL BE INSTALLED AS PER IRC SECTION 315.
- 8. THE SPRAY FOAM CONTRACTOR WILL PROVIDE THE RESCHECK SHOWING COMPLIANCE WITH IECC SECTION 405.4
- 9. THE SPRAY FOAM CONTRACTOR WILL PROVIDE INFORMATION ON THE SPRAY FOAM PRODUCT STATING THE REQUIRED INCHES TO GET THE LISTED R-VALUES PER IECC SECTION 402.1.1 AND CORRESPONDING WITH THE RESCHECK.
- 10. THE SPRAY FOAM CONTRACTOR WILL PROVIDE THE FLAME SPREAD RATING AND SMOKE GENERATION FOR THE SPRAY FOAM PRODUCT AS PER IRC SECTIONS 302.10.

11. THE CONTRACTOR WILL PROVIDE EITHER A BLOWER DOOR TEST OR VISUAL INSPECTION TO CHECK THE AIR BARRIER AS REQUIRED BY IECC SECTION 402.4.2.- SUBMIT TO ARCHITECT & OWNER.

designs, working drawings,or construction of buildings without the written authorization from the copy

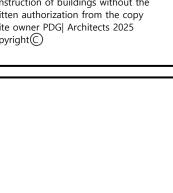


The Dunaw

REVISIONS

5/7/2025



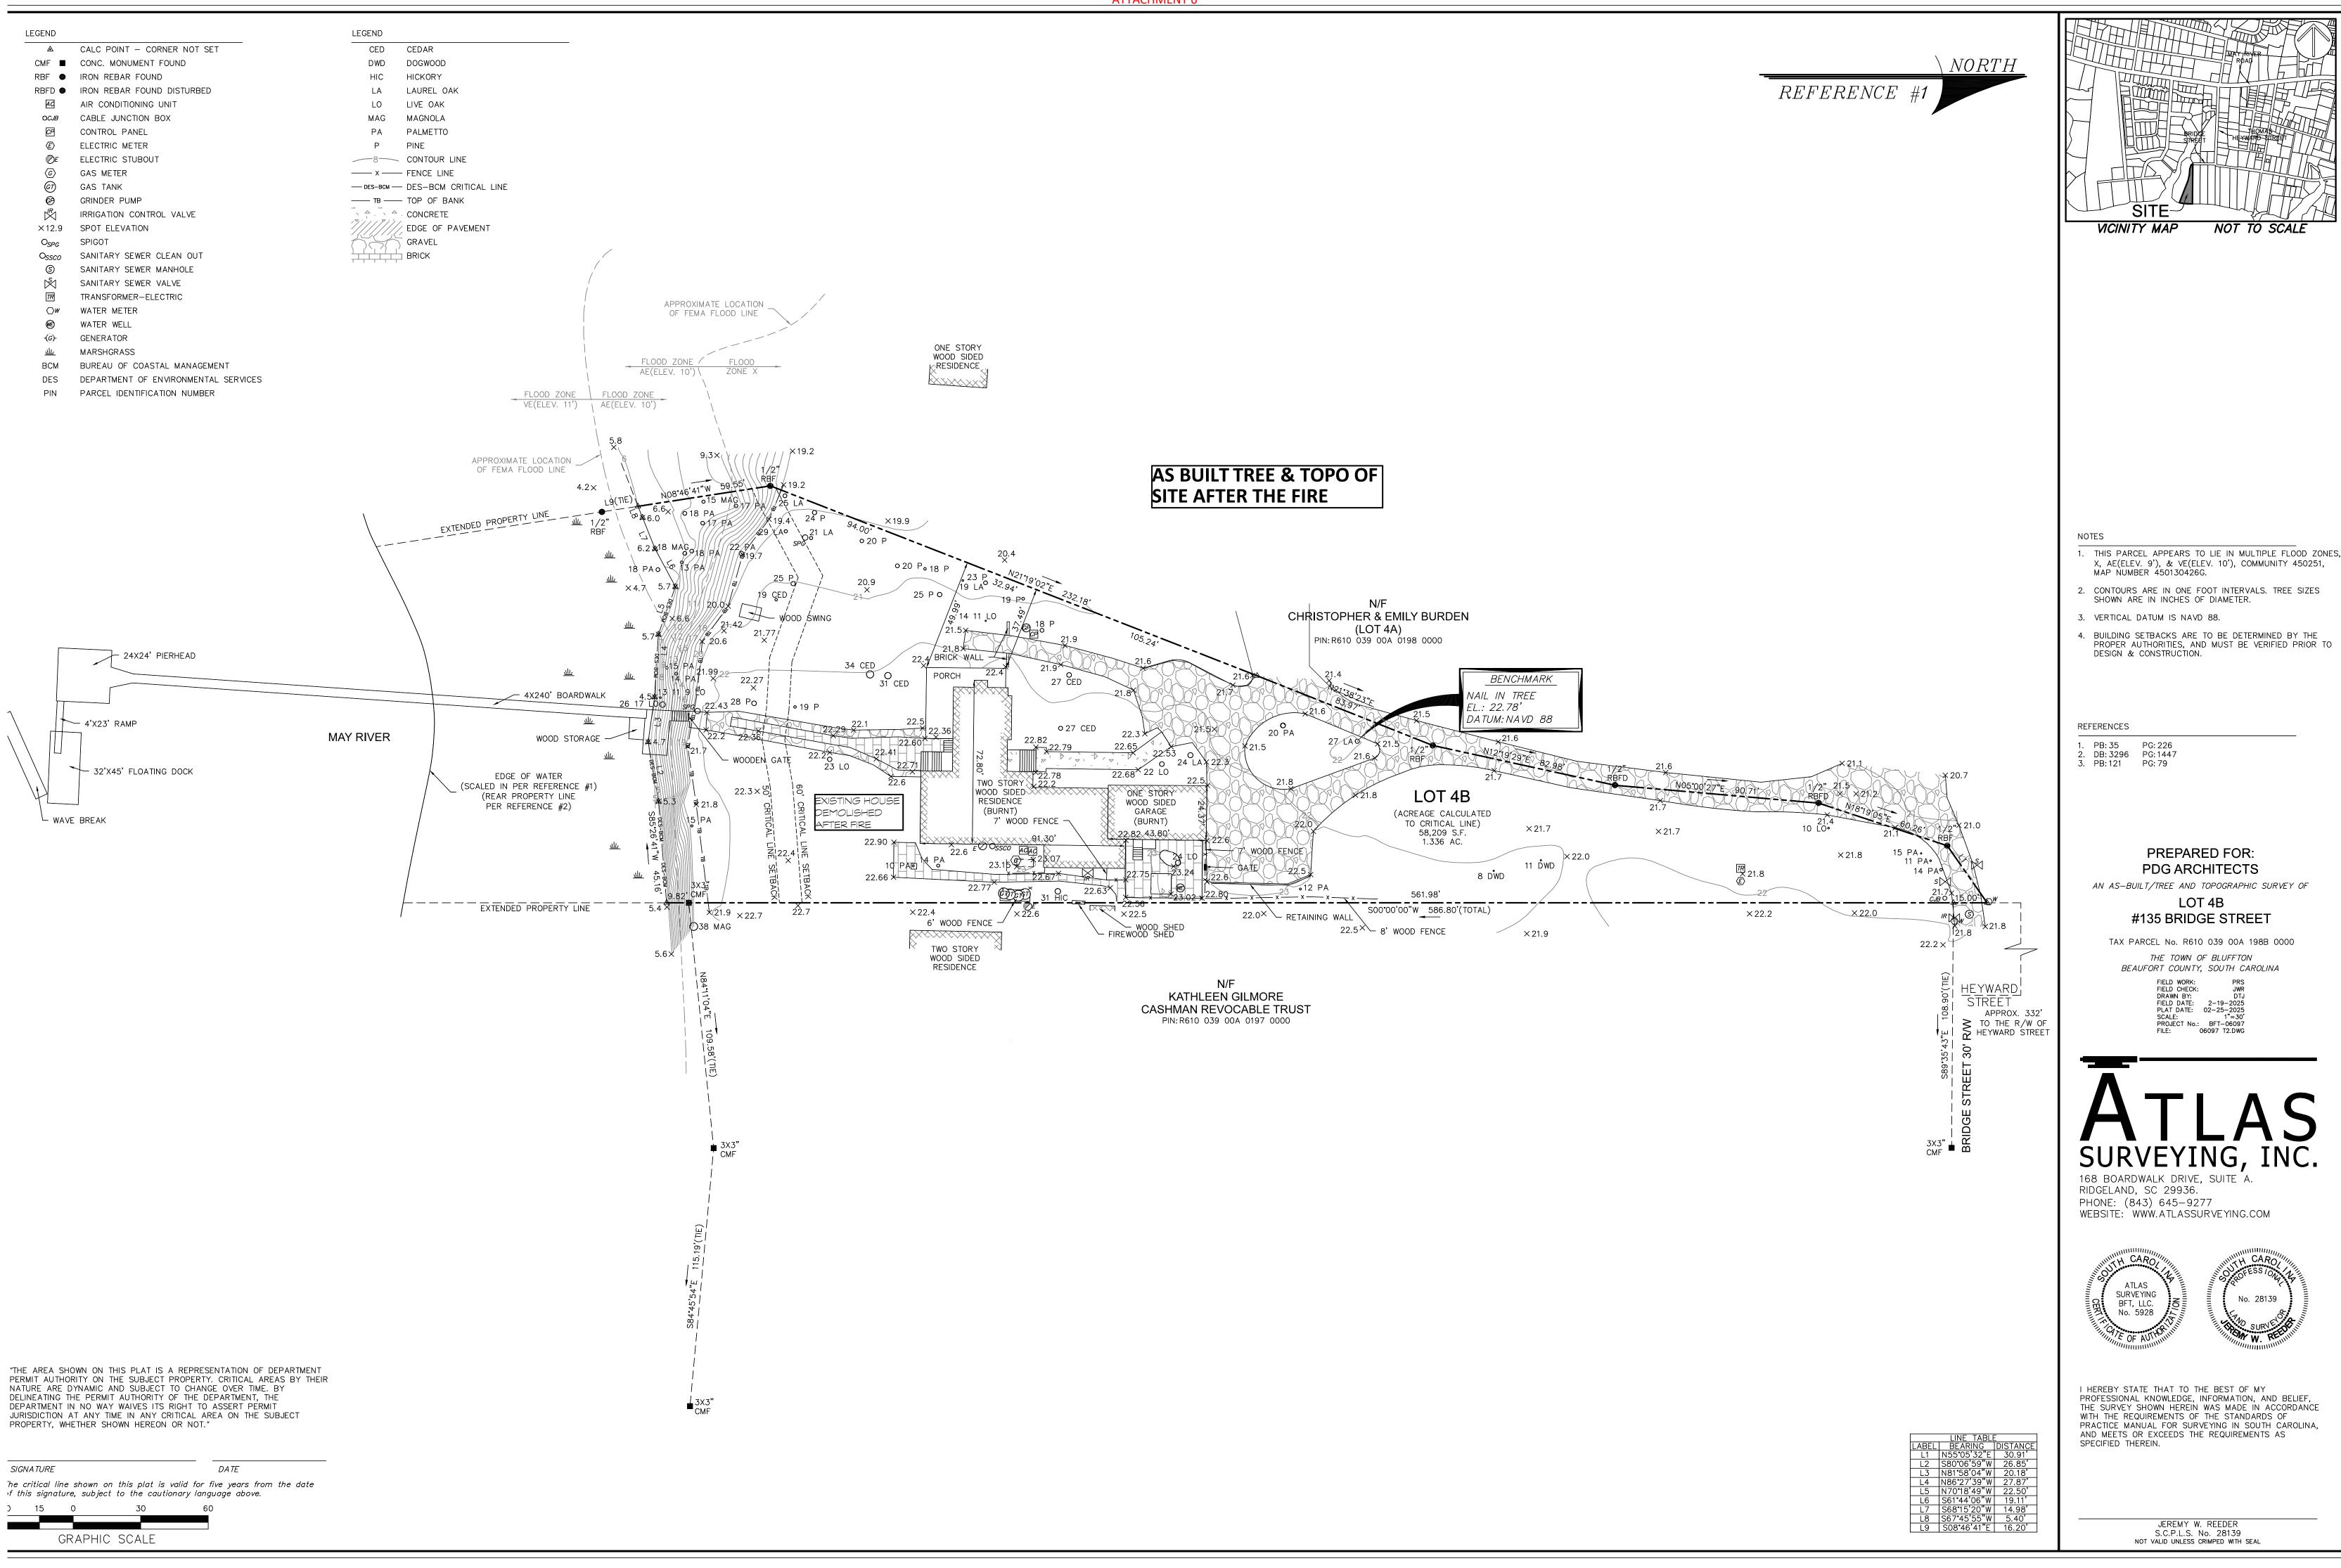

GRAPHIC SCALE

parkerdesigngrouparchitects 843 785 5171 POST OFFICE BOX 5010 HILTON HEAD ISLANI ARCHITECTS

These documents & designs are the property of PDG|Architects & are not to be used or reproduced thereof or for designs, working drawings,or construction of buildings without the written authorization from the copy write owner PDG| Architects 2025 copyright

nily

A New Riverfront Residence for:

The Dunaway Family


REVISIONS DATE


DRAWN BY
WTP
CHECKED BY

DATE OF ISSUE:
5/7/2025

JOB NO. 2505 SHEET

OLD PLAN OVERLAYED \$.1.2

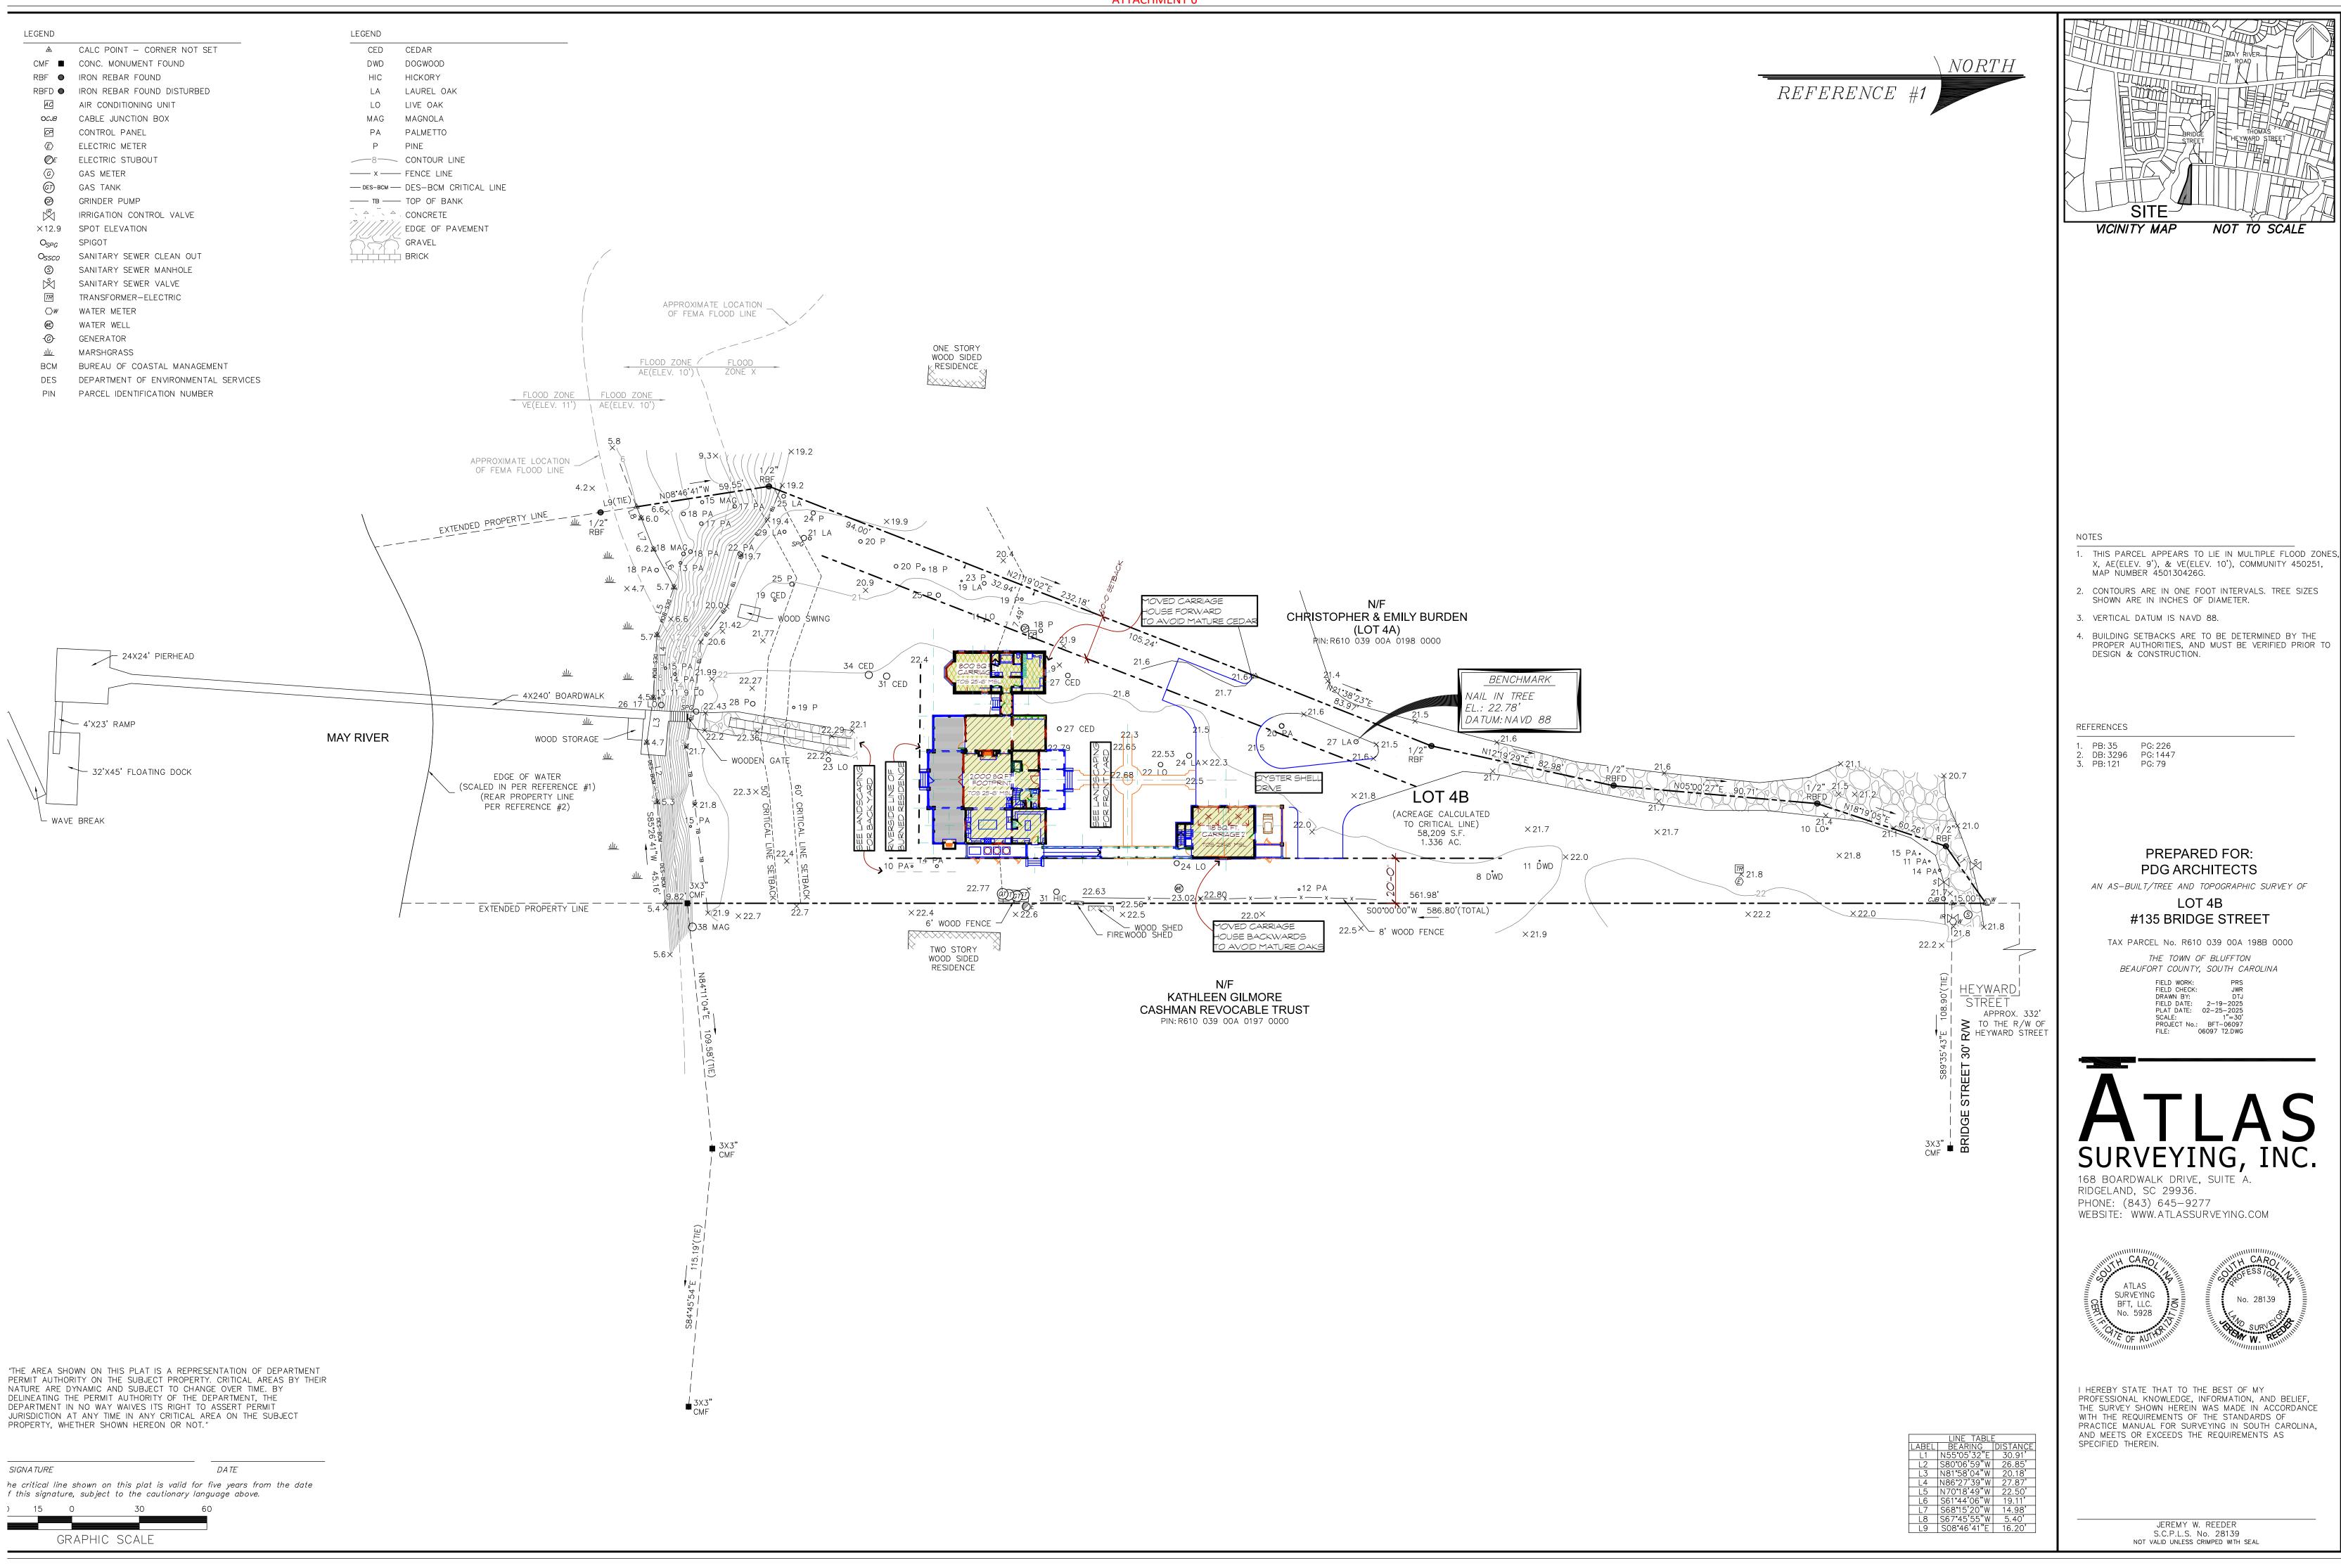

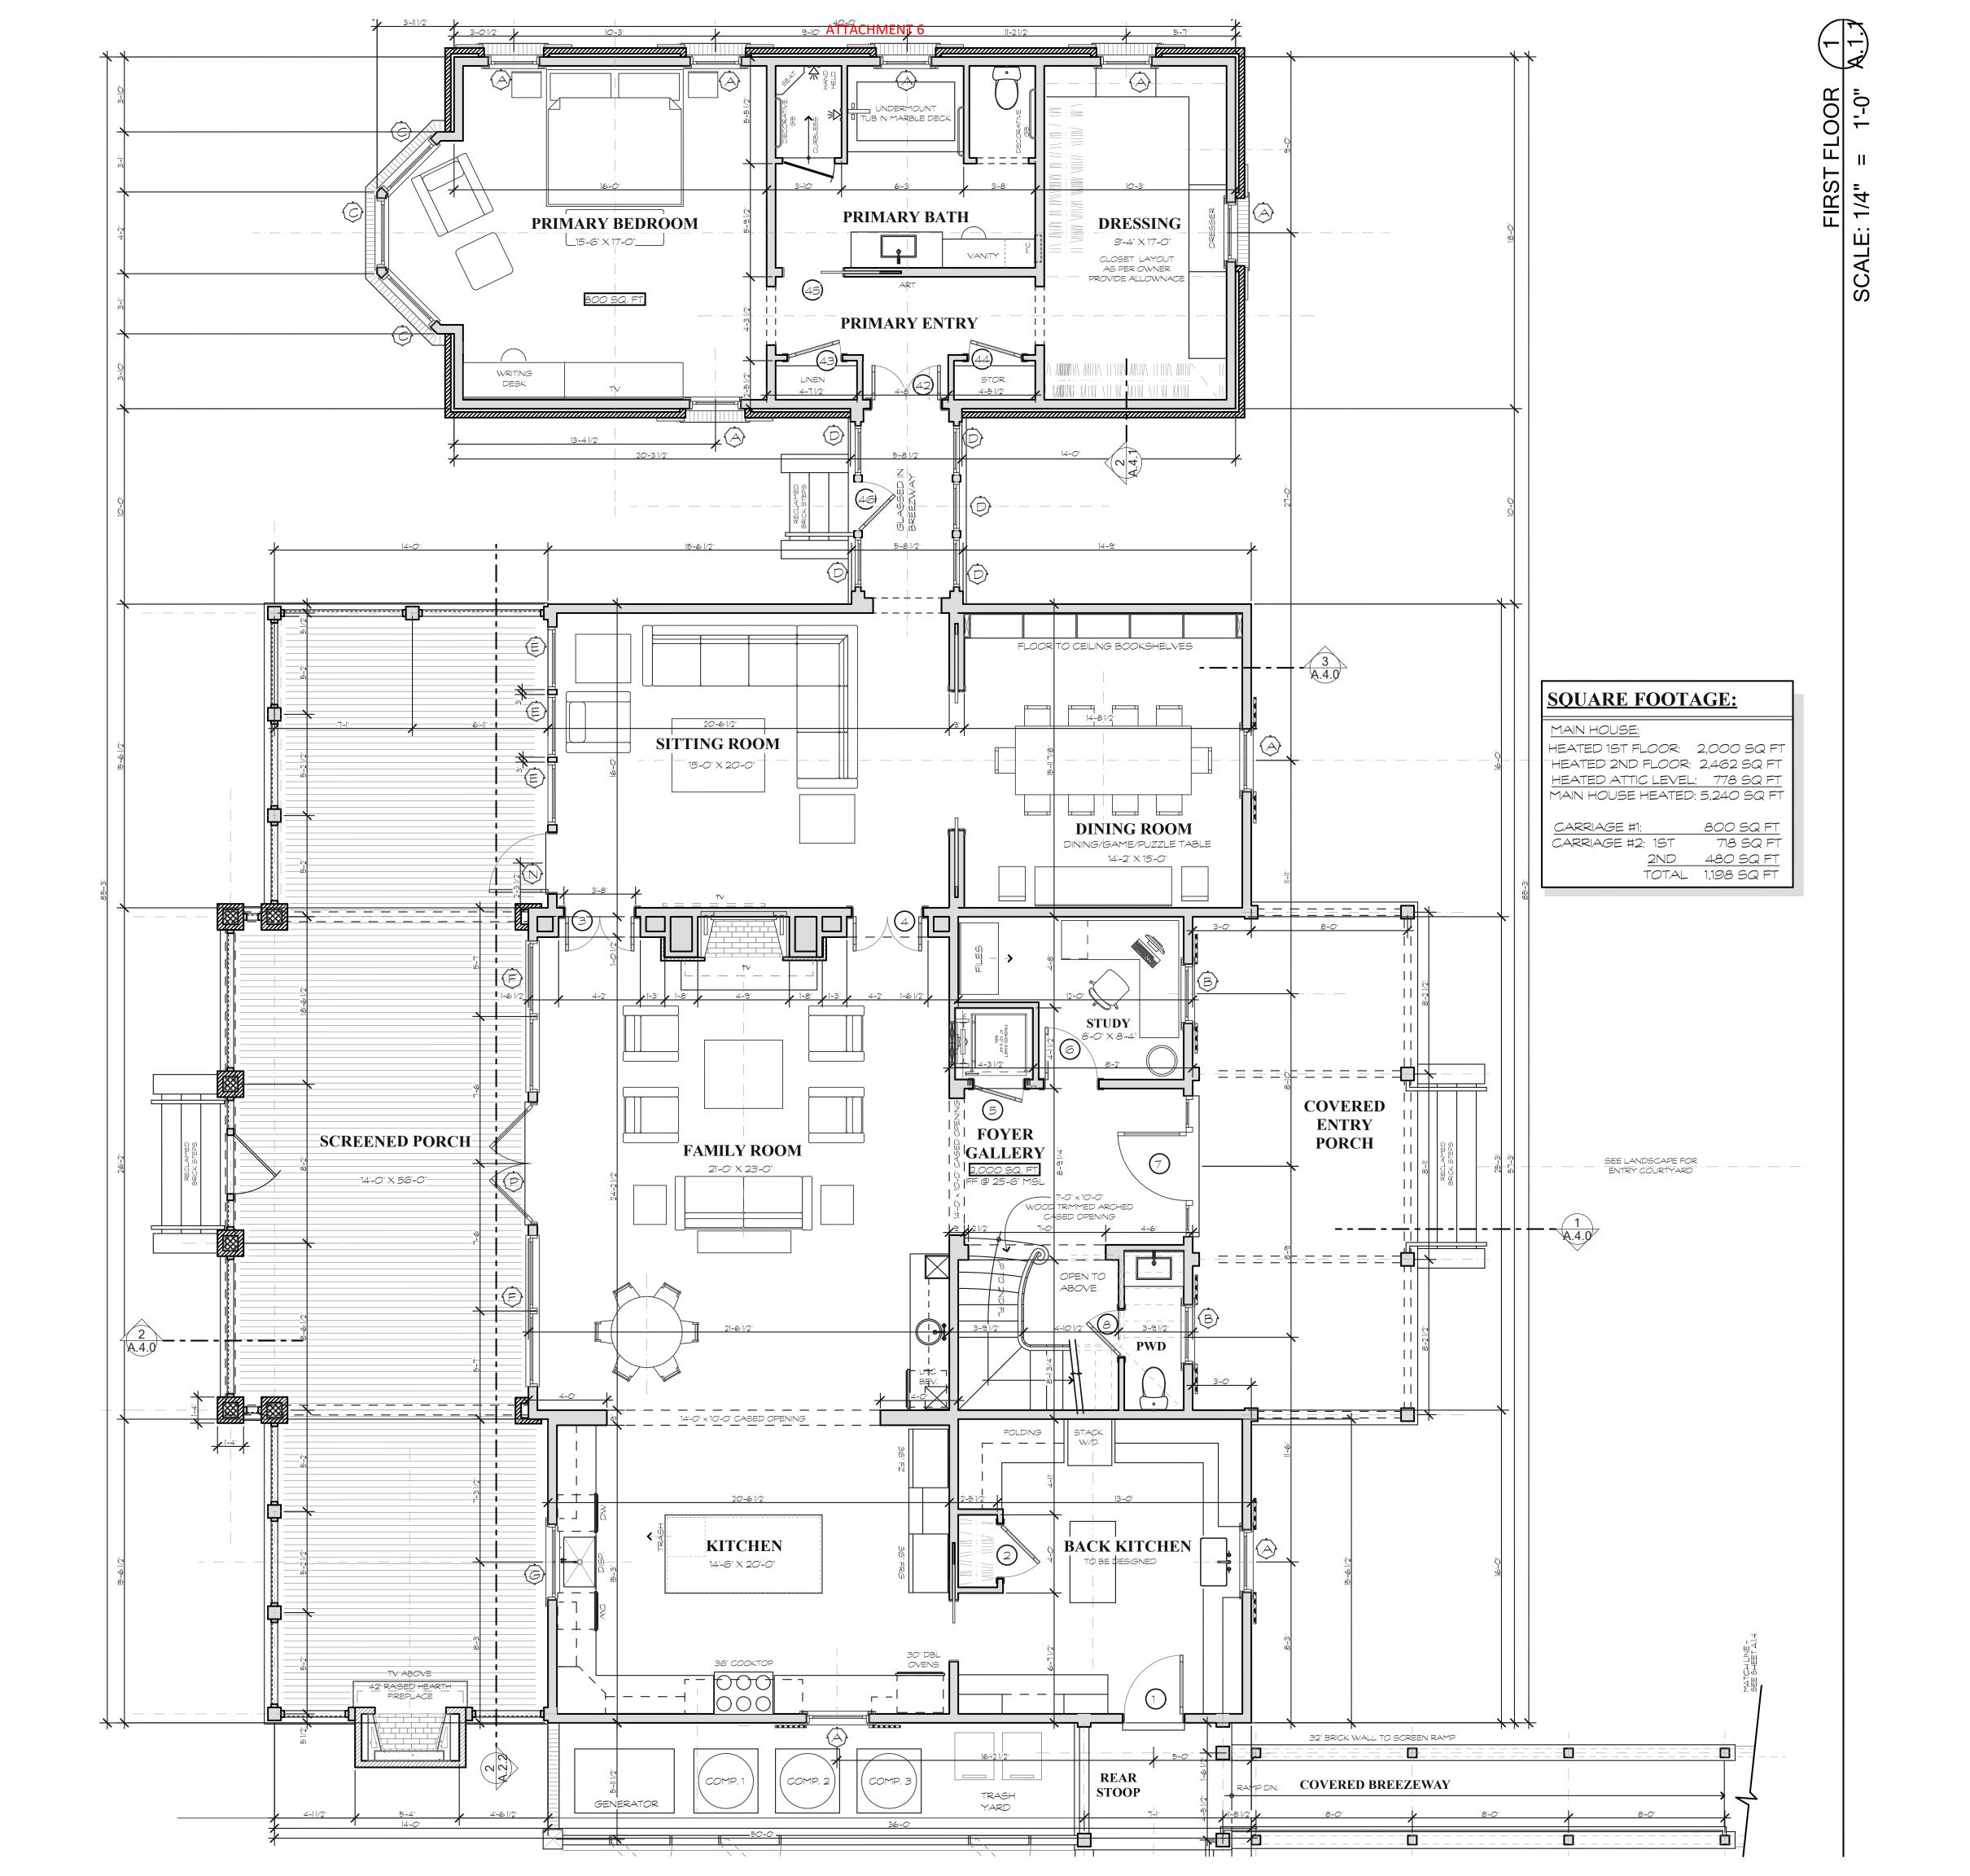

ne Dunaway Family

These documents & designs are the property of PDG|Architects & are not to be used or reproduced thereof or for designs, working drawings,or construction of buildings without the written authorization from the copy write owner PDG| Architects 2025

The Dunaway F:
135 Bridge Street
Bluffton, S. C.


DRAWN BY
WTP
CHECKED BY

DATE OF ISSUE:
5/7/2025

SCALE

FIRST FLOOR PLAN

SHEETS

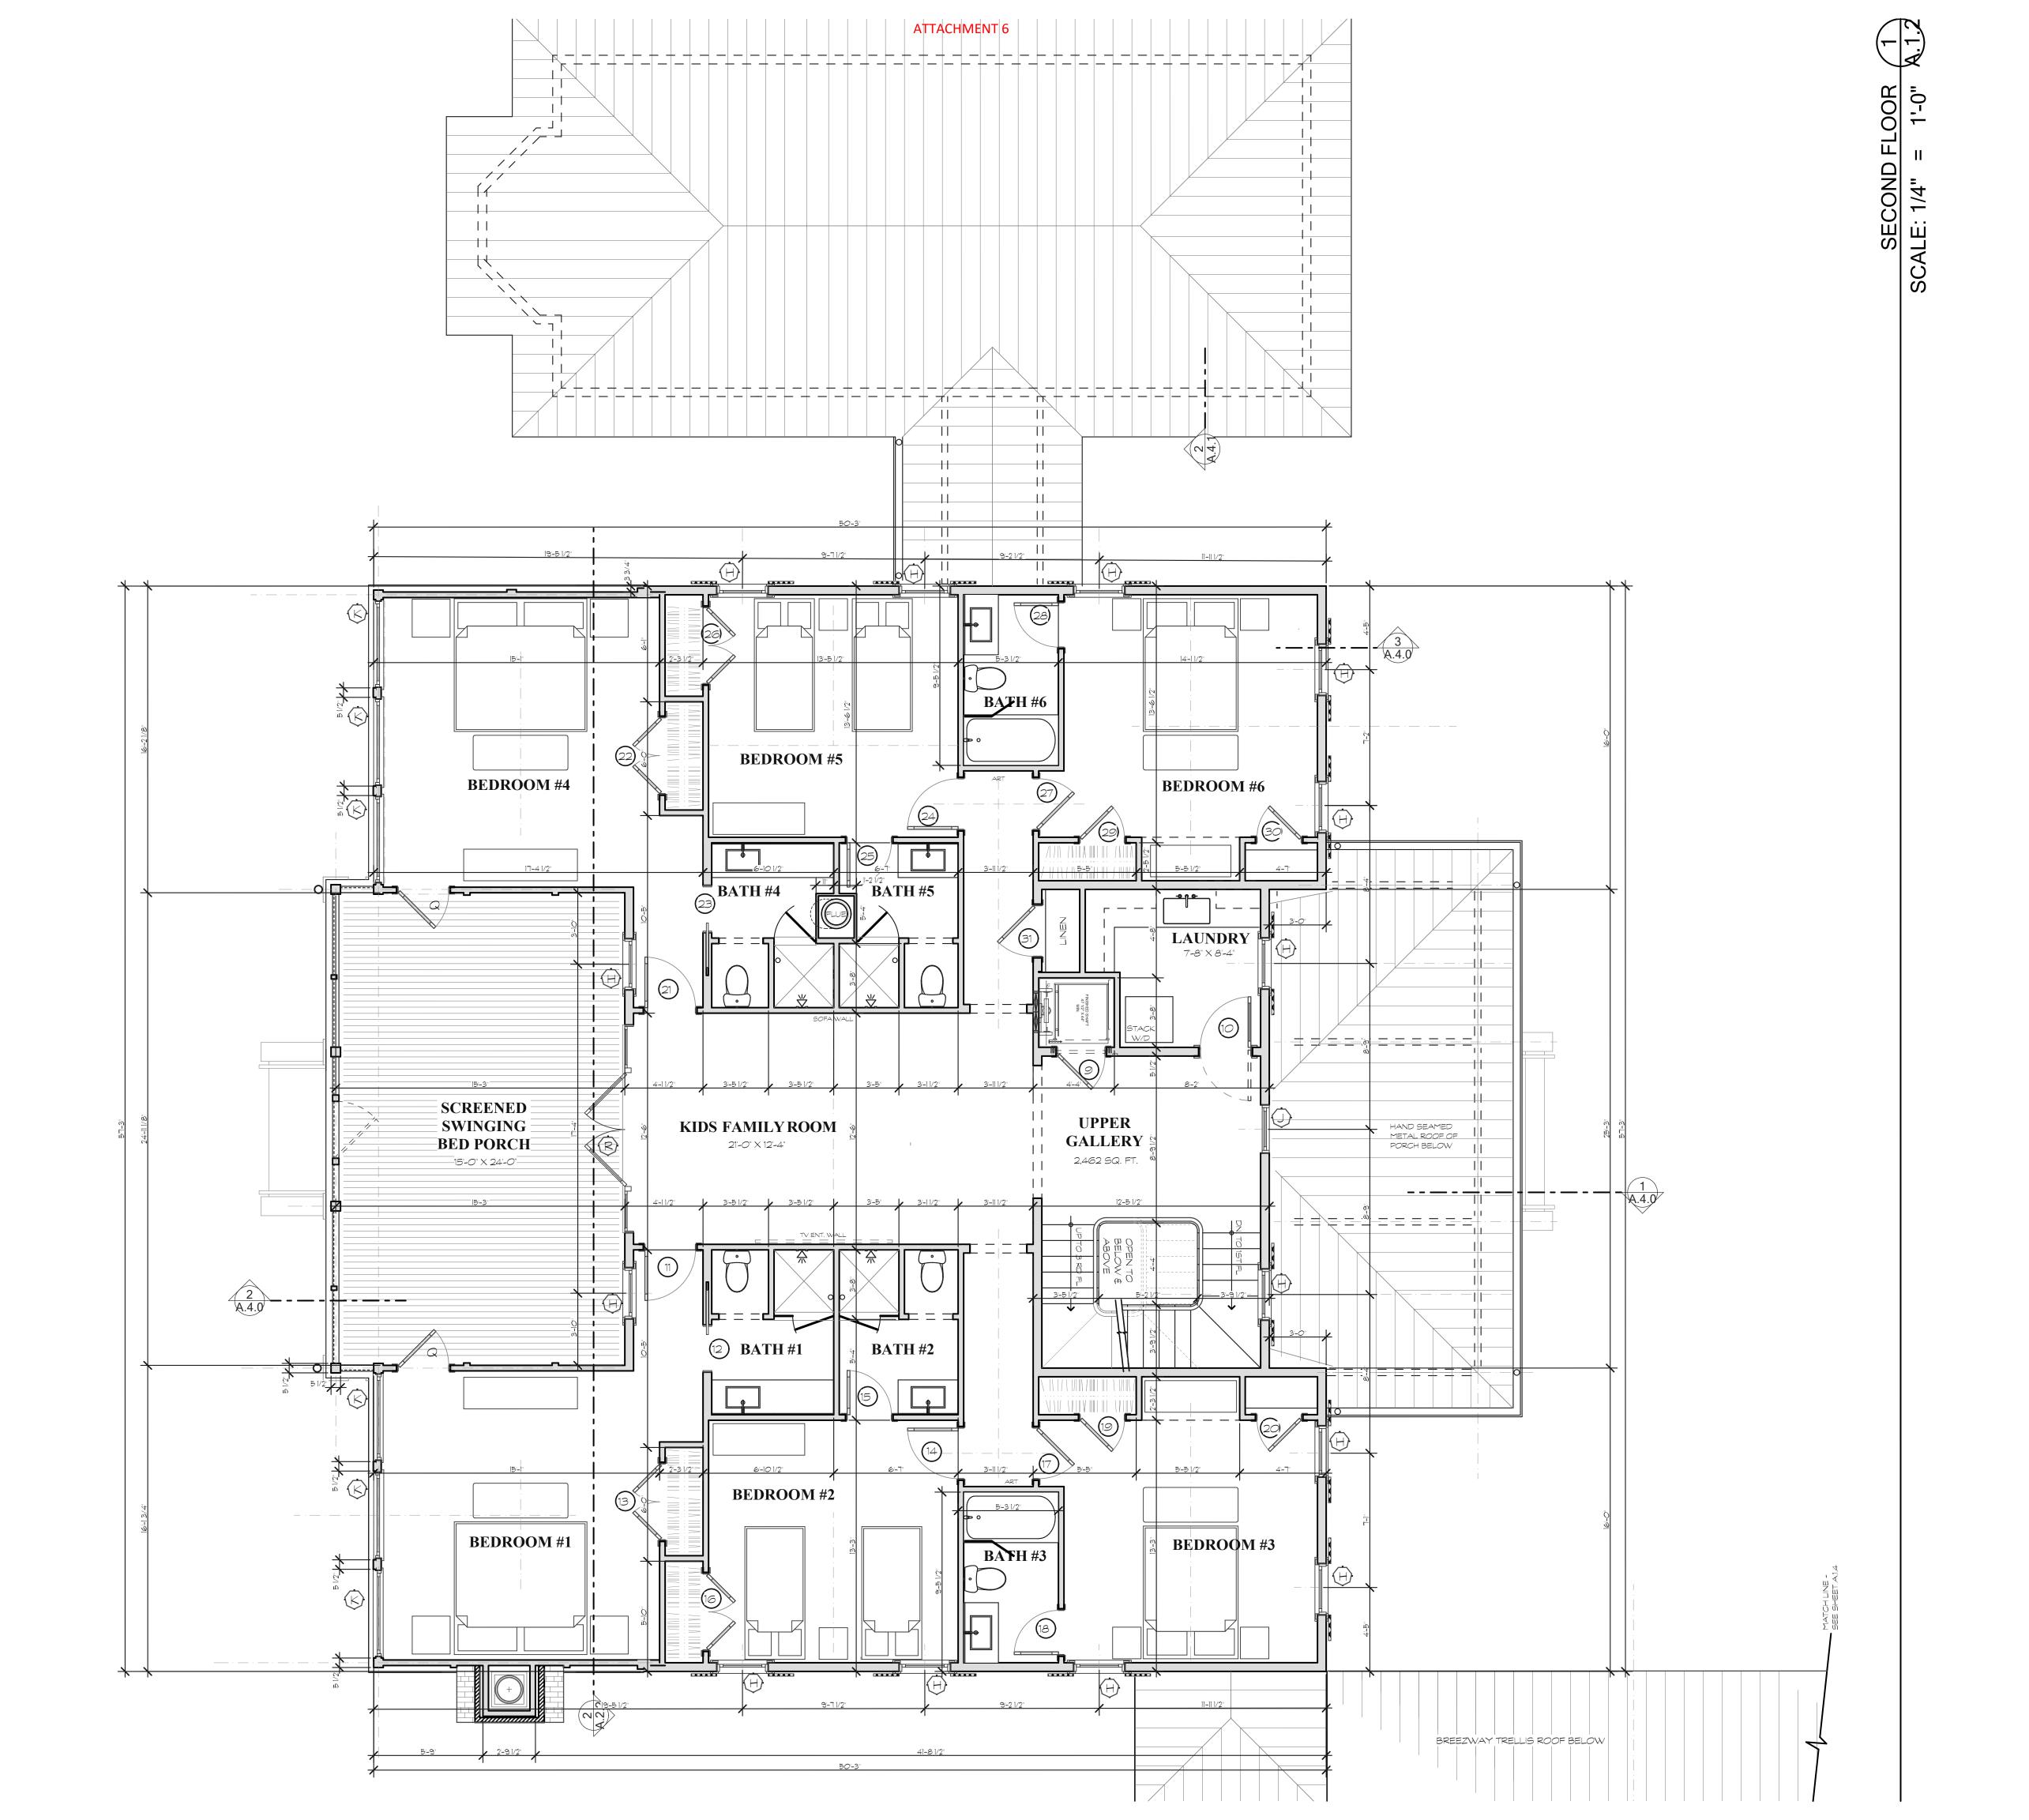



These documents & designs are the property of PDG|Architects & are not to be used or reproduced thereof or for

designs, working drawings,or construction of buildings without the written authorization from the copy write owner PDG| Architects 2025 copyright

135 Bridge Street
Bluffton, S. C.

DRAWN BY
WTP
CHECKED BY


DATE OF ISSUE:
5/7/2025

DRAWN BY
WTP
CHECKED BY

DATE OF ISSUE:
5/7/2025
SCALE

JOB NO.
2505
SHEET
SECOND FLOOR
PLAN
A 1.2

SHEETS

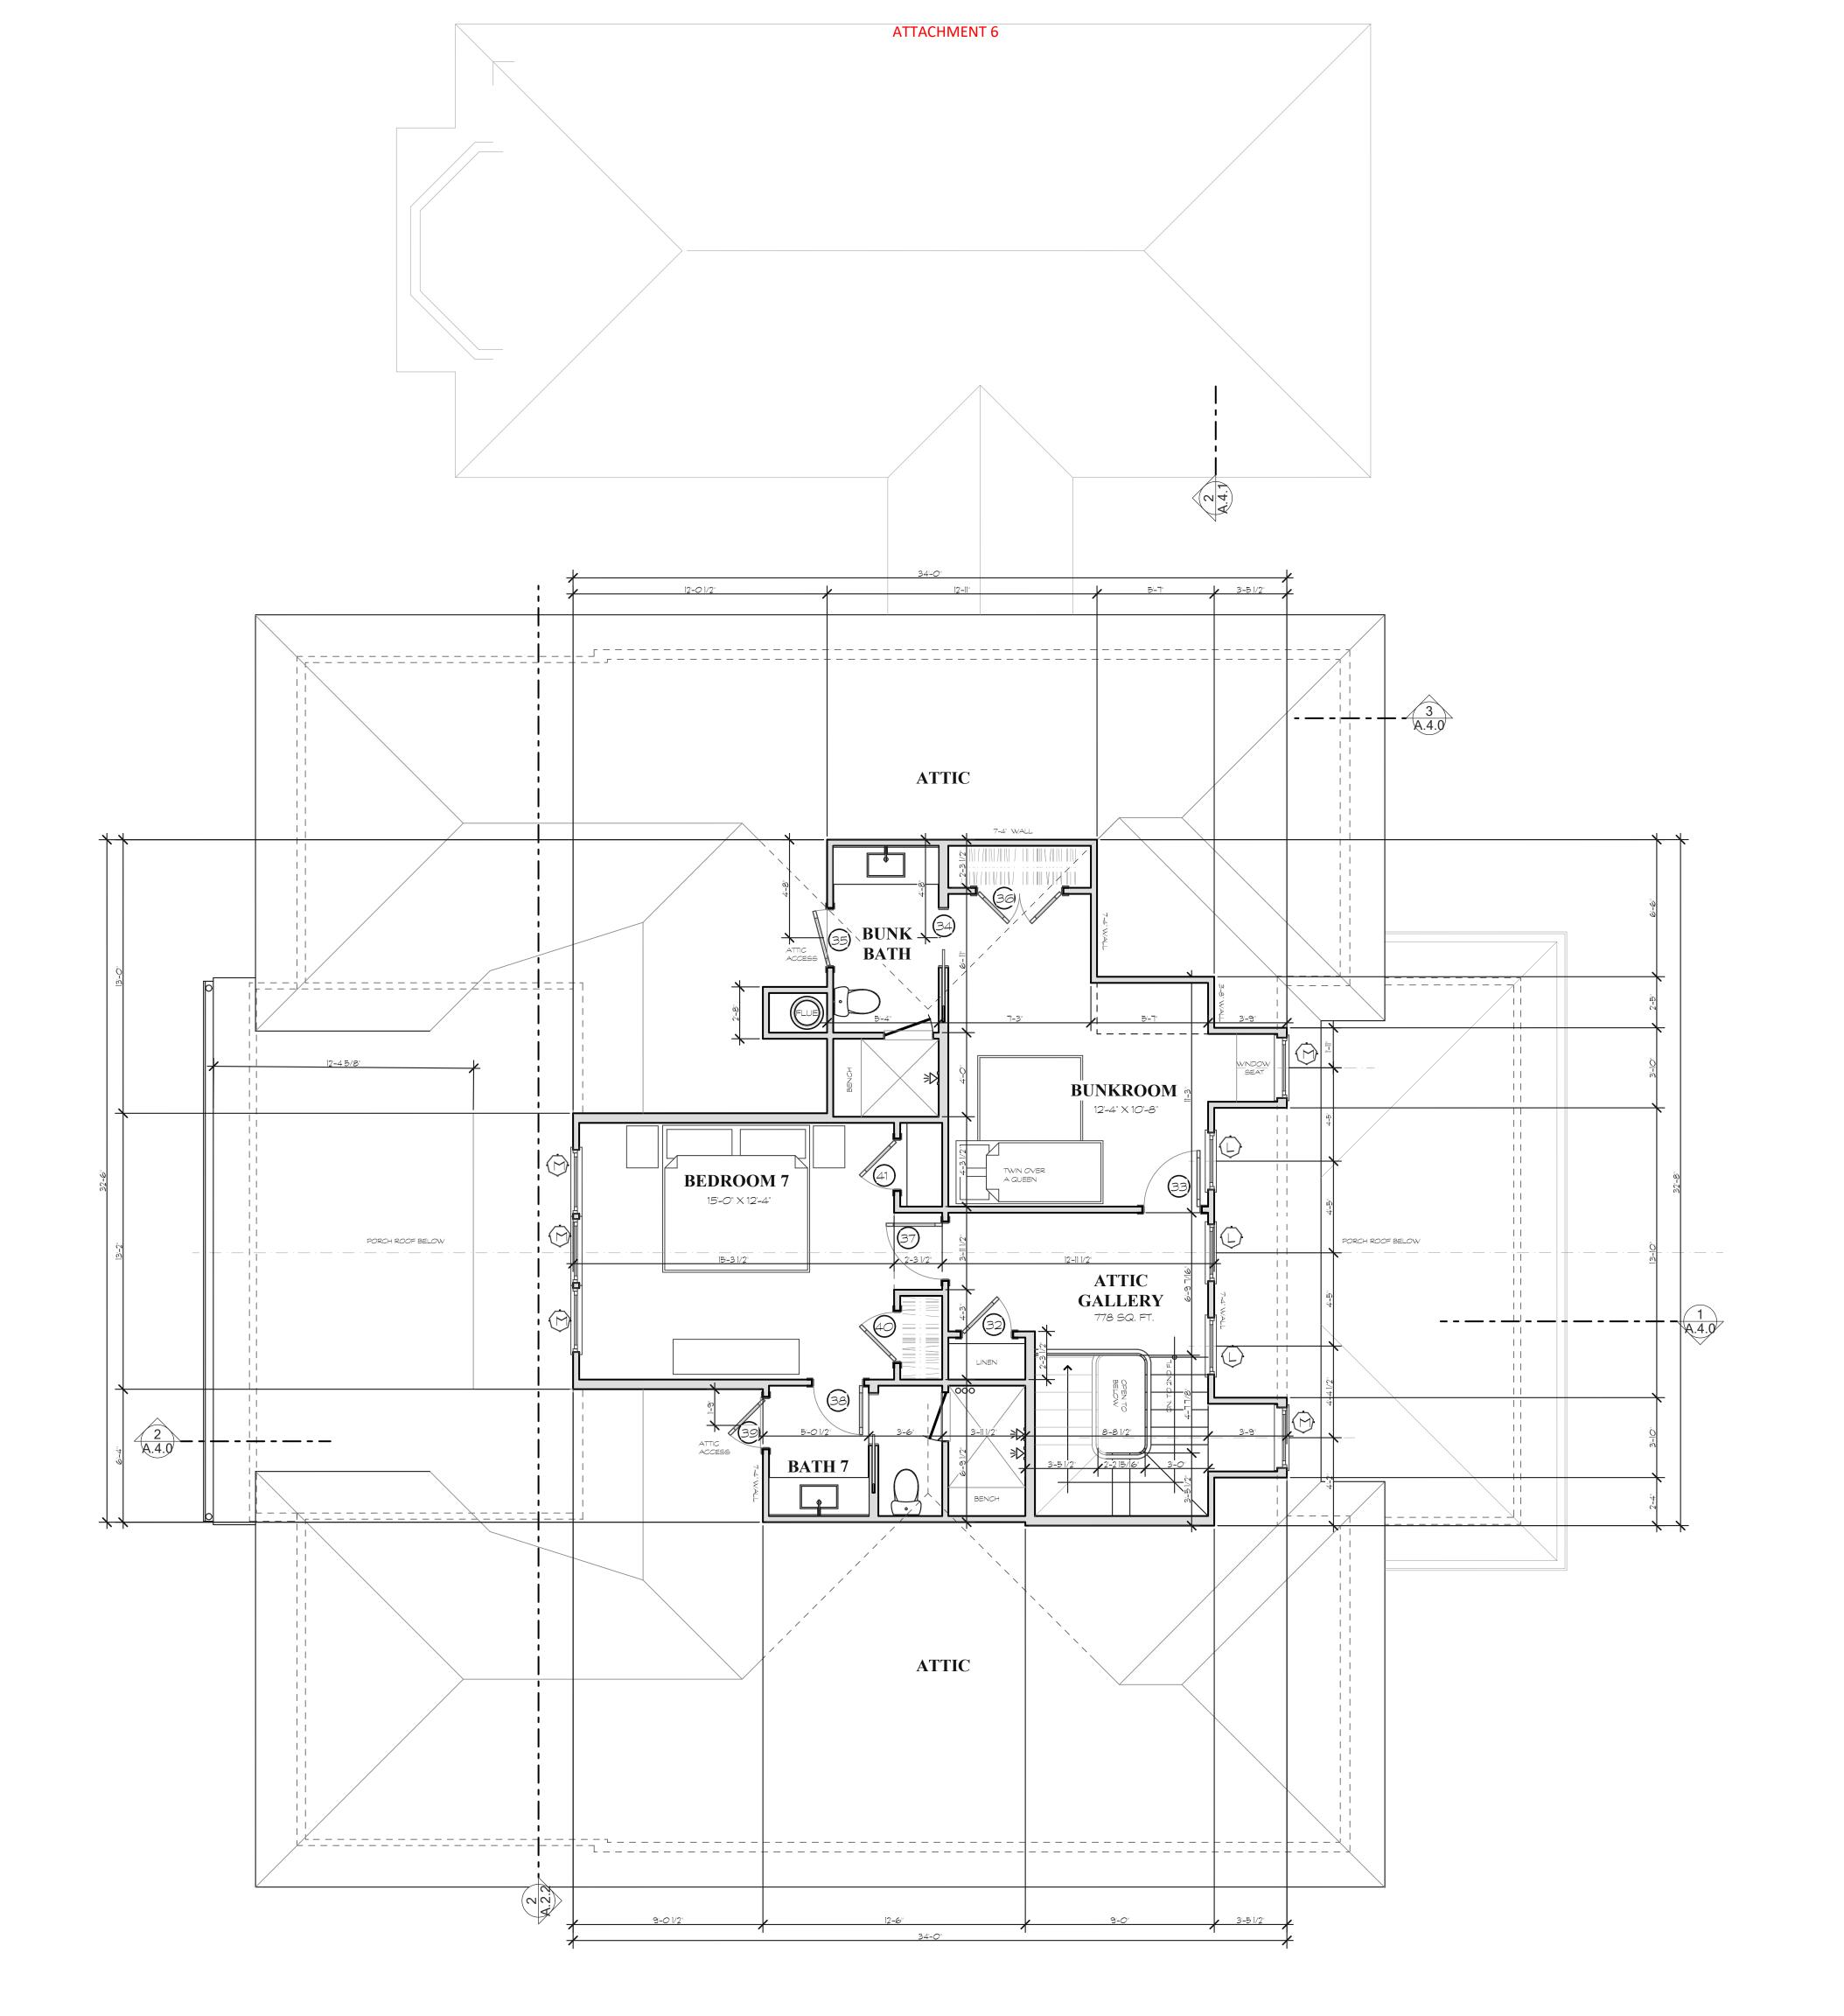



These documents & designs are the property of PDG|Architects & are not to be used or reproduced thereof or for designs, working drawings,or construction of buildings without the written authorization from the copy write owner PDG| Architects 2025 copyright(C)

The Dunaway Family 135 Bridge Street Bluffton, S. C.

REVISIONS DATE

DRAWN BY

WTP

CHECKED BY

DATE OF ISSUE:

5/7/2025


SCALE

JOB NO. 2505 Sheet

ATTIC LEVEL A.1.3

CART PORT **CARRIAGE #2** 718 SQ. FT. T.O.S. @ 23'-6' MSL DRYING YARD

ATTACHMENT 6

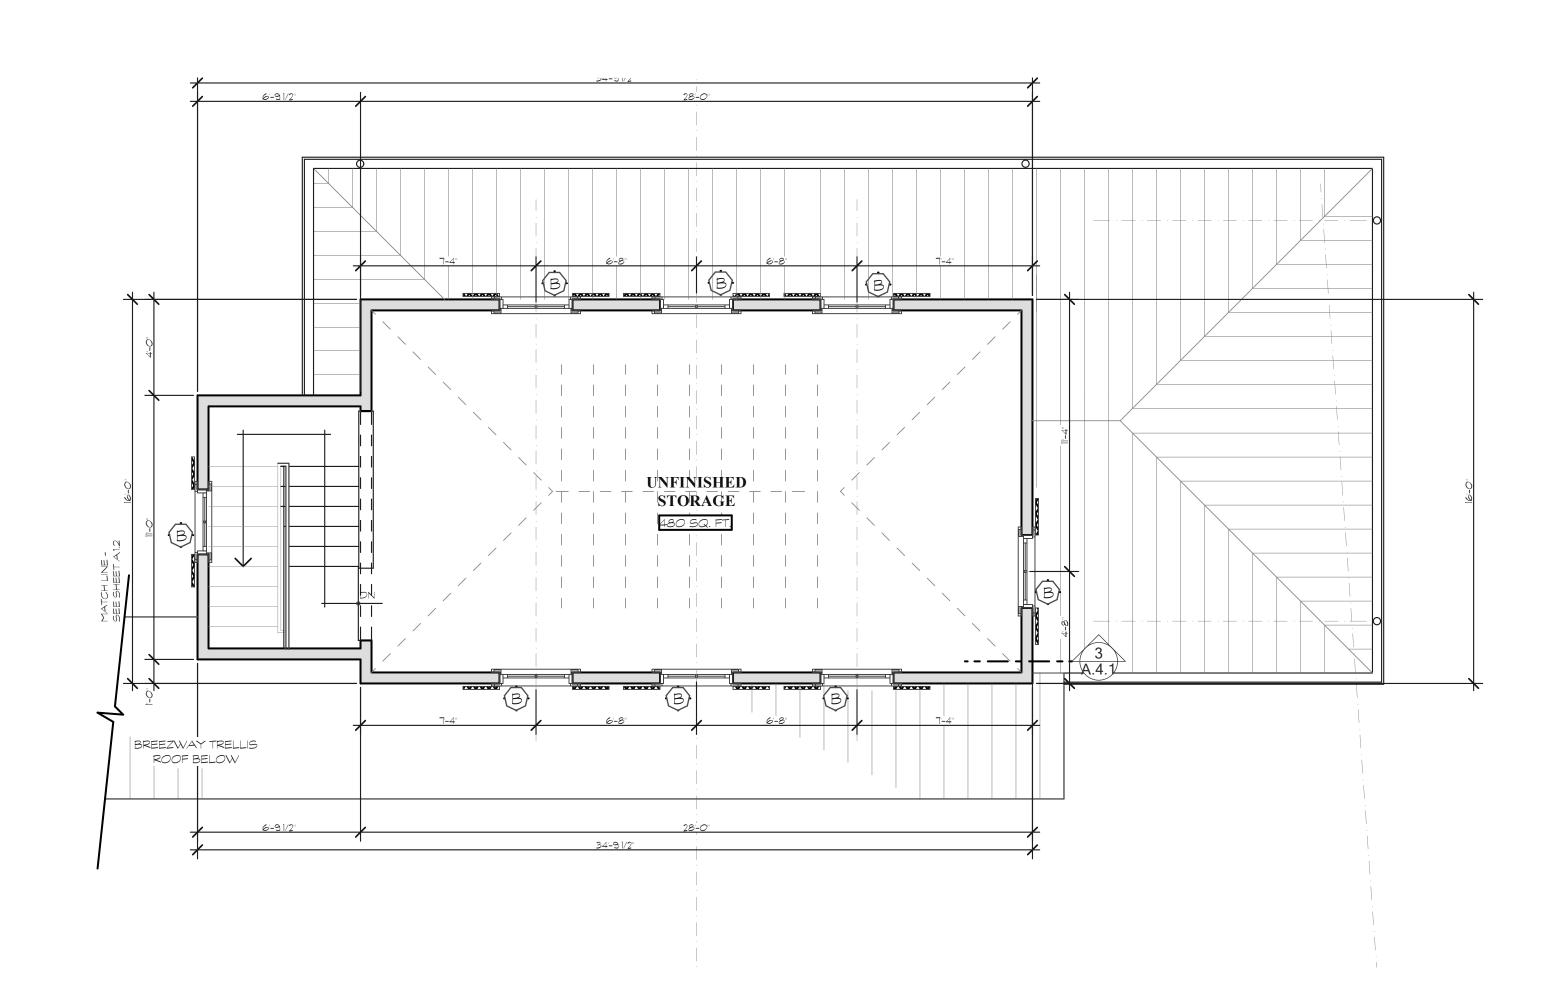

CARRIAGE 2 SECOND FLOOR SCALE: 1/4" = 1'-0"

CARRIAGE 2 FIST FLOOR SCALE: 1/4" = 1'-0"

A New Riverfront Reside
The Dunawa

These documents & designs are the property of PDG|Architects & are not to be used or reproduced thereof or for

designs, working drawings,or construction of buildings without the written authorization from the copy write owner PDG| Architects 2025 copyright

135 Bridge Street Bluffton, S. C.


| DATE |
|------|
| |
| |
DATE OF ISSUE: 5/7/2025

SCALE

CARRIAGE 2 PLANS
A.1.4

SHEETS

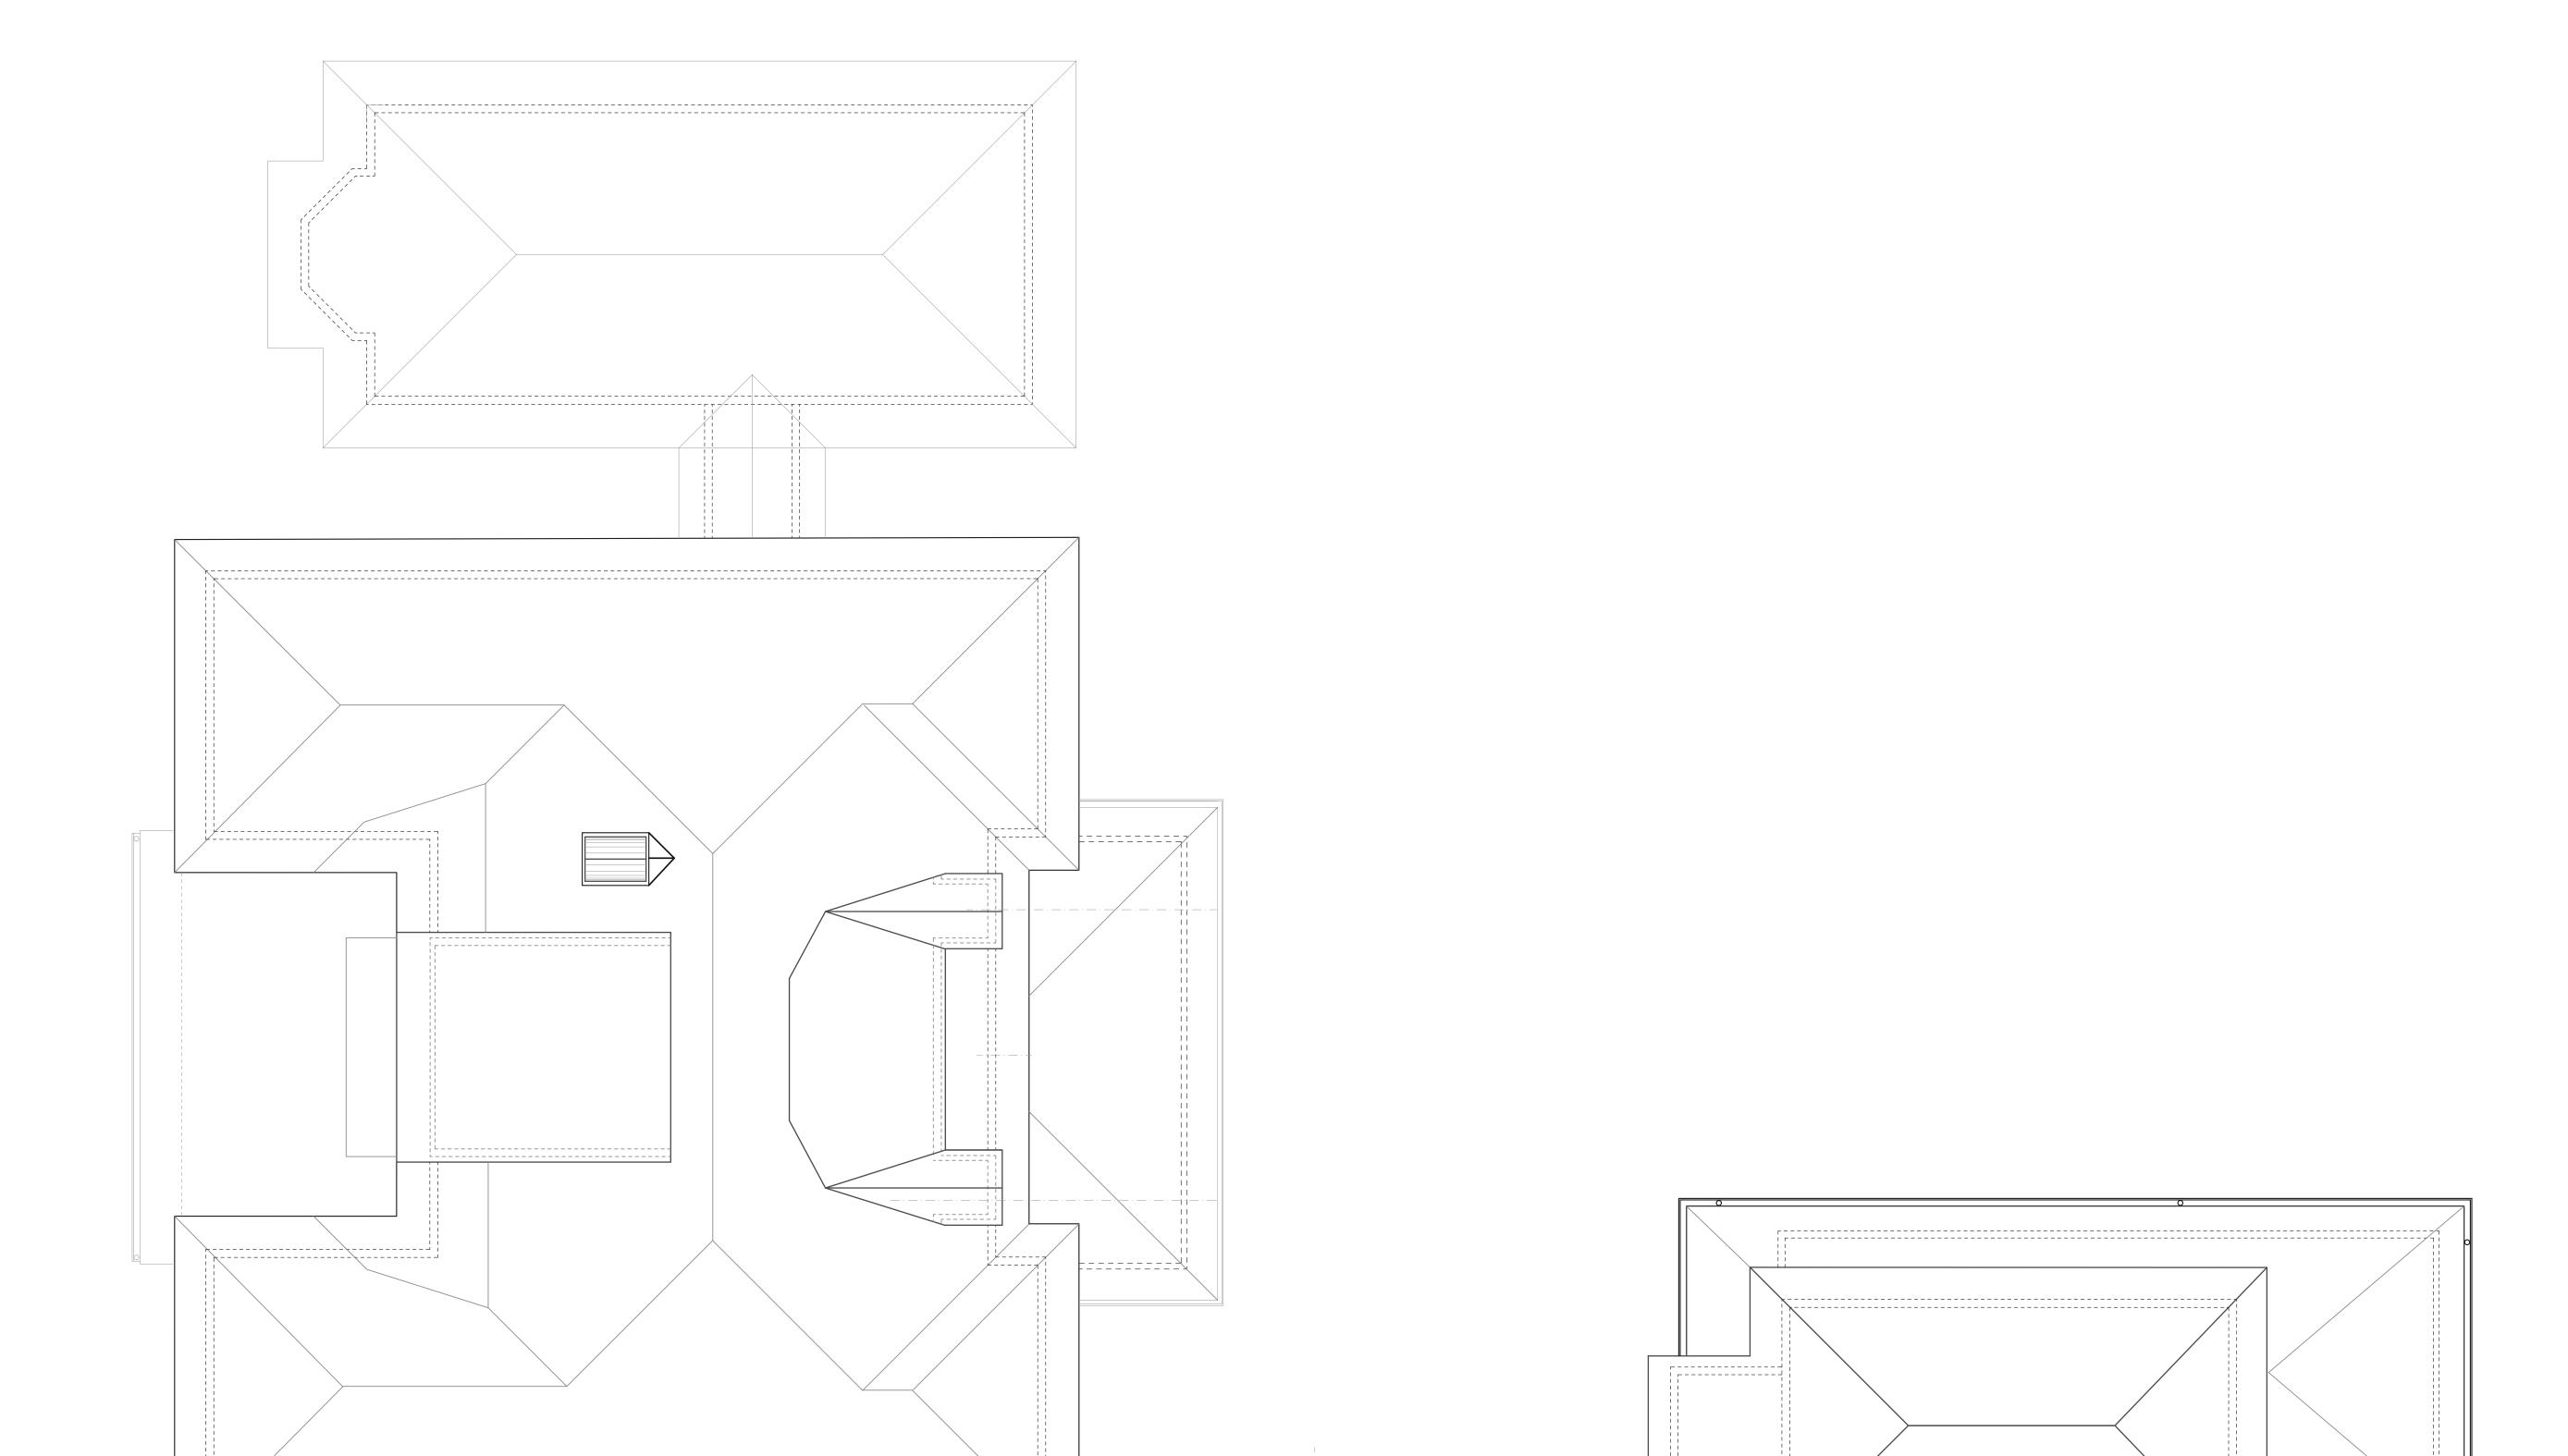

ROOF PLAN 1 SCALE: 3/16" = 1'-0" A.1.5

JOB NO. 2505 SHEET ROOF PLAN
A.1.5

DRAWN BY
WTP
CHECKED BY

DATE OF ISSUE: 5/7/2025
SCALE

These documents & designs are the property of PDG|Architects & are not to be used or reproduced thereof or for designs, working drawings,or construction of buildings without the written authorization from the copy write owner PDG| Architects 2025 copyright


The Dunawa
135 Bridge Street
Bluffton, S. C.

REVISIONS DATE

A New Riverfront Resid

| ROOM | FLOOR | | WAL | L | CEI | LING | REMARKS |
|------------------------------------|--------------|--------------|---------------|------------|-------------|---------|-----------|
| NAME | Material | Base | Material | Finish | Material | Finish | REI IARRS |
| FIRST FLOOR - N | 1AIN HOUS | E | | | | | |
| FOYER | BRICK | WOOD | WOOD | PAINT | GYP. BD. | PAINT | |
| POWDER ROOM | WOOD | WOOD | WOOD | PAINT | GYP. BD. | PAINT | |
| BACK KITCHEN | TILE | WOOD | WOOD | PAINT | GYP. BD. | PAINT | |
| KITCHEN | WOOD | WOOD | WOOD | PAINT | GYP. BD. | PAINT | |
| FAMILY ROOM | WOOD | WOOD | WOOD | PAINT | GYP. BD. | PAINT | |
| SITTING ROOM | WOOD | WOOD | WOOD | PAINT | GYP. BD. | PAINT | |
| DINING ROOM | WOOD | WOOD | WOOD | PAINT | GYP. BD. | PAINT | |
| STUDY | WOOD | WOOD | WOOD | PAINT | GYP. BD.* | PAINT | |
| STAIR AT 1ST FLR | WOOD | WOOD | WOOD | PAINT | GYP. BD. | PAINT | |
| SCREEN PORCH | IPE' | AZEK | SIDING | PAINT | V GROOVE | PAINT | |
| | | | | | | | |
| | | | | | | | |
| SECOND FLOOR - | MAIN HOUS | E | | - | - | | |
| BEDROOM #1 | WOOD | WOOD | GYP. BD. | PAINT | GYP. BD. | PAINT | |
| BATH #1 | TILE | WOOD | GYP. BD. | PAINT | GYP. BD. | PAINT | |
| BEDROOM #2 | WOOD | WOOD | GYP. BD. | PAINT | GYP. BD. | PAINT | |
| BATH #2 | TILE | WOOD | GYP. BD. | PAINT | GYP. BD. | PAINT | |
| BEDROOM #3 | WOOD | WOOD | GYP. BD. | PAINT | GYP. BD. | PAINT | |
| BATH #3 | TILE | WOOD | GYP. BD. | PAINT | GYP. BD. | PAINT | |
| STAIR @ 2ND FLR | WOOD | WOOD | GYP. BD. | PAINT | GYP. BD. | PAINT | |
| UPPER GALLERY | WOOD | WOOD | GYP. BD. | PAINT | GYP. BD. | PAINT | |
| LAUNDRY | TILE | WOOD | GYP. BD. | PAINT | GYP. BD. | PAINT | |
| BEDROOM #4 | WOOD | WOOD | GYP. BD. | PAINT | GYP. BD. | PAINT | |
| | TILE | WOOD | GYP. BD. | PAINT | GYP. BD. | PAINT | |
| BEDROOM #5 | WOOD | WOOD | GYP. BD. | PAINT | GYP. BD. | PAINT | |
| BATH #5 | TILE | WOOD | GYP. BD. | PAINT | GYP. BD. | PAINT | |
| BEDROOM #6 | WOOD | WOOD | GYP. BD. | PAINT | GYP. BD. | PAINT | |
| | TILE | WOOD | GYP. BD. | PAINT | GYP. BD. | PAINT | |
| BATH #6 KIDS FAMILY RM | WOOD | WOOD | GYP. BD. | PAINT | GYP. BD. | PAINT | |
| GUEST DECK | IPE' | AZEK | SHINGLE | PAINT | V GROOVE | | |
| COLST DLCK | IT L | 7 2217 | 31 111 (0 111 | 1 / 11 1 | VERSOVE | 7 31 11 | |
| | | | | | | | |
| ATTIC FLOOR - M. | AIN HOUSE | | | | | | |
| | WOOD | WOOD | GYP. BD. | PAINT | GYP. BD. | PAINT | |
| STAIR @ 3RD FLR | | WOOD | GYP. BD. | PAINT | GYP. BD. | PAINT | |
| | WOOD | | GYP. BD. | PAINT | GYP. BD. | PAINT | |
| BEDROOM #7 | TILE | WOOD WOOD | GYP. BD. | PAINT | GYP. BD. | PAINT | |
| BATH #7 | | WOOD | GYP. BD. | PAINT | | PAINT | |
| BUNKROOM | WOOD TILE | WOOD | GYP. BD. | PAINT | GYP. BD. | PAINT | |
| BUNK BATH | | VV 0 0 D | OTF.DD. | F / VI V I | OTP. DD. | PAIN | |
| | | | | | | | |
| CARRIAGELIQUIGE | #0 CDOUN | | | | | | |
| CARRIAGE HOUSE | | | TYP X GYPSUM/ | DAINIT | 5/8" TYPE X | PAINT | |
| | EPOXYFLAKE | | STUCCO | PAINT | GYP. BD. | | |
| STAIRWAY | TILE | WOOD | GYP. BD. | PAINT | GYP. BD. | PAINT | |
| | | | | | | | |
| | 40 1007 | FI 005 | | | | | |
| C 1 DD 1 1 C - 1 1 - 1 | #2 - UPPER | FLOOR | | | | | |
| CARRIAGE HOUSE | | _ | _ | - | - | - | |
| CARRIAGE HOUSE UNFINISHED STOR. | - | | | | | | |


ATTACHMENT 6

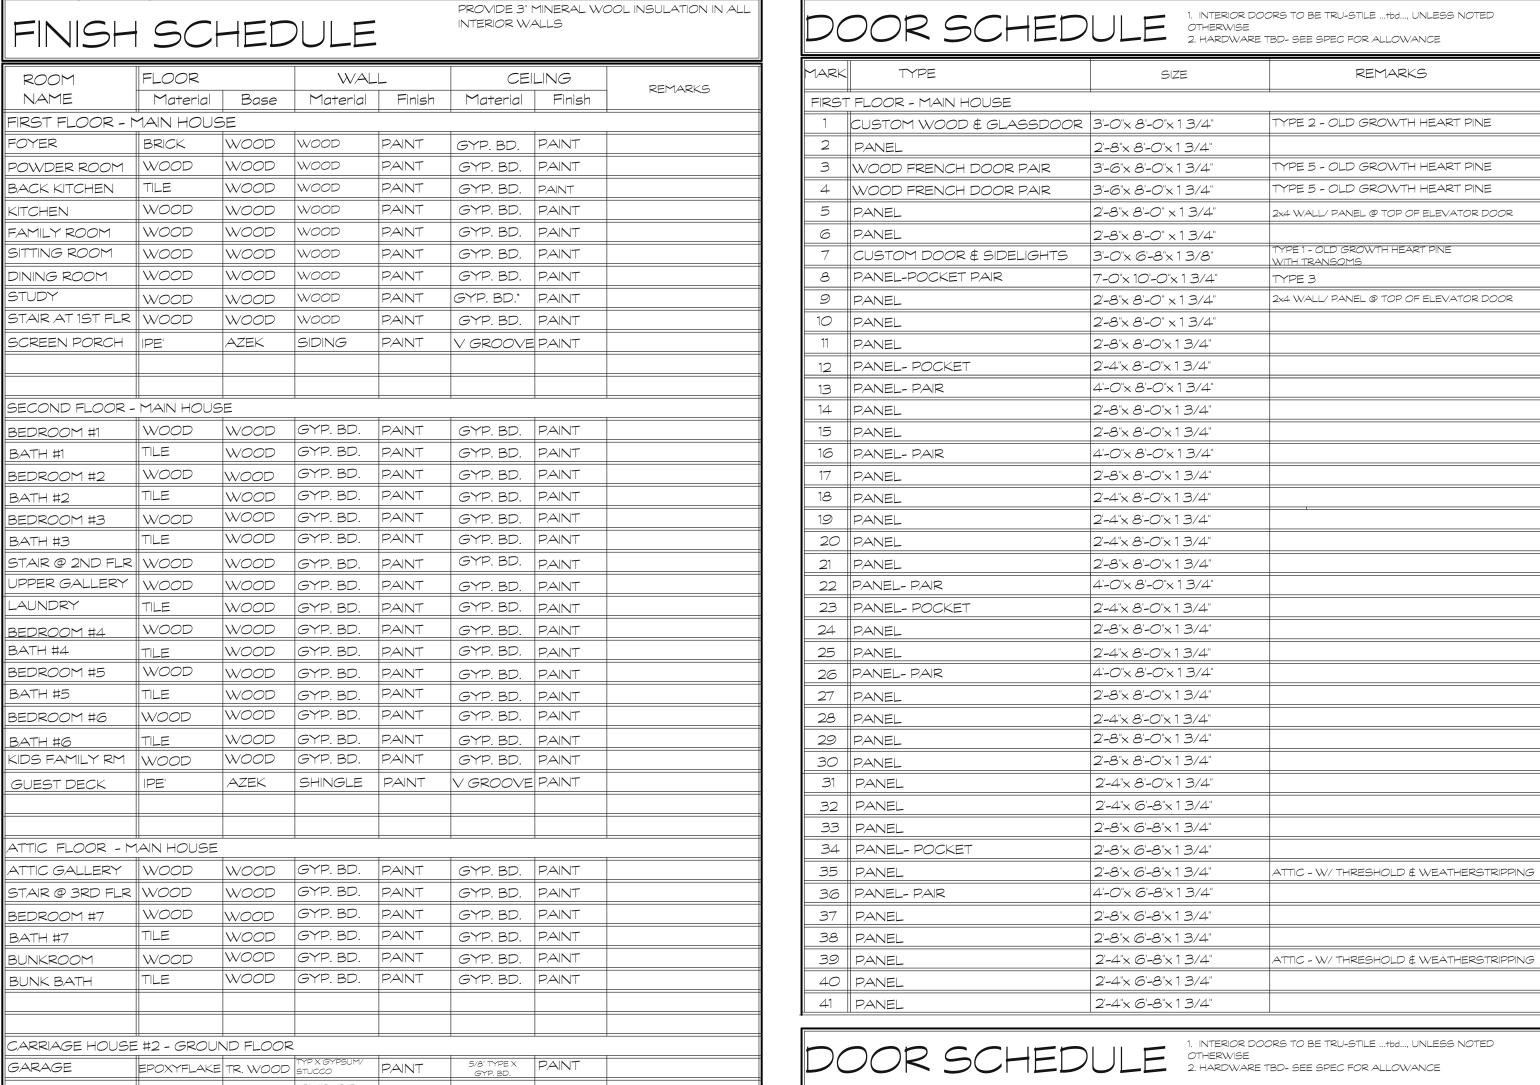



| DC | DOOR SCHEDULE 1. INTERIOR DOORS TO BE TRU-STILE+bd, UNLESS NOTED OTHERWISE 2. HARDWARE TBD- SEE SPEC FOR ALLOWANCE | | | | |
|------|---|----------------------|--|--|--|
| MARK | TYPE | SIZE | REMARKS | | |
| CARR | RIAGE HOUSE #1 - FIRST FLOOR | | | | |
| 42 | PANEL-PAIR | 4'-0"x 8'-0"x 1 3/4" | | | |
| 43 | PANEL | 2'-8"x 8'-0"x 1 3/4" | | | |
| 44 | PANEL | 2'-4"× 8'-0"×13/4" | | | |
| 45 | PANEL- POCKET | 3'-0"x 8'-0"x 1 3/4" | | | |
| 46 | CUSTOM WOOD & GLASSDOOR | 3'-0"x 8'-0"x 1 3/4" | TYPE 4 - OLD GROWTH HEART PINE W/2'-0" TRANSOM | | |
| | | | | | |
| CARR | IAGE HOUSE #2 - GROUND FLOO | R | | | |
| 47 | CLOPAY CANYON RIDGE | 9'-0" × 8'-0" | CARRIAGE HOUSE - 4 LAYER - REC 14 TOP | | |
| 48 | CLOPAY CANYON RIDGE | 9'-0" × 8'-0" | CARRIAGE HOUSE - 4 LAYER - REC 14 TOP | | |
| 49 | THERMA-TRU FIBERGLASS | 3'-0"× 6'-8"×13/8" | SMOOTH STAR S220 | | |
| 50 | THERMA-TRU FIBERGLASS | 2'-8"x 6'-8"x 1 3/8" | SMOOTH STAR S220 | | |
| 51 | THERMA-TRU FIBERGLASS | 2'-8"x 6'-8"x 1 3/8" | SMOOTH STAR S220 | | |
| | | | | | |


| \bigvee | INDOW S | CHEDULE | MARVIN CLAD WOOD WINDOWS W/ ARGON FILL LOW E² GLASS, GUNMETAL, 5/8" SDL, \$ IMPACT GLASS- SEE ELEVATIONS FOR LITE PATTERN \$ DP RATINGS |
|-----------|--|-------------------------------|---|
| 1ARK | TYPE | RO SIZE | REMARKS |
| A | DOUBLE HUNG | 2'-8" × 6'-8" | |
| В | DOUBLE HUNG | 2'-6 × 5'-0" | |
| C | DOUBLE HUNG | 3'-6" × 6'-8" | |
| D | DOUBLE HUNG | 2'-8" × 8'-0" | |
| E | DOUBLE HUNG | 3'-0" × 7'-6" | |
| F | DOUBLE HUNG | (2) 3"-8" × 7'-6" | FACTORY-MULLED UNIT |
| G | DOUBLE HUNG | 3'-10" X 6'-8" | |
| Н | DOUBLE HUNG | 2'-8" X 6'-0" | |
| J | OVAL FIXED GLASS | 2'-6" X 4'-0" | SEE ELEVATION |
| K | FIXED GLASS | 4'-4" × 6'-4" | SEE ELEVATION |
| L | FIXED GLASS | 2'-8" × 2'-8" | |
| Μ | DOUBLE HUNG | 3'-0" X 5'-4" | |
| Ν | SWINGING PATIO DOOR | 3'-0" X 10'-0" | FULL VIEW |
| Р | SWINGING PATIO DOOR | 6'-0" X 10'-0" | FULL VIEW PAIR |
| Q | SWINGING PATIO DOOR | 3'-0" X 8'-0" | FULL VIEW |
| R | SWINGING PATIO DOORS WITH (2) SIDELIGHTS | 6'-0" × 8'-0" W/2'-2" × 8"-0" | SEE ELEVATION |
| S | DOUBLE HUNG | 2'-6" × 5'-8" | |

| JAMB TRM PROUD_5/4" FROM FREIZE PAINTGRADE FRAME & TRIM | |
|--|---|
| SIDE LIGHTS & TRANSOMS OLD GROWTH HEART PINE FLAT PANEL W/ SIMPLE OGEE STICK | |
| ROCKY MOUNTAIN Arched Entry Set 3 1/2" x 26" BBB FINISH SALVAGED ANTIQUE GLASS | |
| BRONZE THRESHOLD 1-6" 3" 3-6" 3" 1-6" ON CUT SILL T-0" TYPE 1 | _ |
| ENTRY DOOR ELEVATION 1 | \ |

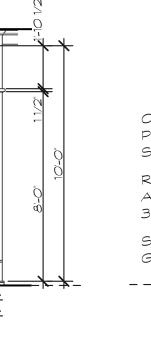

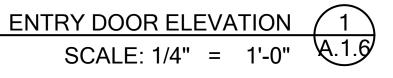

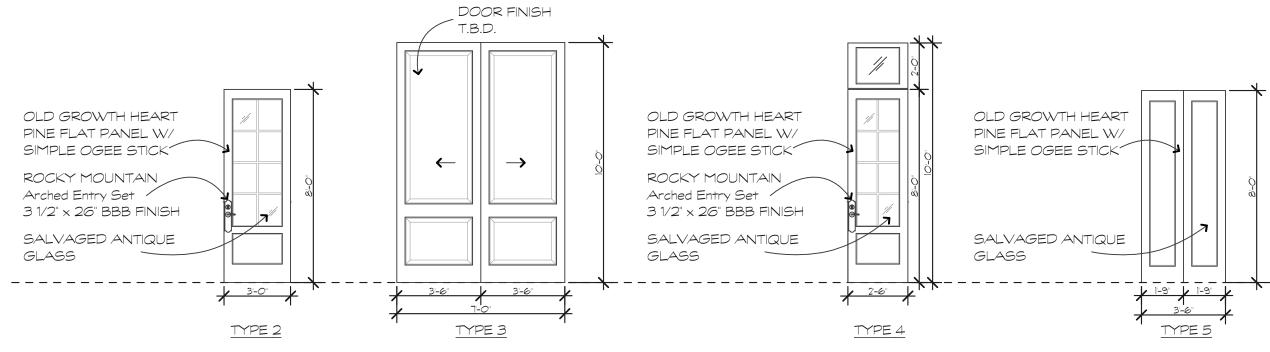

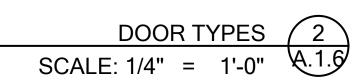

| A New Riverfront Resid | The Dunawa | 135 Bridge Street | Bluffton, S. C. |
|------------------------|----------------|-------------------|--------------------|
| | SIONS | | DATE |
| | | | |
| | | | |
| | | | |
| | | | |
| | | | |
| | | | |
| | | | |
| | | \perp | |
| | | | |
| | | \dashv | |
| | | | |
| DRAWN WTP | ВУ | | |
| CHECKE | D BY | | |
| DATE OF 5/7/2 | ISSUE: 2025 | | |
| SCALE | | | |
| JOB NO. 2505 | | | |
| SHEET | | | |
| | Δ . | ULES | $\hat{\mathbf{S}}$ |
| OF | | SHEETS | S |

hese documents & designs are the

property of PDG|Architects & are not to

be used or reproduced thereof or for designs, working drawings, or

onstruction of buildings without the written authorization from the copy

write owner PDG| Architects 2025

mily

opyright(C)



_----

RIVER ELEVATION 1 SCALE: 1/8" = 1'-0" A.2.0

FRONT ELEVATION

SCALE: 1/8" = 1'-0"

These documents & designs are the property of PDG|Architects & are not to be used or reproduced thereof or for

designs, working drawings,or construction of buildings without the written authorization from the copy write owner PDG| Architects 2025 copyright


135 Bridge Street Bluffton, S. C.

REVISIONS DATE

DATE OF ISSUE: 5/7/2025

JOB NO. 2505

1/8" BUILDING ELEVATIONS A.2.0

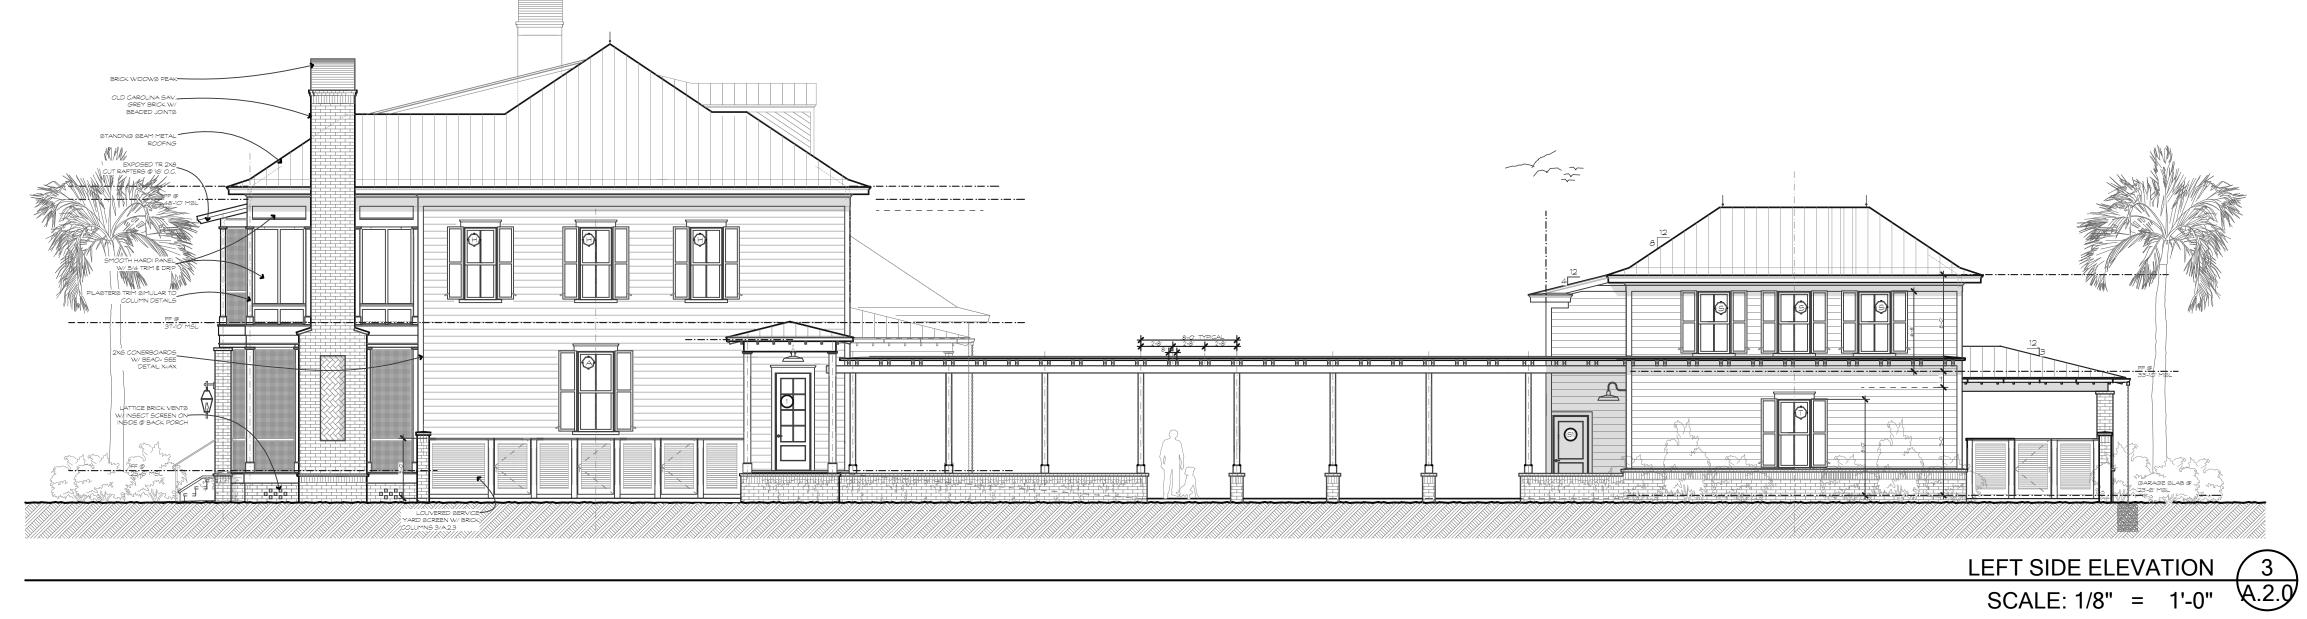

FRONT ELEVATION CARRIAGE 2 5

SCALE: 1/8" = 1'-0" A.2.0

RIGHT SIDE ELEVATION 4


SCALE: 1/8" = 1'-0" A.2.0




FRONT ELEVATION 1
SCALE: 1/4" = 1'-0" A.2.1

-TYICAL ROOFING-1X4 TIGHT JOINT— SHIPLAP SIDING BROKEN COPPER-FLASHING _3 9/16"+- CROWN CYMA TRIM _1X6 TIGHT JOINT SHIPLAP SIDING 2 X 6 CONER/JAMB -_11/4" QUARTER— ROUND __2x6 CORNER TRIM —STEP FLASHING TO MATCH ROOFING 2X4 FRAMING @ DORMER NOTE: ALL TRIM TO BE FLY ASH OR PVC UNLESS NOTED OTHERWISE

FRONT ENTRY DORMER DETAIL 1
SCALE: 1/2" = 1'-0" A.2.1

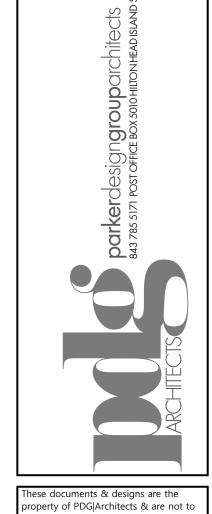

be used or reproduced thereof or for designs, working drawings,or construction of buildings without the written authorization from the copy write owner PDG| Architects 2025

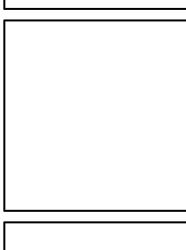


ay The Dunaw New Riverfront Resid 135 Bridge Street Bluffton, S. C.

| <u> </u> | | 1. B |
|-------------------------|-------|---------|
| REVI | SIONS | DATE |
| | | |
| | | |
| DRAWN NTP CHECKED | | |
| DATE OF | | |

SCALE

JOB NO. 2505 SHEET

A.2.1

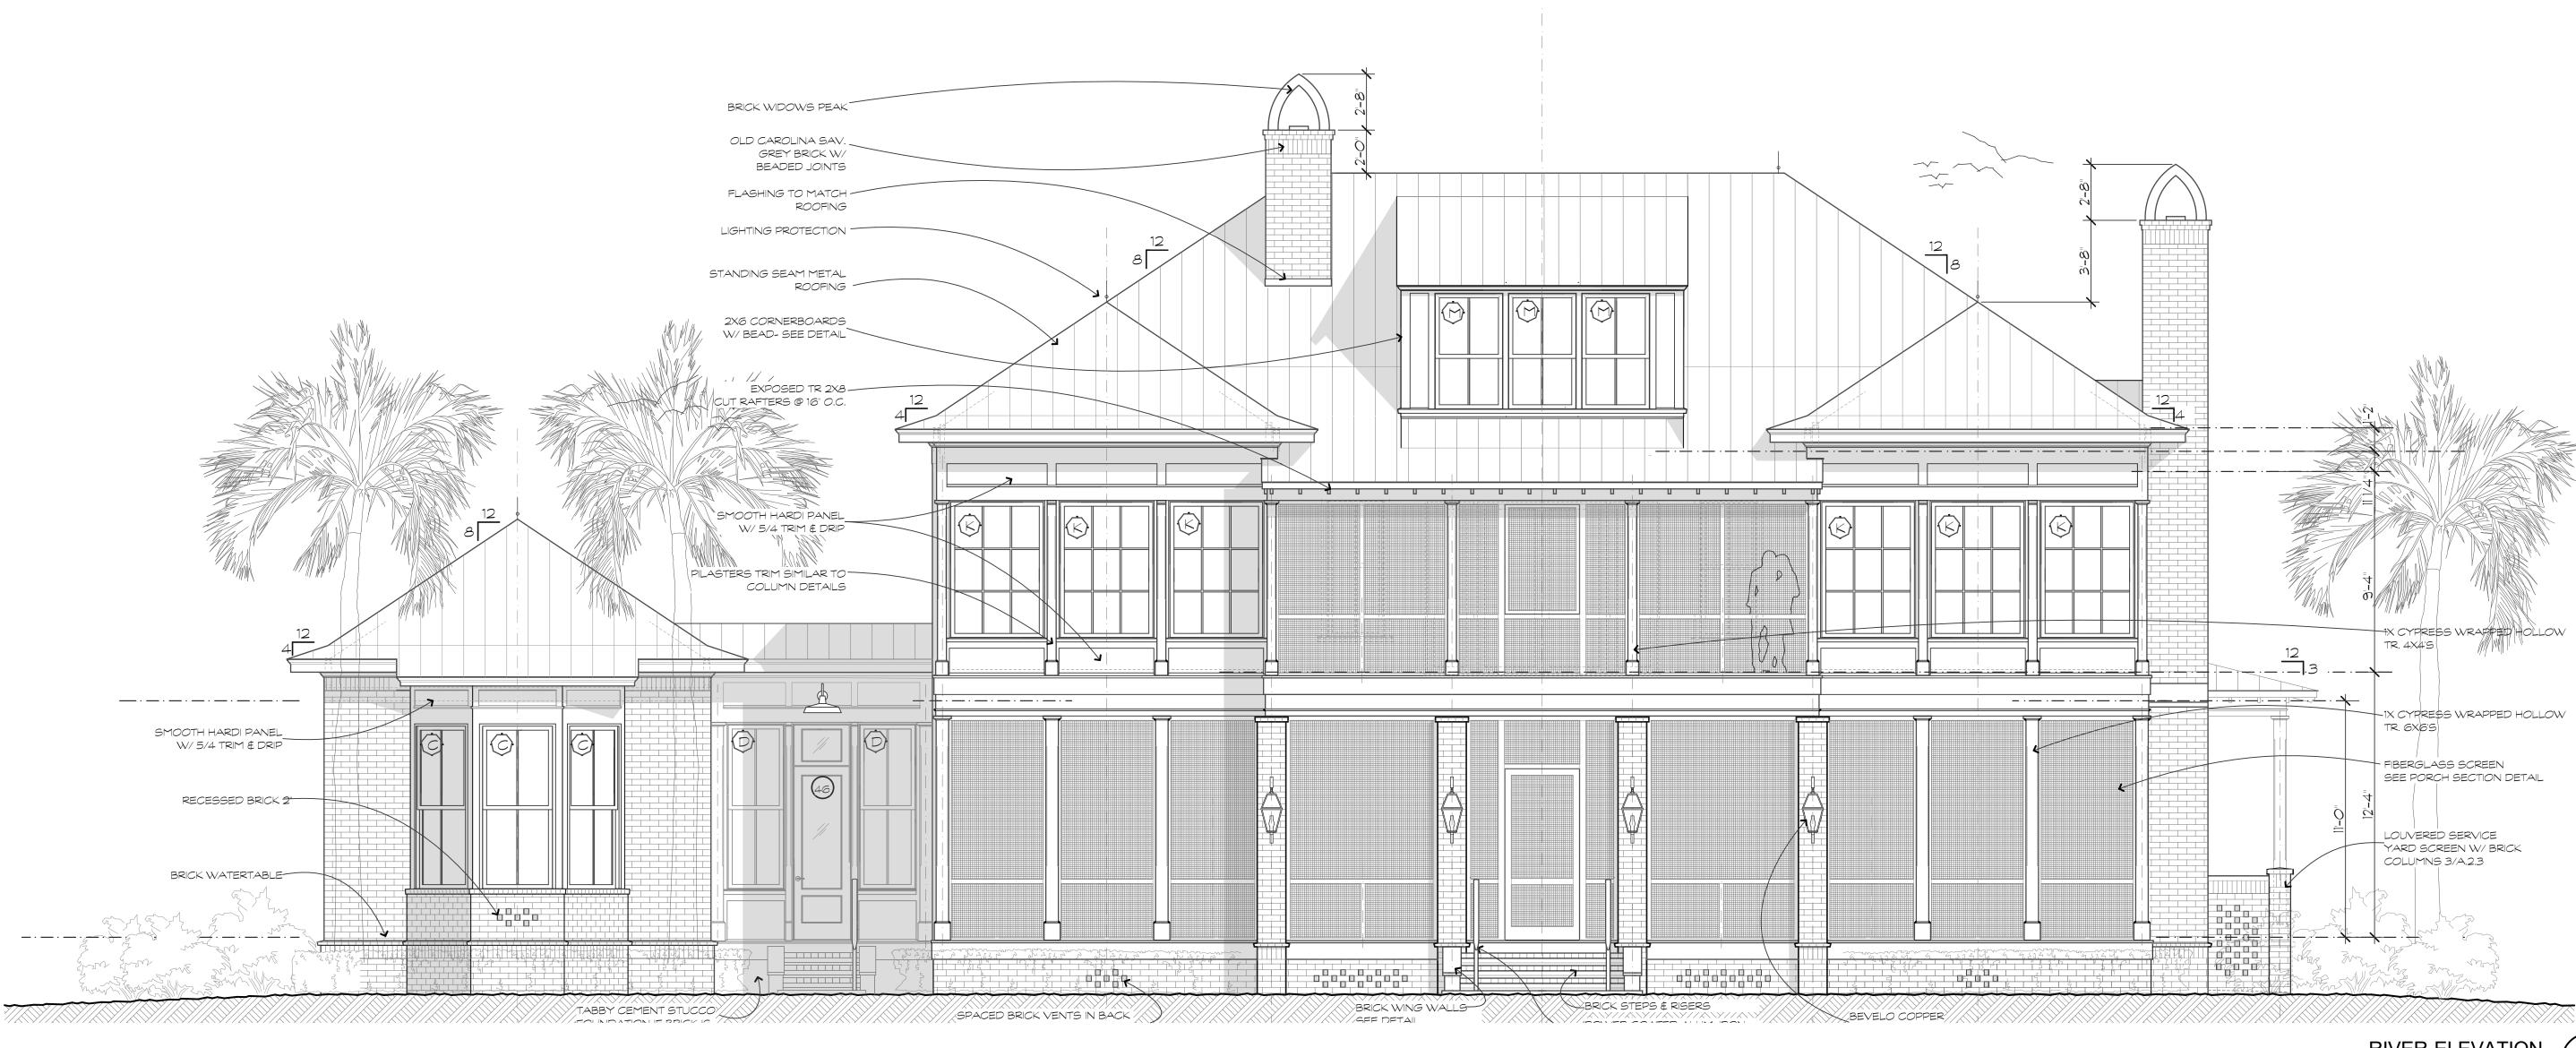

ATTACHMENT 6

RIVER ELEVATION SCALE: 1/4" = 1'-0"

SCREEN PORCH ELEVATION 2 SCALE: 1/4" = 1'-0" A.2.2

The Dunaw A New Riverfront Resid

These documents & designs are the property of PDG|Architects & are not to be used or reproduced thereof or for designs, working drawings,or construction of buildings without the written authorization from the copy

write owner PDG| Architects 2025

135 Bridge Street Bluffton, S. C. REVISIONS DATE

DRAWN BY
WTP
CHECKED BY

DATE OF ISSUE: 5/7/2025

A.2.2

JOB NO. 2505



51

BRICK PILASTER W/ #5 VERTICAL BAR PLAN VIEW _SLOPED BRICK CAP TR. 2X8 CAP W/ CUT DRIP- SLOPE SLIGHTLY TR. 1X4 FRAME _ PIERCED BRICK TO MATCH THE HOUSE CHAMFERED TR.6 × 6 — POSTS SET IN CONC. FOOTERS TR. 2X6 W/ BEVELED TOP & FAUX PLUGS SEE ELEVATION SLOPED BROOM FINISH CONC. @ 1/4"/1'-0"

WINDOW IN SIDING 3
SCALE: 3/4" = 1'-0" A.2.3

CARRIAGE #2 LEFT SDIE ELEVATION 2
SCALE: 1/4" = 1'-0" A.2.3

SCALE: 1/4" = 1'-0"

mily The Dunaw

135 Bridge Street Bluffton, S. C.

REVISIONS DATE

DRAWN BY
WTP
CHECKED BY

JOB NO. 2505

LEFT SIDE ELEVATION A.2.3



MAIN HOUSE RIGHT SIDE ELEVATION 1
SCALE: 1/4" = 1'-0" A.2.4

A New Riverfront Residence for:

The Dunaway Family
135 Bridge Street
Bluffton, S. C.

These documents & designs are the property of PDG|Architects & are not to be used or reproduced thereof or for designs, working drawings,or construction of buildings without the written authorization from the copy write owner PDG| Architects 2025 copyright (C)

| AN | | 13 | Blu |
|------------------|-------|----|------|
| REVI | SIONS | | DATE |
| | | | |
| | | | |
| DRAWN WTP | ВҮ | | |
| CHECKED |) BY | | |
| DATE OF 5/7/2 | | | |

JOB NO. 2505

RIGHT SIDE ELEVATION



CARRIAGE #2 RIGHT SIDE ELEVATION 2

SCALE: 1/4" = 1'-0" A.2.4



CARRIAGE 2 FRONT ELEVATON 2
SCALE: 1/4" = 1'-0" A.2.5

CARRIAGE 1 RIGHT SIDE ELEVATION 1
SCALE: 1/4" = 1'-0" A.2.5


CARRIAGE 1 LEFT SDIE ELEVATION 3
SCALE: 1/4" = 1'-0" A.2.5


CARRIAGE 2 COURTYARD ELEVATION 4
SCALE: 1/4" = 1'-0" A.2.5 DRAWN BY
WTP
CHECKED BY CARRIAGE 1 & 2
ELEVATIONS


A.2.5

REVISIONS DATE

These documents & designs are the property of PDG|Architects & are not to be used or reproduced thereof or for designs, working drawings, or construction of buildings without the written authorization from the copy write owner PDG| Architects 2025

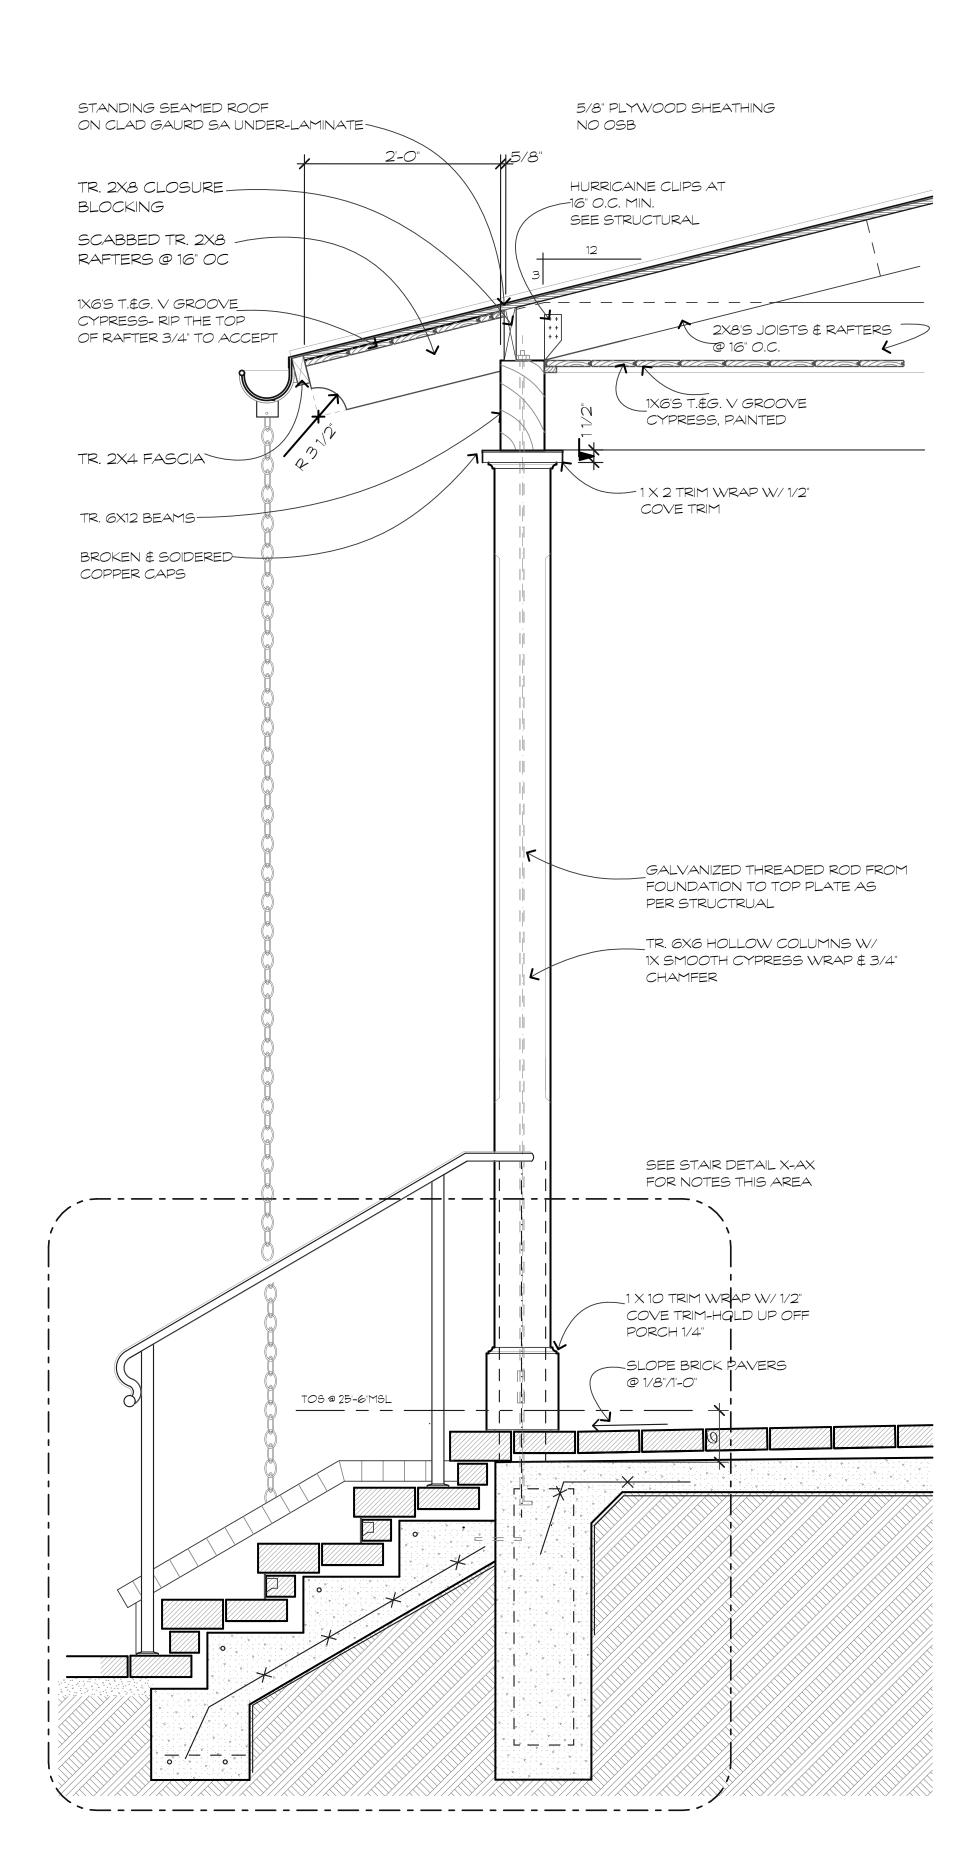

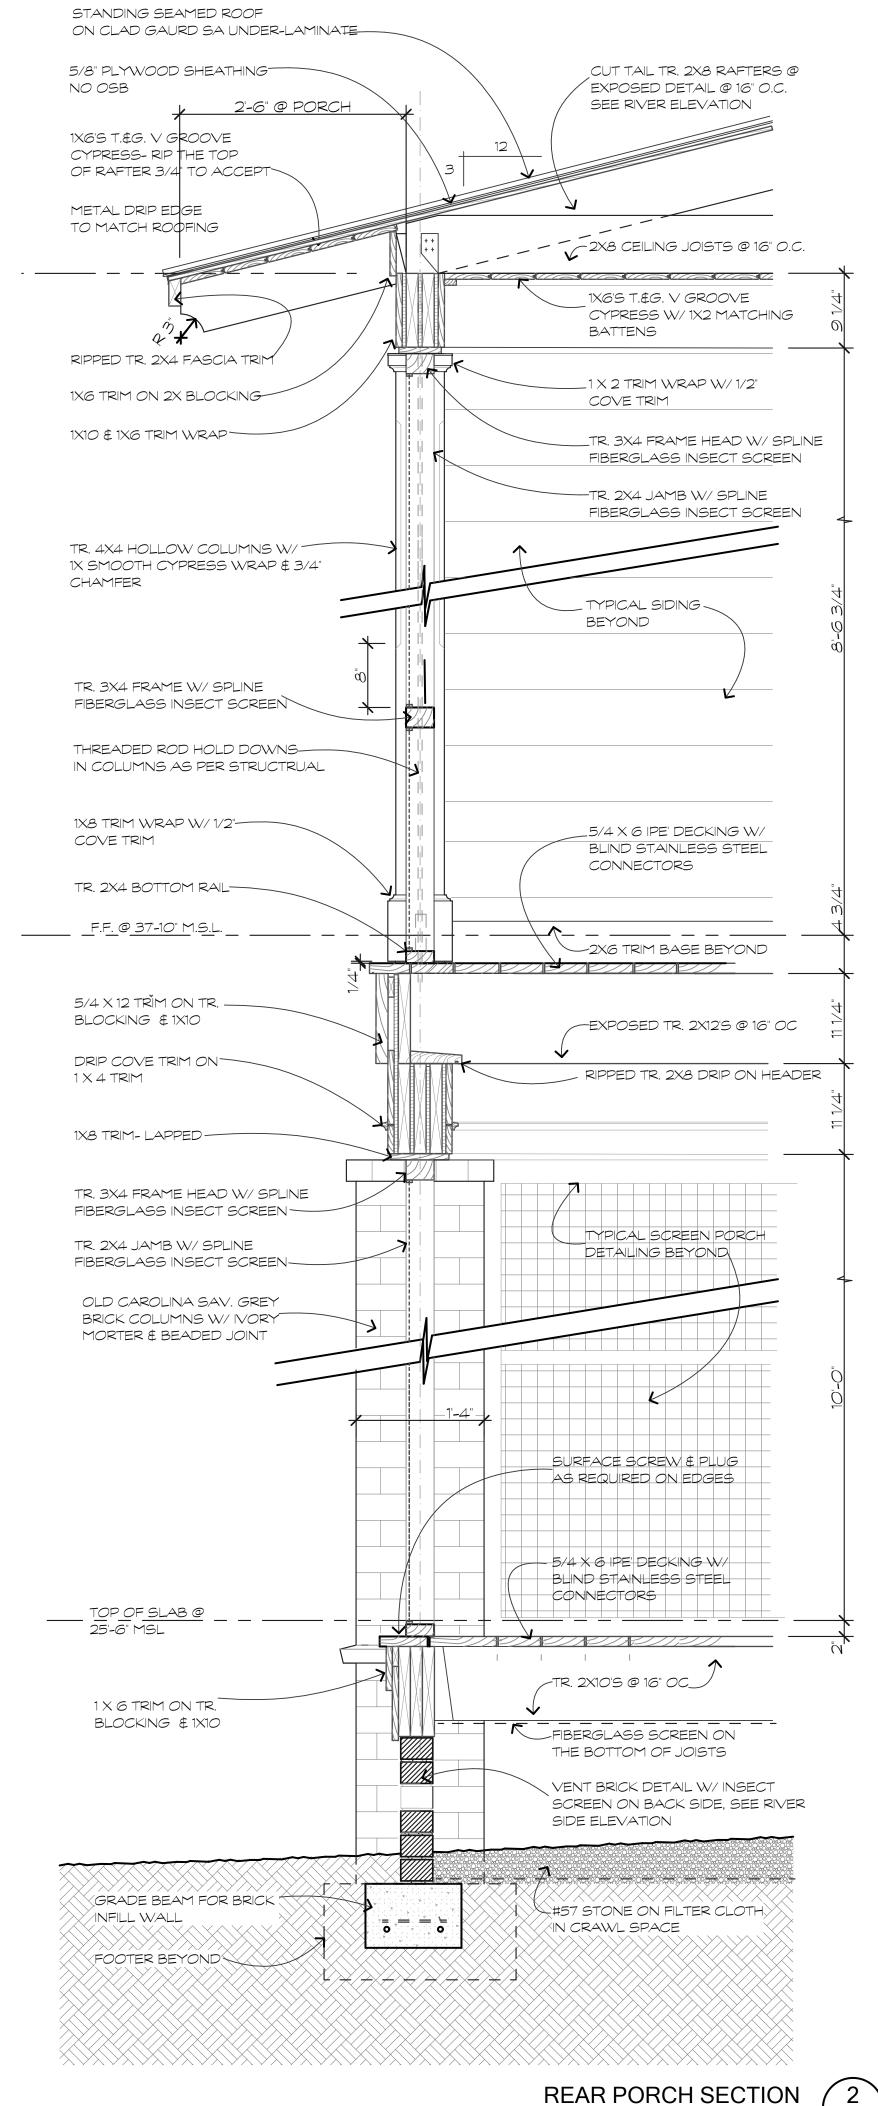

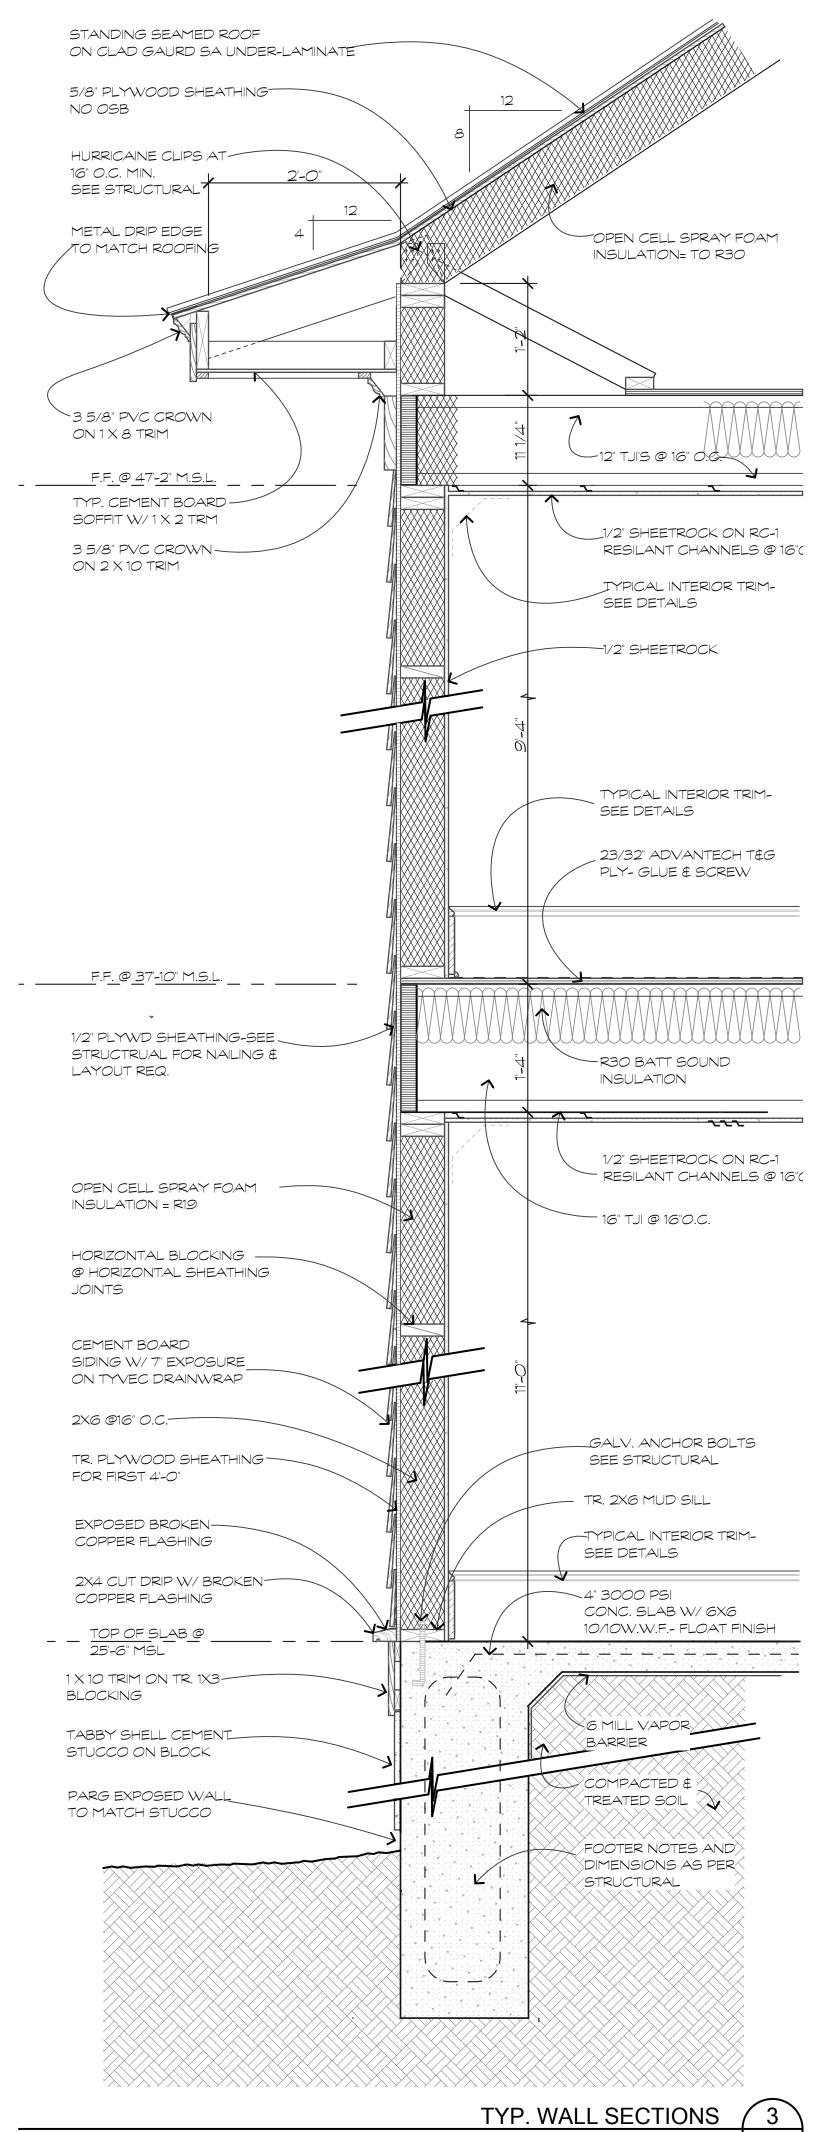

parker design group architects
843 785 5171 POST OFFICE BOX 5010 HILTON HEAD ISLAND SC 29938
ARCHITECTS

These documents & designs are the property of PDG|Architects & are not to be used or reproduced thereof or for designs, working drawings,or construction of buildings without the written authorization from the copy write owner PDG| Architects 2025 copyright

iverfront Residence for:

Dunaway Family

Joe Street

DRAWN BY
WTP
CHECKED BY


DATE


DATE

FRONT PORCH SECTION 1
SCALE: 1" = 1'-0" A.4.0

WALL SECTIONS

SCALE

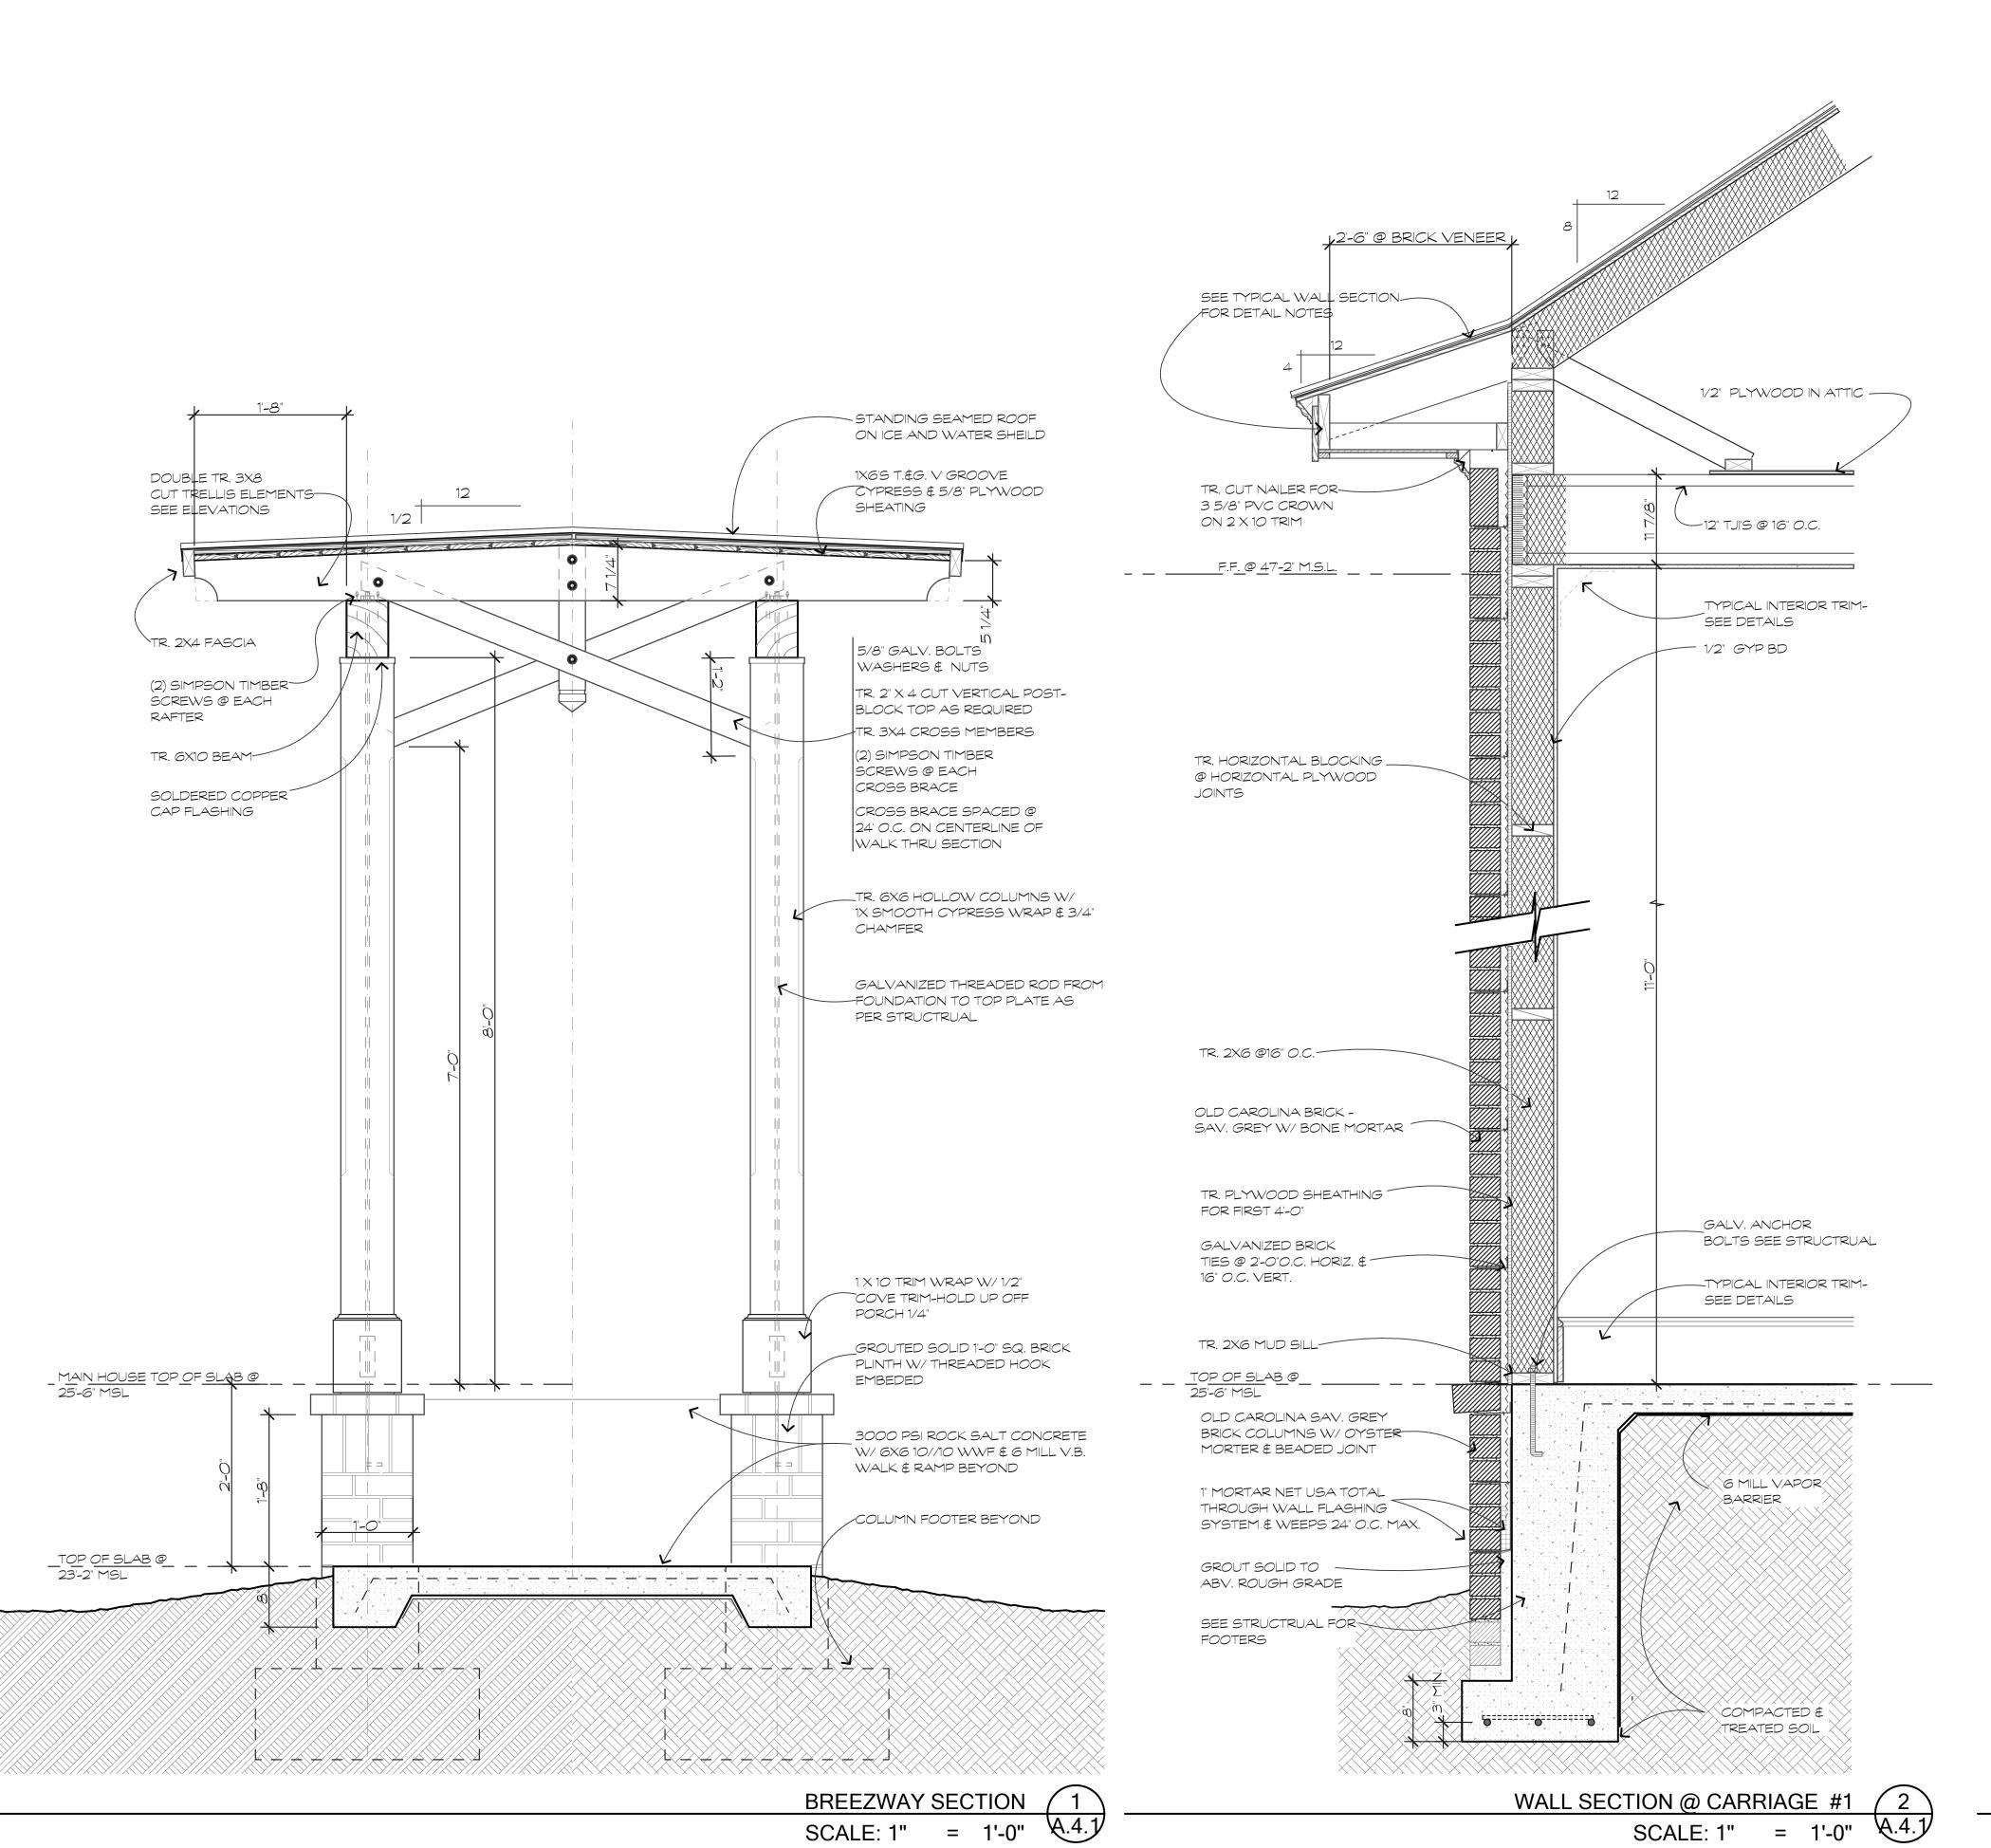

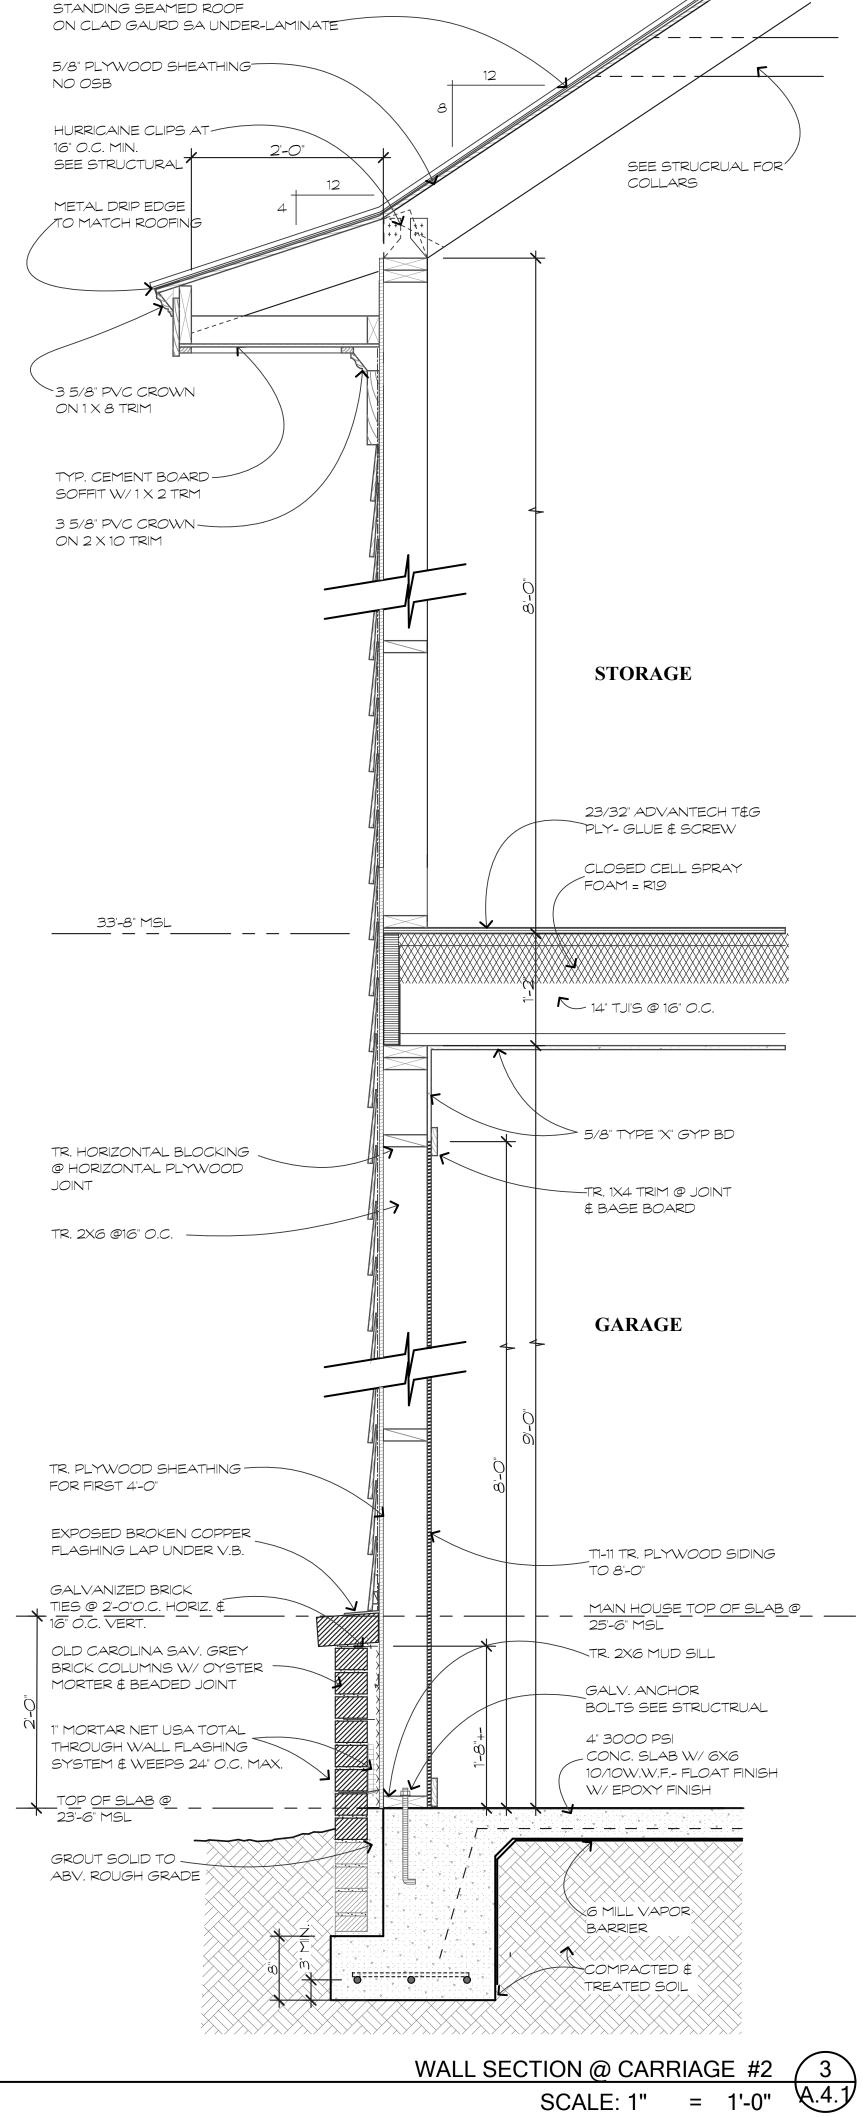

parker designgrouparchitects
843 785 5171 POST OFFICE BOX 5010 HILTON HEAD ISLAND SC 299

These documents & designs are the property of PDG|Architects & are not to be used or reproduced thereof or for designs, working drawings,or construction of buildings without the written authorization from the copy write owner PDG| Architects 2025 copyright

struction of buildings without the ten authorization from the copy te owner PDG| Architects 2025 syright

amily

The Dunaway F:

135 Bridge Street

Bluffton, S. C.

DRAWN BY

WTP

CHECKED BY

DATE

5/7/2025


SCALE


JOB NO. 2505

SHEET

WALL SECTIONS

A.4.1

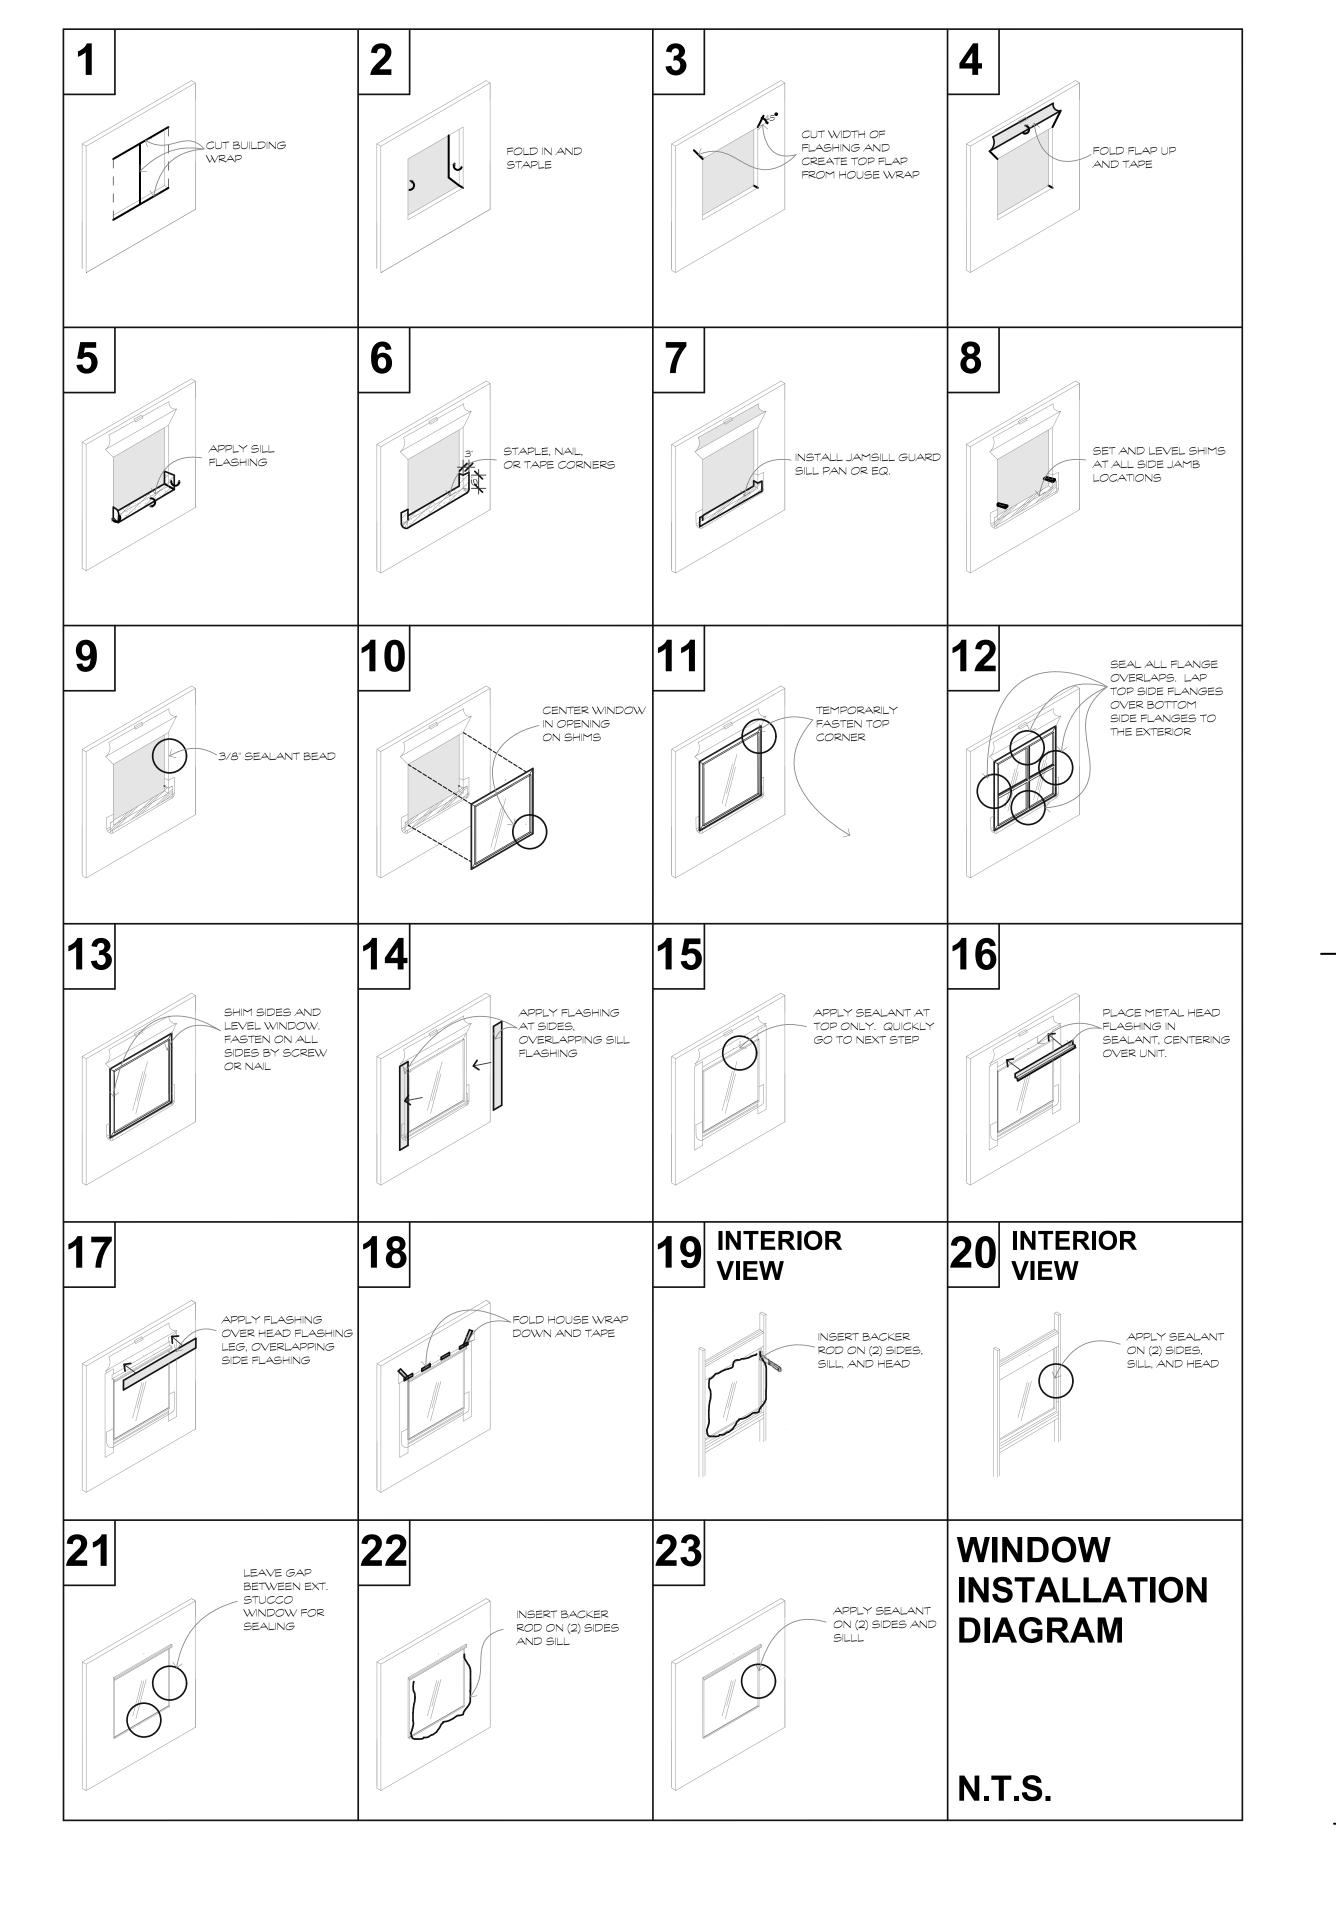

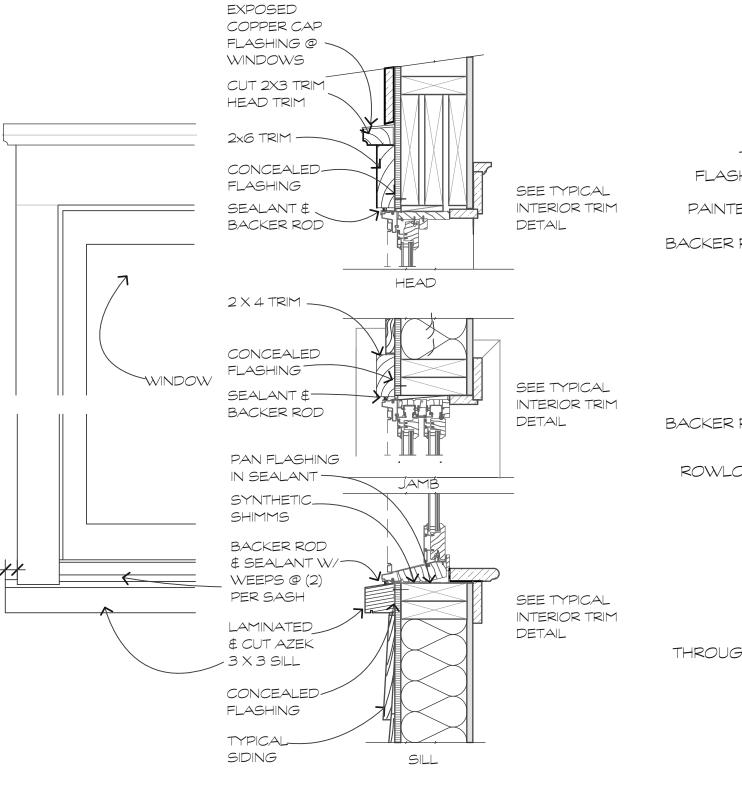

WINDOW IN SIDING

POWDERCOATED

TERMINATION

GROUT SET BRICK
PORCH FLOORING

ALUMINUM "IRON" LOOK 2

1/4" ART CAP HANDRAIL W/ LAMBS TOUNGE

SEE PORCH DETAILS FOR COLUMN BEYOND

SOLDIER BRICK TREADS & CUT BRICK RISERS

#4 REBAR PINS @ 24" OC 3000 P.S.I. CONCRETE W/

PROVIDE CONDUITE FOR

COMPACTED & TREATED

BRICK RISER LIGHTS

SEE STRUCTRUAL

SCALE: 1" = 1'-0" A.5.0

EXTERIOR BRICK STAIR & HANDRAIL


WWF 6X6 10/10


SCALE: 1 1/2"= 1'-0"

1ST FL @ 25'-6"MSL

7" 1'-0" 1'-0" 1'-0"

ATTACHMENT 6

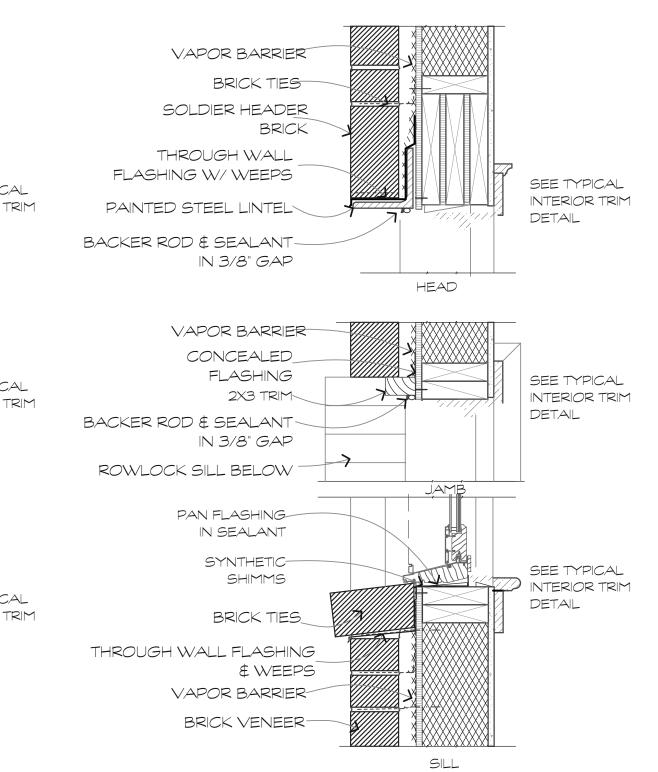

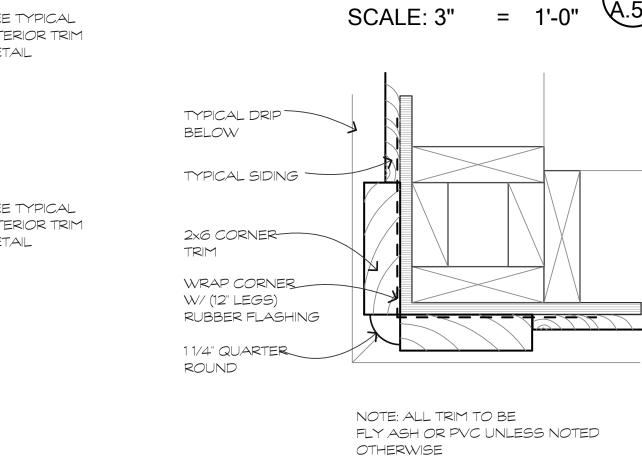

TYPICAL SIDING

TYPICAL DRIP

SIDING


BELOW


2x2 TRIM TO MATCH.

WRAP CORNER -


RUBBER FLASHING

W/ (12" LEGS)

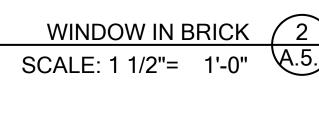

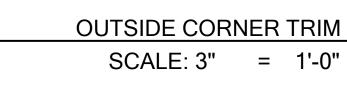

INSIDE CORNER TRIM

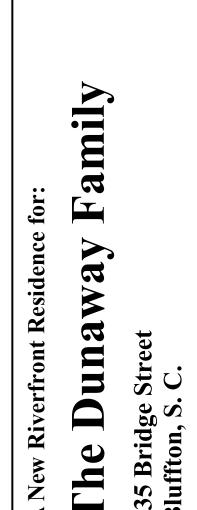

hese documents & designs are the

designs, working drawings,or construction of buildings without the

written authorization from the copy

write owner PDG| Architects 2025

property of PDG|Architects & are not to be used or reproduced thereof or for

| A New The | Blufft |
|-----------|--------|
| REVISIONS | DATE |
| | |
| | |
| | |
| | |
| | |
| | |
| | |
| | |
| DRAWN BY | |

| DRAWN BY | | |
|----------------------------|----|------|
| CHECKED BY | | |
| DATE OF ISSUE: 5/7/2025 | | |
| SCALE | | |
| JOB NO. 2505 | | |
| SHEET | | |
| FXTFRIOR | DF | ΓΔΙΙ |

A.5.U

be used or reproduced thereof or for designs, working drawings,or construction of buildings without the written authorization from the copy write owner PDG| Architects 2025

○FBO

T

mily

REVISIONS

FIRST FLOOR ELECTRICAL 1
SCALE: 3/16" = 1'-0" E.1.1

1ST FLOOR ELECTRICAL

LIGHTING FIXTURE SCHEDULE

| TYPE | MANUFACTURER | ID NUMBER | MOUNTING | LAMP | COLOR | REMARKS |
|----------------|--------------|---------------------------------|----------|-------------|-------|---|
| Д | DMF iX | X2NCR-IXD10930FLT- X2TRDSWH | RECESSED | 3000K/1000L | WHITE | 2" TYP. CAN - 40 DEG. |
| В | JUNO | UPLD | SURFACE | LED | WHITE | UNDERCABINET LIGHTING |
| С | HAFELE | LOO× 2028 | SURFACE | 2700K | BLACK | IN TOE KICK - TRANS, IN CABINET |
| D | HADC0 | CALRCL2 | RECESSED | 18 WATTS | GRAY | STEP LIGHT - HORIZONTAL |
| E | LITHONIA | FML4W 48 5000LM 840 ZT MVOLT | SURFACE | 4000K | WHITE | GARAGE OR ATTIC 1X4 LED - DAMP-RATED |
| F | PANASONIC | FV-0511VK2 | SURFACE | N/A | WHITE | EXHAUST FAN (110) |
| G | | | | | | |
| \vdash | | | | | | |
| | | | | | | |
| $ \leftarrow $ | | | | | | |
| L | | | | | | |
| M | | | | | | |

ELECTRICAL LEGEND

| SWITCH | \$ | 2X4 LED | \otimes |
|------------------------------------|---|---------------------|--------------|
| DIMMER SWITCH | \$ D | 1X4 LED | \otimes |
| JAMB SWITCH | \$ J | CLOSET HEADER STRIP | |
| THREE WAY SWITCH | \$ 3 | TRACK LIGHT | \otimes —— |
| DUPLEX | • | COVE LIGHT | ⊗ |
| QUADPLEX | \(\begin{array}{c} \\ \\ \\ \\ \\ \\ \\ \\ \\ \\ \\ \\ \\ | JUNCTION BOX | ○FBO |
| COUNTER HEIGHT | ¢ ⊕ | DISCONNECT | |
| G.F.I. DUPLEX | GFCI | THERMOSTAT | T |
| CLOCK OUTLET | \ominus | METER | |
| FLOOR DUPLEX | | CEILING FAN | |
| 220 DUPLEX | ⊕ 220 | TELEPHONE | |
| SWITCHED DUPLEX | ** | WALL TELEPHONE | ₩w |
| WATERPROOF DUPLEX | $\stackrel{WP}{igoplus}$ | TELEVISION CABLE | <u>-</u> |
| CAN LIGHT | - ♦ | PANEL | |
| ACCENT LIGHT | | EXHAUST FAN | |
| SLOPED CEILING CAN | -OSCA | EXHAUST FAN/ LIGHT | \boxtimes |
| WALL MOUNTED FIXTURE | \$- | PUSH BUTTON | -0 |
| SMOKE /CARBON MONOXIDE DETECTOR | 6 /C | CHIME | |
| UNDER CABINET | - | STEP LIGHT | |
| PILOT LIGHT FOR ATTIC | \$ P | USB/ POWER | 0 |


SCREENED SWINGING
BED PORCH BEDROOM #1

BEDROOM #6

BEDROOM #4

SECOND FLOOR ELECTRICAL PLAN 1
SCALE: 3/16" = 1'-0" E.1.2



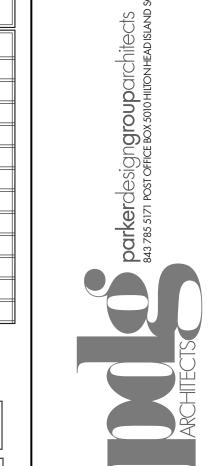

These documents & designs are the property of PDG|Architects & are not to be used or reproduced thereof or for designs, working drawings,or construction of buildings without the written authorization from the copy write owner PDG| Architects 2025




135 Bridge Street Bluffton, S. C.

| | ' | |
|---------|------|-------|
| VISIONS | DATE | |
| | | |
| | | |
| WN BY | | , |

| DRAWN BY | |
|----------------|--|
| WTP | |
| CHECKED BY | |
| DATE OF ISSUE: | |
| 5/7/2025 | |
| SCALE | |

ATTACHMENT 6

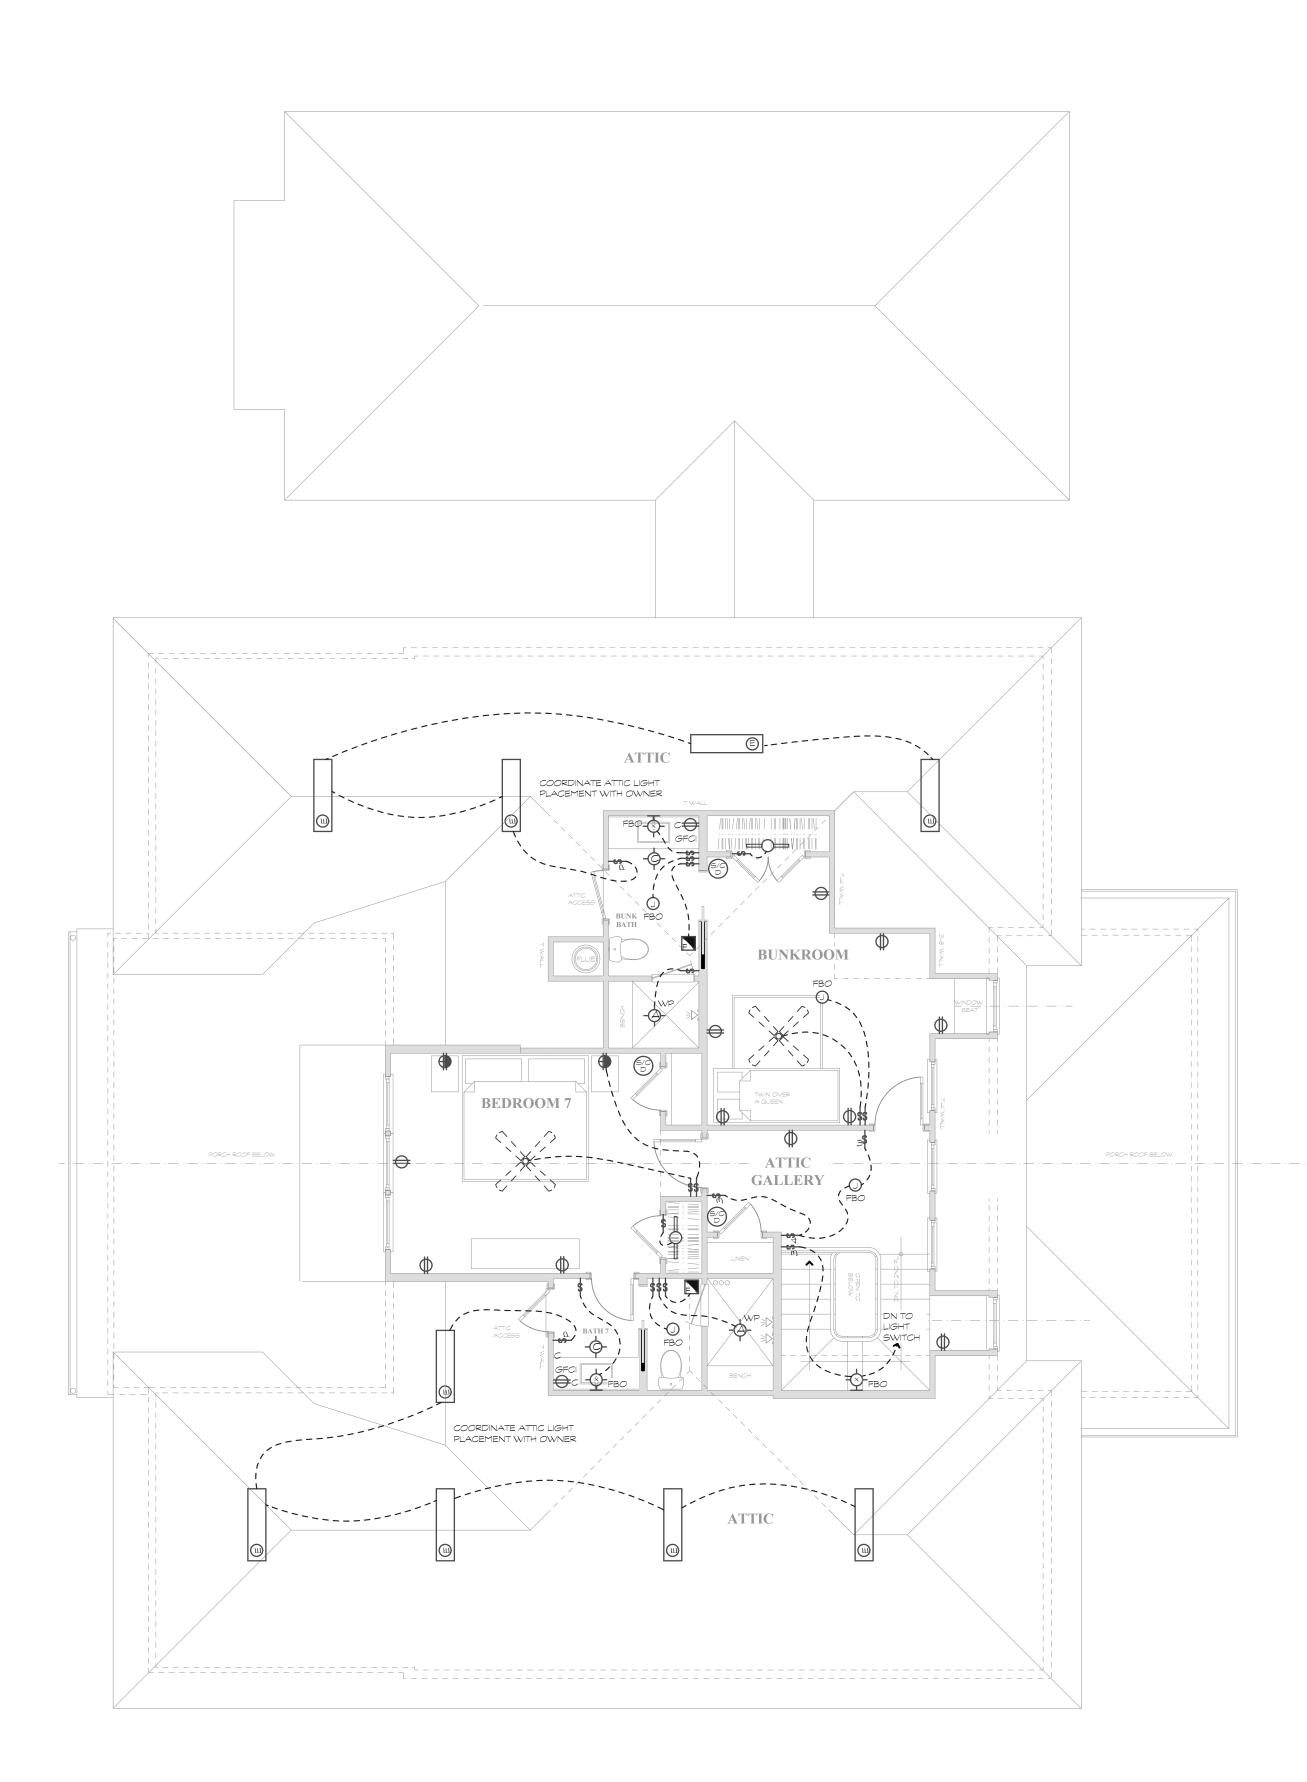


ATTIC FLOOR ELECTRICAL PLAN 1
SCALE: 3/16" = 1'-0" E.1.3

LIGHTING FIXTURE SCHEDULE

| TYPE | MANUFACTURER | ID NUMBER | MOUNTING | LAMP | COLOR | REMARKS |
|------|--------------|---------------------------------|----------|-------------|-------|---|
| Д | DMF iX | X2NCR-IXD10930FLT- X2TRDSWH | RECESSED | 3000K/1000L | WHITE | 2" TYP. CAN - 40 DEG. |
| В | JUNO | UPLD | SURFACE | LED | WHITE | UNDERCABINET LIGHTING |
| С | HAFELE | LOOX 2028 | SURFACE | 2700K | BLACK | IN TOE KICK - TRANS, IN CABINET |
| D | HADCO | CALRCL2 | RECESSED | 18 WATTS | GRAY | STEP LIGHT - HORIZONTAL |
| E | LITHONIA | FML4W 48 5000LM 840 ZT MVOLT | SURFACE | 4000K | WHITE | GARAGE OR ATTIC IX4 LED - DAMP-RATED |
| F | PANASONIC | FV-0511VK2 | SURFACE | N/A | WHITE | EXHAUST FAN (110) |
| G | | | | | | |
| H | | | | | | |
| | | | | | | |
| K | | | | | | |
| L | | | | | | |
| М | | | | | | |
| | | | | | | |

ELECTRICAL LEGEND

| SWITCH | \$ | 2X4 LED |
|------------------------------------|---------------------------------|---------------------|
| DIMMER SWITCH | \$ D | 1X4 LED |
| JAMB SWITCH | \$ J | CLOSET HEADER STRIP |
| THREE WAY SWITCH | \$ 3 | TRACK LIGHT |
| DUPLEX | \bigoplus_{i} | COVE LIGHT |
| QUADPLEX | \Pi | JUNCTION BOX (JFBO |
| COUNTER HEIGHT | $\stackrel{c}{\Leftrightarrow}$ | DISCONNECT |
| G.F.I. DUPLEX | GFCI O | THERMOSTAT |
| CLOCK OUTLET | \ominus | METER (, |
| FLOOR DUPLEX | | CEILING FAN |
| 220 DUPLEX | ⊕ 220 | TELEPHONE |
| SWITCHED DUPLEX | ** | WALL TELEPHONE W |
| WATERPROOF DUPLEX | ₩P → | TELEVISION CABLE |
| CAN LIGHT | -&- | PANEL |
| ACCENT LIGHT | | EXHAUST FAN |
| SLOPED CEILING CAN | -OSCA | EXHAUST FAN/ LIGHT |
| WALL MOUNTED FIXTURE | \$- | PUSH BUTTON - |
| SMOKE /CARBON MONOXIDE DETECTOR | (S/C) | CHIME |
| UNDER CABINET | - | STEP LIGHT |
| PILOT LIGHT FOR ATTIC | \$ P | USB/ POWER |

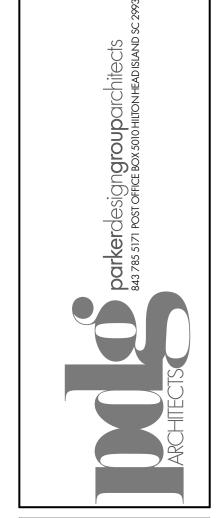

These documents & designs are the property of PDG|Architects & are not to be used or reproduced thereof or for designs, working drawings,or construction of buildings without the written authorization from the copy write owner PDG| Architects 2025 copyright





| AN T. 135 | Blu |
|-----------|------|
| REVISIONS | DATE |
| | |
| | |
| | |
| | |
| | |
| | |
| | |
| | |

DRAWN BY
WTP
CHECKED BY

DATE OF ISSUE:
5/7/2025

JOB NO. 2505

ATTIC LEVEL ELECTRICAL E.1.3