1	2	3	4	5	6	ATTACHMENT 3
					<u>.</u>	THE CANOPY OF EXISTING TREES IS REPRESENTED BY A CIRCLE, TYP.
		40 15	•		3	NEFRESENTED BY A CIRCLE, TYP.
	LA	0 14	FUTURE R/W	0.28 ACRE LAO 1		
0 18	Power-Box 15	8 5 P		18	LO 13 LO 27	
	18 CC	8	OFEN SPACE	S S S		LO 24
	PNO	*	13	Mulched Bark Path	80	AO
	RO 8 20 LAO 7 A	1AO 10 HIØ 14	AO 18	• LA	PEN SPACE	8b LO 17
		OPEN SPACE	3	LAO 18		
						7 LB 1 NS
2 8 XMAG			UNDERGROUND	TANKS	4 CF	
PN 12 LAO	9				66 IG	15 IG
ic 1						2 NS
2		CL TO CL	J FAC	CE TO FACE		
AO LAO 9 10 X LAO	18				4/	
CED 10 PN 13	3 RA	8 RA			4	
\$20 LAO	22	12 IC 1 TD	3 IG	E E	4 IG: 10	15 RK
_AO 20	EDGE		1 TD	1 CP	1 TD	
ro 18 LAO	22 1	12 10	3 RK	5 IG		12 RK Q
LAO 17 X LAO 1	3			2 RK ENTRANCE		SOMM
AO-12	1 4 IG	8 IV	\$ - \$ - \$	FF=39.00 PROPOSED		DE OF OFFICE OF THE PROPERTY O
→ PN 8 PN 8	1 CP 3 NS	CAR WASH	2 GS	4958 SQ LANDSCAPE OUTPARCE	FT	9 RK
RO 17		FF=39.00	19 IG "	TRELLIS PARCEL 1.56 ACR	6 E	1 CF
8	EDGE W			_15 IV	7 IV	14 IG /// /// /// ///
	10	1 CF				
A0 14	4RK W 00 W 1013/1V			10 mm		34 RK
	S S	S 8"SS S —	s — s — 8"SS s —			W 10"W W
s	g" SS				S (S)	

			PLANT SCHEDU	JLE			
KEY	QTY	BOTANICAL NAME	COMMON NAME	SIZE	SPACING	NOTES	
			TREES	1			
CC	CC 18 CERCIS CANADENSIS		EASTERN REDBUD	1.5" CAL.	PER PLAN	MINIMUM 12' HEIGHT	
СР	3	CRATAEGUS PHAENOPYRUM 'PRINCETON SENTRY'	WASHINGTON HAWTHORN	1.5" CAL.	PER PLAN	MINIMUM 12' HEIGHT	
NS	6	NYSSA SYLVATICA	BLACK GUM	6" CAL.	PER PLAN	MINIMUM 12' HEIGHT	
TD	4	TAXODIUM DISTICHUM	BALD CYPRESS	6" CAL.	PER PLAN	MINIMUM 12' HEIGHT	
			SHRUBS				
CF	7	CALYCANTHUS FLORIDUS	CAROLINA ALLSPICE	3' MIN. HT.	8' O.C.		
IC	24	ILEX CRENATA 'SKY PENCIL'	SKY PENCIL HOLLY	3' MIN. HT.	2' O.C.		
IG	99	ILEX GLABRA 'SHAMROCK'	INKBERRY	3' MIN. HT.	4' O.C.		
IV	47	ILEX VERTICILLATA 'BERRY POPPINS' & 'MR. POPPINS'	WINTERBERRY	3' MIN. HT.	4' O.C.	20% OF TOTAL TO BE MR. POPPINS FOR POLLINATION	
LB	10	LINDERA BENZOIN	SPICEBUSH	3' MIN. HT.	10' O.C.		
RA	11	ROSA X 'NOAMEL'	APPLEBLOSSOM FLOWERCARPET ROSE	30" MIN. HT.	3' O.C.		
RK	87	ROSA 'KNOCKOUT'	SHRUB ROSE	30" MIN. HT.	4' O.C.		
			VINES				
GS	2	GELSEMIUM SEMPERVIRENS	CAROLINA JESSAMINE	3 GAL.	5' O.C.		
			GROUNDCOVER				
	GF	ROUNDCOVER MIX					
//////	124	ERAGROSTIS SPECTABILIS	PURPLE LOVE GRASS	1 GAL.	30" O.C.	40% OF AREA	
	44	ACHILLEA MILLEFOLIUM	YARROW	1 GAL.	3' O.C.	20% OF AREA	
	44	COREOPSIS VERTICILLATA	THREADLEAF COREOPSIS	1 GAL.	3' O.C.	20% OF AREA	
	44	PENSTEMON 'DARK TOWERS'	PENSTEMON	1 GAL.	3' O.C.	20% OF AREA	
* * * * * * * * * * * * * * * * * * *	3,313 SF	SOD: TIFWAY 419 BERMUDA	LAWN	SOD			
V	9,337 SF	MULCH: SHREDDED HARDWOOD				3" DEPTH; ALL PLANTING BED EXCEPT LAWN	

LEGEND

METAL EDGE: SEE LANDSCAPE SPECIFICATIONS

F
F
SF.
SF
SF

LANDSCAPE REQUIREMENTS

- 1) BUFFER AT RIGHT-OF-WAY: THE EXISTING VEGETATION IS LEFT UNTOUCHED.
 LENGTH OF RIGHT-OF-WAY: 256 LF
 OVERSTORY TREES REQUIRED: 16 TREES (6 PER 100 LF)
 OVERSTORY TREES PROVIDED: 32 TREES (EXISTING TREES)
 UNDERSTORY TREES REQUIRED: 18 TREES (7 PER 100 LF)
- SHRUBS REQUIRED: 77 SHRUBS (30 PER LF)
 SHRUBS PROVIDED: 77 SHRUBS
 2) PARKING LOT SCREENING: SHRUBS HAVE BEEN PLANTED AROUND THE EDGES OF THE

PROPERTY TO SCREEN THE PARKING LOT FROM VIEW.

UNDERSTORY TREES PROVIDED: 18 TREES

- 3) PARKING LOT PLANTING: THE PARKING LOT ISLANDS HAVE BEEN PLANTED WITH SHRUBS
- AND 1 TREE PER ISLAND.

 4) FOUNDATION PLANTING: A MIX OF TREES, SHRUBS, VINES, AND GROUNDCOVER ARE
- SHOWN AROUND THE FOUNDATION OF THE BUILDING.

 TREE MITIGATION: TEN PROPOSED SHADE TREES ARE SHOWN ON THE PLAN. THEY ARE NOTED TO BE PLANTED AT 6" CALIPER TO MAXIMIZE MITIGATION. THIS IS THE MAXIMUM NUMBER OF SHADE TREES THAT CAN BE PLANTED DUE TO CONFLICTS WITH UTILITIES. ONE EXISTING TREE IS EXPECTED TO BE RETAINED WITHIN THE DEVELOPED AREA AND

CAN COUNT TOWARD MITIGATION. THE PLAN ALSO INCLUDES 21 SMALL TREES.


LANDSCAPE PLAN NOTES


- SOIL TYPE PER NRCS SOIL SURVEY: WANDO FINE SAND & SEABROOK FINE SAND
 THERE IS 1 EXISTING TREE ON SITE THAT WILL BE USED FOR LANDSCAPE REQUIREMENTS.
- 3) SINCE THE PROPOSED SHADE TREES ARE SIZED AT 6" CALIPER, THE PROPOSED TREES ACCOUNTS FOR 18 MITIGATION TREES; TOTAL OF 19 MITIGATION TREES INCLUDING THE EXISTING TREE TO BE RETAINED.
- 4) FOR THE GROUNDCOVER MIX, THE ENTIRE AREA IS TO BE PLANTED WITH THE CHASMANTHIUM, AND THE OTHER THREE SPECIES ARE TO BE RANDOMLY INTERMINGLED.

ROOT BARRIERS


THE CONTRACTOR SHALL INSTALL ROOT BARRIERS NEAR ALL NEWLY-PLANTED TREES THAT ARE LOCATED WITHIN FIVE (5) FEET OF PAVING OR CURBS. ROOT BARRIERS SHALL BE "CENTURY" OR "DEEP-ROOT" 24" DEEP PANELS (OR EQUAL). BARRIERS SHALL BE LOCATED IMMEDIATELY ADJACENT TO HARDSCAPE. INSTALL PANELS PER MANUFACTURER'S RECOMMENDATIONS. UNDER NO CIRCUMSTANCES SHALL THE CONTRACTOR USE ROOT BARRIERS OF A TYPE THAT COMPLETELY ENCIRCLE THE ROOTBALL.



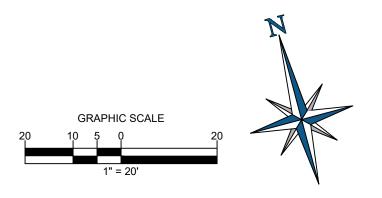

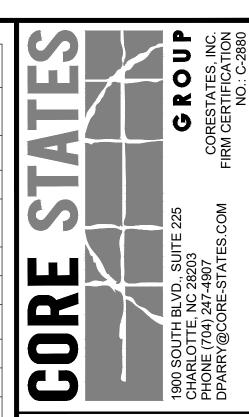

DOCUMENTS PREPARED BY CORESTATES, INC., INCLUDING THIS DOCUMENT, ARE TO BE USED ONLY FOR THE SPECIFIC PROJECT AND SPECIFIC USE FOR WHICH THEY WERE INTENDED. ANY EXTENSION OF USE TO ANY OTHER PROJECTS, BY OWNER OR BY ANY OTHER PARTY, WITHOUT THE EXPRESSED WRITTEN CONSENT OF CORESTATES, INC. IS DONE UNLAWFULLY AND AT THE USERS OWN RISK. IF USED IN A WAY OTHER THAN THAT SPECIFICALLY INTENDED, USER WILL HOLD CORESTATES, INC. HARMLESS FROM ALL CLAIMS AND LOSSES.

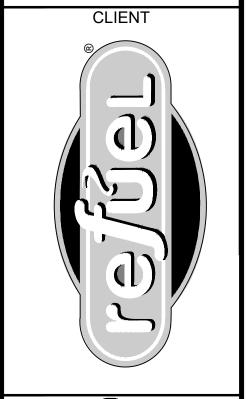

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Call before you dig.

THE CONTRACTOR IS SPECIFICALLY CAUTIONED THAT THE LOCATION ANDIOR ELEVATION OF EXISTING UTILITIES AS SHOWN ON THESE PLANS IS BASED ON DESIGN DRAWINGS, RECORDS OF THE VARIOUS UTILITY COMPANIES, AND WHERE POSSIBLE. MEASUREMENTS TAKEN IN THE FIELD. CORESTATES, INC. DOES NOT GUARANTEE THAT LOCATIONS SHOWN ARE EXACT. THE CONTRACTOR MUST CONTACT THE APPROPRIATE UTILITY COMPANIES AT LEAST 72 HOURS BEFORE ANY EXCAVATION TO REQUEST EXACT FIELD LOCATIONS OF UTILITIES.

PALMETTO UTILITY PROTECTION SERVICE SOUTH CAROLINA PUPS

REVISIONS


REV DATE COMMENT BY

DOCUMENT
PRELIMINARY
DEVELOPMENT PLAN

SITE LOCATION

NEW RIVERSIDE VILLAGE, BLUFFTON, SC 29910

CERTIFICATE OF AUTHORIZATION

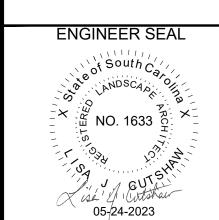

SHEET TITLE
PRELIMINARY
LANDSCAPING PLAN

JOB #:		RFL.35149
DATE:		12/13/2022
SCALE:		AS SHOWN
DRAWN BY:		КВ
CHECKED BY:		BS
	SHEET NO	

SHEET NO.

- A. QUALIFICATIONS OF LANDSCAPE CONTRACTOR ALL LANDSCAPE WORK SHOWN ON THESE PLANS SHALL BE PERFORMED BY A SINGLE FIRM
- SPECIALIZING IN LANDSCAPE PLANTING. A LIST OF SUCCESSFULLY COMPLETED PROJECTS OF THIS TYPE, SIZE AND NATURE MAY BE REQUESTED BY THE OWNER FOR FURTHER QUALIFICATION MEASURES. THE LANDSCAPE CONTRACTOR SHALL HOLD A VALID CONTRACTOR'S LICENSE ISSUED BY THE
- APPROPRIATE LOCAL JURISDICTION. B. SCOPE OF WORK WORK COVERED BY THESE SECTIONS INCLUDES THE FURNISHING AND PAYMENT OF ALL MATERIALS. LABOR SERVICES FOLIPMENT LICENSES TAXES AND ANY OTHER ITEMS THAT ARE NECESSARY FOR
- THE EXECUTION, INSTALLATION AND COMPLETION OF ALL WORK, SPECIFIED HEREIN AND / OR SHOWN ON THE LANDSCAPE PLANS, NOTES, AND DETAILS. ALL WORK SHALL BE PERFORMED IN ACCORDANCE WITH ALL APPLICABLE LAWS. CODES AND REGULATIONS REQUIRED BY AUTHORITIES HAVING JURISDICTION OVER SUCH WORK, INCLUDING ALL INSPECTIONS AND PERMITS REQUIRED BY FEDERAL, STATE AND LOCAL AUTHORITIES IN SUPPLY, TRANSPORTATION AND INSTALLATION OF MATERIALS.
- THE LANDSCAPE CONTRACTOR SHALL VERIFY THE LOCATION OF ALL UNDERGROUND UTILITY LINES (WATER, SEWER, ELECTRICAL, TELEPHONE, GAS, CABLE, TELEVISION, ETC.) PRIOR TO THE START OF ANY WORK.

- ALL MANUFACTURED PRODUCTS SHALL BE NEW. CONTAINER AND BALLED-AND-BURLAPPED PLANTS:
- FURNISH NURSERY-GROWN PLANTS COMPLYING WITH ANSI Z60.1-2014. PROVIDE WELL-SHAPED, FULLY BRANCHED, HEALTHY, VIGOROUS STOCK FREE OF DISEASE, INSECTS, EGGS, LARVAE, AND DEFECTS SUCH AS KNOTS, SUN SCALD, INJURIES, ABRASIONS, AND DISFIGUREMENT. ALL PLANTS WITHIN A SPECIES SHALL HAVE SIMILAR SIZE, AND SHALL BE OF A FORM TYPICAL FOR THE SPECIES. ALL TREES SHALL BE OBTAINED FROM SOURCES WITHIN 200 MILES OF THE PROJECT SITE, AND WITH SIMILAR CLIMACTIC CONDITIONS
- ROOT SYSTEMS SHALL BE HEALTHY, DENSELY BRANCHED ROOT SYSTEMS, NON-POT-BOUND, FREE FROM ENCIRCLING AND/OR GIRDLING ROOTS, AND FREE FROM ANY OTHER ROOT DEFECTS (SUCH AS
- TREES MAY BE PLANTED FROM CONTAINERS OR BALLED-AND-BURLAPPED (B&B), UNLESS SPECIFIED
- ON THE PLANTING LEGEND. BARE-ROOT TREES ARE NOT ACCEPTABLE. ANY PLANT DEEMED UNACCEPTABLE BY THE LANDSCAPE ARCHITECT OR OWNER SHALL BE IMMEDIATELY REMOVED FROM THE SITE AND SHALL BE REPLACED WITH AN ACCEPTABLE PLANT OF LIKE TYPE AND SIZE AT THE CONTRACTOR'S OWN EXPENSE. ANY PLANTS APPEARING TO BE UNHEALTHY, EVEN IF DETERMINED TO STILL BE ALIVE. SHALL NOT BE ACCEPTED. THE LANDSCAPE ARCHITECT AND OWNER SHALL BE THE SOLE JUDGES AS TO THE ACCEPTABILITY OF PLANT MATERIAL
- ALL TREES SHALL BE STANDARD IN FORM, UNLESS OTHERWISE SPECIFIED. TREES WITH CENTRAL LEADERS WILL NOT BE ACCEPTED IF LEADER IS DAMAGED OR REMOVED. PRUNE ALL DAMAGED TWIGS AFTER PLANTING.
- CALIPER MEASUREMENTS FOR STANDARD (SINGLE TRUNK) TREES SHALL BE AS FOLLOWS: SIX INCHES ABOVE THE ROOT FLARE FOR TREES UP TO AND INCLUDING FOUR INCHES IN CALIPER, AND TWELVE INCHES ABOVE THE ROOT ELARE FOR TREES EXCEEDING FOUR INCHES IN CALIPER
- MULTI-TRUNK TREES SHALL BE MEASURED BY THEIR OVERALL HEIGHT, MEASURED FROM THE TOP OF THE ROOT BALL. WHERE CALIPER MEASUREMENTS ARE USED, THE CALIPER SHALL BE CALCULATED AS ONE-HALF OF THE SUM OF THE CALIPER OF THE THREE LARGEST TRUNKS. ANY TREE OR SHRUB SHOWN TO HAVE EXCESS SOIL PLACED ON TOP OF THE ROOT BALL, SO THAT
- THE ROOT FLARE HAS BEEN COMPLETELY COVERED. SHALL BE REJECTED. SOD: PROVIDE WELL-ROOTED SOD OF THE VARIETY NOTED ON THE PLANS. SOD SHALL BE CUT FROM
- HEALTHY, MATURE TURF WITH SOIL THICKNESS OF 3/4" TO 1". EACH PALLET OF SOD SHALL BE ACCOMPANIED BY A CERTIFICATE FROM SUPPLIER STATING THE COMPOSITION OF THE SOD. TOPSOIL: SANDY TO CLAY LOAM TOPSOIL, FREE OF STONES LARGER THAN 1/2 INCH, FOREIGN MATTER,
- PLANTS, ROOTS, AND SEEDS. COMPOST: WELL-COMPOSTED, STABLE, AND WEED-FREE ORGANIC MATTER, pH RANGE OF 5.5 TO 8; MOISTURE CONTENT 35 TO 55 PERCENT BY WEIGHT; 100 PERCENT PASSING THROUGH 3/4-INCH SIEVE; SOLUBLE SALT CONTENT OF 5 TO 10 DECISIEMENS/M; NOT EXCEEDING 0.5 PERCENT INERT CONTAMINANTS AND FREE OF SUBSTANCES TOXIC TO PLANTINGS. NO MANURE OR ANIMAL-BASED PRODUCTS SHALL BE
- FERTILIZER: GRANULAR FERTILIZER CONSISTING OF NITROGEN, PHOSPHORUS, POTASSIUM, AND OTHER NUTRIENTS IN PROPORTIONS, AMOUNTS, AND RELEASE RATES RECOMMENDED IN A SOIL REPORT FROM A QUALIFIED SOIL-TESTING AGENCY (SEE BELOW).
- MULCH: SIZE AND TYPE AS INDICATED ON PLANS, FREE FROM DELETERIOUS MATERIALS AND SUITABLE AS A TOP DRESSING OF TREES AND SHRUBS. TREE STAKING AND GUYING
- STAKES: 6' LONG GREEN METAL T-POSTS.
- GUY AND TIE WIRE: ASTM A 641, CLASS 1, GALVANIZED-STEEL WIRE, 2-STRAND, TWISTED, 0.106 INCH STRAP CHAFING GUARD: REINFORCED NYLON OR CANVAS AT LEAST 1-1/2 INCH WIDE, WITH
- GROMMETS TO PROTECT TREE TRUNKS FROM DAMAGE. STEEL EDGING: PROFESSIONAL STEEL EDGING, 14 GAUGE THICK X 4 INCHES WIDE, FACTORY PAINTED DARK
- GREEN. ACCEPTABLE MANUFACTURERS INCLUDE COL-MET OR APPROVED EQUAL. PRE-EMERGENT HERBICIDES: ANY GRANULAR, NON-STAINING PRE-EMERGENT HERBICIDE THAT IS LABELED FOR THE SPECIFIC ORNAMENTALS OR TURF ON WHICH IT WILL BE UTILIZED. PRE-EMERGENT HERBICIDES SHALL BE APPLIED PER THE MANUFACTURER'S LABELED RATES.

METHODS

A. SOIL PREPARATION

- VORK THE LANDSCAPE CONTRACTOR SHALL VERIEV THAT THE GRADE OF ALL LANDSCAPE AREAS ARE WITHIN +/-0.1' OF FINISH GRADE. THE CONTRACTOR SHALL NOTIFY THE OWNER IMMEDIATELY SHOULD ANY DISCREPANCIES EXIST. SOIL TESTING:
- a. AFTER FINISH GRADES HAVE BEEN ESTABLISHED, CONTRACTOR SHALL HAVE SOIL SAMPLES FROM THE PROJECT'S LANDSCAPE AREAS TESTED BY AN ESTABLISHED SOIL TESTING LABORATORY. EACH SAMPLE SUBMITTED TO THE LAB SHALL CONTAIN NO LESS THAN ONE QUART OF SOIL, TAKEN FROM BETWEEN THE SOIL SURFACE AND 6" DEPTH. IF NO SAMPLE LOCATIONS ARE INDICATED ON THE PLANS, THE CONTRACTOR SHALL TAKE A MINIMUM OF THREE
- SAMPLES FROM VARIOUS REPRESENTATIVE LOCATIONS FOR TESTING THE CONTRACTOR SHALL HAVE THE SOIL TESTING LABORATORY PROVIDE RESULTS FOR THE FOLLOWING: SOIL TEXTURAL CLASS, GENERAL SOIL FERTILITY, pH, ORGANIC MATTER CONTENT,
- SALT (CEC), LIME, SODIUM ADSORPTION RATIO (SAR) AND BORON CONTENT. THE CONTRACTOR SHALL ALSO SUBMIT THE PROJECT'S PLANT LIST TO THE LABORATORY ALONG THE SOIL REPORT PRODUCED BY THE LABORATORY SHALL CONTAIN RECOMMENDATIONS FOR
- THE FOLLOWING (AS APPROPRIATE): SEPARATE SOIL PREPARATION AND BACKFILL MIX RECOMMENDATIONS FOR GENERAL ORNAMENTAL PLANTS, XERIC PLANTS, TURF, AND NATIVE SEED, AS WELL AS PRE-PLANT FERTILIZER APPLICATIONS AND RECOMMENDATIONS FOR ANY OTHER SOIL RELATED ISSUES. THE REPORT SHALL ALSO PROVIDE A FERTILIZER PROGRAM FOR THE ESTABLISHMENT PERIOD AND FOR LONG-TERM MAINTENANCE. THE CONTRACTOR SHALL INSTALL SOIL AMENDMENTS AND FERTILIZERS PER THE SOILS REPORT
- RECOMMENDATIONS. ANY CHANGE IN COST DUE TO THE SOIL REPORT RECOMMENDATIONS, EITHER INCREASE OR DECREASE, SHALL BE SUBMITTED TO THE OWNER WITH THE REPORT.
- FOR BIDDING PURPOSES ONLY, THE SOIL PREPARATION SHALL CONSIST OF THE FOLLOWING: TURF: INCORPORATE THE FOLLOWING AMENDMENTS INTO THE TOP 8" OF SOIL BY MEANS OF ROTOTILLING AFTER CROSS-RIPPING:
- NITROGEN STABILIZED ORGANIC AMENDMENT 4 CU. YDS. PER 1,000 S.F.
- PREPLANT TURF FERTILIZER (10-20-10 OR SIMILAR, SLOW RELEASE, ORGANIC) 15 LBS PER 1,000 "CLAY BUSTER" OR EQUAL - USE MANUFACTURER'S RECOMMENDED RATE
- TREES, SHRUBS, AND PERENNIALS: INCORPORATE THE FOLLOWING AMENDMENTS INTO THE TOP 8" OF SOIL BY MEANS OF ROTOTILLING AFTER CROSS-RIPPING. NITROGEN STABILIZED ORGANIC AMENDMENT - 4 CU. YDS. PER 1.000 S.F.
- 12-12-12 FERTILIZER (OR SIMILAR, ORGANIC, SLOW RELEASE) 10 LBS, PER CU, YD. "CLAY BUSTER" OR EQUAL - USE MANUFACTURER'S RECOMMENDED RATE
- IRON SULPHATE 2 LBS. PER CU. YD. IN THE CONTEXT OF THESE PLANS, NOTES, AND SPECIFICATIONS, "FINISH GRADE" REFERS TO THE FINAL ELEVATION OF THE SOIL SURFACE (NOT TOP OF MULCH) AS INDICATED ON THE GRADING PLANS. a. BEFORE STARTING WORK, THE LANDSCAPE CONTRACTOR SHALL VERIFY THAT THE ROUGH
- GRADES OF ALL LANDSCAPE AREAS ARE WITHIN +/-0.1' OF FINISH GRADE. SEE SPECIFICATIONS FOR MORE DETAILED INSTRUCTION ON TURF AREA AND PLANTING BED PREPARATION. CONSTRUCT AND MAINTAIN FINISH GRADES AS SHOWN ON GRADING PLANS, AND CONSTRUCT AND MAINTAIN SLOPES AS RECOMMENDED BY THE GEOTECHNICAL REPORT. ALL LANDSCAPE AREAS SHALL HAVE POSITIVE DRAINAGE AWAY FROM STRUCTURES AT THE MINIMUM SLOPE SPECIFIED IN THE REPORT AND ON THE GRADING PLANS, AND AREAS OF POTENTIAL PONDING
- SHALL BE REGRADED TO BLEND IN WITH THE SURROUNDING GRADES AND ELIMINATE PONDING c. THE LANDSCAPE CONTRACTOR SHALL DETERMINE WHETHER OR NOT THE EXPORT OF ANY SOIL WILL BE NEEDED, TAKING INTO ACCOUNT THE ROUGH GRADE PROVIDED, THE AMOUNT OF SOIL AMENDMENTS TO BE ADDED (BASED ON A SOIL TEST, PER SPECIFICATIONS), AND THE FINISH
- GRADES TO BE ESTABLISHED. d. ENSURE THAT THE FINISH GRADE IN SHRUB AREAS IMMEDIATELY ADJACENT TO WALKS AND OTHER WALKING SURFACES, AFTER INSTALLING SOIL AMENDMENTS, IS 3" BELOW THE ADJACENT FINISH SURFACE, IN ORDER TO ALLOW FOR PROPER MULCH DEPTH. TAPER THE SOIL SURFACE TO MEET FINISH GRADE, AS SPECIFIED ON THE GRADING PLANS, AT APPROXIMATELY 18" AWAY FROM THE WALKS.
- e. ENSURE THAT THE FINISH GRADE IN TURF AREAS IMMEDIATELY ADJACENT TO WALKS AND OTHER WALKING SURFACES, AFTER INSTALLING SOIL AMENDMENTS. IS 1" BELOW THE FINISH SURFACE OF THE WALKS. TAPER THE SOIL SURFACE TO MEET FINISH GRADE, AS SPECIFIED ON THE GRADING PLANS. AT APPROXIMATELY 18" AWAY FROM THE WALKS. SHOULD ANY CONFLICTS AND/OR DISCREPANCIES ARISE BETWEEN THE GRADING PLANS.
- GEOTECHNICAL REPORT THESE NOTES AND PLANS, AND ACTUAL CONDITIONS, THE CONTRACTOR SHALL IMMEDIATELY BRING SUCH ITEMS TO THE ATTENTION OF THE LANDSCAPE ARCHITECT GENERAL CONTRACTOR AND OWNER
- ONCE SOIL PREPARATION IS COMPLETE, THE LANDSCAPE CONTRACTOR SHALL ENSURE THAT THERE ARE NO DEBRIS, TRASH, OR STONES LARGER THAN 1" REMAINING IN THE TOP 6" OF SOIL

- THE CONTRACTOR SHALL PROVIDE SUBMITTALS AND SAMPLES, IF REQUIRED, TO THE LANDSCAPE ARCHITECT, AND RECEIVE APPROVAL IN WRITING FOR SUCH SUBMITTALS BEFORE WORK COMMENCES. SUBMITTALS SHALL INCLUDE PHOTOS OF PLANTS WITH A RULER OR MEASURING STICK FOR SCALE, PHOTOS OR SAMPLES OF ANY REQUIRED MULCHES, AND SOIL TEST RESULTS AND PREPARATION
- SUBMITTALS SHALL ALSO INCLUDE MANUFACTURER CUT SHEETS FOR PLANTING ACCESSORIES SUCH AS TREE STAKES AND TIES EDGING AND LANDSCAPE FARRICS (IF ANY) WHERE MULTIPLE ITEMS ARE SHOWN ON A PAGE, THE CONTRACTOR SHALL CLEARLY INDICATE THE

TYPES, AND OTHER AMENDMENTS FOR TREE/SHRUB, TURF, AND SEED AREAS AS MAY BE

RECOMMENDATIONS FROM THE TESTING LAB (INCLUDING COMPOST AND FERTILIZER RATES AND


- ITEM BEING CONSIDERED GENERAL PLANTING REMOVE ALL NURSERY TAGS AND STAKES FROM PLANTS.
- EXCEPT IN AREAS TO BE PLANTED WITH ORNAMENTAL GRASSES, APPLY PRE-EMERGENT HERBICIDES AT THE MANUFACTURER'S RECOMMENDED RATE TRENCHING NEAR EXISTING TREES:
 - a. CONTRACTOR SHALL NOT DISTURB ROOTS 1-1/2" AND LARGER IN DIAMETER WITHIN THE CRITICAL ROOT ZONE (CRZ) OF EXISTING TREES, AND SHALL EXERCISE ALL POSSIBLE CARE AND PRECAUTIONS TO AVOID INJURY TO TREE ROOTS, TRUNKS, AND BRANCHES. THE CRZ IS DEFINED AS A CIRCULAR AREA EXTENDING OUTWARD FROM THE TREE TRUNK. WITH A RADIUS EQUAL TO 1' FOR EVERY 1" OF TRUNK DIAMETER-AT-BREAST-HEIGHT (4.5' ABOVE THE AVERAGE
 - GRADE AT THE TRUNK). b. ALL EXCAVATION WITHIN THE CRZ SHALL BE PERFORMED USING HAND TOOLS. NO MACHINE EXCAVATION OR TRENCHING OF ANY KIND SHALL BE ALLOWED WITHIN THE CRZ.
 - ALTER ALIGNMENT OF PIPE TO AVOID TREE ROOTS 1-1/2" AND LARGER IN DIAMETER. WHERE TREE ROOTS 1-1/2" AND LARGER IN DIAMETER ARE ENCOUNTERED IN THE FIELD, TUNNEL UNDER SUCH ROOTS. WRAP EXPOSED ROOTS WITH SEVERAL LAYERS OF BURLAP AND KEEP MOIST.
 - CLOSE ALL TRENCHES WITHIN THE CANOPY DRIP LINES WITHIN 24 HOURS. d. ALL SEVERED ROOTS SHALL BE HAND PRUNED WITH SHARP TOOLS AND ALLOWED TO AIR-DRY DO NOT USE ANY SORT OF SEALERS OR WOUND PAINTS.
- TREE PLANTING HOLES SHALL BE EXCAVATED TO MINIMUM WIDTH OF TWO TIMES THE WIDTH OF THE ROOTBALL, AND TO A DEPTH EQUAL TO THE DEPTH OF THE ROOTBALL LESS TWO TO FOUR INCHES. SCARIFY THE SIDES AND BOTTOM OF THE PLANTING HOLE PRIOR TO THE PLACEMENT OF THE TREE.
- REMOVE ANY GLAZING THAT MAY HAVE BEEN CAUSED DURING THE EXCAVATION OF THE HOLE. FOR CONTAINER AND BOX TREES, TO REMOVE ANY POTENTIALLY GIRDLING ROOTS AND OTHER ROOT DEFECTS, THE CONTRACTOR SHALL SHAVE A 1" LAYER OFF OF THE SIDES AND BOTTOM OF THE ROOTBALL OF ALL TREES JUST BEFORE PLACING INTO THE PLANTING PIT. DO NOT "TEASE" ROOTS OUT FROM THE ROOTBALL.
- INSTALL THE TREE ON UNDISTURBED SUBGRADE SO THAT THE TOP OF THE ROOTBALL IS TWO TO FOUR INCHES ABOVE THE SURROUNDING GRADE. BACKFILL THE TREE HOLE UTILIZING THE EXISTING TOPSOIL FROM ON-SITE. ROCKS LARGER THAN 1 DIA. AND ALL OTHER DEBRIS SHALL BE REMOVED FROM THE SOIL PRIOR TO THE BACKFILL. SHOULD ADDITIONAL SOIL BE REQUIRED TO ACCOMPLISH THIS TASK. USE STORED TOPSOIL FROM ON-SITE OR
- TOPSOIL SHALL BE OF SIMILAR TEXTURAL CLASS AND COMPOSITION IN THE ON-SITE SOIL. TREES SHALL NOT BE STAKED UNLESS LOCAL CONDITIONS (SUCH AS HEAVY WINDS OR SLOPES). REQUIRE STAKES TO KEEP TREES UPRIGHT. SHOULD STAKING BE REQUIRED, THE TOTAL NUMBER OF TREE STAKES (BEYOND THE MINIMUMS LISTED BELOW) WILL BE LEFT TO THE LANDSCAPE CONTRACTOR'S DISCRETION. SHOULD ANY TREES FALL OR LEAN, THE LANDSCAPE CONTRACTOR SHALL STRAIGHTEN THE TREE, OR REPLACE IT SHOULD IT BECOME DAMAGED. TREE STAKING SHALL ADHERE TO THE FOLLOWING GUIDELINES:

IMPORT ADDITIONAL TOPSOIL FROM OFF-SITE AT NO ADDITIONAL COST TO THE OWNER. IMPORTED

- . 1"-2" TREES TWO STAKES PER TREE 2-1/2"-4" TREES THREE STAKES PER TREE TREES OVER 4" CALIPER GUY AS NEEDED
- MULTI-TRUNK TREES THREE STAKES PER TREE MINIMUM, QUANTITY AND POSITIONS AS NEEDED TO STABILIZE THE TREE
- UPON COMPLETION OF PLANTING, CONSTRUCT AN EARTH WATERING BASIN AROUND THE TREE. COVER THE INTERIOR OF THE TREE RING WITH MULCH (TYPE AND DEPTH PER PLANS). D. SHRUB, PERENNIAL, AND GROUNDCOVER PLANTING
- DIG THE PLANTING HOLES TWICE AS WIDE AND 2" LESS DEEP THAN EACH PLANT'S ROOTBALL. INSTALL THE PLANT IN THE HOLE. BACKFILL AROUND THE PLANT WITH SOIL AMENDED PER SOIL TEST
- WHEN PLANTING IS COMPLETE, INSTALL MULCH (TYPE AND DEPTH PER PLANS) OVER ALL PLANTING BEDS, COVERING THE ENTIRE PLANTING AREA.
- SOD VARIETY TO BE AS SPECIFIED ON THE LANDSCAPE PLAN. LAY SOD WITHIN 24 HOURS FROM THE TIME OF STRIPPING. DO NOT LAY IF THE GROUND IS FROZEN. LAY THE SOD TO FORM A SOLID MASS WITH TIGHTLY FITTED JOINTS. BUTT ENDS AND SIDES OF SOD
- STRIPS DO NOT OVERLAP. STAGGER STRIPS TO OFFSET JOINTS IN ADJACENT COURSES. ROLL THE SOD TO ENSURE GOOD CONTACT OF THE SOD'S ROOT SYSTEM WITH THE SOIL UNDERNEATH.
- WATER THE SOD THOROUGHLY WITH A FINE SPRAY IMMEDIATELY AFTER PLANTING TO OBTAIN AT LEAST SIX INCHES OF PENETRATION INTO THE SOIL BELOW THE SOD.
- 1. INSTALL MULCH TOPDRESSING, TYPE AND DEPTH PER MULCH NOTE, IN ALL PLANTING AREAS AND
- DO NOT INSTALL MULCH WITHIN 6" OF TREE ROOT FLARE AND WITHIN 24" OF HABITABLE STRUCTURES, EXCEPT AS MAY BE NOTED ON THESE PLANS. MULCH COVER WITHIN 6" OF CONCRETE WALKS AND CURBS SHALL NOT PROTRUDE ABOVE THE FINISH SURFACE OF THE WALKS AND CURBS. MULCH COVER WITHIN 12" OF WALLS SHALL BE AT LEAST 3" LOWER THAN THE TOP OF WALL
- DURING LANDSCAPE PREPARATION AND PLANTING, KEEP ALL PAVEMENT CLEAN AND ALL WORK AREAS IN A NEAT, ORDERLY CONDITION.
- TERIALS OFF THE PROJECT SITE. H. INSPECTION AND ACCEPTANCE UPON COMPLETION OF THE WORK, THE LANDSCAPE CONTRACTOR SHALL PROVIDE THE SITE CLEAN, FREE OF DEBRIS AND TRASH, AND SUITABLE FOR USE AS INTENDED. THE LANDSCAPE CONTRACTOR SHALL THEN REQUEST AN INSPECTION BY THE OWNER TO DETERMINE FINAL ACCEPTABILITY. WHEN THE INSPECTED PLANTING WORK DOES NOT COMPLY WITH THE CONTRACT DOCUMENTS, THE
- LANDSCAPE CONTRACTOR SHALL REPLACE AND/OR REPAIR THE REJECTED WORK TO THE OWNER'S SATISFACTION WITHIN 24 HOURS. THE LANDSCAPE MAINTENANCE PERIOD WILL NOT COMMENCE UNTIL THE LANDSCAPE WORK HAS BEEN RE-INSPECTED BY THE OWNER AND FOUND TO BE ACCEPTABLE. AT THAT TIME, A WRITTEN NOTICE OF FINAL ACCEPTANCE WILL BE ISSUED BY THE OWNER, AND THE MAINTENANCE AND
- GUARANTEE PERIODS WILL COMMENCE. LANDSCAPE MAINTENANCE THE LANDSCAPE CONTRACTOR SHALL BE RESPONSIBLE FOR THE MAINTENANCE OF ALL WORK SHOWN ON THESE PLANS FOR 90 DAYS BEYOND FINAL ACCEPTANCE OF ALL LANDSCAPE WORK BY THE OWNER. LANDSCAPE MAINTENANCE SHALL INCLUDE WEEKLY SITE VISITS FOR THE FOLLOWING ACTIONS (AS APPROPRIATE): PROPER PRUNING, RESTAKING OF TREES, RESETTING OF PLANTS THAT HAVE SETTLED, MOWING AND AERATION OF LAWNS, WEEDING, RESEEDING AREAS WHICH HAVE NOT GERMINATED WELL, TREATING FOR INSECTS AND DISEASES, REPLACEMENT OF MULCH, REMOVAL OF LITTER, REPAIRS TO THE IRRIGATION SYSTEM DUE TO FAULTY PARTS AND/OR WORKMANSHIP, AND THE APPROPRIATE WATERING OF ALL PLANTINGS. THE LANDSCAPE CONTRACTOR SHALL MAINTAIN THE IRRIGATION SYSTEM IN PROPER WORKING ORDER, WITH SCHEDULING ADJUSTMENTS BY SEASON
- TO MAXIMIZE WATER CONSERVATION SHOULD SEEDED AND/OR SODDED AREAS NOT BE COVERED BY AN AUTOMATIC IRRIGATION SYSTEM. THE LANDSCAPE CONTRACTOR SHALL BE RESPONSIBLE FOR WATERING THESE AREAS AND OBTAINING
- A FULL, HEALTHY STAND OF PLANTS AT NO ADDITIONAL COST TO THE OWNER. TO ACHIEVE FINAL ACCEPTANCE AT THE END OF THE MAINTENANCE PERIOD, ALL OF THE FOLLOWING
- a. THE LANDSCAPE SHALL SHOW ACTIVE, HEALTHY GROWTH (WITH EXCEPTIONS MADE FOR SEASONAL DORMANCY). ALL PLANTS NOT MEETING THIS CONDITION SHALL BE REJECTED AND REPLACED BY HEALTHY PLANT MATERIAL PRIOR TO FINAL ACCEPTANCE.
- b. ALL HARDSCAPE SHALL BE CLEANED PRIOR TO FINAL ACCEPTANCE. HYDROMULCHED AREAS SHALL SHOW ACTIVE, HEALTHY GROWTH. BARE AREAS LARGER THAN


CONDITIONS MUST OCCUR-

- TWELVE SQUARE INCHES MUST BE RESODDED OR RESEEDED (AS APPROPRIATE) PRIOR TO FINAL ACCEPTANCE. WARRANTY PERIOD, PLANT GUARANTEE AND REPLACEMENTS THE LANDSCAPE CONTRACTOR SHALL GUARANTEE ALL TREES, SHRUBS, PERENNIALS,
- SEEDED/HYDROMULCHED AREAS, AND IRRIGATION SYSTEMS FOR A PERIOD OF ONE YEAR FROM THE DATE OF THE OWNER'S FINAL ACCEPTANCE (90 DAYS FOR ANNUAL PLANTS). THE CONTRACTOR SHALL REPLACE, AT HIS OWN EXPENSE AND TO THE SATISFACTION OF THE OWNER, ANY PLANTS WHICH DIE IN THAT TIME, OR REPAIR ANY PORTIONS OF THE IRRIGATION SYSTEM WHICH OPERATE IMPROPERLY AFTER THE INITIAL MAINTENANCE PERIOD AND DURING THE GUARANTEE PERIOD, THE LANDSCAPE
- CONTRACTOR SHALL ONLY BE RESPONSIBLE FOR REPLACEMENT OF PLANTS WHEN PLANT DEATH CANNOT BE ATTRIBUTED DIRECTLY TO OVERWATERING OR OTHER DAMAGE BY HUMAN ACTIONS. PROVIDE A MINIMUM OF (2) COPIES OF RECORD DRAWINGS TO THE OWNER UPON COMPLETION OF WORK. A RECORD DRAWING IS A RECORD OF ALL CHANGES THAT OCCURRED IN THE FIELD AND THAT ARE DOCUMENTED THROUGH CHANGE ORDERS, ADDENDA, OR CONTRACTOR/CONSULTANT DRAWING MARKUPS.

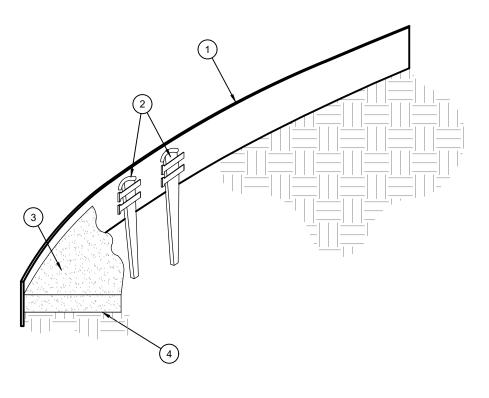

- (1) ROLLED-TOP STEEL EDGING PER PLANS
- (2) TAPERED STEEL STAKES.
- (3) MULCH, TYPE AND DEPTH PER PLANS. (4) FINISH GRADE.
- 1) INSTALL EDGING SO THAT STAKES WILL BE ON INSIDE OF PLANTING BED. 2) BOTTOM OF EDGING SHALL BE BURIED A MINIMUM OF 1" BELOW FINISH GRADE. 3) TOP OF MULCH SHALL BE 1" LOWER THAN TOP OF EDGING.




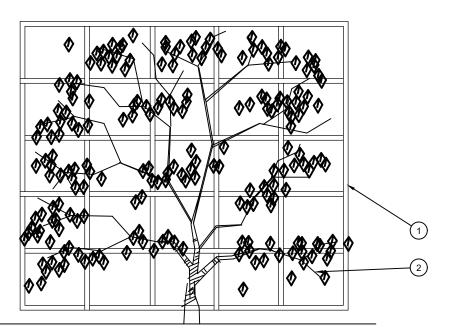


1 TRELLIS PER PLAN VINE. REMOVE NURSERY STAKES AND SECURE TO TRELLIS WITH VINE TIES.



ARRANGE VINE STEMS EVENLY ACROSS

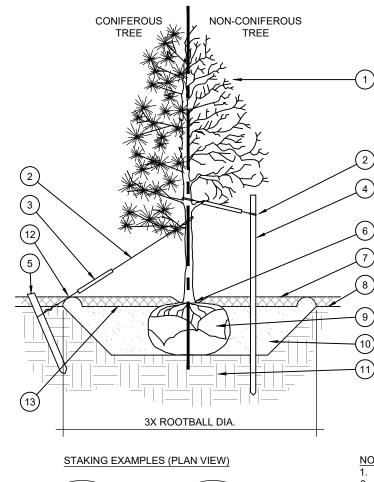

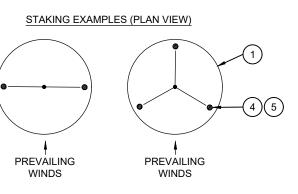

TREE PLANTING

SCALE: NOT TO SCALE

CINCH-TIES (24" BOX/2" CAL. TREES AND SMALLER) OR 12 GAUGE GALVANIZED WIRE WITH NYLON TREE STRAPS AT TREE AND STAKE (36" BOX/2.5" CAL. TREES AND LARGER). SECURE TIES OR STRAPS TO TRUNK JUST ABOVE LOWEST MAJOR BRANCHES.


- (3) 24" X 3/4" P.V.C. MARKERS OVER WIRES.
- (4) GREEN STEEL T-POSTS. EXTEND POSTS 12" MIN. INTO UNDISTURBED SOIL.
- (5) PRESSURE-TREATED WOOD DEADMAN. TWO PER TREE (MIN.) BURY OUTSIDE OF PLANTING PIT AND
- (6) TRUNK FLARE.

(1) TREE CANOPY.

(7) MULCH, TYPE AND DEPTH PER PLANS. DO NOT PLACE MULCH WITHIN 6" OF TRUNK.


18" MIN. INTO UNDISTURBED SOIL.

- (8) FINISH GRADE.
- (9) ROOT BALL.
- 0) BACKFILL. AMEND AND FERTILIZE ONLY AS RECOMMENDED IN SOIL FERTILITY ANALYSIS
- (11) UNDISTURBED NATIVE SOIL.
- (12) 4" HIGH EARTHEN WATERING BASIN (13) FINISH GRADE.
- SCARIFY SIDES OF PLANTING PIT PRIOR TO SETTING TREE. 2. REMOVE EXCESS SOIL APPLIED ON TOP OF THE ROOTBALL THAT COVERS THE ROOT FLARE. THE PLANTING HOLE DEPTH SHALL BE SUCH THAT THE ROOTBALL RESTS ON UNDISTURBED SOIL. AND THE ROOT FLARE IS 2"-4" ABOVE FINISH GRADE. FOR B&B TREES, CUT OFF BOTTOM 1/3 OF WIRE BASKET BEFORE
- PLACING TREE IN HOLE, CUT OFF AND REMOVE REMAINDER OF BASKET AFTER TREE IS SET IN HOLE. REMOVE ALL NYLON TIES. TWINE, ROPE, AND OTHER PACKING MATERIAL. REMOVE AS MUCH BURLAP FROM AROUND ROOTBALL AS IS PRACTICAL. REMOVE ALL NURSERY STAKES AFTER PLANTING
- 5. FOR TREES 36" BOX/2.5" CAL. AND LARGER, USE THREE STAKES OR DEADMEN (AS APPROPRIATE), SPACED EVENLY AROUND TREE. 6. STAKING SHALL BE TIGHT ENOUGH TO PREVENT TRUNK FROM BENDING, BUT LOOSE ENOUGH TO ALLOW SOME TRUNK MOVEMENT

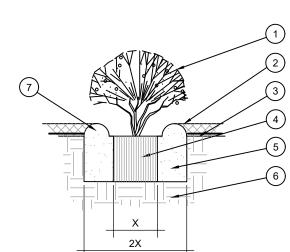


- 1) SHRUB, PERENNIAL, OR ORNAMENTAL GRASS.
- MULCH TYPE AND DEPTH PER PLANS PLACE NO. MORE THAN 1" OF MULCH WITHIN 6" OF PLANT
- (5) BACKFILL. AMEND AND FERTILIZE ONLY AS
- (7) 3" HIGH EARTHEN WATERING BASIN


SHRUB AND PERENNIAL PLANTING

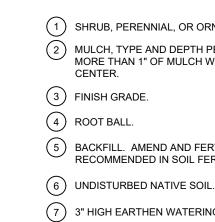



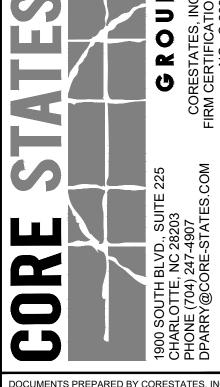

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ALMETTO UTILITY PROTECTION SERVICE SOUTH CAROLINA PUPS REVISIONS REV DATE COMMENT

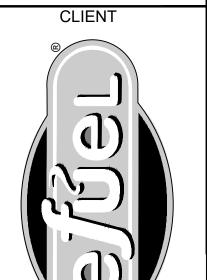DOCUMENT PRELIMINARY **DEVELOPMENT PLAN**

SITE LOCATION NEW RIVERSIDE VILLAGE

BLUFFTON, SC 29910

CERTIFICATE OF AUTHORIZATION

ENGINEER SEAL

NO. 1633

05-24-2023 SHEET TITLE LANDSCAPE **SPECIFICATIONS &**

DETAILS RFL.3514 12/13/202 SCALE: AS SHOWN DRAWN BY: CHECKED BY:

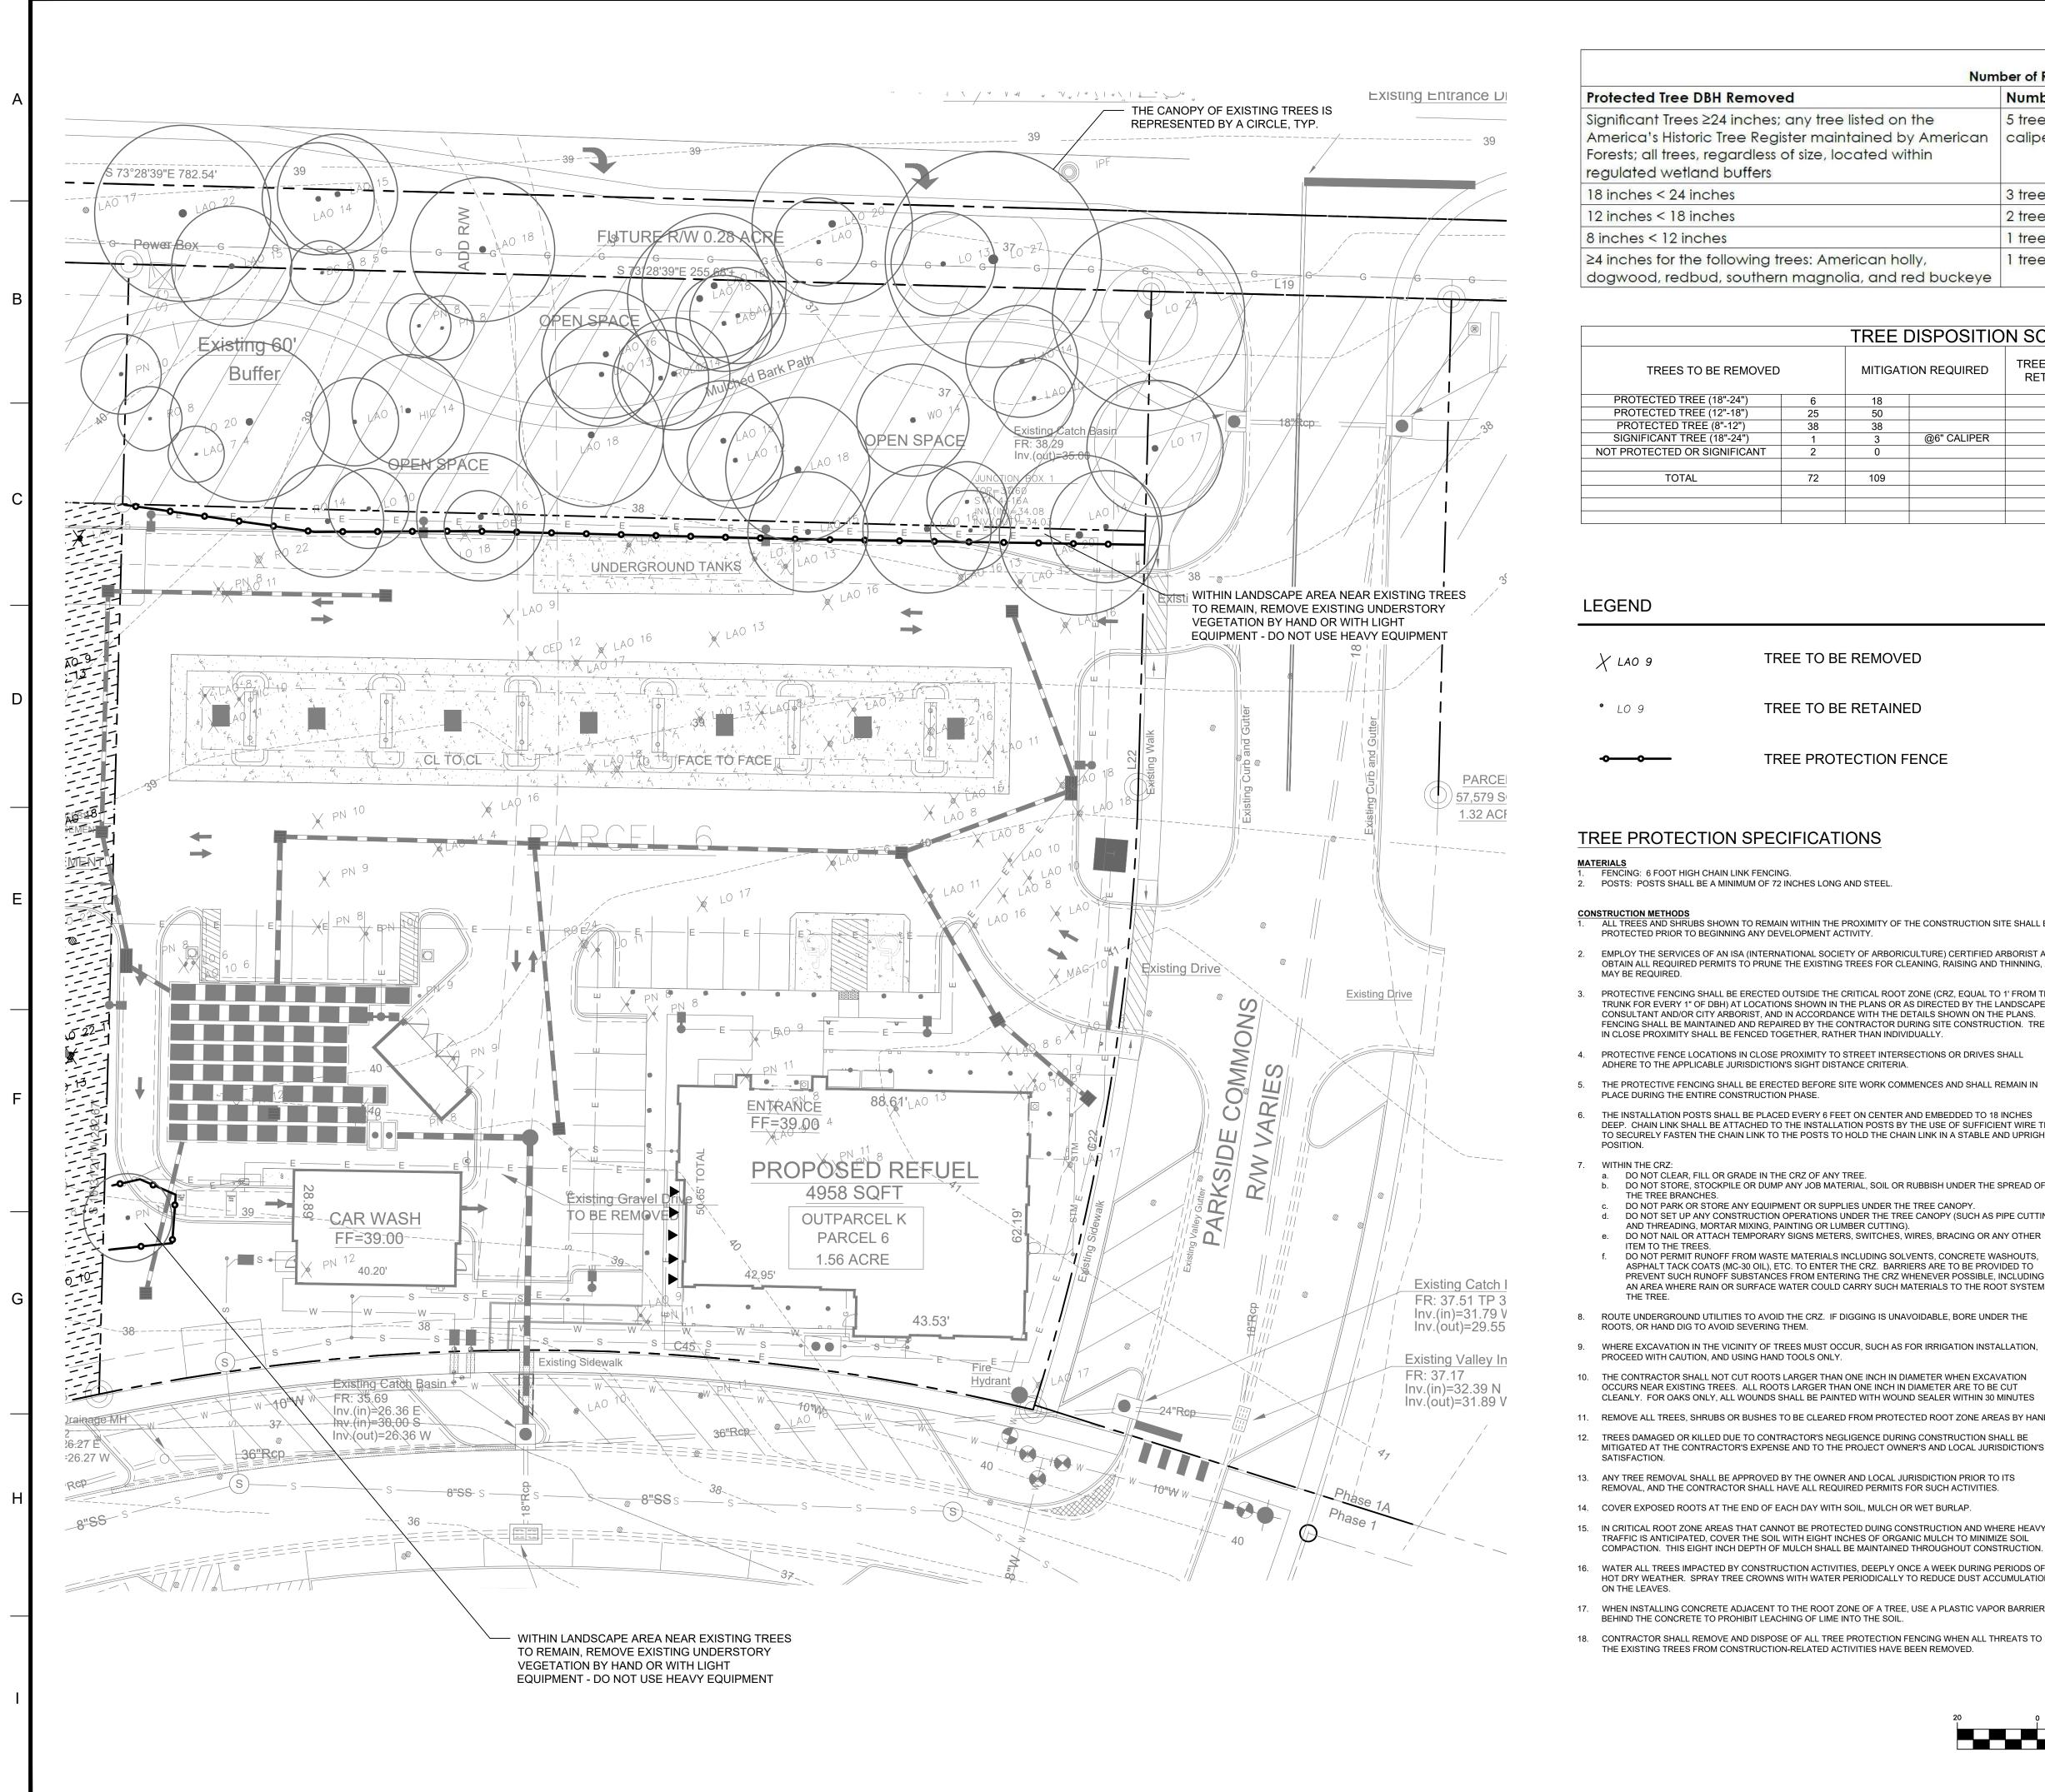


Table 5.3 Number of Replacement Trees Requ				
Protected Tree DBH Removed	Number of Replacement Trees			
Significant Trees ≥24 inches; any tree listed on the America's Historic Tree Register maintained by American Forests; all trees, regardless of size, located within regulated wetland buffers	5 trees or 3 trees with a 6-inch caliper at time of planting			
18 inches < 24 inches	3 trees			
12 inches < 18 inches	2 trees			
8 inches < 12 inches	1 tree			
≥4 inches for the following trees: American holly, dogwood, redbud, southern magnolia, and red buckeye	1 tree			

TREE DISPOSITION SCHEDULE							
TREES TO BE REMOVED		MITIGATION REQUIRED		TREES TO BE RETAINED	CANOPY TREES TO BE PLANTED	UNDERSTORY TREES TO BE PLANTED	MITIGATION PROVIDED
PROTECTED TREE (18"-24")	6	18		1			1
PROTECTED TREE (12"-18")	25	50		4			4
PROTECTED TREE (8"-12")	38	38		5			5
SIGNIFICANT TREE (18"-24")	1	3	@6" CALIPER				
NOT PROTECTED OR SIGNIFICANT	2	0					
TOTAL	72	109		19	6 (X3)	3	32
				<u> </u>			·

LEGEND

TREE TO BE REMOVED X LAO 9

• LO 9 TREE TO BE RETAINED

TREE PROTECTION FENCE

TREE PROTECTION SPECIFICATIONS

FENCING: 6 FOOT HIGH CHAIN LINK FENCING. 2. POSTS: POSTS SHALL BE A MINIMUM OF 72 INCHES LONG AND STEEL.

ALL TREES AND SHRUBS SHOWN TO REMAIN WITHIN THE PROXIMITY OF THE CONSTRUCTION SITE SHALL BE PROTECTED PRIOR TO BEGINNING ANY DEVELOPMENT ACTIVITY.


- EMPLOY THE SERVICES OF AN ISA (INTERNATIONAL SOCIETY OF ARBORICULTURE) CERTIFIED ARBORIST AND OBTAIN ALL REQUIRED PERMITS TO PRUNE THE EXISTING TREES FOR CLEANING, RAISING AND THINNING, AS
- PROTECTIVE FENCING SHALL BE ERECTED OUTSIDE THE CRITICAL ROOT ZONE (CRZ, EQUAL TO 1' FROM THE TRUNK FOR EVERY 1" OF DBH) AT LOCATIONS SHOWN IN THE PLANS OR AS DIRECTED BY THE LANDSCAPE CONSULTANT AND/OR CITY ARBORIST, AND IN ACCORDANCE WITH THE DETAILS SHOWN ON THE PLANS. FENCING SHALL BE MAINTAINED AND REPAIRED BY THE CONTRACTOR DURING SITE CONSTRUCTION. TREES IN CLOSE PROXIMITY SHALL BE FENCED TOGETHER, RATHER THAN INDIVIDUALLY.
- 4. PROTECTIVE FENCE LOCATIONS IN CLOSE PROXIMITY TO STREET INTERSECTIONS OR DRIVES SHALL ADHERE TO THE APPLICABLE JURISDICTION'S SIGHT DISTANCE CRITERIA.
- PLACE DURING THE ENTIRE CONSTRUCTION PHASE.
- 6. THE INSTALLATION POSTS SHALL BE PLACED EVERY 6 FEET ON CENTER AND EMBEDDED TO 18 INCHES DEEP. CHAIN LINK SHALL BE ATTACHED TO THE INSTALLATION POSTS BY THE USE OF SUFFICIENT WIRE TIES TO SECURELY FASTEN THE CHAIN LINK TO THE POSTS TO HOLD THE CHAIN LINK IN A STABLE AND UPRIGHT

7. WITHIN THE CRZ:

- a. DO NOT CLEAR, FILL OR GRADE IN THE CRZ OF ANY TREE. b. DO NOT STORE, STOCKPILE OR DUMP ANY JOB MATERIAL, SOIL OR RUBBISH UNDER THE SPREAD OF THE TREE BRANCHES.
- c. DO NOT PARK OR STORE ANY EQUIPMENT OR SUPPLIES UNDER THE TREE CANOPY. DO NOT SET UP ANY CONSTRUCTION OPERATIONS UNDER THE TREE CANOPY (SUCH AS PIPE CUTTING AND THREADING, MORTAR MIXING, PAINTING OR LUMBER CUTTING).
- e. DO NOT NAIL OR ATTACH TEMPORARY SIGNS METERS, SWITCHES, WIRES, BRACING OR ANY OTHER ITEM TO THE TREES.
- f. DO NOT PERMIT RUNOFF FROM WASTE MATERIALS INCLUDING SOLVENTS, CONCRETE WASHOUTS, ASPHALT TACK COATS (MC-30 OIL), ETC. TO ENTER THE CRZ. BARRIERS ARE TO BE PROVIDED TO PREVENT SUCH RUNOFF SUBSTANCES FROM ENTERING THE CRZ WHENEVER POSSIBLE, INCLUDING IN AN AREA WHERE RAIN OR SURFACE WATER COULD CARRY SUCH MATERIALS TO THE ROOT SYSTEM OF
- 8. ROUTE UNDERGROUND UTILITIES TO AVOID THE CRZ. IF DIGGING IS UNAVOIDABLE, BORE UNDER THE ROOTS, OR HAND DIG TO AVOID SEVERING THEM.
- 9. WHERE EXCAVATION IN THE VICINITY OF TREES MUST OCCUR, SUCH AS FOR IRRIGATION INSTALLATION, PROCEED WITH CAUTION, AND USING HAND TOOLS ONLY.
- 10. THE CONTRACTOR SHALL NOT CUT ROOTS LARGER THAN ONE INCH IN DIAMETER WHEN EXCAVATION OCCURS NEAR EXISTING TREES. ALL ROOTS LARGER THAN ONE INCH IN DIAMETER ARE TO BE CUT
- 11. REMOVE ALL TREES, SHRUBS OR BUSHES TO BE CLEARED FROM PROTECTED ROOT ZONE AREAS BY HAND.

CLEANLY. FOR OAKS ONLY, ALL WOUNDS SHALL BE PAINTED WITH WOUND SEALER WITHIN 30 MINUTES

- 12. TREES DAMAGED OR KILLED DUE TO CONTRACTOR'S NEGLIGENCE DURING CONSTRUCTION SHALL BE MITIGATED AT THE CONTRACTOR'S EXPENSE AND TO THE PROJECT OWNER'S AND LOCAL JURISDICTION'S
- 13. ANY TREE REMOVAL SHALL BE APPROVED BY THE OWNER AND LOCAL JURISDICTION PRIOR TO ITS REMOVAL, AND THE CONTRACTOR SHALL HAVE ALL REQUIRED PERMITS FOR SUCH ACTIVITIES.
- 14. COVER EXPOSED ROOTS AT THE END OF EACH DAY WITH SOIL, MULCH OR WET BURLAP.
- 15. IN CRITICAL ROOT ZONE AREAS THAT CANNOT BE PROTECTED DUING CONSTRUCTION AND WHERE HEAVY TRAFFIC IS ANTICIPATED, COVER THE SOIL WITH EIGHT INCHES OF ORGANIC MULCH TO MINIMIZE SOIL COMPACTION. THIS EIGHT INCH DEPTH OF MULCH SHALL BE MAINTAINED THROUGHOUT CONSTRUCTION.
- 16. WATER ALL TREES IMPACTED BY CONSTRUCTION ACTIVITIES, DEEPLY ONCE A WEEK DURING PERIODS OF HOT DRY WEATHER. SPRAY TREE CROWNS WITH WATER PERIODICALLY TO REDUCE DUST ACCUMULATION
- 17. WHEN INSTALLING CONCRETE ADJACENT TO THE ROOT ZONE OF A TREE, USE A PLASTIC VAPOR BARRIER BEHIND THE CONCRETE TO PROHIBIT LEACHING OF LIME INTO THE SOIL.
- 18. CONTRACTOR SHALL REMOVE AND DISPOSE OF ALL TREE PROTECTION FENCING WHEN ALL THREATS TO THE EXISTING TREES FROM CONSTRUCTION-RELATED ACTIVITIES HAVE BEEN REMOVED.

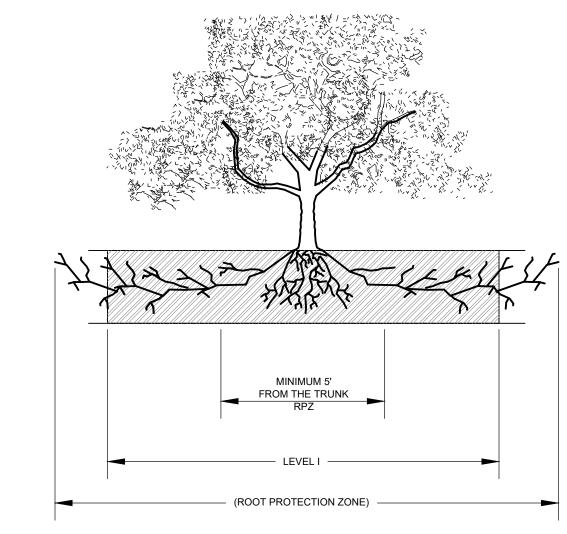



GRAPHIC SCALE


(IN FEET) 1 inch = 20 ft.







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ALMETTO UTILITY PROTECTION SERVICE

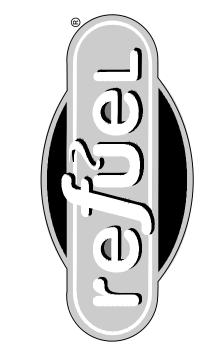REVISIONS EV DATE COMMENT

DOCUMENT **PRELIMINARY** DEVELOPMENT PLAN

SITE LOCATION

NEW RIVERSIDE VILLAGE BLUFFTON, SC 29910

CERTIFICATE OF AUTHORIZATION



SHEET TITLE TREE DISPOSITION PLAN

RFL.35149 12/13/202 SCALE: AS SHOWN DRAWN BY: CHECKED BY: