LAKE + LAND GENERAL NOTES
1. THE CONTRACTOR SHALL FULLY COMPLY WITH THE MOST CURRENT IBC AS WELL AS ALL ADDITIONAL STATE AND LOCAL CODE REQUIREMENTS. THE MOST CURRENT IEC AND IMC SHALL BE USED. THE CONTRACTOR SHALL BE LIABLE FOR ANY WORK KNOWINGLY PERFORMED CONTRARY TO SUCH LAWS, ORDINANCES, OR REGULATIONS. THE CONTRACTOR SHALL COORDINATE WITH ALL UTILITIES AND STATE SERVICE AUTHORITIES INVOLVED.
2. THE CONTRACTOR SHALL USE ONLY WRITTEN DIMENSIONS, OR THOSE OTHERWISE DIRECTLY INDICATED BY LAKE AND LAND STUDIO, LLC. THE CONTRACTOR SHALL NOT SCALE DRAWINGS. THE CONTRACTOR SHALL VERIFY ALL DIMENSIONS (INCLUDING ROUGH OPENINGS) AND FOR THE CONDITIONS ON THE JOB.
3. THE CONTRACTOR IS RESPONSIBLE FOR THE DESIGN AND PROPER FUNCTION OF PLUMBING, HVAC, AND ELECTRICAL SYSTEMS.
4. THE CONTRACTOR SHALL REVIEW ALL DRAWINGS AND DETAILS CONTAINED WITHIN THE DESIGN PLANS; PRIOR TO THE INITIATION OF CONSTRUCTION, ANY SUSPECTED ERRORS, INCONSISTENCIES, AND/OR POTENTIAL DETAIL OMISSIONS ARE TO BE REPORTED TO LAKE AND LAND STUDIO, LLC FOR CLARIFICATION. THE CONTRACTOR SHALL NOT WORK WITHOUT CORRECT DESIGN PLANS. LAKE AND LAND STUDIO, LLC WILL NOT BE RESPONSIBLE FOR ANY IMPLICATIONS THAT RESULT SECONDARY TO A CONTRACTOR OR SUBCONTRACTOR'S CONSTRUCTION MEANS AND METHODS OR ACTS THAT ARE NOT COMPLETED IN ACCORDANCE WITH DESIGN PLANS.
5. THESE DESIGN PLANS ARE PROPERTY OF LAKE AND LAND STUDIO, LLC AND ARE PROTECTED UNDER FEDERAL COPYRIGHT LAWS. USE OF THE DESIGN PLAN INFORMATION CONTAINED HEREIN IS AUTHORIZED FOR ONE-TIME USE ONLY, AS OUTLINED WITHIN THE DESIGN PLAN PURCHASE AGREEMENT. ANY DUPLICATION, PUBLICATION, DISTRIBUTION, AND/OR SALE OF ANY PART(S) OF THE PLANS IS STRICTLY PROHIBITED. ANY UNAUTHORIZED USE OF THE COPYRIGHTED MATERIAL REPRESENTS A VIOLATION OF FEDERAL LAW AND IS SUBJECT TO THE PRESCRIBED PENALTIES UNLESS PRIOR WRITTEN PERMISSION FOR USE IS GRANTED BY LAKE AND LAND STUDIO, LLC.
6. PURCHASE AGREEMENT: PURCHASE OF THESE DESIGN PLANS GRANTS THE BUYER THE RIGHT TO USE DOCUMENTS CONTAINED WITHIN FOR THE CONSTRUCTION OF A SINGLE HOME. THE BUYER ACKNOWLEDGES THAT THE TITLE, DESIGN PLANS (AND DERIVATIVES THEREOF), INTEREST IN COPYRIGHTS, AND ALL OTHER RIGHTS OF OWNERSHIP REMAIN WITH LAKE AND LAND STUDIO, LLC. ANY DESIGN PLAN MODIFICATIONS ARE CONSIDERED TO BE DERIVATIVES OF THE ORIGINAL AND ARE PROTECTED WITHIN THE COPYRIGHT PARAMETERS PREVIOUSLY STATED; PLAN DERIVATIVES MAY NOT BE SOLD, COPIED, OR USED FOR CONSTRUCTION OF ANY OTHER RESIDENCE.
7. LAKE AND LAND STUDIO, LLC WILL NOT BE HELD RESPONSIBLE FOR ANY FAULT RESULTING FROM UNAUTHORIZED USE OF ANY PART(S) OF THESE DESIGN PLANS (OR ANY AFTER-PURCHASE DESIGN MODIFICATIONS) IN ANY CONSTRUCTION OR BUILDING ACT.
8. LAKE AND LAND STUDIO, LLC RESERVES THE RIGHT TO MAKE MODIFICATIONS TO DESIGN PLANS, DRAWINGS, AND/OR MODELS AT ANY TIME; DETAILS IN IMAGES USED FOR MARKETING PURPOSES ON WEBSITES OR IN CATALOGS MAY NOT MATCH DESIGN PLANS EXACTLY.
9. LIMITATION OF LIABILITY: LAKE AND LAND STUDIO, LLC SHALL NOT BE LIABLE FOR ANY SPECIAL, CONSEQUENTIAL, INCIDENTAL, OR INDIRECT DAMAGES ARISING FROM USE OF THE PLANS INCLUDING, BUT NOT LIMITED TO, DAMAGES FOR LOSS OF ANTICIPATED PROFITS OR LOSS OF BUSINESS OPPORTUNITY. TO THE EXTENT PERMITTED BY LAW, LIABILITY OF LAKE AND LAND STUDIO, LLC SHALL BE LIMITED TO THE RETAIL PRICE OF THE PLANS.
10. BUILDING CODES VARY BY LOCATION DUE TO VAST DIFFERENCES IN GEOGRAPHICAL AND CLIMATE RELATED FACTORS THAT IMPACT CONSTRUCTION. EACH STATE, COUNTY, AND MUNICIPALITY HAS ITS OWN RESPECTIVE BUILDING CODES, ZONE REQUIREMENTS, AND ORDINANCES FOR BUILDING REGULATIONS. THE CONTRACTOR IS RESPONSIBLE FOR SUBMITTING PLANS TO THE NECESSARY STATE, COUNTY, AND LOCAL OFFICIALS FOR PERMITTING OF CONSTRUCTION OF THIS PROJECT. DESIGN PLANS MAY NEED TO BE MODIFIED TO COMPLY WITH LOCAL REQUIREMENTS REGARDING SNOW LOADS, ENERGY CODES, SOIL AND SEISMIC CONDITIONS, AND NUMEROUS OTHER VARIABLE FACTORS. IT IS THE BUYER'S RESPONSIBILITY TO CONSULT WITH APPROPRIATE LOCAL CONSTRUCTION PROFESSIONALS (ARCHITECTS, ENGINEERS) TO DETERMINE IF PLANS COMPLY WITH CODES GOVERNING THE BUYER'S BUILDING SITE AND, IF NECESSARY, TO SEE THAT APPROPRIATE MODIFICATIONS ARE MADE TO PLANS PRIOR TO CONSTRUCTION.

S-101 A-101 A-102 A-103 A-104 A-201 A-202 A-401 E-101 E-102

C-101

P-101 P-102


SUOZZI RESIDENCE BLUFFTON, SC




SECOND FLOOR PLUMBING PLAN

003	DOOR LA
Wo3	WINDOW LA
	INTERIOR ELEVATION LA
8X8 POST	ANNOTAT
/	BREAK L
	HIDDEN OR INVISIBLE L
SUBFLOOR	ELEVATION DATUM L
B <u>UILDING SECTION</u> SHEET A-301	SECTION CUT L

+ STUDIO
LAKE AND LAND STUDIO, LLC RECOMMENDS THAT ALL DRAWINGS BE REVIEWED AND APPROVED BY A LICENSED ARCHITECT OR STRUCTURAL ENGINEER. INCLUDED DRAWINGS ARE FOR DESIGN PURPOSES ONLY.
SHEET TITLE: COVER PAGE
PROJECT DESCRIPTION: SUOZZI RESIDENCE BLUFFTON,SC
DRAWINGS PROVIDED BY: LAKE AND LAND STUDIO, LLC 16 Bellegrass Blvd Hattiesburg, MS 39402 601.336.8114 info@lakeandlandstudio.com
7/18/2023 SCALE: NO SCALE SHEET: COVER

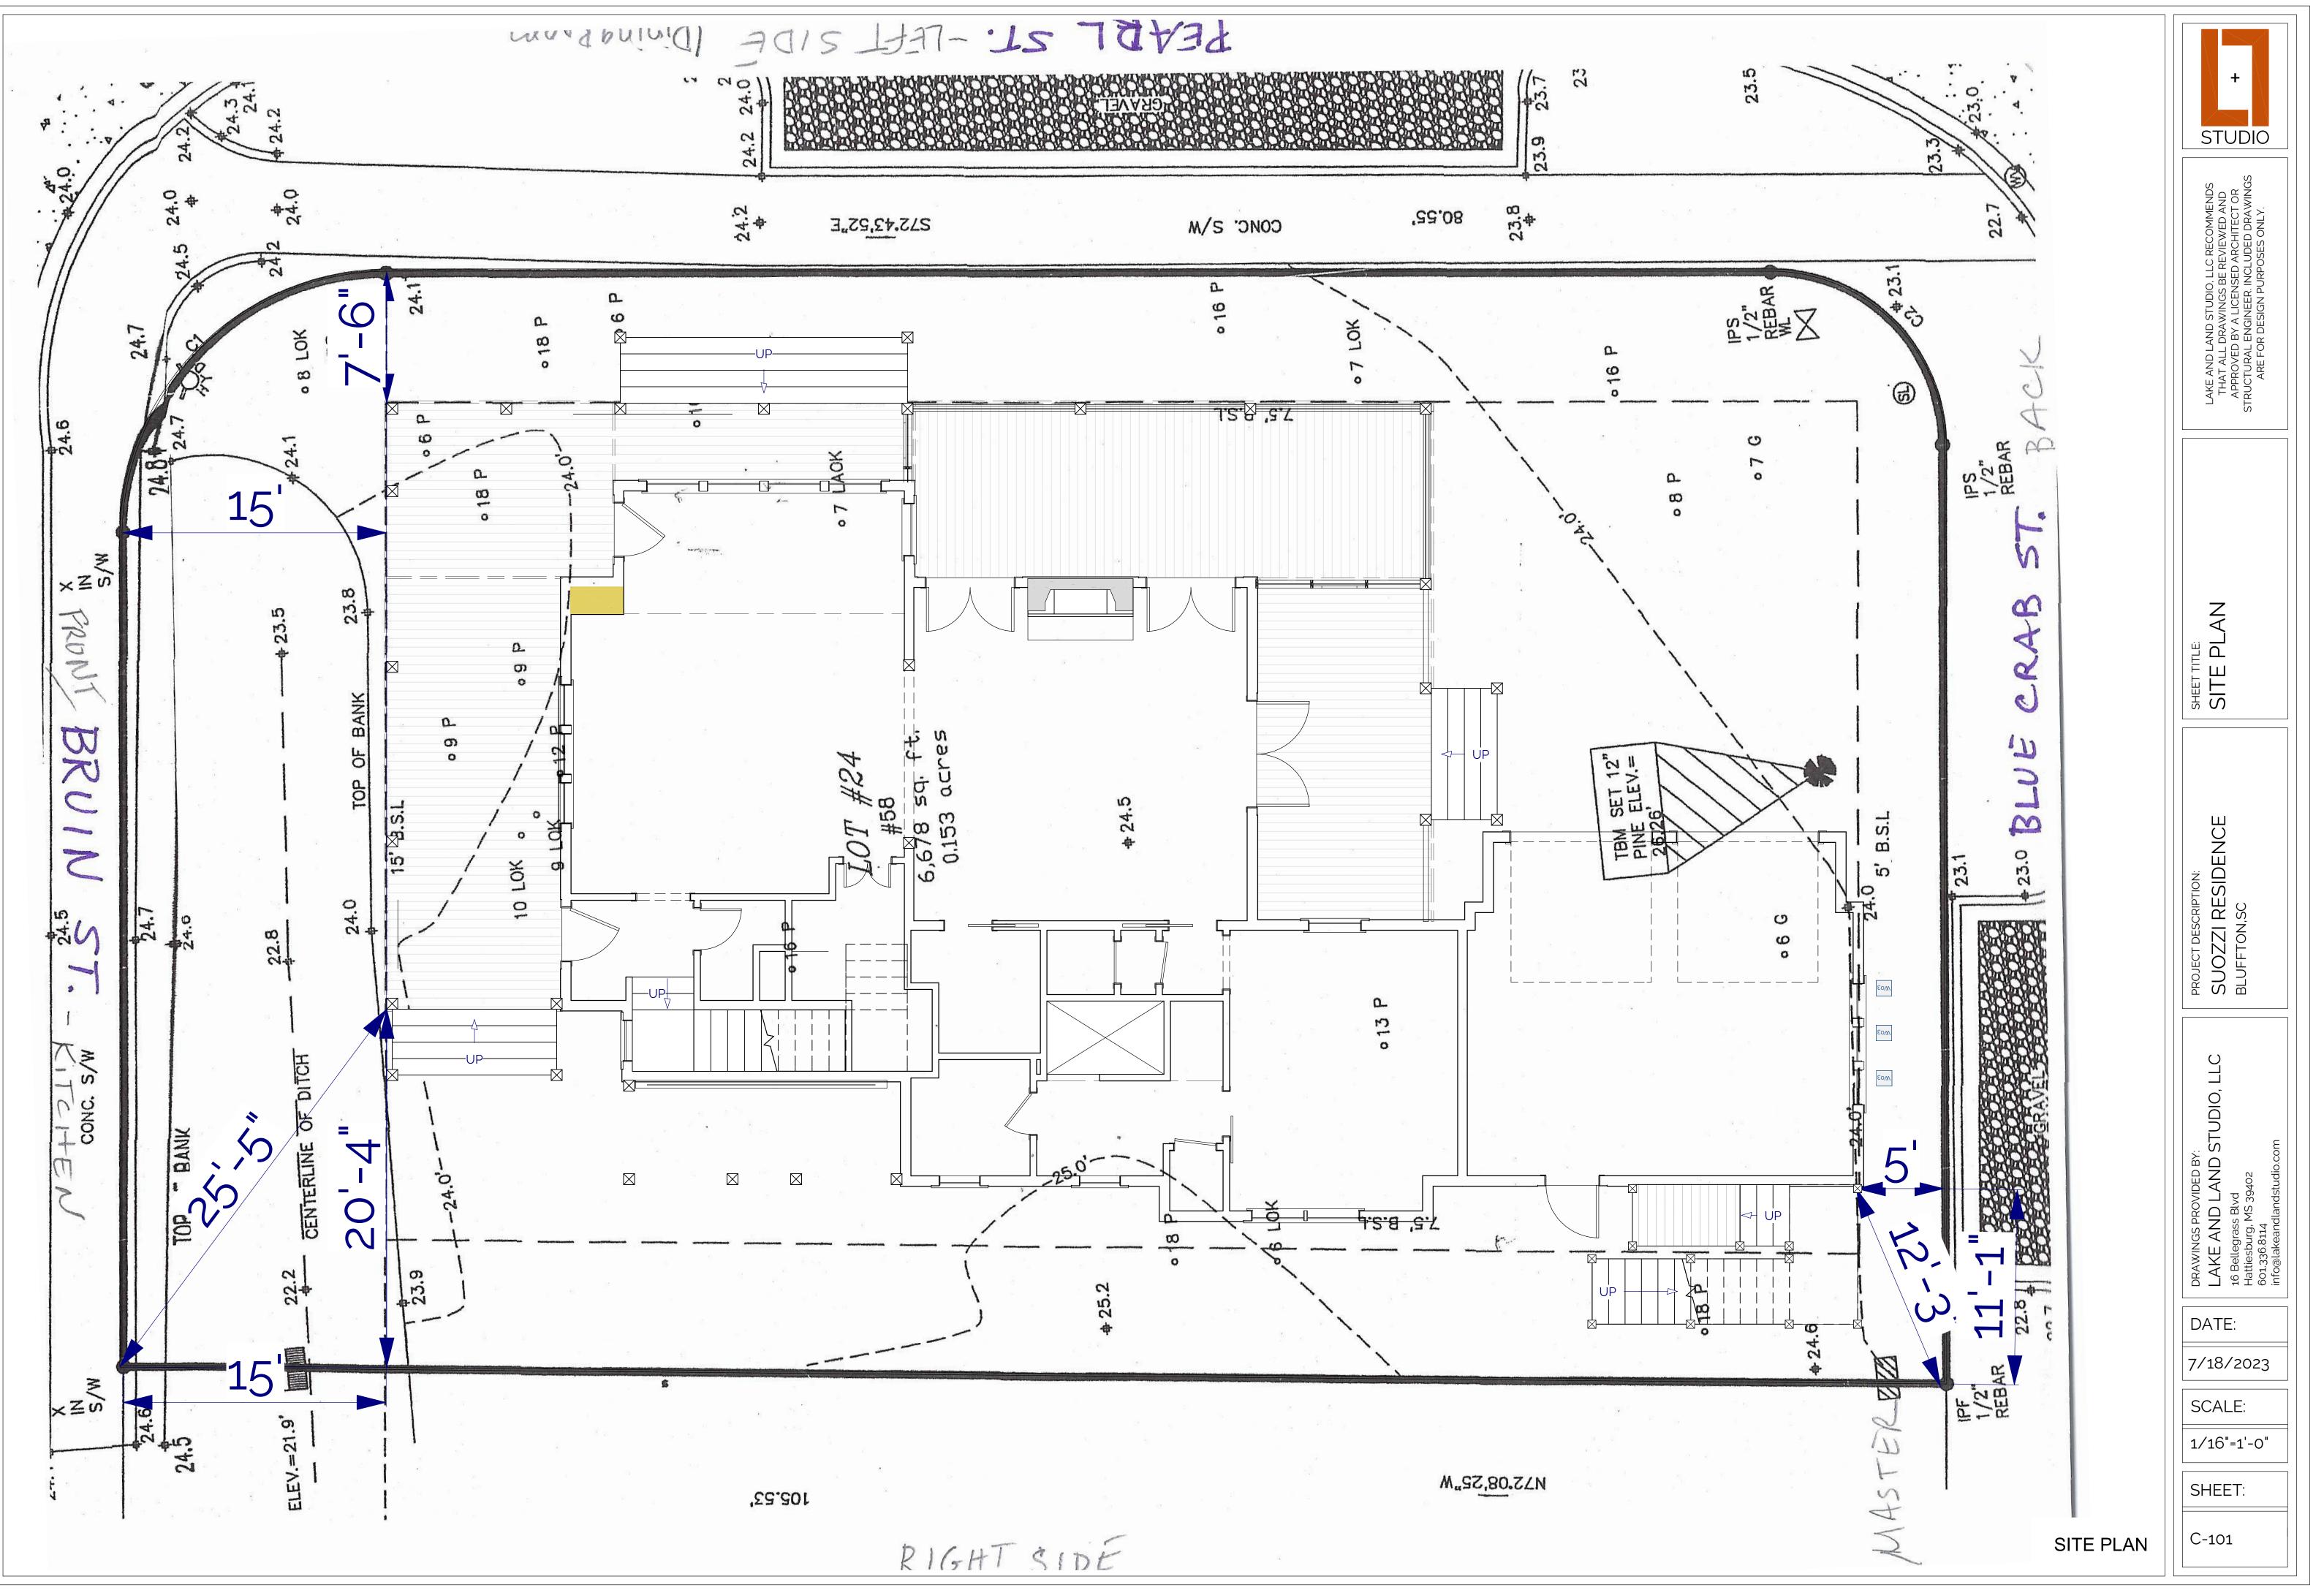

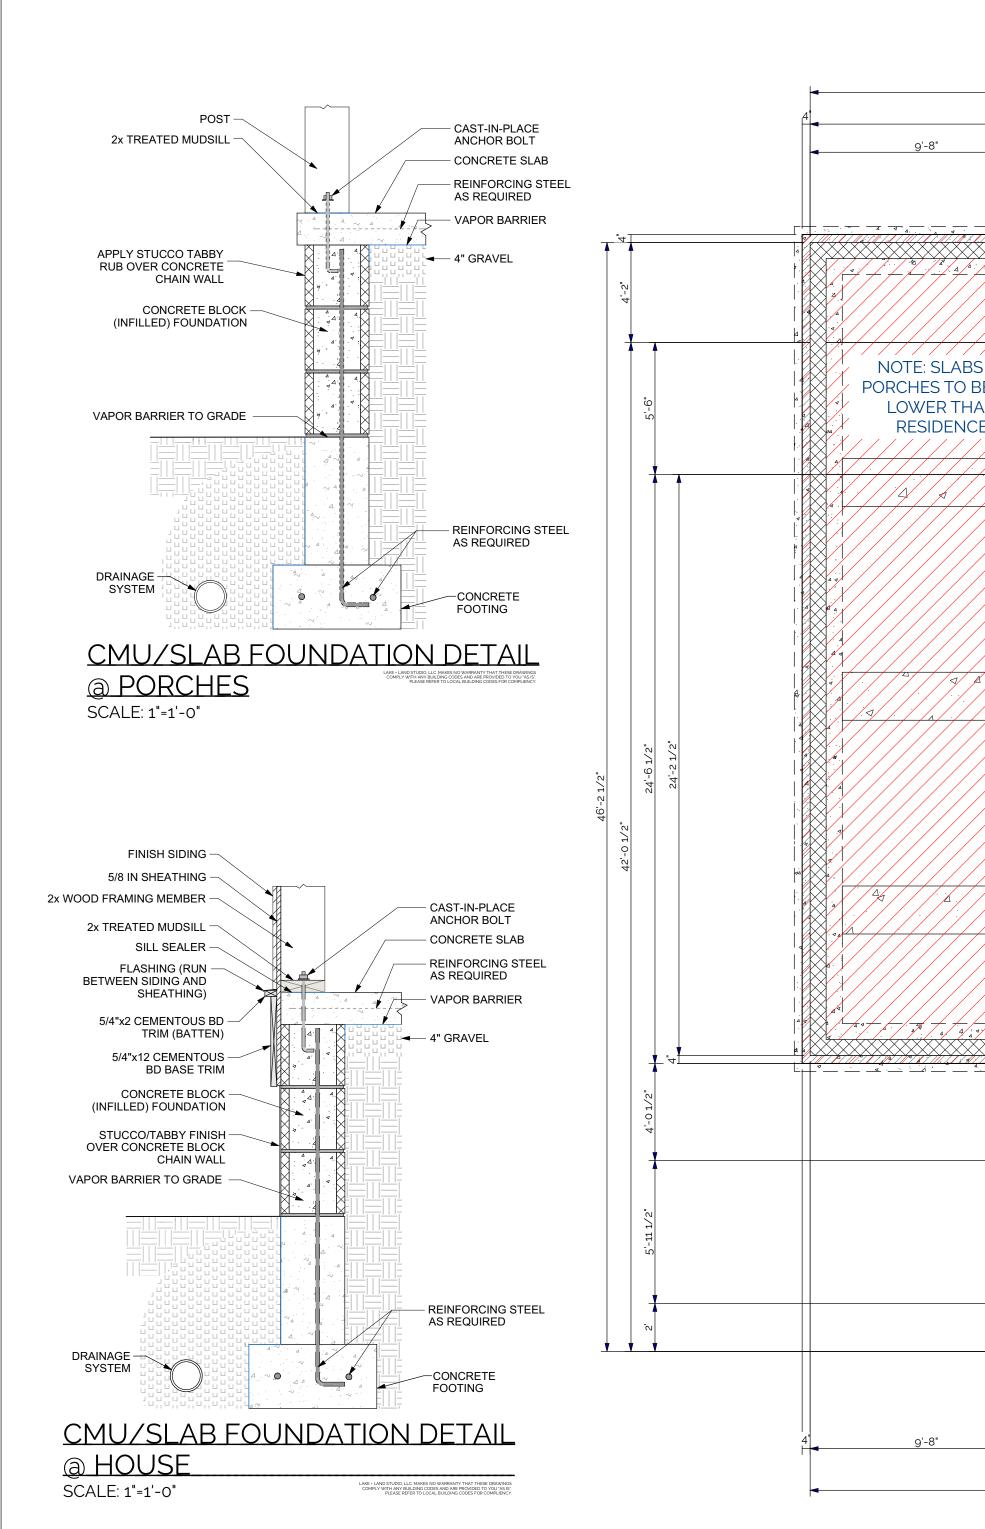

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	◀ 3'-6"		15'-10 1/2"			14'-9	9"			17'-5"
						51'-6 1/2"				


FOUNDATION PLAN


83'-9"

GENERAL FRAMING NOTES


- 1. CONTRACTOR TO ENSURE ALL WORKMANSHIP AND MATERIALS SHALL CONFORM TO THE NATIONAL DESIGN SPECIFICATIONS FOR WOOD CONSTRUCTION, PUBLISHED BY THE NATIONAL FOREST PRODUCTS ASSOCIATION (NFPA). 2. ALL STRUCTURAL INFORMATION SHOWN ARE FOR REFERENCE PURPOSES ONLY. ALL STRUCTURAL DESIGN WILL MEET OR EXCEED STRUCTURAL ELEMENTS SUCH AS FOOTINGS, REINFORCEMENT, FOUNDATION WALLS, PIERS AND SLAB TO THE LATEST EDITION OF THE INTERNATIONAL BUILDING CODES (I.B.C.) AND/OR LOCAL BUILDING CODES. 3. THE GENERAL CONTRACTOR SHALL HAVE A LOCAL LICENSED ENGINEER (P.E.) REVIEW THE STRUCTURAL DESIGN NEEDS OF THE STRUCTURE IN CONJUNCTION WITH SITE CONDITIONS, AND DESIGN ALL FRAMING ELEMENTS SUCH AS JOISTS, BEAMS, GIRDERS, HEADERS, COLUMNS AND RAFTERS. CONSTRUCTION SHALL NOT BEGIN WITHOUT SAID REVIEW AND DELIVERY OF ENGINEERED
- PLANS BY THE P.E. 4. THE CONTRACTOR WILL REVIEW THE PLANS, ELEVATION AND DETAILS, AND ADVISE THE OWNER AND/OR DESIGNER SHOULD ANY CONDITIONS REQUIRE MODIFICATIONS TO THE DESIGN INTENT SHOWN ON THE PLANS, SECTIONS OR EXTERIOR ELEVATIONS. 5. IF "ENGINEERED LUMBER" OR TRUSSES WILL BE USED, THEY WILL BE DESIGNED AND APPROVED BY A P.E.
- 6. INSTALL SOLID BRACING, OR EQUAL, AT ALL OUTSIDE CORNERS. 7. PROVIDE DOUBLE JOISTS UNDER ALL NON-LOAD BEARING PARTITIONS PARALLEL TO THE SPAN OF THE FLOOR JOISTS.
- 8. PROVIDE DIAGONAL OR SOLID BLOCKING AT 8' O.C. MAXIMUM IN ALL FLOOR JOUSTS, AND SOLID BLOCKING BETWEEN FLOOR JOIST 4. CONTRACTOR TO INSTALL ALUMINUM SHEET METAL TERMITE SHIELDS CONTINUOUS BETWEEN ANY WOOD UNDER WALLS THAT ARE PERPENDICULAR TO THE FLOOR JOISTS. 9. INSTALL A CONTINUOUS ALUMINUM TERMITE SHIELD BETWEEN ANY WOOD AND CONCRETE SURFACES.
- 10. ALL STRUCTURAL WOOD USED IN THE CONSTRUCTION OF STEPS, PORCHES AND DECKS, SHALL BE PRESSURE TREATED OR EQUAL. 11. ALL WOOD IN CONTACT WITH CONCRETE SHALL BE PRESSURE TREATED.
- 12. INSTALL HURRICANE CONNECTIONS AS REQUIRED BY LOCAL CONDITIONS AND BUILDING CODES. 13. ALL KNEE WALL CONSTRUCTION TO BE DIAGONALLY BRACED AT 4' O.C. MAXIMUM.

- **GENERAL FOUNDATION NOTES**
- ENSURE IT MEETS LOCAL BUILDING CODES.
- ENGINEERING DESIGN.
- THE HOUSE). SURFACES THAT ARE EXPOSED TO CONCRETE SURFACES.
- CONFORM TO ASTM STANDARDS.
- DAYS. 7. ALL CONSTRUCTION ON FILL SOILS SHALL BE DESIGNED BY A P.E.
- FROST DEPTH WARRANTS A GREATER DEPTH.

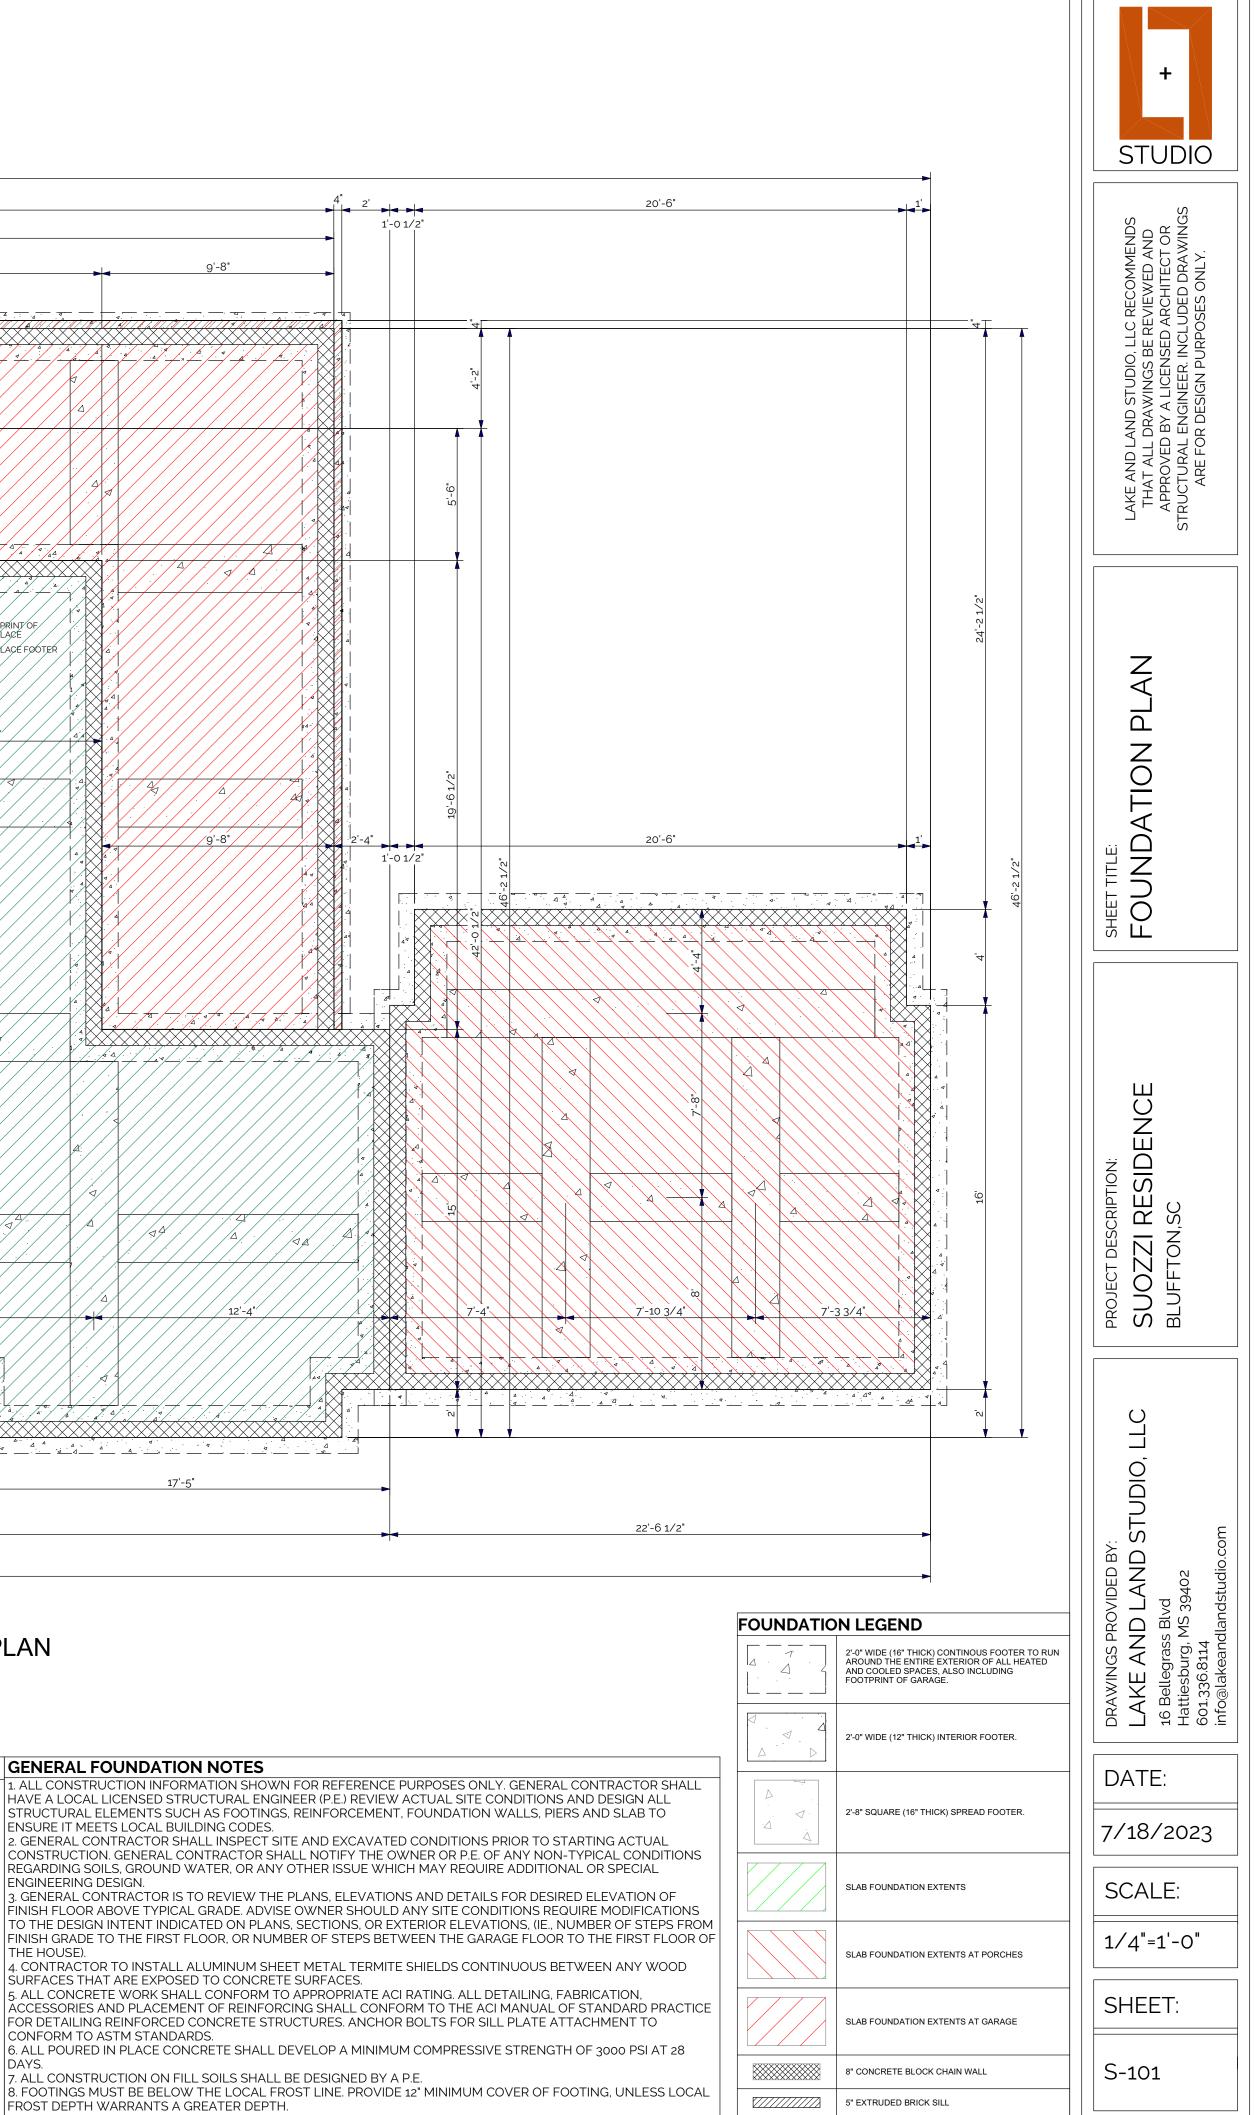


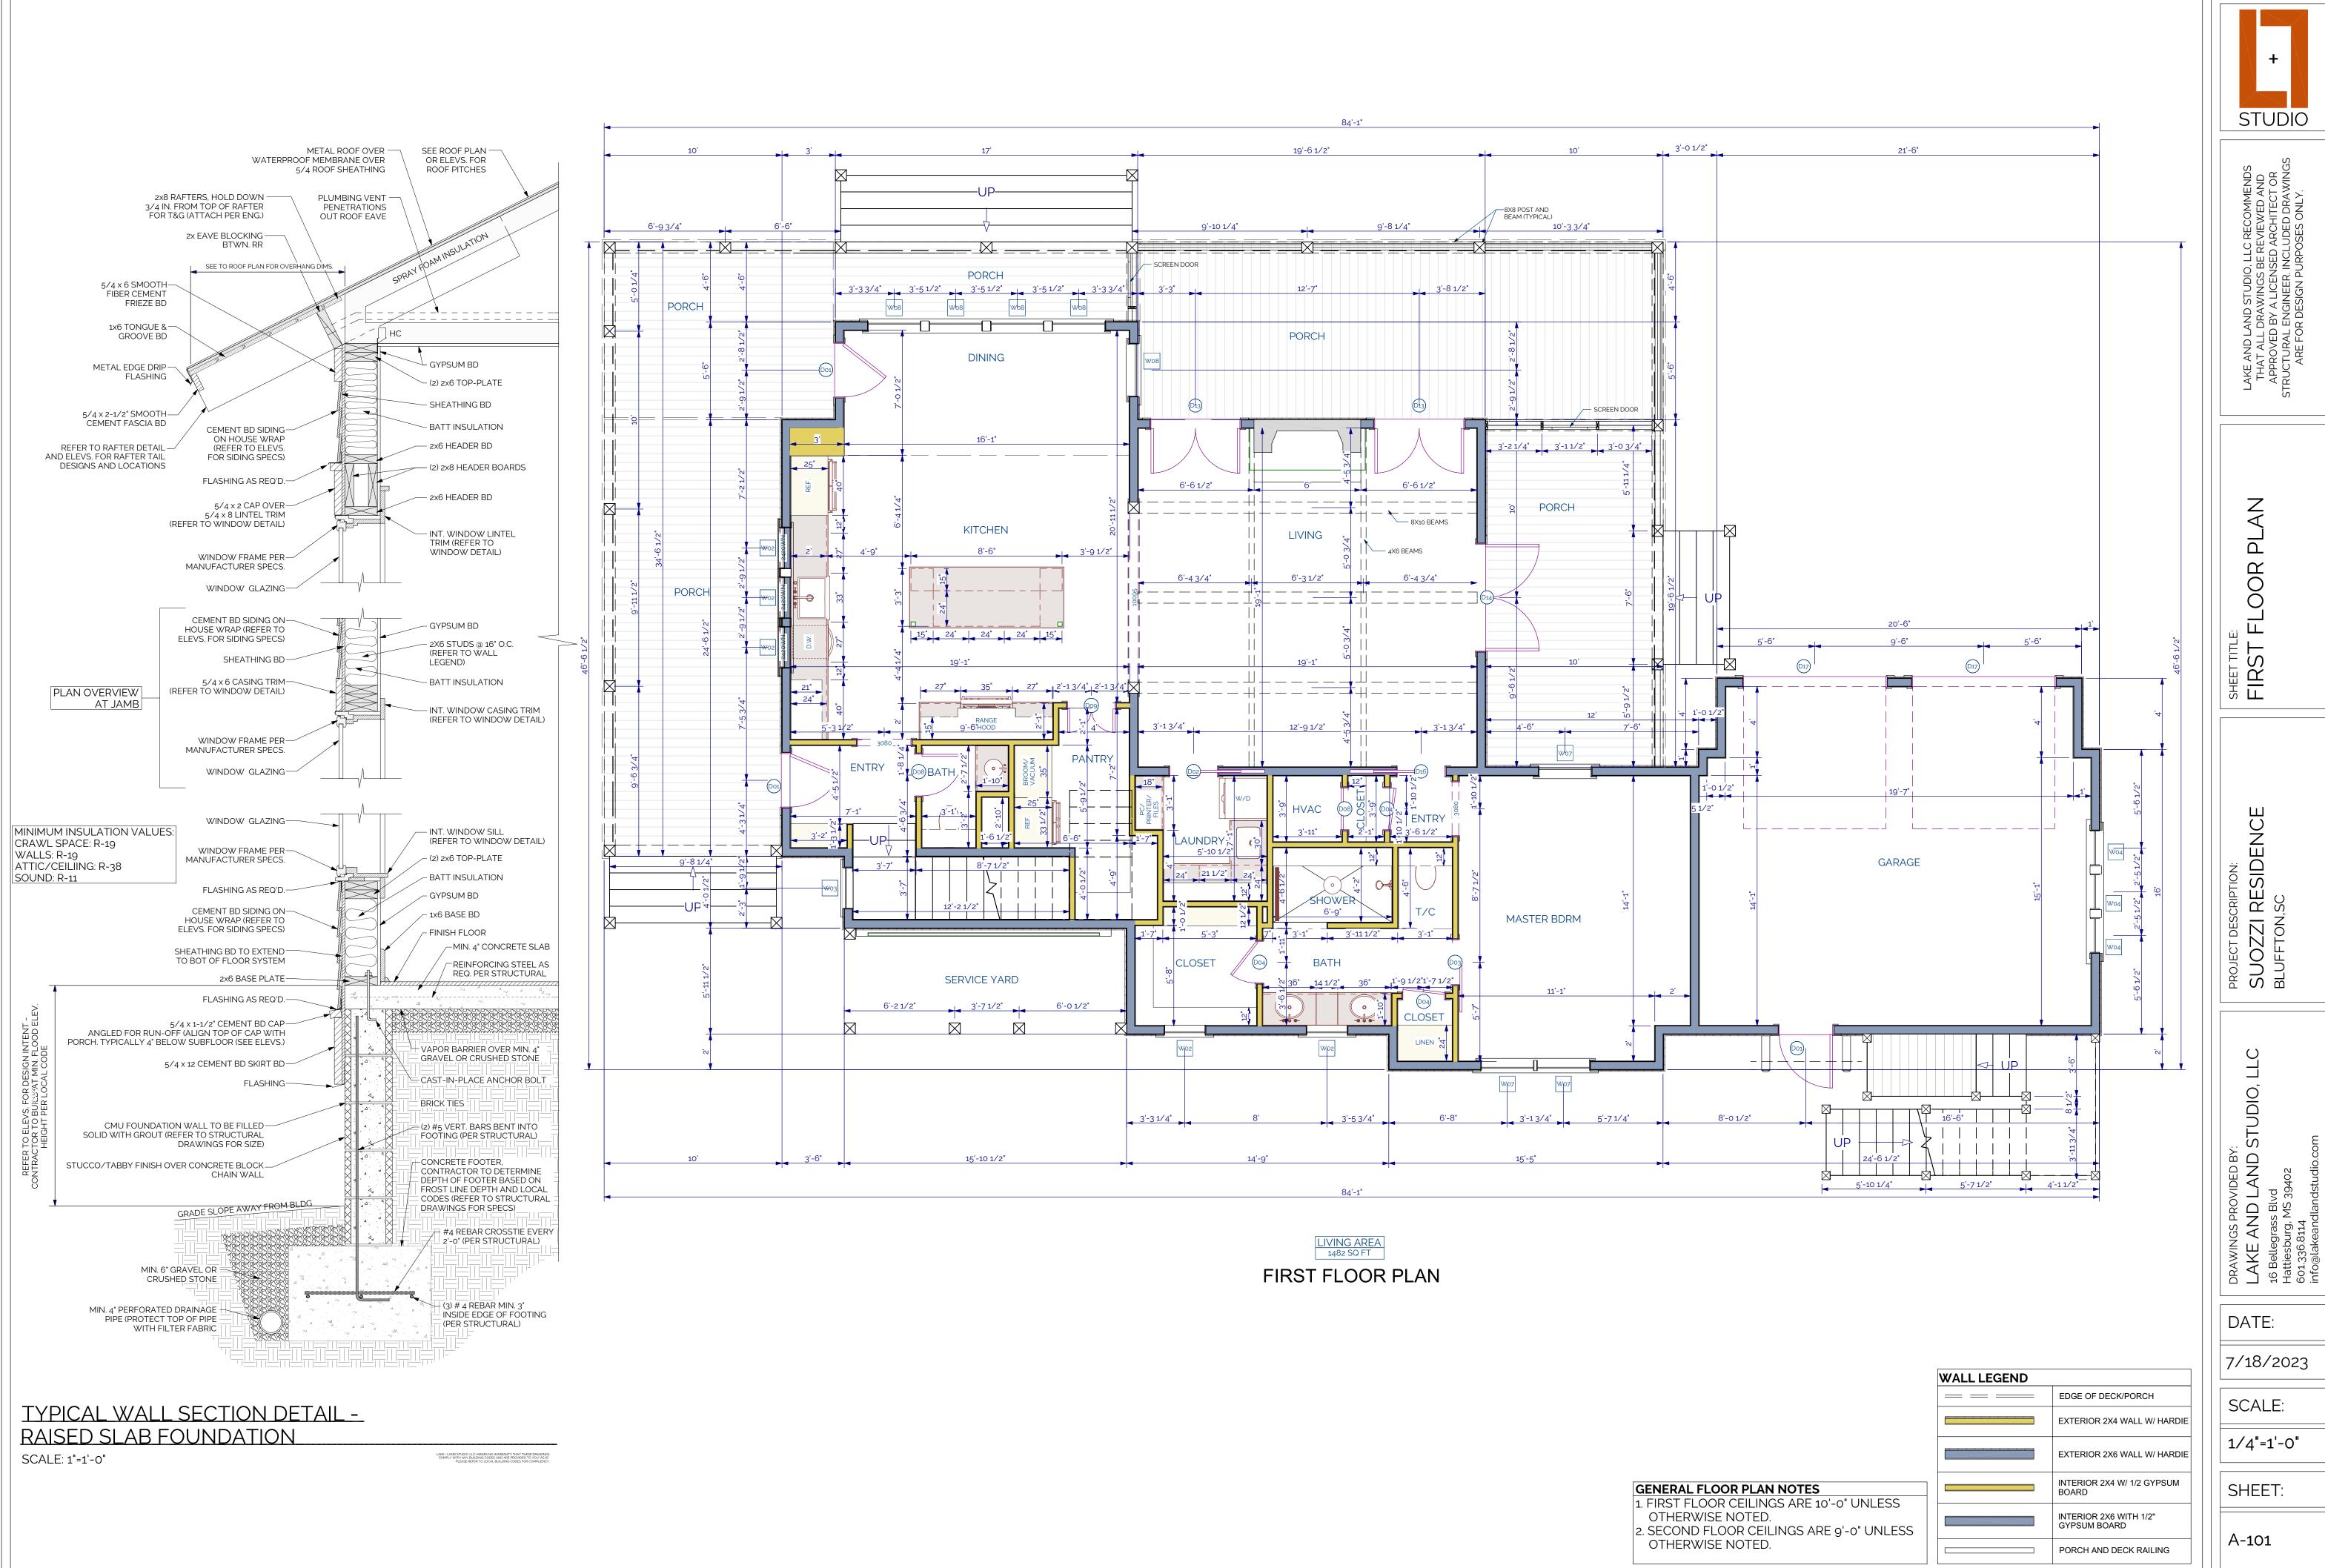




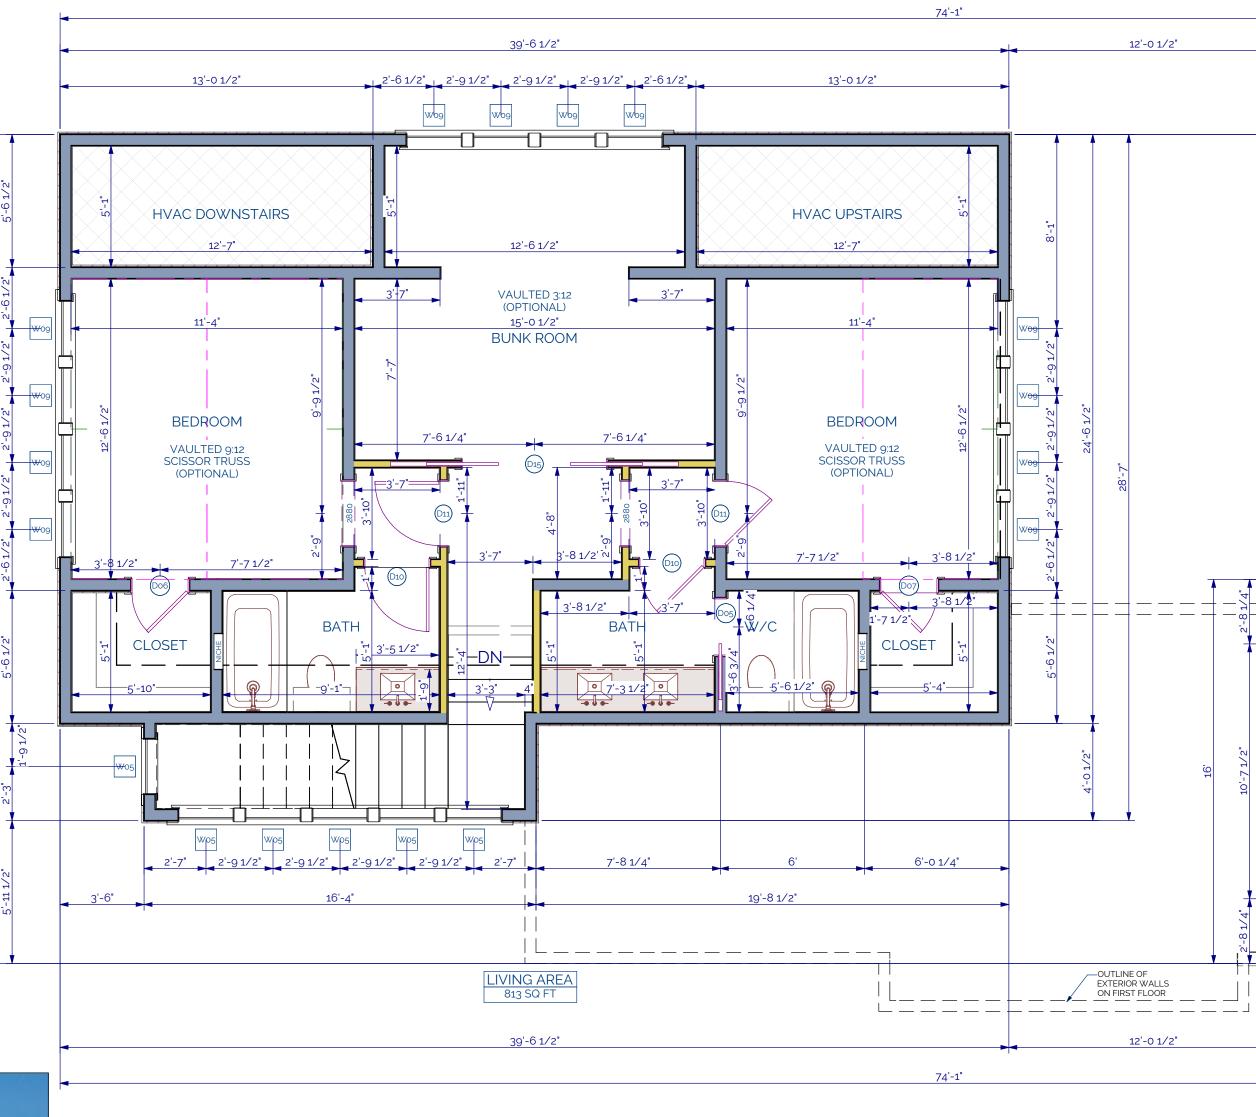



SECOND FLOOR PLAN

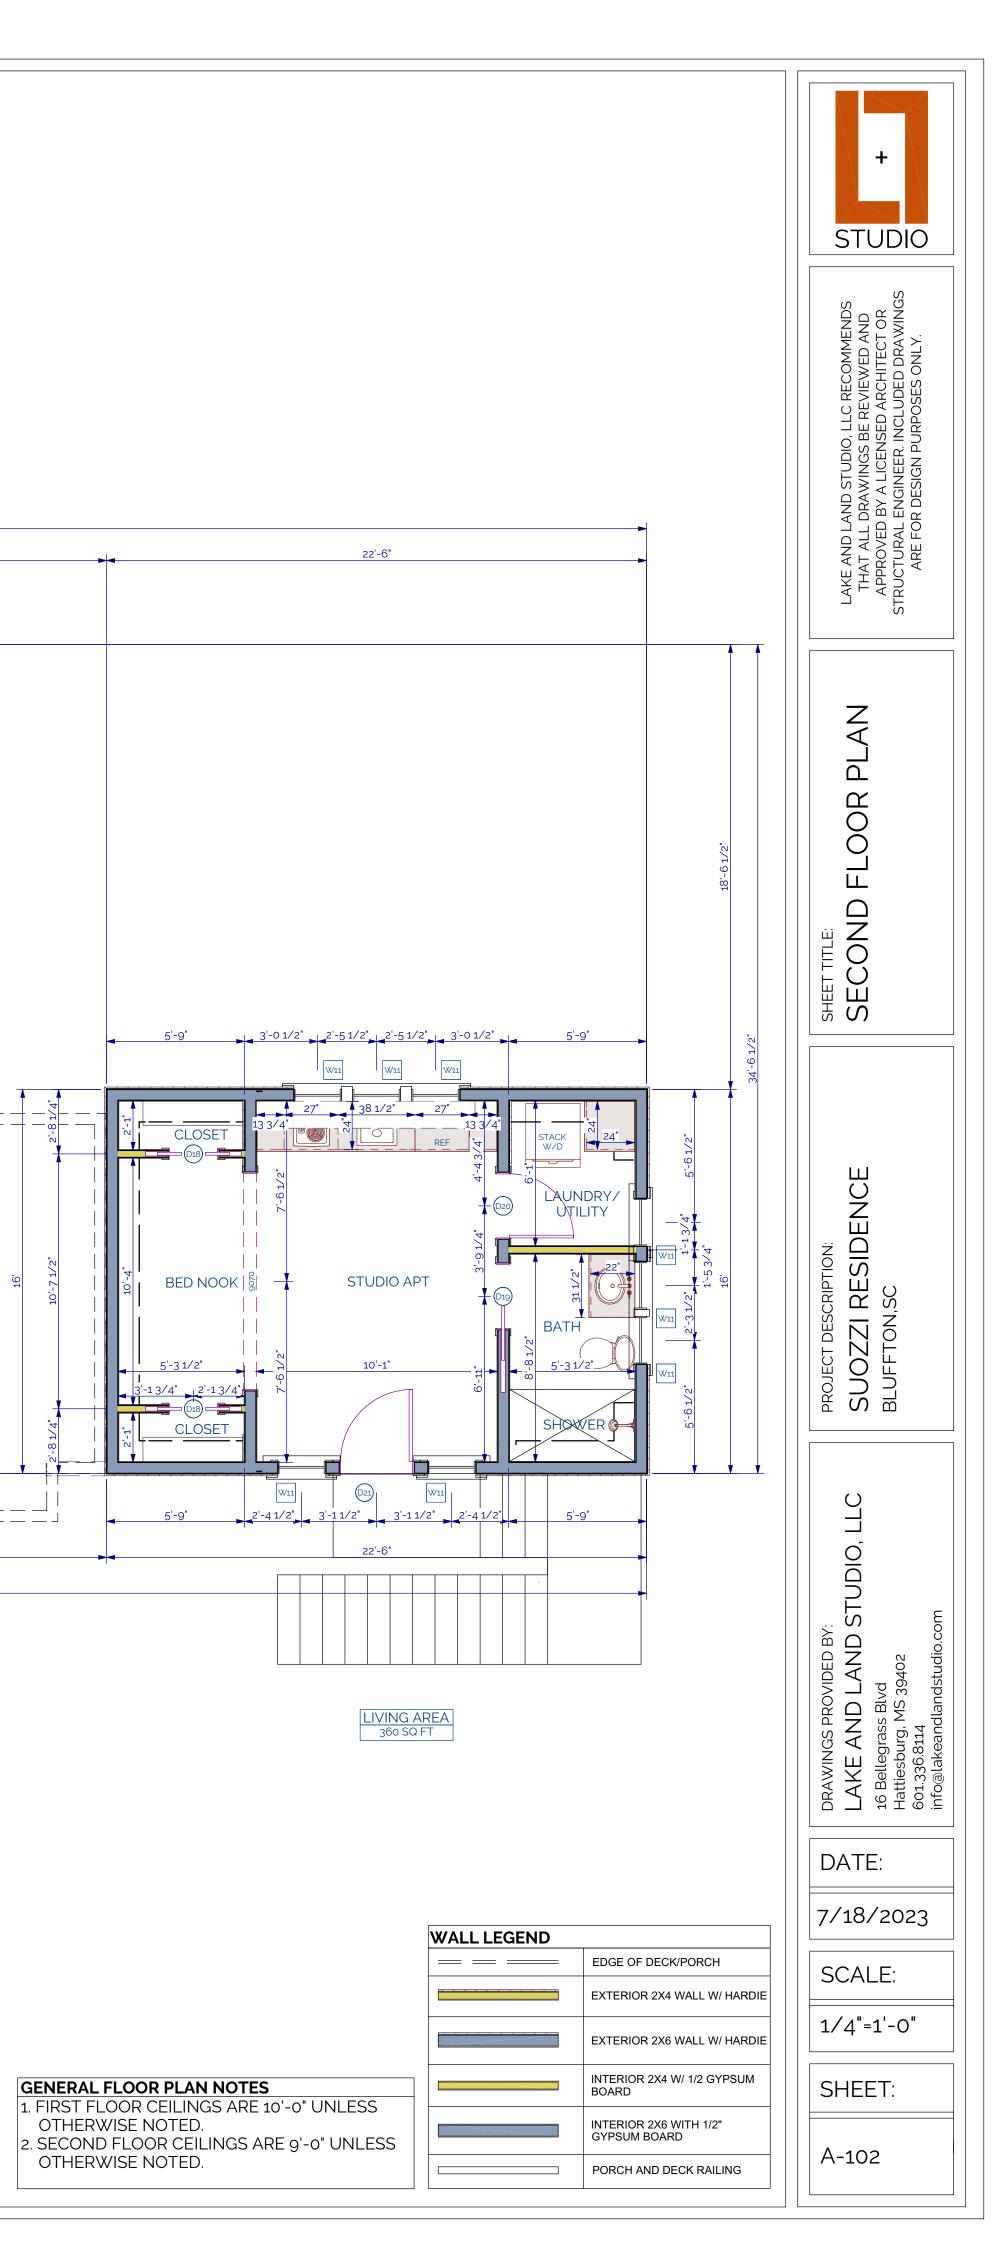

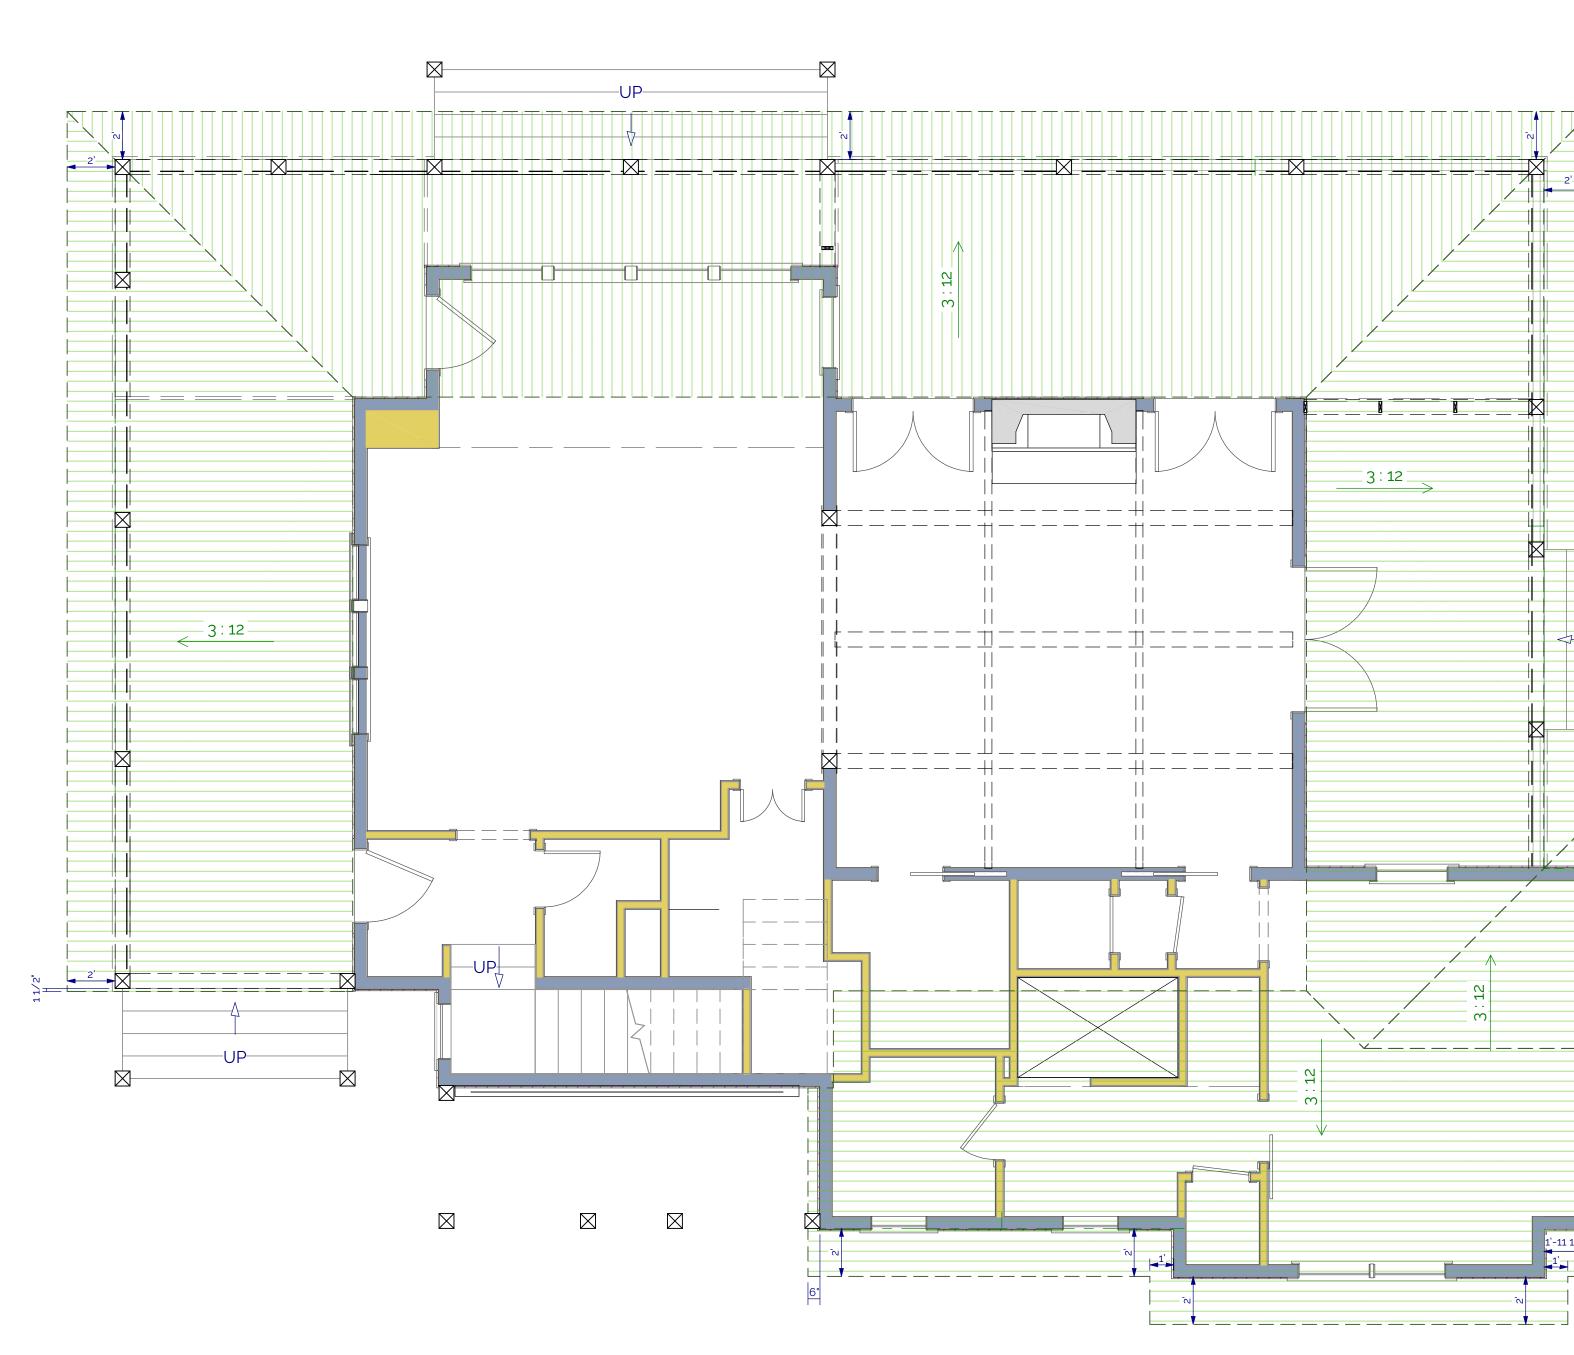



LOWER ROOF PLAN

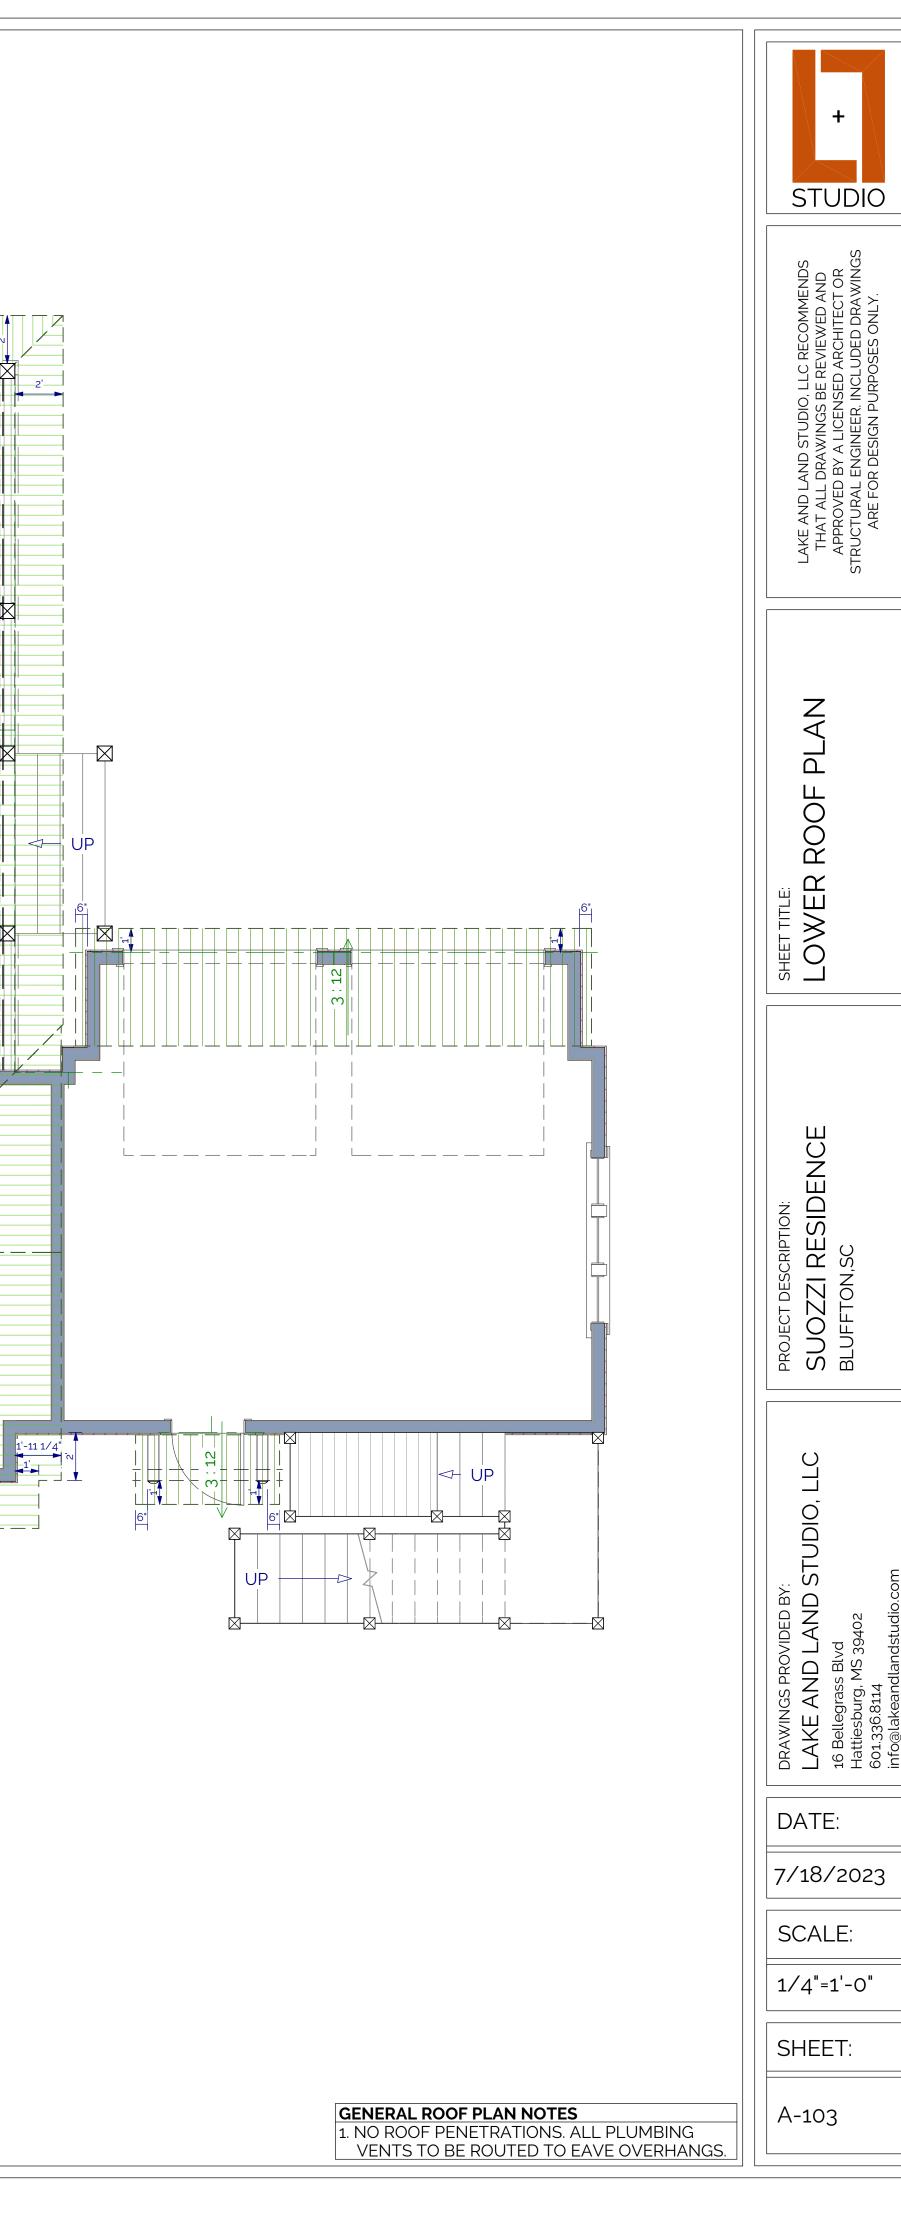

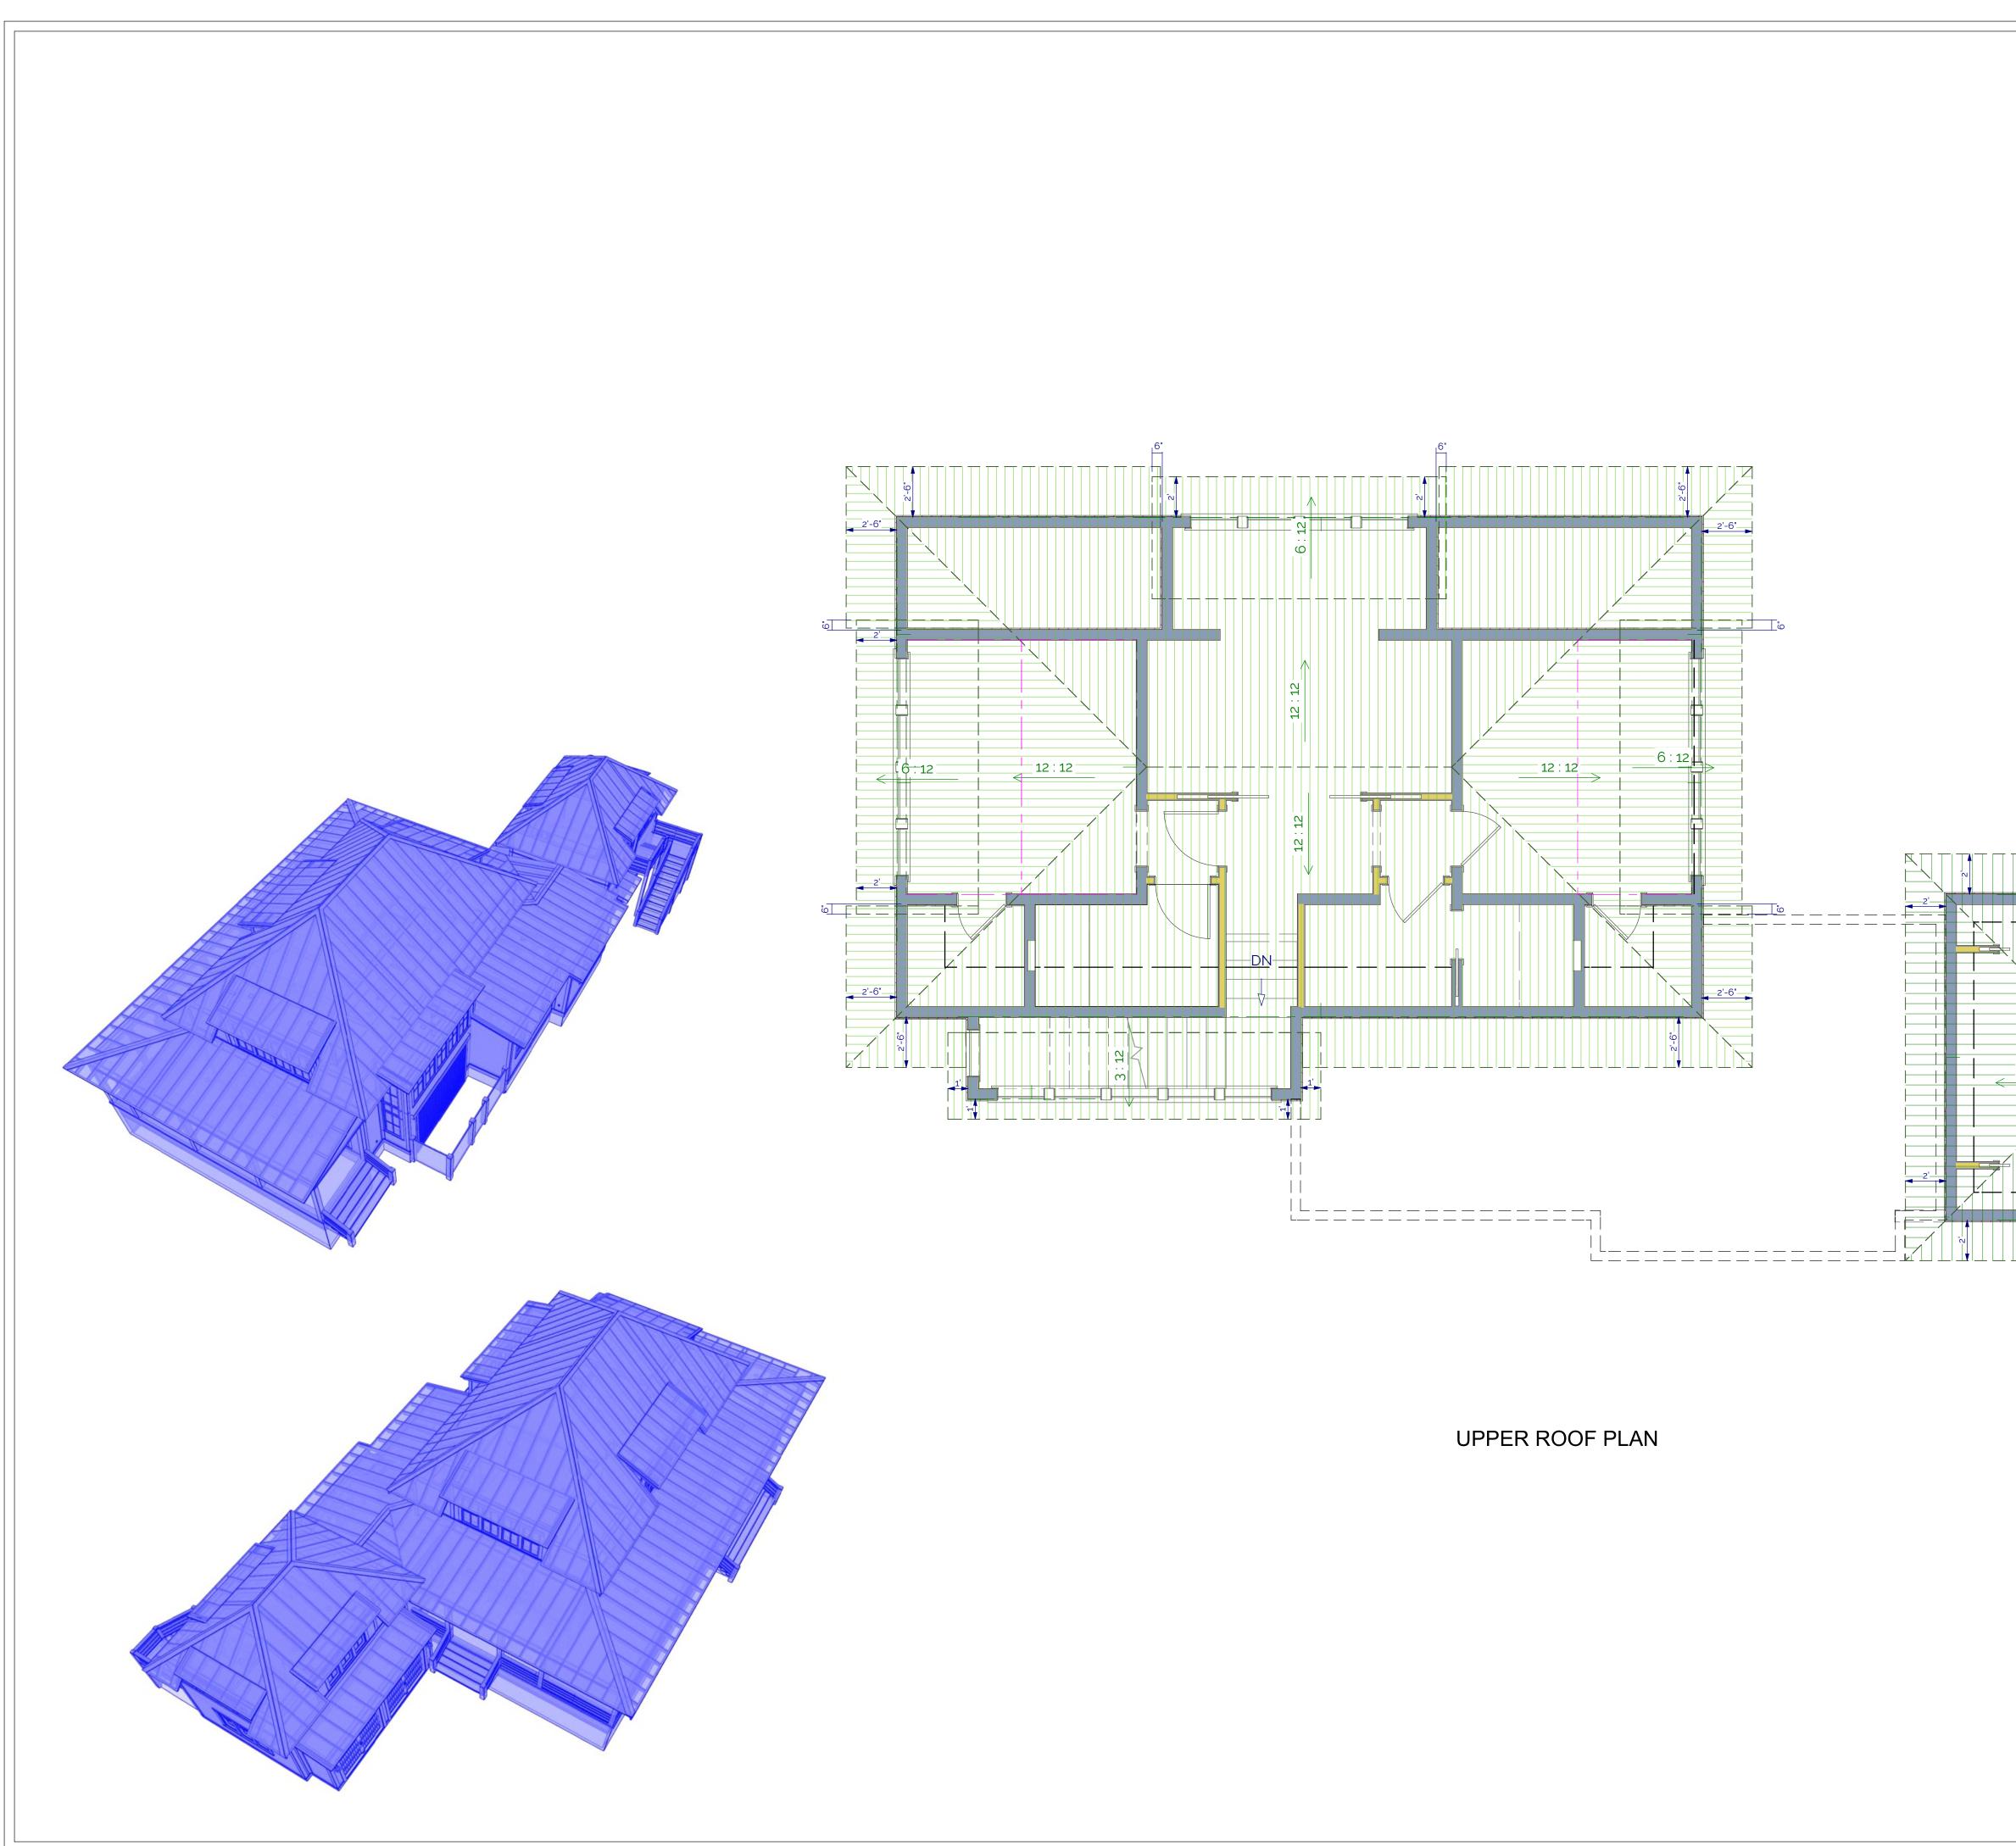


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	AND LAND STUDIO, LLC RECOMMENDS AT ALL DRAWINGS BE REVIEWED AND ROVED BY A LICENSED ARCHITECT OR TURAL ENGINEER. INCLUDED DRAWINGS ARE FOR DESIGN PURPOSES ONLY.
	LAKE AND LAND STUDIO, LLC RECOMMENDS THAT ALL DRAWINGS BE REVIEWED AND APPROVED BY A LICENSED ARCHITECT OR STRUCTURAL ENGINEER. INCLUDED DRAWINGS ARE FOR DESIGN PURPOSES ONLY.
SHEET TITLE:	UPPER ROOF PLAN
PROJECT DESCRIPTION:	SUOZZI RESIDENCE BLUFFTON,SC
DRAWINGS PROVIDED BY:	LAKE AND LAND STUDIO, LLC 16 Bellegrass Blvd Hattiesburg, MS 39402 601.336.8114 info@lakeandlandstudio.com
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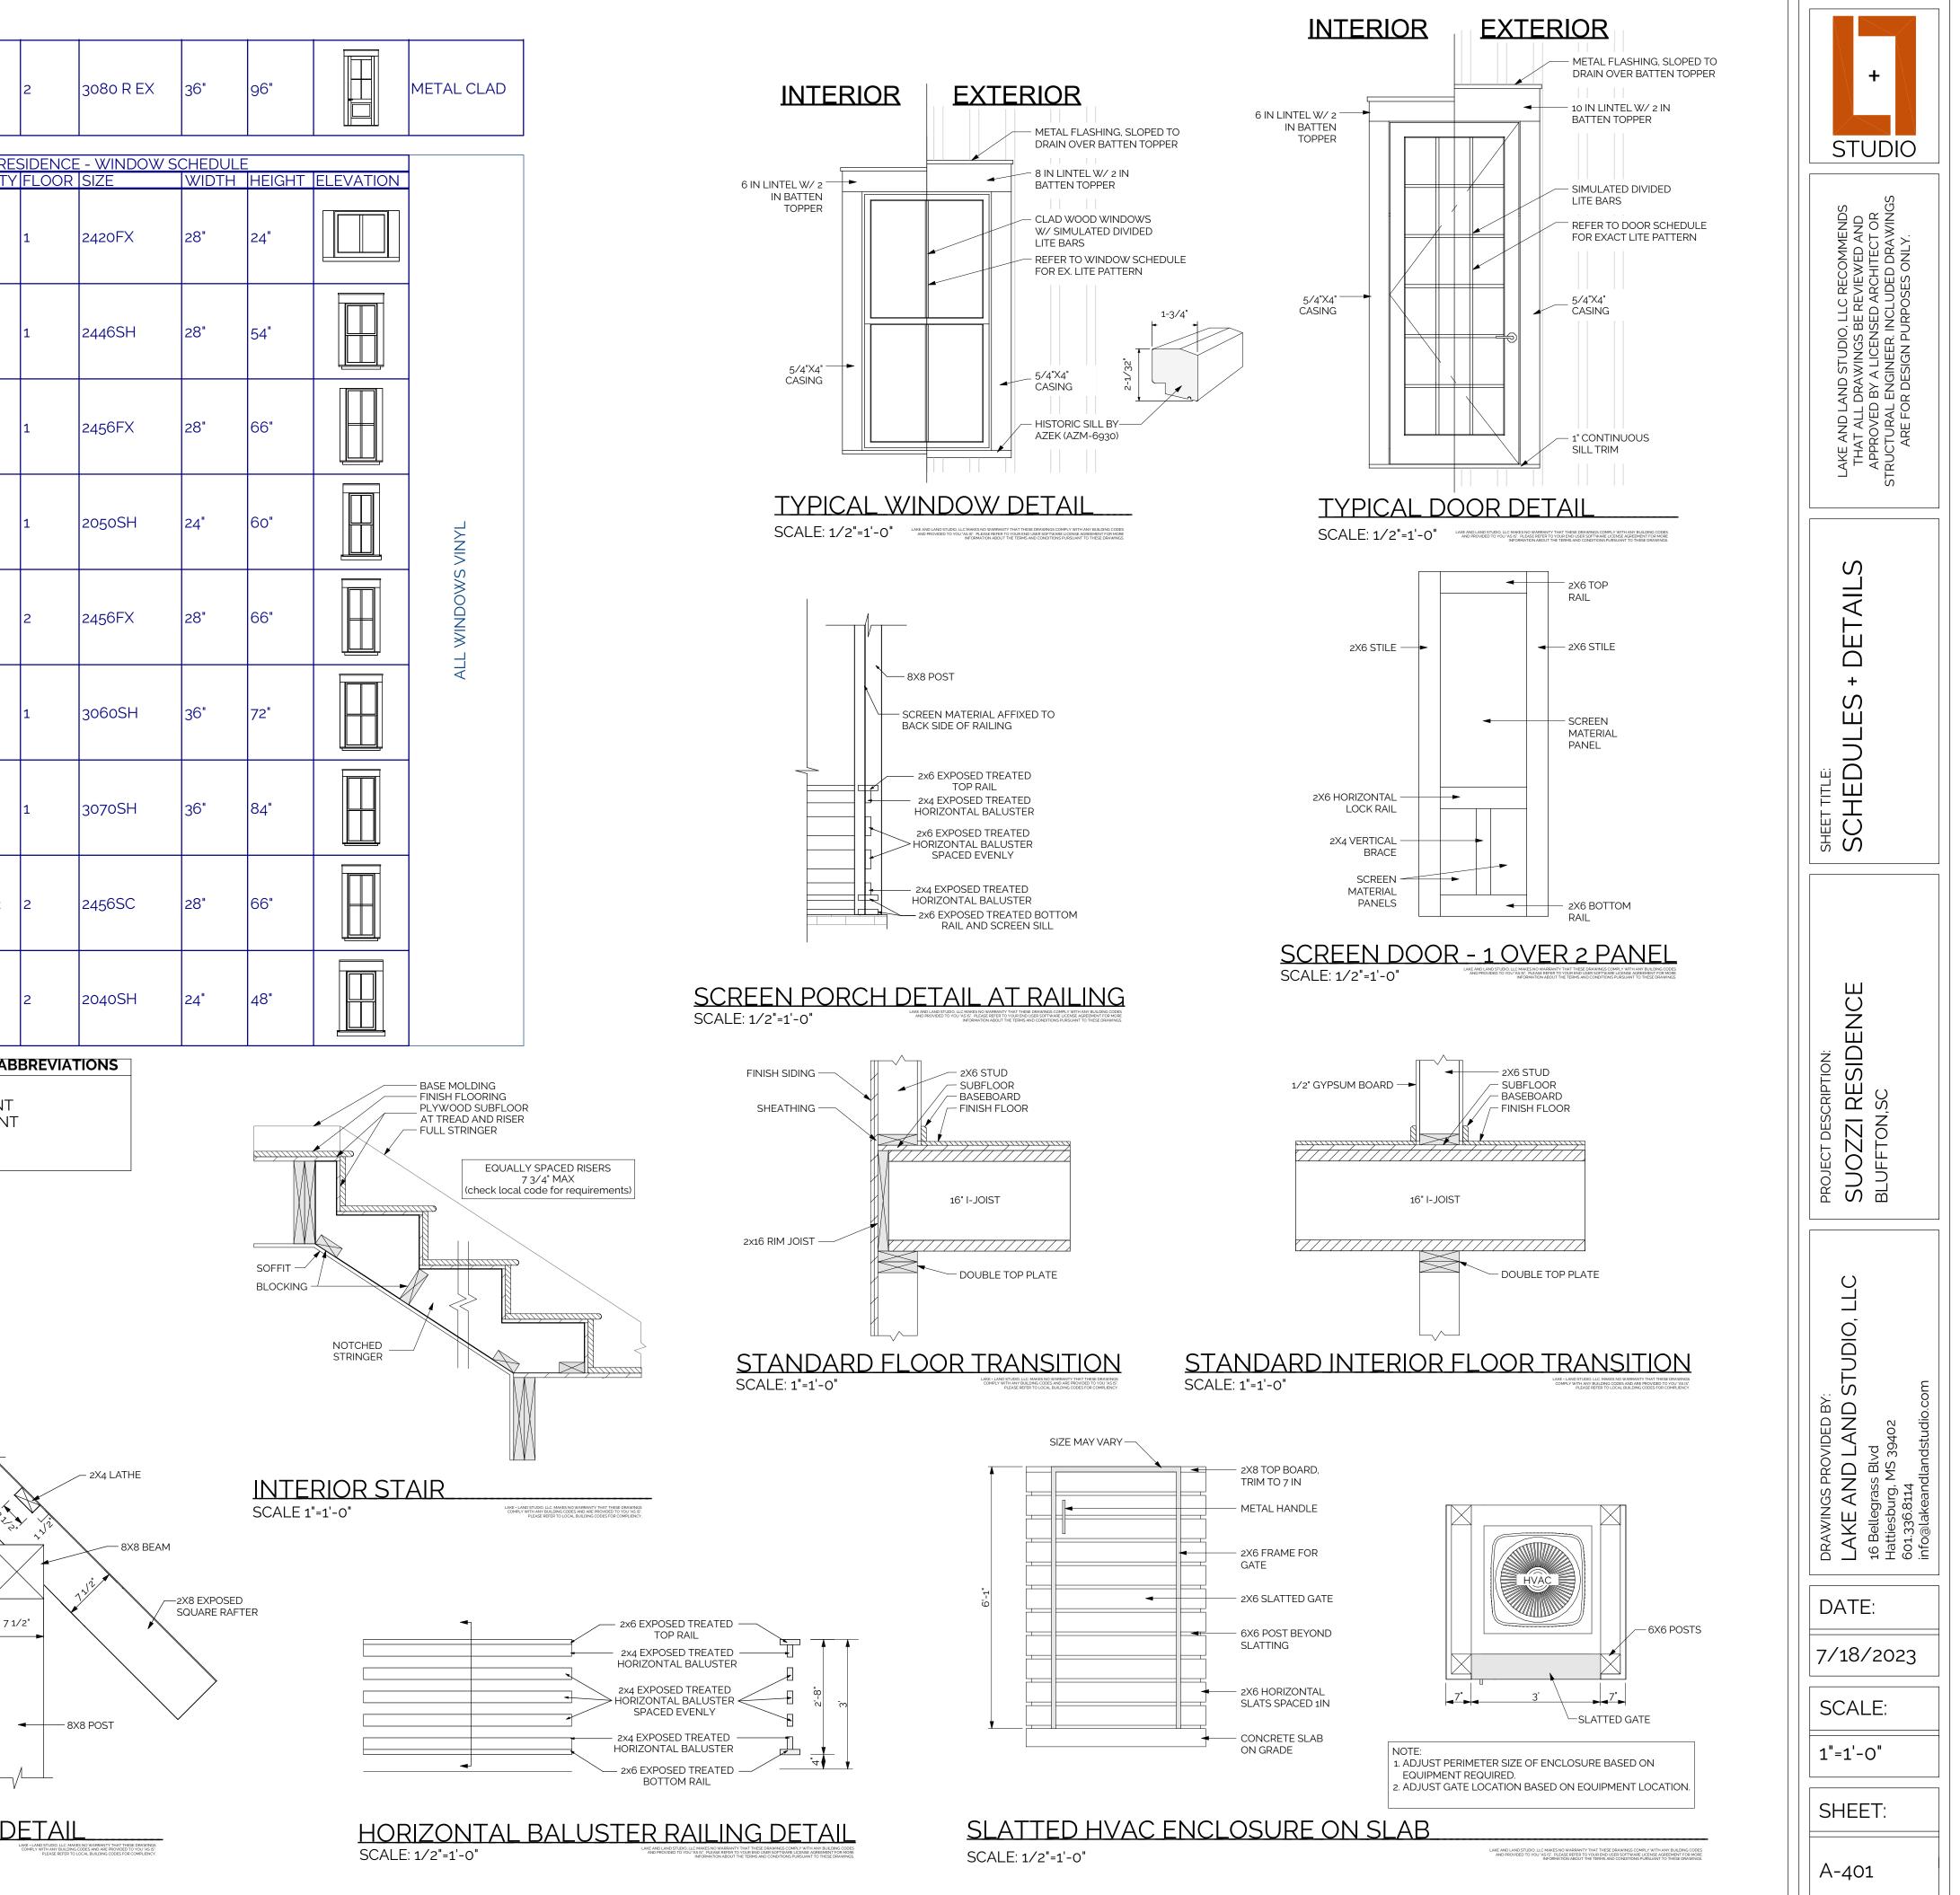


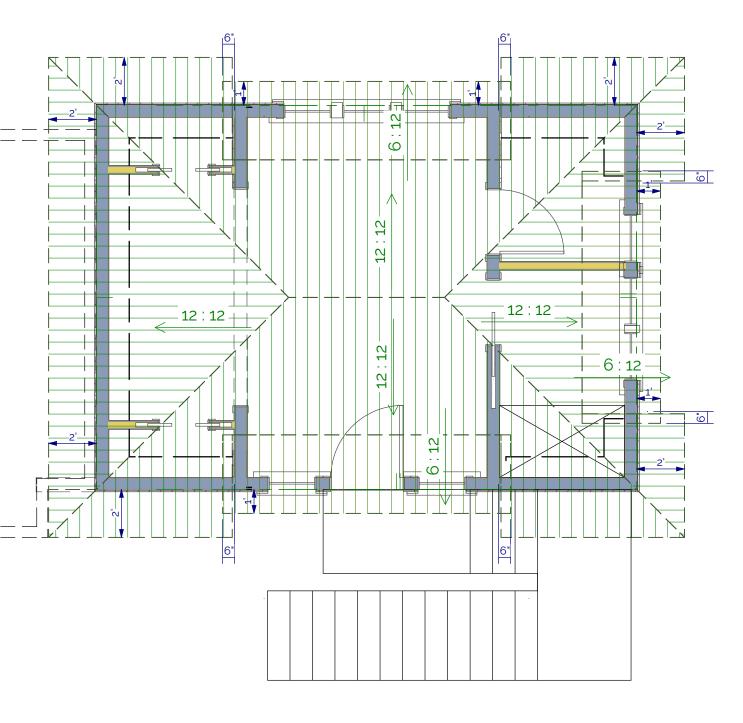


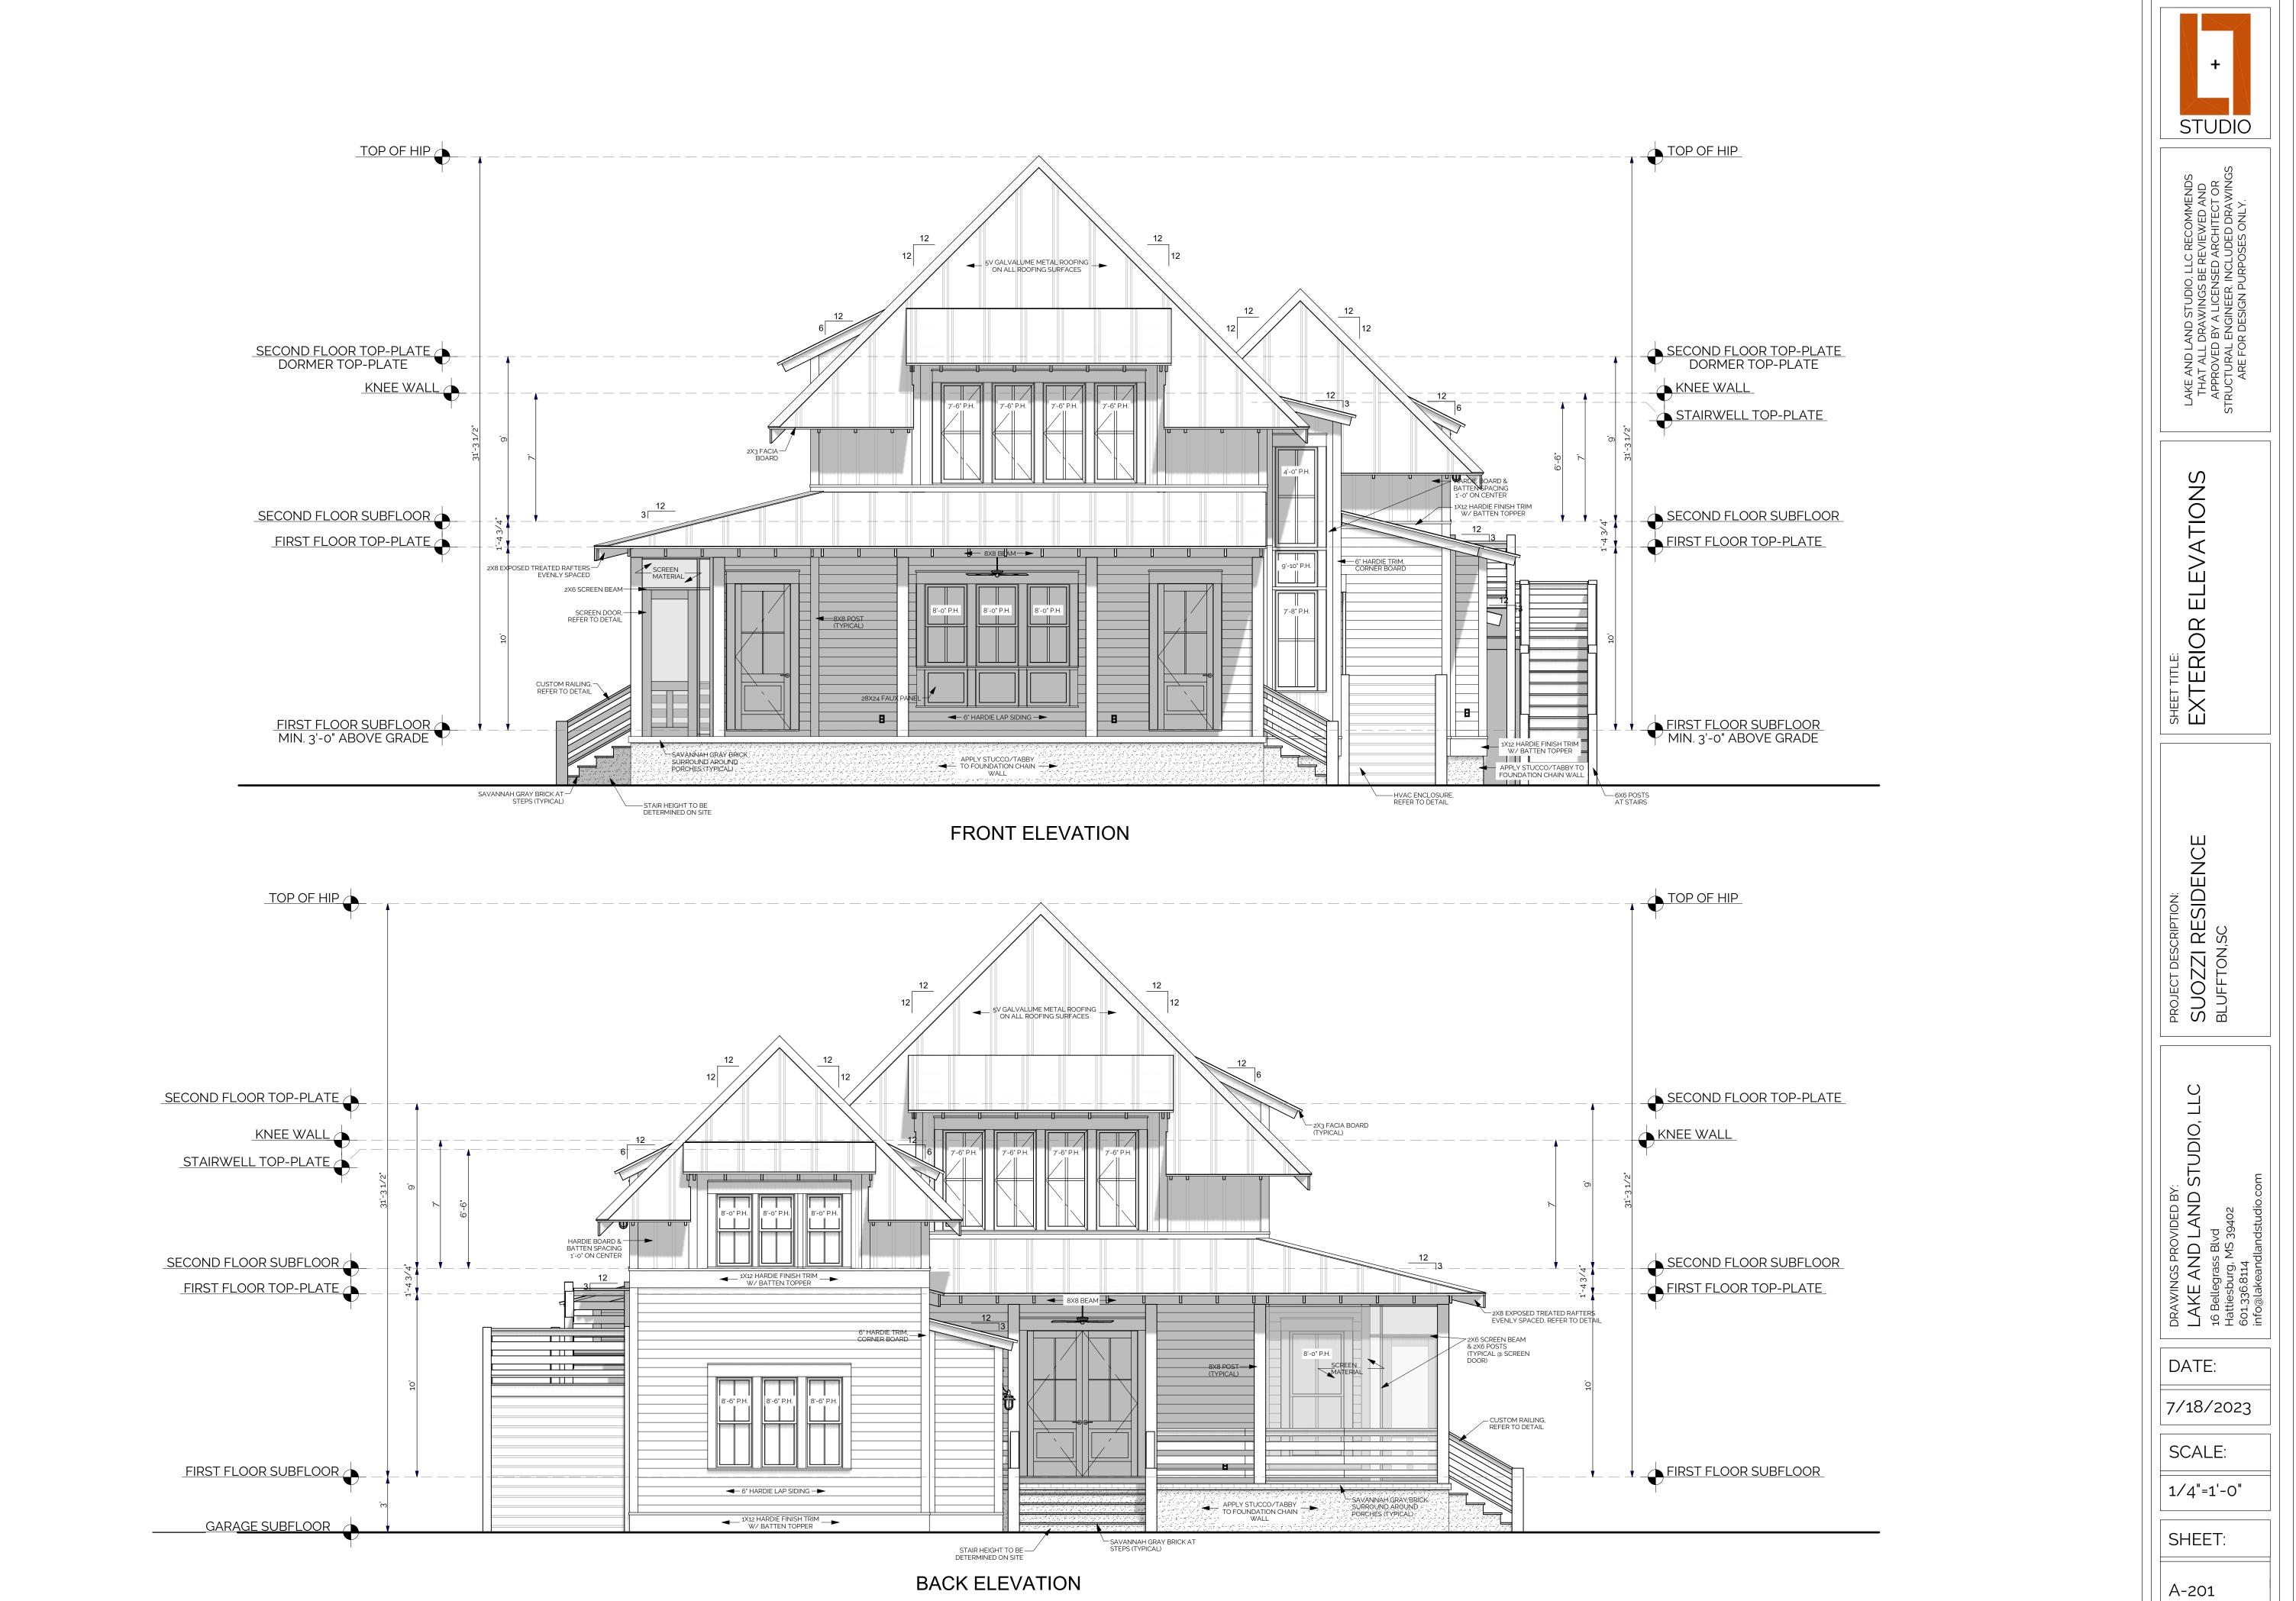BACK ELEVATION

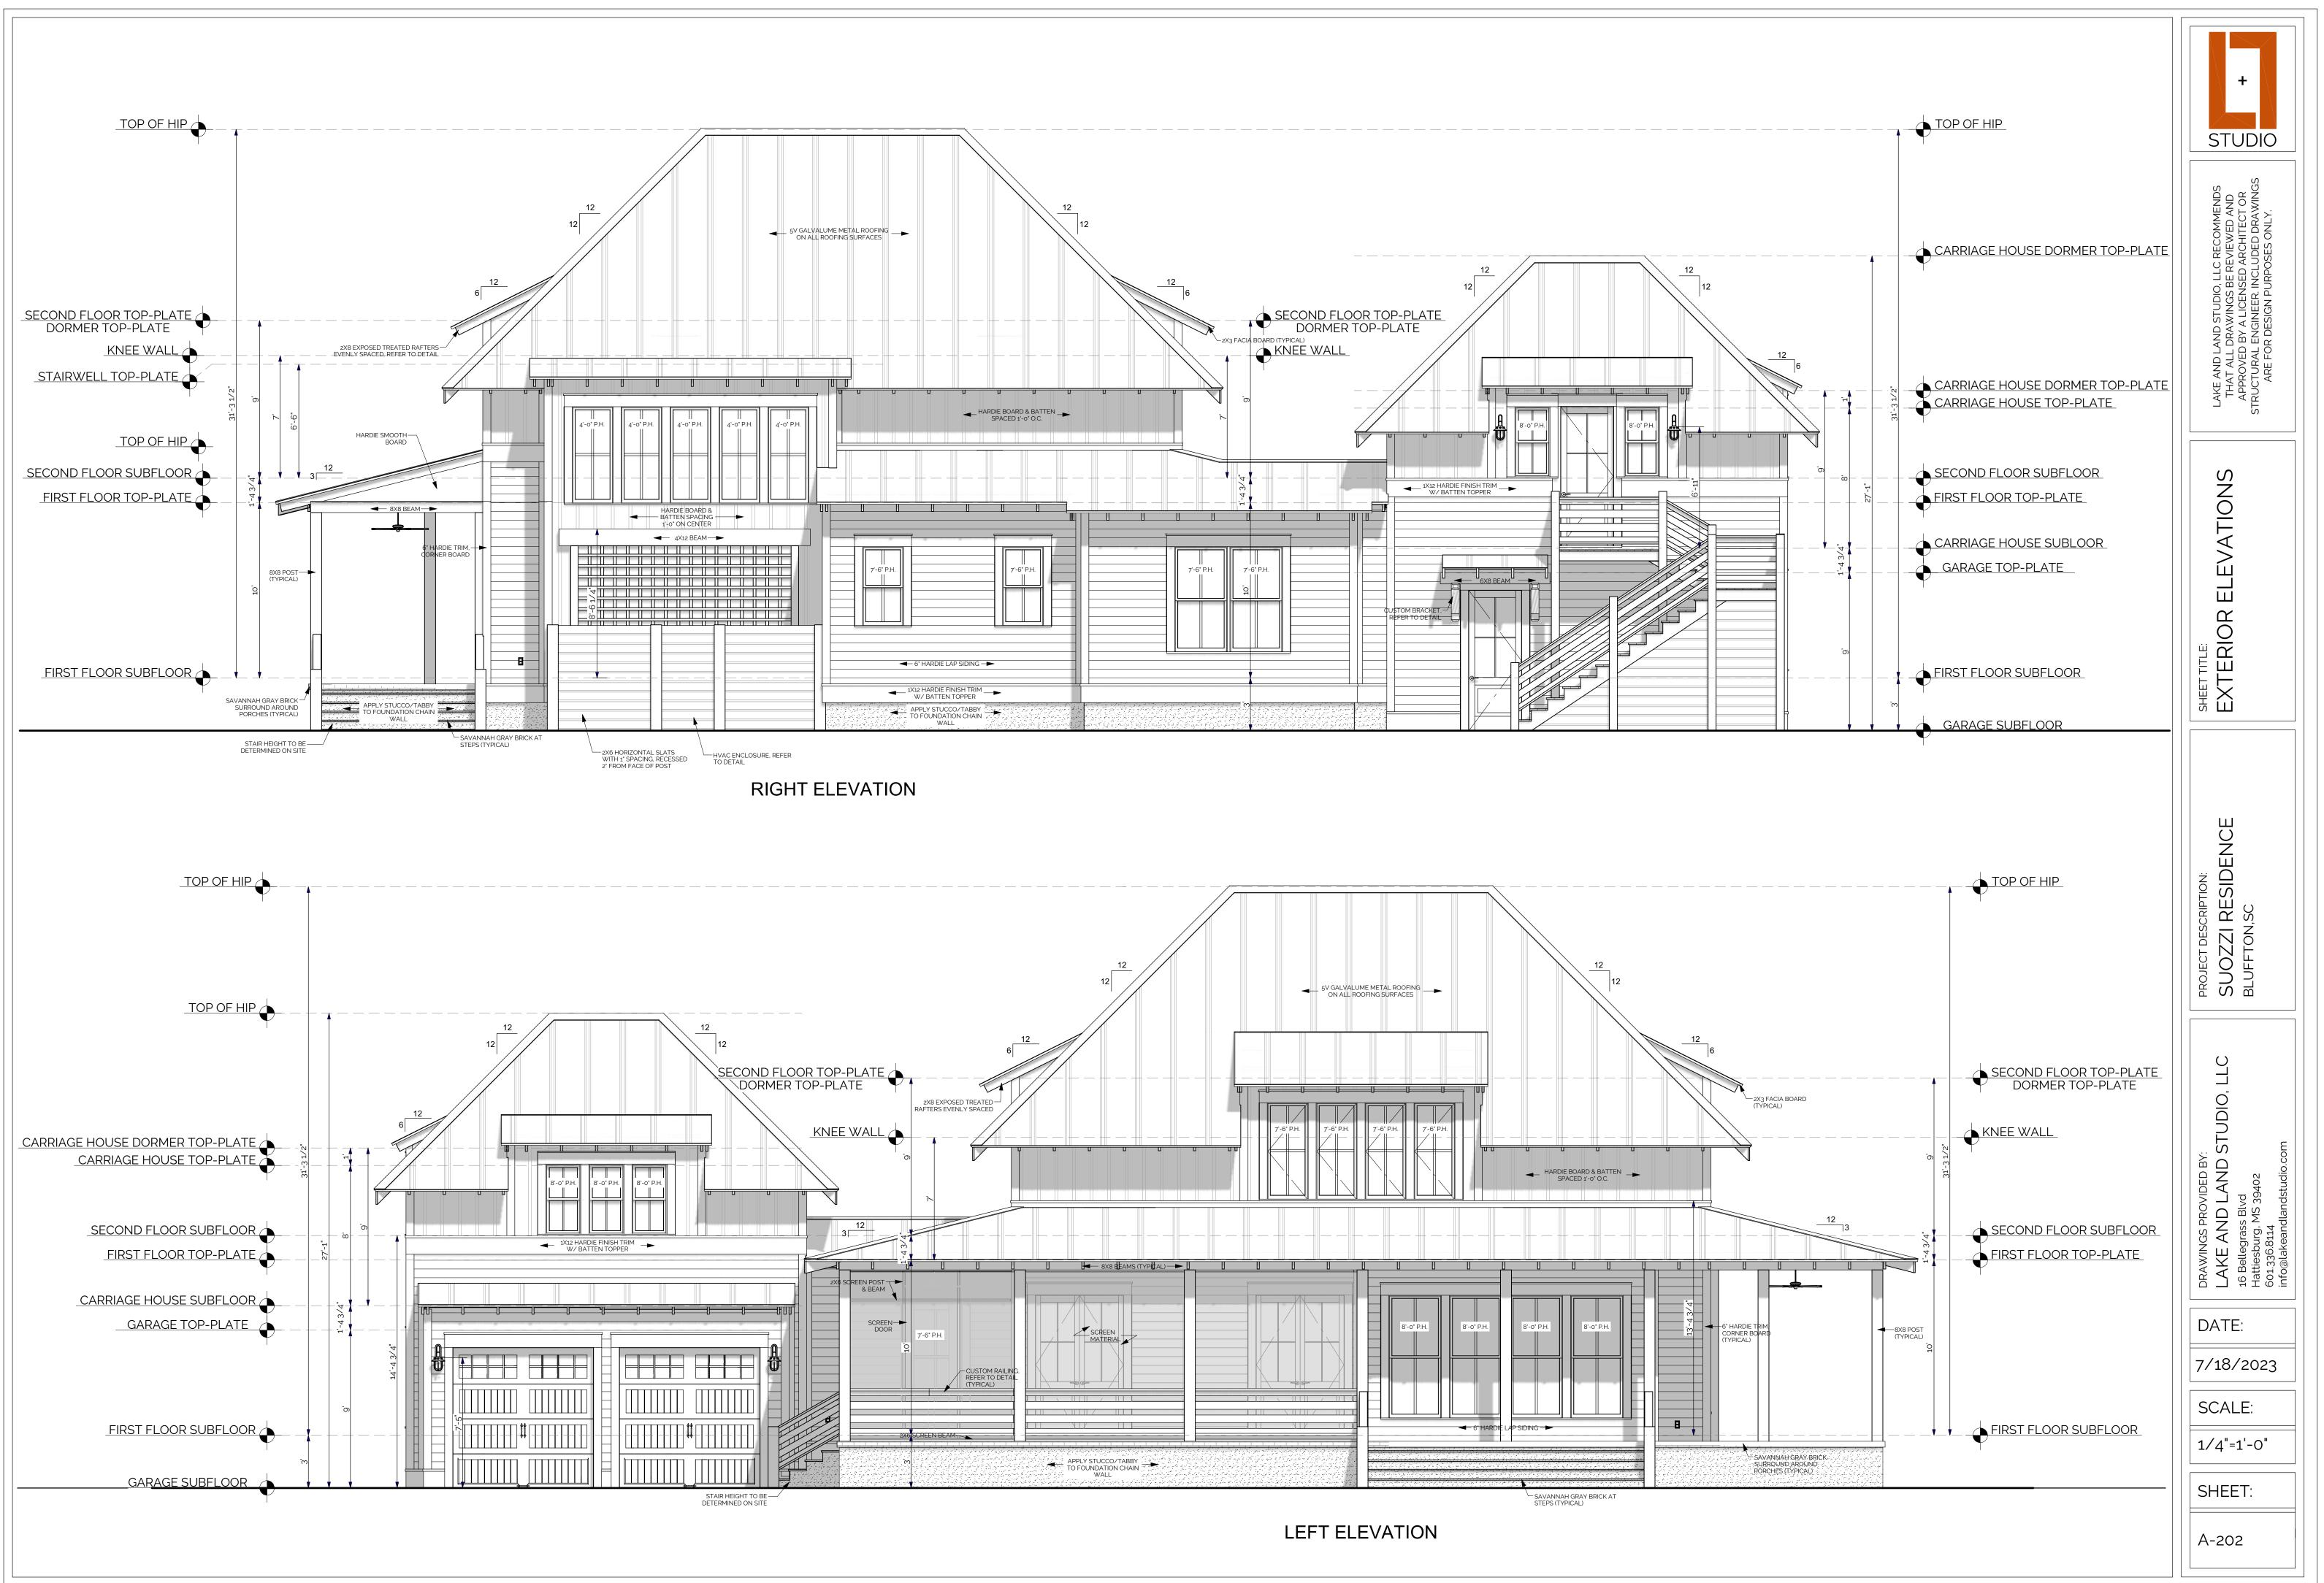


NUMBER	LABEL	QTY	RI FLOOR	ESIDENCE - DC SIZE	WIDTH		ELEVATION	COMMENTS	۰ ۱	i	
D01	3080	3	1	3080 L EX	36"	96"		METAL CLAD	D21	3080	1
Do2	2880	1	1	2880 L	32"	96"			NUMBER	LABEL	R
	2692								W01	2420FX	1
Do3	2680	1	1	2680 L	30"	96"			W02	2446SH	5
D04	2480	3	1	2480 R IN	28"	96"					
D05	2480	1	2	2480 R	28"	96"			Wo3	2456FX	1
D06	2480	1	2	2480 L IN	28"	96"			W04	WUDH 3632	3
									W05	2456FX	6
D07	2480	1	2	2480 R IN	28"	96"			W07	3060SH	3
Do8	2480	2	1	2480 L IN	28"	96"					
Dog	2880	1	1	2880 L/R IN	32"	96"			W08	3070SH	5
D10	2880	2	2	2880 L IN	32"	96"			Wo9	2456SC	12
D11	2882	2	2			06"			W11	WUDH 3632	8
D11	2880	2	2	2880 R IN	32"	96"			GENERAL		
D13	5080	2	1	5080 L/R EX	60"	96"		MAHOGANY	DC- DOUE	ILE CASEM BLE CASEI	MEN-
D14	6080	1	1	6080 L/R EX	72"	96"		MAHOGANY			
D15	6080	1	2	6080 L/R	72"	96"					
D16	2880	1	1	2880 R	32"	96"				/	
D17	8080	2	1	8080	96"	96"		CLOPAY			- N
D18	2070	2	2	2070 L/R	24"	84"				71/2"	
D19	2870	1	2	2870 L	32"	84"					
D20	2870	1	2	2870 R IN	32"	84"					



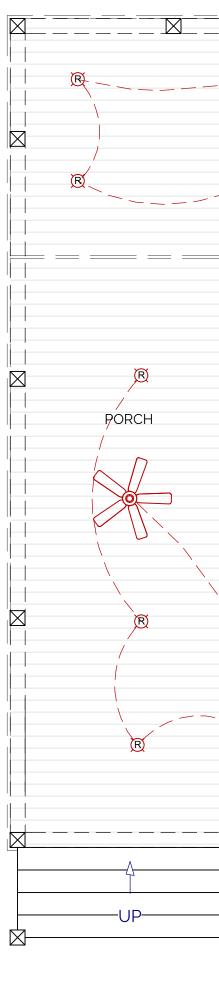

GENERAL MECHANICAL NOTES 1. CLOSELY COORDINATE WORK WITH ALL OTHER TRADES ESPECIALLY CONCERNING ENGINEERED FLOOR SYSTEMS. 2. DESIGN AND SPECIFICATION OF MECHANICAL SYSTEM TO BE DETERMINED BY BUILDER OR LOCAL ENGINEER. 3. BUILDER TO FURNISH ALL DUCTWORK, CONTROL WIRING, PIPING, FITTINGS, ACCESSORIES, ECT. FOR COMPLETE INSTALLATION.

ATTACHMENT 3

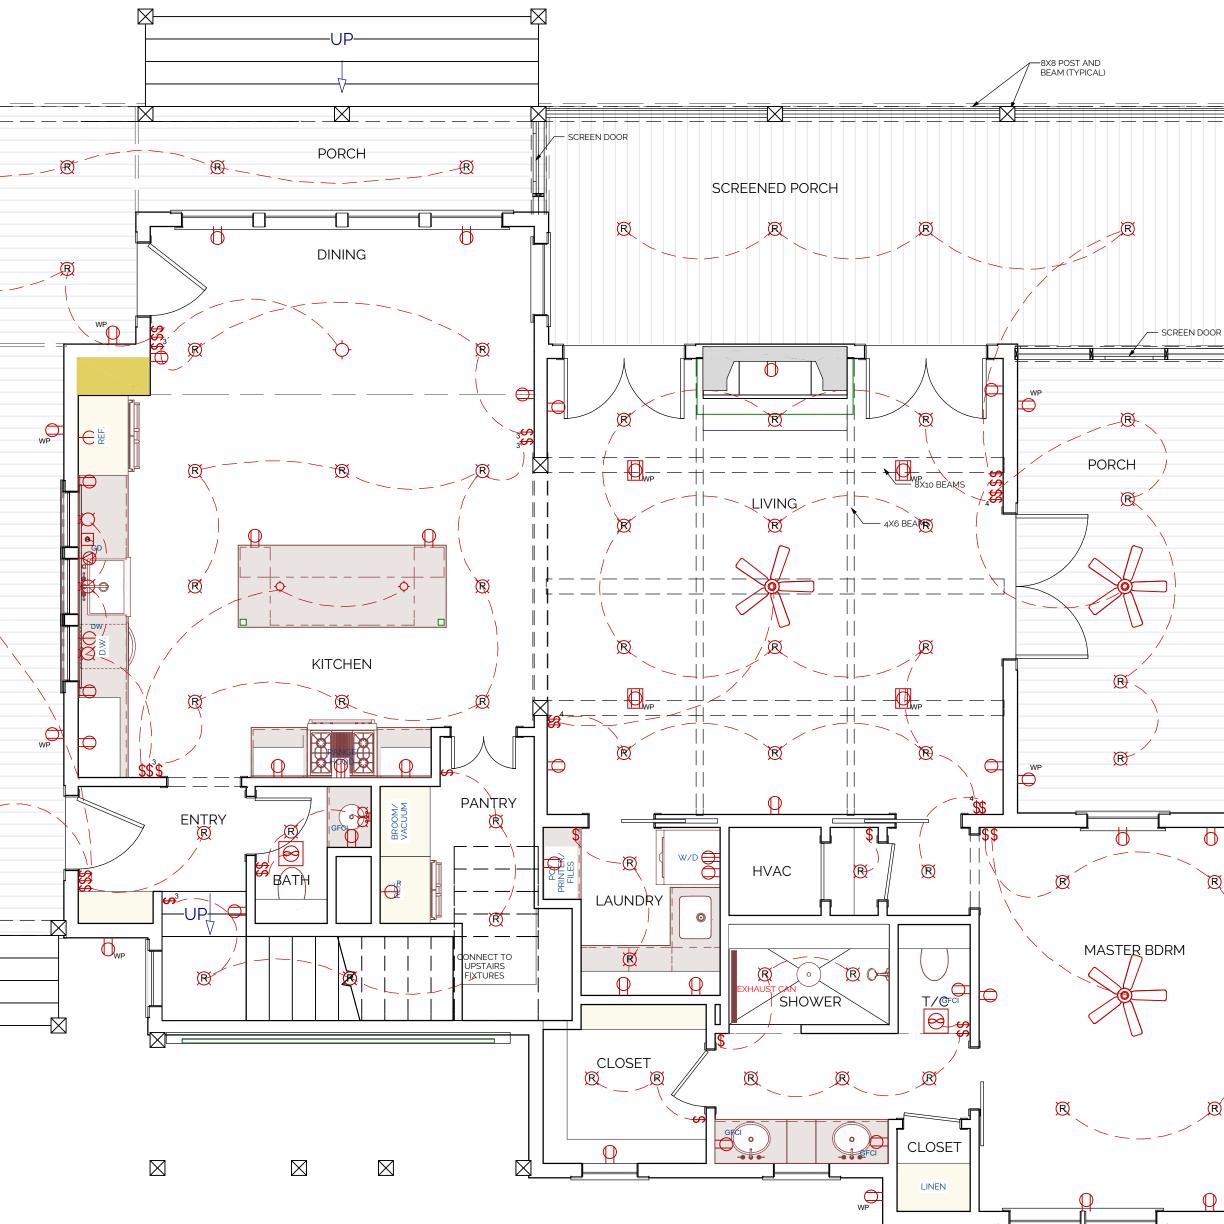

FIRST FLOOR ELECTRICAL PLAN

GENERAL ELECTRICAL NOTES

REQUIREMENTS.

EXTERIOR APPLICATIONS.

CONTRACTOR AND ELECTRICAN RESPONSIBLE TO COORDINATE APPROPRIATE AMPACITY REQUIRED AS NEEDED. AREAS IN NON-LIT AREAS REQUIRE ONE OUTLET AND ONE LIGHT. ALL OUTLETS EXPOSED TO WEATHER SHALL HAVE WEATHERPROOF GFCI AS REQUIRED BY CODE.


6. ALL SERVICE REQUIREMENTS MUST BE COORDINATED WITH LOCAL POWER COMPANY INCLUDING LOCATION AND TYPES OF TRANSFORMERS, DISCONNECTS AT EXTERIOR OF BUILDING, VOLTAGES, AMPACITIES AND ALL OTHER ELECTRICAL CONSTRUCTION DETAILS. FEEDERS SHOULD BE SIZED ACCORDING TO NEC REQUIREMENTS.

7. ALL CONCEALED CABLES TO BE RUN IN FLOORS, WALLS, OR CEILINGS AS NEEDED. 8. CONTRACTOR AND ELECTRICIAN TO PROVIDE BLOCKING FOR ALL ELECTRICAL FIXTURES AS NEEDED. 9. RECEPTACLES IN EXTERIOR WALLS MUST BE ISOLATED AND SEALED SOLIDLY.

10. SWITCHES SHOULD TYPICALLY BE MOUNTED 48" ABOVE FINISH FLOOR TO CENTER OF SWITCH. LOCATE SWITCHES ADJACENT TO DOOR CASINGS BUT NOT INTERSECTING DOOR CASINGS OR TRIM.

11. EXTERIOR SECURITY LIGHTING TO BE SELECTED AND LOCATED BY OWNER. ELECTRICIAN TO VERIFY SWITCHING LOCATION.


4. MAINTAIN CEILING HEIGHTS AND DUCT SPACES PROVIDED.

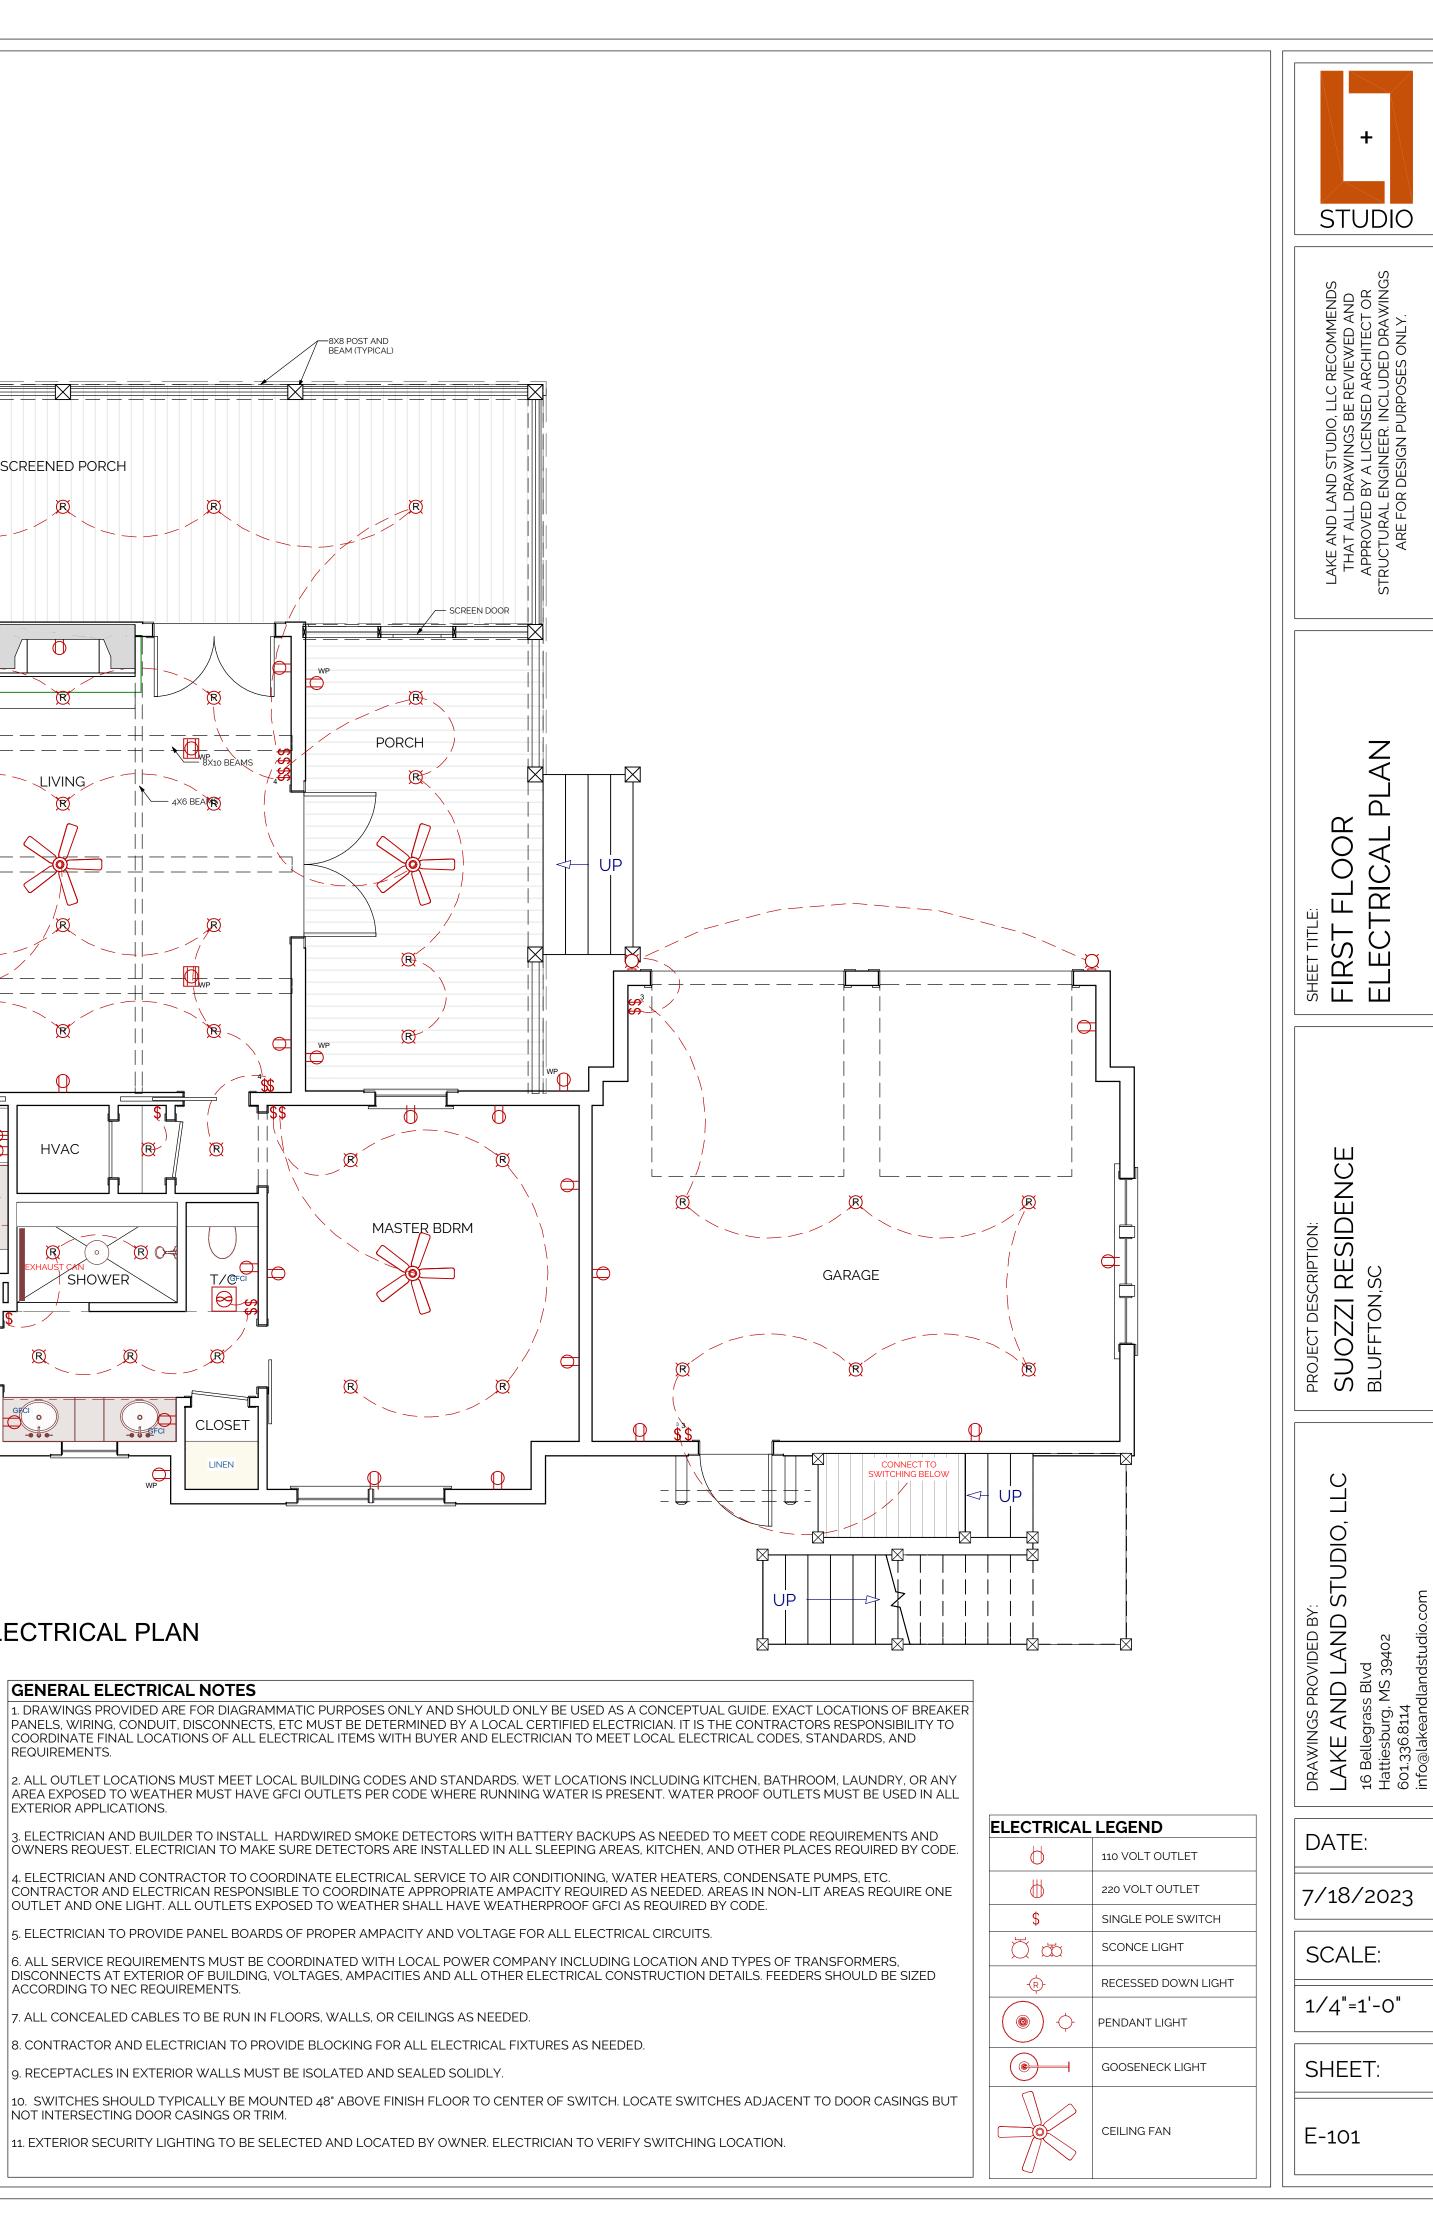

GENERAL MECHANICAL NOTES

4. MAINTAIN CEILING HEIGHTS AND DUCT SPACES PROVIDED.

ATTACHMENT 3

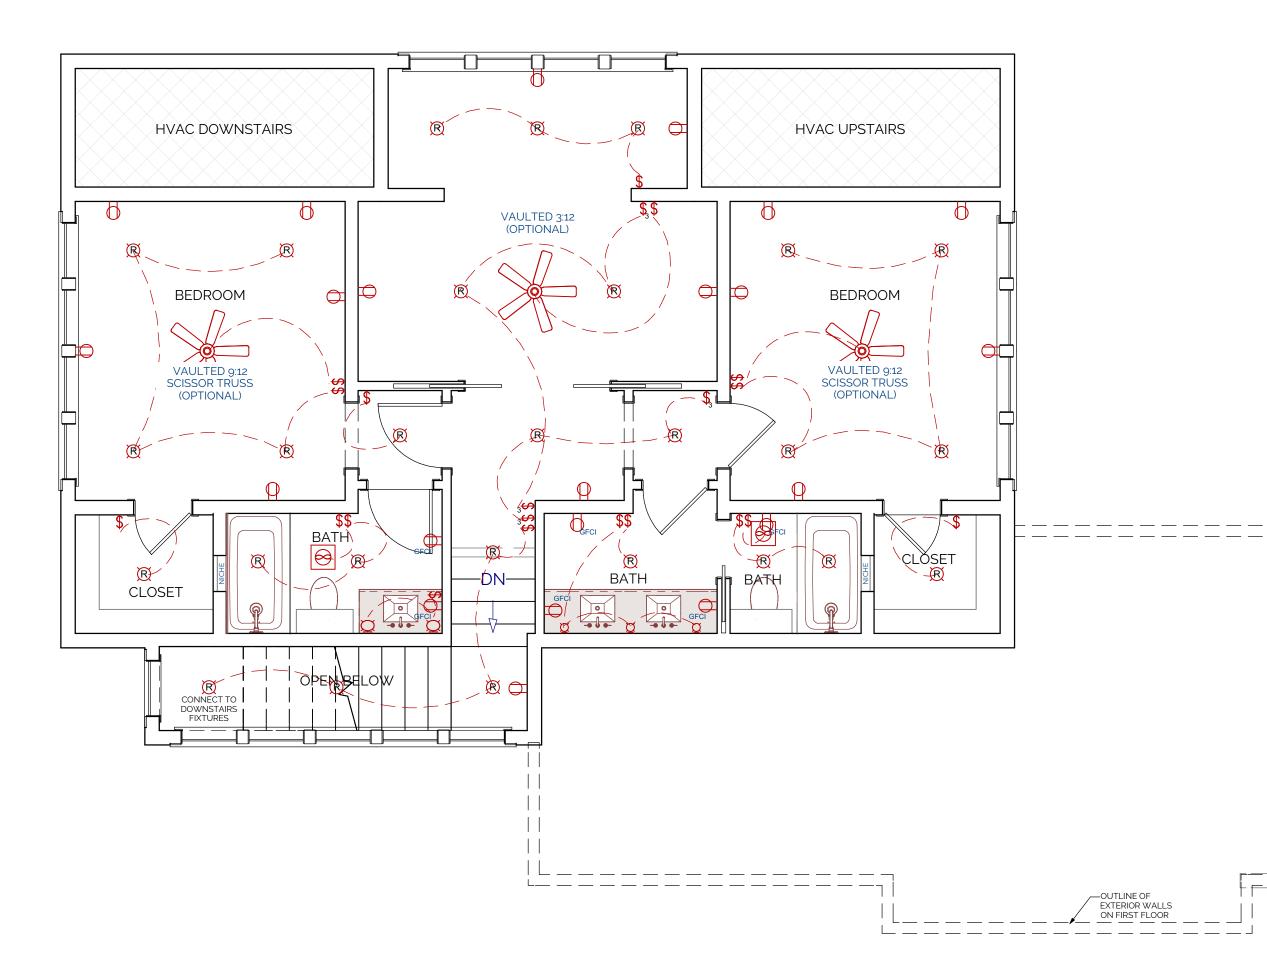

SECOND FLOOR ELECTRICAL PLAN

GENERAL ELECTRICAL NOTES

1. DRAWINGS PROVIDED ARE FOR DIAGRAMMATIC PURPOSES ONLY AND SHOULD ONLY BE USED AS A CONCEPTUAL GUIDE. EXACT LOCATIONS OF BREAKER PANELS, WIRING, CONDUIT, DISCONNECTS, ETC MUST BE DETERMINED BY A LOCAL CERTIFIED ELECTRICIAN. IT IS THE CONTRACTORS RESPONSIBILITY TO COORDINATE FINAL LOCATIONS OF ALL ELECTRICAL ITEMS WITH BUYER AND ELECTRICIAN TO MEET LOCAL ELECTRICAL CODES, STANDARDS, AND REQUIREMENTS.

2. ALL OUTLET LOCATIONS MUST MEET LOCAL BUILDING CODES AND STANDARDS. WET LOCATIONS INCLUDING KITCHEN, BATHROOM, LAUNDRY, OR ANY AREA EXPOSED TO WEATHER MUST HAVE GFCI OUTLETS PER CODE WHERE RUNNING WATER IS PRESENT. WATER PROOF OUTLETS MUST BE USED IN ALL EXTERIOR APPLICATIONS.

3. ELECTRICIAN AND BUILDER TO INSTALL HARDWIRED SMOKE DETECTORS WITH BATTERY BACKUPS AS NEEDED TO MEET CODE REQUIREMENTS AND OWNERS REQUEST. ELECTRICIAN TO MAKE SURE DETECTORS ARE INSTALLED IN ALL SLEEPING AREAS, KITCHEN, AND OTHER PLACES REQUIRED BY CODE.

4. ELECTRICIAN AND CONTRACTOR TO COORDINATE ELECTRICAL SERVICE TO AIR CONDITIONING, WATER HEATERS, CONDENSATE PUMPS, ETC. CONTRACTOR AND ELECTRICAN RESPONSIBLE TO COORDINATE APPROPRIATE AMPACITY REQUIRED AS NEEDED. AREAS IN NON-LIT AREAS REQUIRE ONE OUTLET AND ONE LIGHT. ALL OUTLETS EXPOSED TO WEATHER SHALL HAVE WEATHERPROOF GFCI AS REQUIRED BY CODE. 5. ELECTRICIAN TO PROVIDE PANEL BOARDS OF PROPER AMPACITY AND VOLTAGE FOR ALL ELECTRICAL CIRCUITS.

6. ALL SERVICE REQUIREMENTS MUST BE COORDINATED WITH LOCAL POWER COMPANY INCLUDING LOCATION AND TYPES OF TRANSFORMERS, DISCONNECTS AT EXTERIOR OF BUILDING, VOLTAGES, AMPACITIES AND ALL OTHER ELECTRICAL CONSTRUCTION DETAILS. FEEDERS SHOULD BE SIZED ACCORDING TO NEC REQUIREMENTS.

7. ALL CONCEALED CABLES TO BE RUN IN FLOORS, WALLS, OR CEILINGS AS NEEDED. 8. CONTRACTOR AND ELECTRICIAN TO PROVIDE BLOCKING FOR ALL ELECTRICAL FIXTURES AS NEEDED. 9. RECEPTACLES IN EXTERIOR WALLS MUST BE ISOLATED AND SEALED SOLIDLY.

10. SWITCHES SHOULD TYPICALLY BE MOUNTED 48" ABOVE FINISH FLOOR TO CENTER OF SWITCH. LOCATE SWITCHES ADJACENT TO DOOR CASINGS BUT NOT INTERSECTING DOOR CASINGS OR TRIM.


11. EXTERIOR SECURITY LIGHTING TO BE SELECTED AND LOCATED BY OWNER. ELECTRICIAN TO VERIFY SWITCHING LOCATION.

1. CLOSELY COORDINATE WORK WITH ALL OTHER TRADES ESPECIALLY CONCERNING ENGINEERED FLOOR SYSTEMS.

2. DESIGN AND SPECIFICATION OF MECHANICAL SYSTEM TO BE DETERMINED BY BUILDER OR LOCAL ENGINEER.

3. BUILDER TO FURNISH ALL DUCTWORK, CONTROL WIRING, PIPING, FITTINGS, ACCESSORIES, ECT. FOR COMPLETE INSTALLATION.

+ STUDIO
LAKE AND LAND STUDIO, LLC RECOMMENDS THAT ALL DRAWINGS BE REVIEWED AND APPROVED BY A LICENSED ARCHITECT OR STRUCTURAL ENGINEER. INCLUDED DRAWINGS ARE FOR DESIGN PURPOSES ONLY.
SHEET TITLE: SECOND FLOOR ELECTRICAL PLAN
PROJECT DESCRIPTION: SUOZZI RESIDENCE BLUFFTON,SC
DRAWINGS PROVIDED BY: LAKE AND LAND STUDIO, LLC 16 Bellegrass Blvd Hattiesburg, MS 39402 601.336.8114 info@lakeandlandstudio.com
DATE: 7/18/2023 SCALE: 1/4"=1'-0" SHEET:

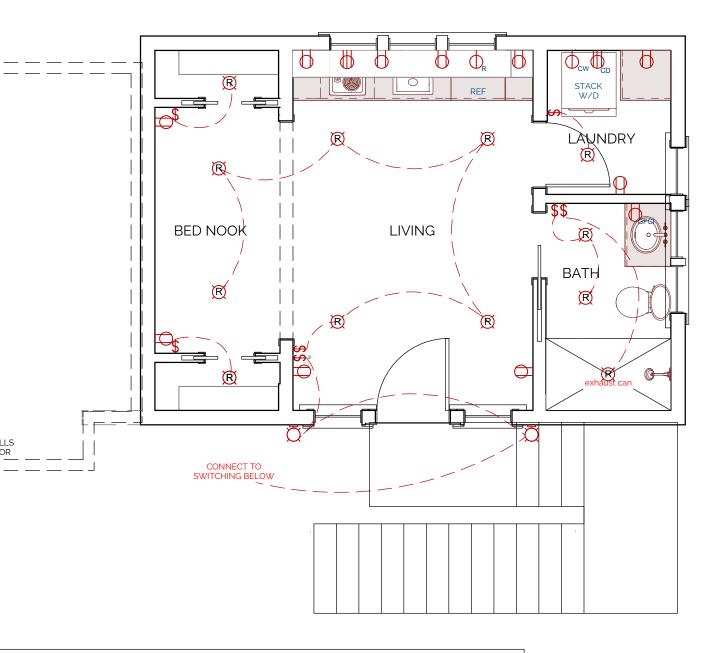

ELECTRICAL LEGEND

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110 VOLT OUTLET

220 VOLT OUTLET

SCONCE LIGHT


PENDANT LIGHT


CEILING FAN

GOOSENECK LIGHT

SINGLE POLE SWITCH

RECESSED DOWN LIGHT

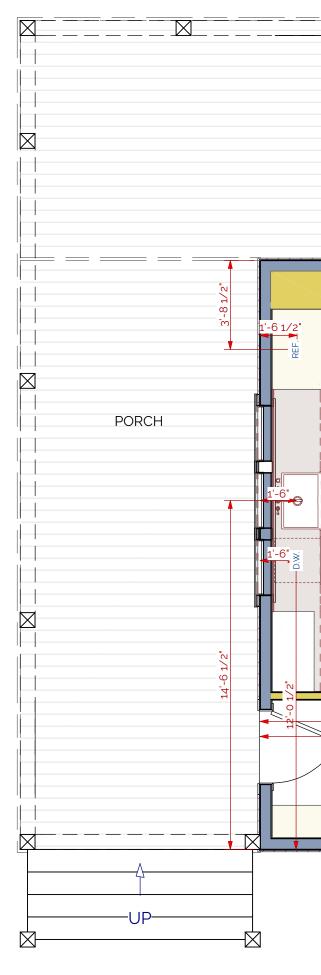

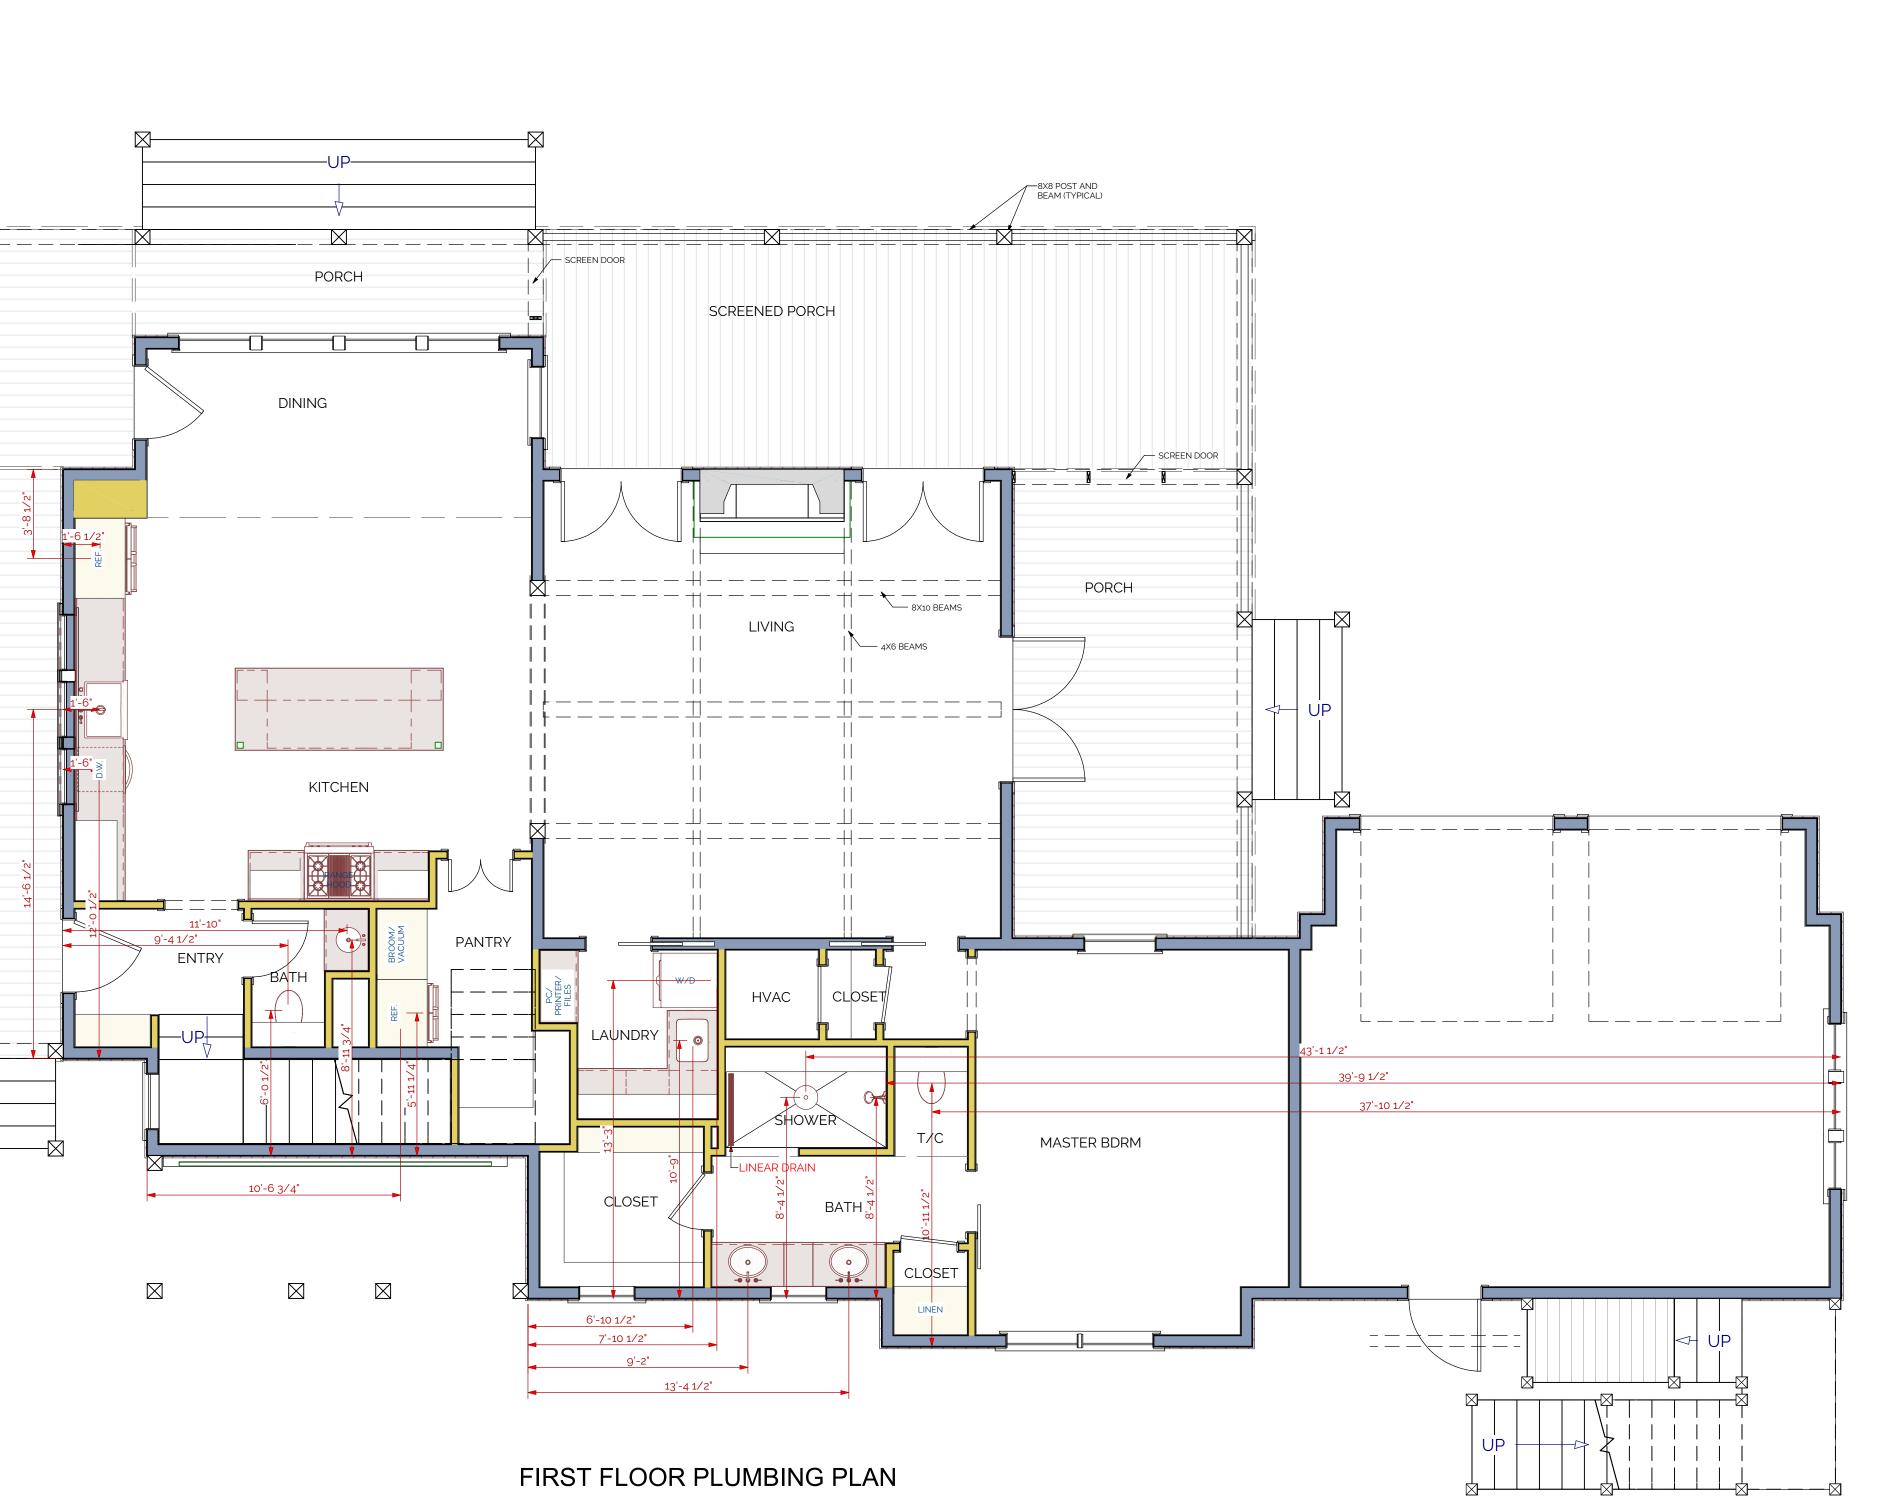

GENERAL PLUMBING NOTES 1. PLUMBING SYSTEMS SHALL BE DESIGNED IN ACCORDANCE WITH ALL APPLICABLE CODES, STANDARDS, AND REQUIREMENTS OF LOCAL UTILITY OFFICIALS.

2. INSULATE ALL DOMESTIC WATER SUPPLY LINES IN UN-INSULATED SPACES WITH TUBULAR FOAM INSULATION. INSULATION SHALL BE OF SELF-SEALING TYPE OR SHALL BE TAPED CLOSED WITH FOIL FACED TAPE.

3. CENTER ALL FIXTURES IN SPACE ALLOCATED UNLESS NOTED OTHERWISE. COORDINATE PLACEMENT OF ALL DRAINS WITH FLOORING SUBCONTRACTOR.


4. CLEANOUTS SHALL EXTEND TO SURFACES OR SHALL BE PROVIDED WITH ACCESS DOORS OR SIMILAR DEVICES. CAP ALL PIPE TO BE LEFT OPEN OVERNIGHT, AND PROTECT PIPE DURING INSTALLATION FROM DIRT, GRAVEL, AND OTHER DEBRIS WHICH MIGHT CAUSE BLOCKAGES OR FLOW RESTRICTIONS. ALL VALVES, CLEANOUTS, AND CONTROL DEVICES SHALL BE ACCESSIBLE FOR OPERATION AND MAINTENANCE THROUGH ACCESS DOORS OR PANELS MANUFACTURED FOR SUCH PURPOSES.

5. LEAD SOLDER IS NOT ALLOWED ON THIS PROJECT.


6. SOIL AND VENT STACKS SHALL HAVE CLEANOUTS AS REQUIRED BY APPLICABLE CODES FOR PROPER MAINTENANCE.


7. COORDINATE WITH AN ELECTRICIAN CONCERNING ITEMS REQUIRING ELECTRICAL SERVICE SUCH AS WATER COOLERS, SENSOR FLUSH VALVES AND WATER HEATERS. COORDINATE SERVICE AND AMPACITY REQUIRED. 8. SEAL TO WALL, FLOOR OR COUNTERTOP AROUND ALL FIXTURES WITH TUB AND TILE SEALANT TO MATCH COLOR OF FIXTURE UNLESS OTHERWISE NOTED.

+ STUDIO
LAKE AND LAND STUDIO, LLC RECOMMENDS THAT ALL DRAWINGS BE REVIEWED AND APPROVED BY A LICENSED ARCHITECT OR STRUCTURAL ENGINEER. INCLUDED DRAWINGS ARE FOR DESIGN PURPOSES ONLY.
SHEET TITLE: FIRST FLOOR PLUMBING PLAN
PROJECT DESCRIPTION: SUOZZI RESIDENCE BLUFFTON,SC
DRAWINGS PROVIDED BY: LAKE AND LAND STUDIO, LLC 16 Bellegrass Blvd Hattiesburg, MS 39402 601.336.8114 info@lakeandlandstudio.com
DATE: 7/18/2023 SCALE: 1/4"=1'-0" SHEET:
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SECOND FLOOR PLUMBING PLAN

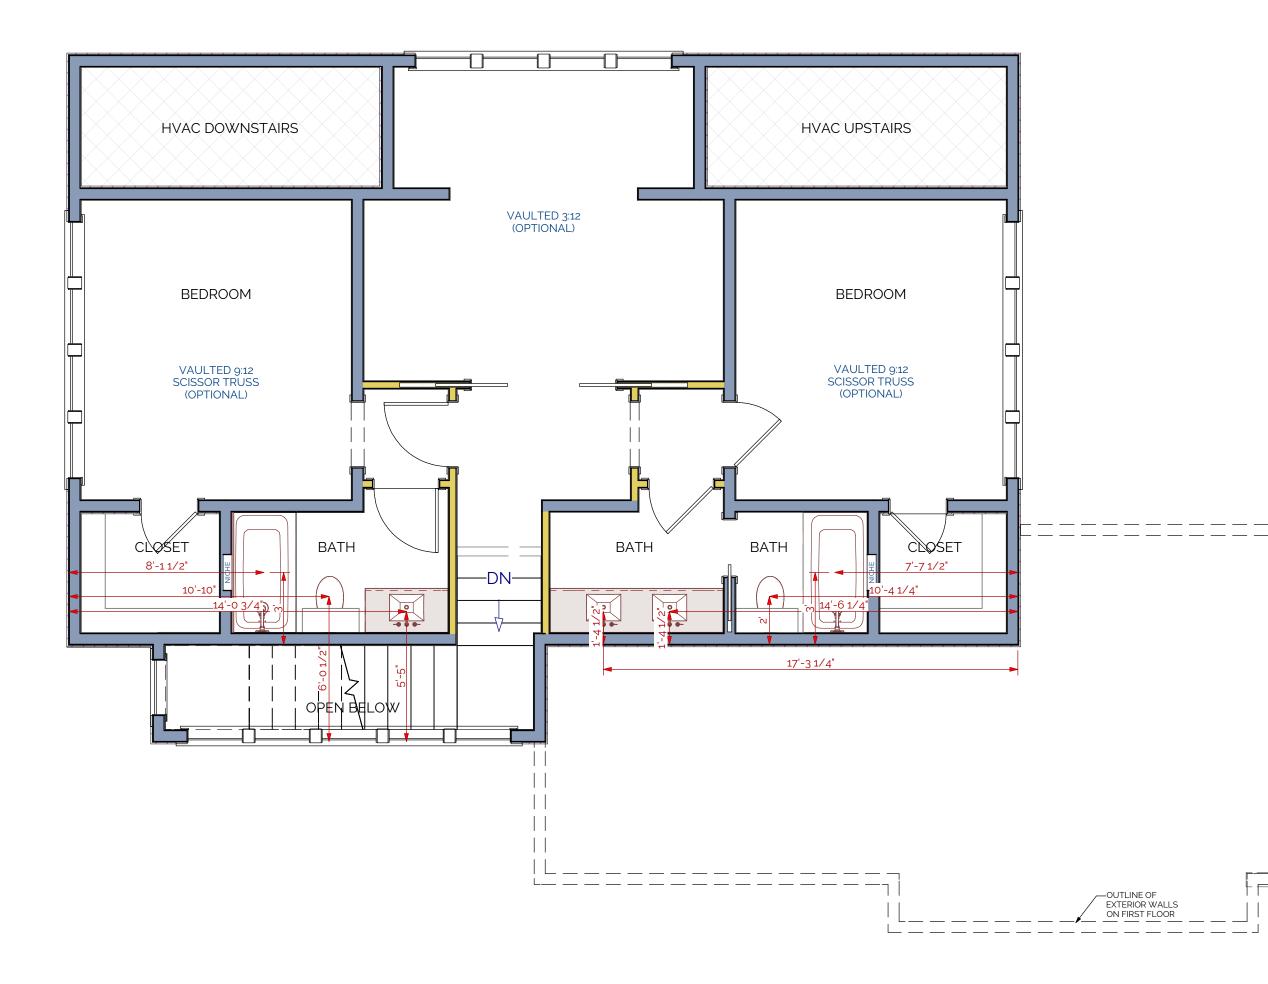

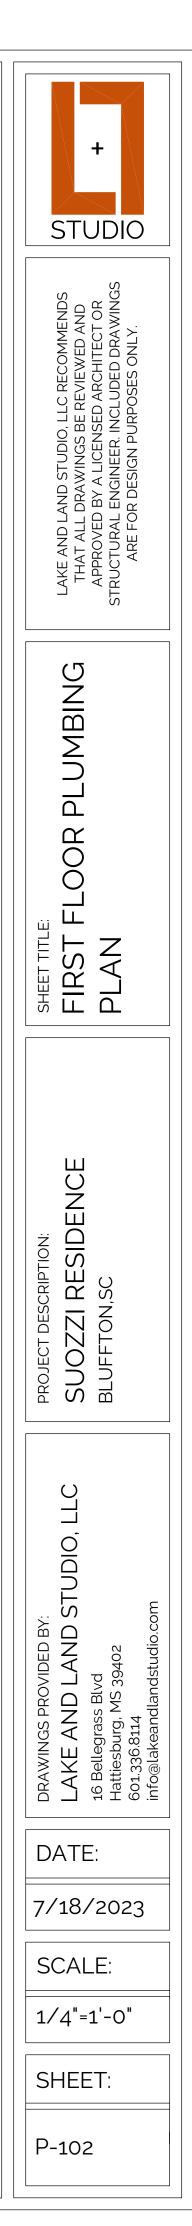

GENERAL PLUMBING NOTES 1. PLUMBING SYSTEMS SHALL BE DESIGNED IN ACCORDANCE WITH ALL APPLICABLE CODES, STANDARDS, AND REQUIREMENTS OF LOCAL UTILITY OFFICIALS.

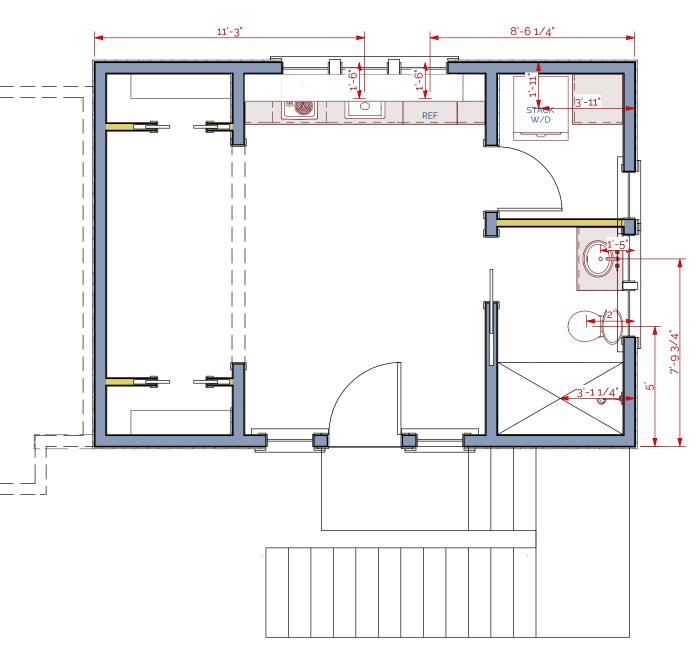2. INSULATE ALL DOMESTIC WATER SUPPLY LINES IN UN-INSULATED SPACES WITH TUBULAR FOAM INSULATION. INSULATION SHALL BE OF SELF-SEALING TYPE OR SHALL BE TAPED CLOSED WITH FOIL FACED TAPE.

3. CENTER ALL FIXTURES IN SPACE ALLOCATED UNLESS NOTED OTHERWISE. COORDINATE PLACEMENT OF ALL DRAINS WITH FLOORING SUBCONTRACTOR.

4. CLEANOUTS SHALL EXTEND TO SURFACES OR SHALL BE PROVIDED WITH ACCESS DOORS OR SIMILAR DEVICES. CAP ALL PIPE TO BE LEFT OPEN OVERNIGHT, AND PROTECT PIPE DURING INSTALLATION FROM DIRT, GRAVEL, AND OTHER DEBRIS WHICH MIGHT CAUSE BLOCKAGES OR FLOW RESTRICTIONS. ALL VALVES, CLEANOUTS, AND CONTROL DEVICES SHALL BE ACCESSIBLE FOR OPERATION AND MAINTENANCE THROUGH ACCESS DOORS OR PANELS MANUFACTURED FOR SUCH PURPOSES.

5. LEAD SOLDER IS NOT ALLOWED ON THIS PROJECT.

6. SOIL AND VENT STACKS SHALL HAVE CLEANOUTS AS REQUIRED BY APPLICABLE CODES FOR PROPER MAINTENANCE.

7. COORDINATE WITH AN ELECTRICIAN CONCERNING ITEMS REQUIRING ELECTRICAL SERVICE SUCH AS WATER COOLERS, SENSOR FLUSH VALVES AND WATER HEATERS. COORDINATE SERVICE AND AMPACITY REQUIRED. 8. SEAL TO WALL, FLOOR OR COUNTERTOP AROUND ALL FIXTURES WITH TUB AND TILE SEALANT TO MATCH COLOR OF FIXTURE UNLESS OTHERWISE NOTED.