ALL NOTES APPLY TO ALL DRAWINGS AND ALL TRADES.

- IT IS THE RESPONSIBILITY OF ALL CONTRACTORS AND TRADES TO COORDINATE THE INSTALLATION OF
- THEIR WORK WITH THE INSTALLATION OF WORK BY ALL OTHER CONTRACTORS AND TRADES. THE REQUIREMENTS OF THE DRAWINGS, GENERAL REQUIREMENTS, AND ALL ITEMS OF THE CONTRACT DOCUMENTS ARE EQUALLY BINDING FOR ALL CONTRACTORS AND TRADES
- EACH CONTRACTOR IS REQUIRED TO MAINTAIN FULL (COLOR) SETS OF THE CONTRACT DOCUMENTS FOR HIS EMPLOYEES USE ON THE PROJECT TO ASSURE THAT ALL WORK IS PROPERLY COORDINATED
- AND FOR REVIEWS BY COUNTY AND / OR MUNICIPALITY OFFICIALS FOR INSPECTIONS. ALL CONTRACTORS AND ALL TRADES ARE RESPONSIBLE FOR OBTAINING THE CORRECT PERMITS AND INSPECTIONS PRIOR TO CONSTRUCTION AS REQUIRED BY LOCAL PLANNING, ZONING, BUILDING CODE
- AND OTHER TOWN AUTHORITIES. W.J.K. LTD., THE OWNER AND / OR THE OWNER'S REPRESENTATIVE SHALL BE NOTIFIED OF ANY SITE CONDITIONS WHICH MAY NECESSITATE MODIFICATION TO THE PLAN. THE OWNER OR OWNER'S
- REPRESENTATIVE SHALL MAKE 'INFIELD MODIFICATIONS,' IF NECESSARY CONTRACTOR SHALL PROVIDE AND FURNISH ALL MATERIALS, EQUIPMENT AND LABOR NECESSARY FOR ALL CONSTRUCTION, PROTECTION, MAINTENANCE AND RELATED ITEMS TO COMPLETE WORK INDICATED ON THE DRAWINGS.
- BEFORE COMMENCING ANY WORK CONTRACTOR SHALL ASCERTAIN THE LOCATION OF ALL UTILITIES, SUB-SURFACE DRAINAGE, AND UNDERGROUND CONSTRUCTION SO THAT PROPER PRECAUTIONS MAY BE TAKEN NOT TO DISTURB ANY SUB-SURFACE IMPROVEMENTS. CONTRACTOR SHALL TAKE ALL NECESSARY PRECAUTIONS IN BRINGING EQUIPMENT ON TO AND OFF OF THE SITE, PROTECTING WALKS, PAVING, STEPS AND OTHER EXISTING CONSTRICTION ON THE SITE. CONTACTS SHALL BE MADE BY CONTRACTOR WITH PROPER AUTHORITIES BEFORE AND DURING THIS WORK SO AS TO COMPLY WITH ALL REGULATIONS AND ORDINANCES.
- CONTRACTOR SHALL FIELD LOCATE ALL UTILITIES AND CONFIRM / DETERMINE UTILITY ELEVATIONS PRIOR TO CONSTRUCTION. CONTRACTOR IS RESPONSIBLE FOR ANY DAMAGE AND MAKE REPAIRS, AT THEIR OWN EXPENSE, THAT MAY OCCUR TO EXISTING UTILITIES IN ACCORDANCE WITH NATIONAL, STATE AND LOCAL CODES.
- 10. CONTRACTOR SHALL VERIFY ALL EXISTING TREE CONDITIONS AND ELEVATIONS PRIOR TO CONSTRUCTION. CONTRACTOR SHALL NOTIFY THE OWNER OR OWNER'S REPRESENTATIVE OF ANY DISCREPANCIES PRIOR TO THEIR REMOVAL
- . Contractor shall protect and install tree protection fence around the drip line of all TREES AND NATURAL AREAS TO REMAIN. TREE PROTECTION LOCATION SHALL BE APPROVED BY LANDSCAPE ARCHITECT PRIOR TO CONSTRUCTION.
- 12. ALL CONSTRUCTION FOR ALL TRADES SHALL CONFORM TO OR EXCEED THE PRODUCT MANUFACTURER'S RECOMMENDATIONS, REGULATIONS OF BEAUFORT COUNTY AND THE AMERICANS WITH DISABILITIES ACT, AND / OR OTHER APPLICABLE NATIONAL, STATE, AND LOCAL CODES AND ANY OTHER GOVERNING AUTHORITIES.
- 13. CONTRACTOR ACCESS FOR CONSTRUCTION AS DIRECTED BY THE OWNER OR OWNER'S REPRESENTATIVE. 14. CONTRACTOR SHALL PROTECT THE GENERAL PUBLIC FROM CONSTRUCTION AREAS DURING CONSTRUCTION.
- 15. ANY DEVIATIONS FROM THESE PLANS MUST BE SPECIFICALLY APPROVED BY W.J.K. LTD., AND THE OWNER OR OWNER'S REPRESENTATIVE.

DEMOLITION NOTES:

- THE CONTRACTOR, BEFORE BEGINNING ANY DEMOLITION ACTIVITY, SHALL CONTACT THE LOCAL UTILITIES FOR INSTRUCTION ON SPECIAL PROCEDURES THAT MAY BE REQUIRED BY THE UTILITIES CONCERNING DEMOLITION.
- ALL DEMOLISHED MATERIAL SHALL BE HAULED AWAY AND DISPOSED OF PROPERLY IN A LANDFILL AS APPLICABLE PER BEAUFORT COUNTY CODE(S) THE CONTRACTOR SHALL FOLLOW ALL REQUIREMENTS OF LOCAL, STATE AND FEDERAL REGULATORY
- AGENCIES WHICH MAY HAVE JURISDICTION OVER SUCH ACTIVITIES. THE CONTRACTOR IS RESPONSIBLE FOR VERIFYING ALL DATA PROVIDED IN THESE DRAWINGS. THE
- Contractor shall perform his own estimate of material for demolition and report any DISCREPANCIES TO THE OWNER OR THE OWNER'S REPRESENTATIVE PRIOR TO BEGINNING WORK.
- ALL UTILITIES SHOWN ON THE DRAWINGS ARE APPROXIMATE AND FOR ESTIMATING PURPOSES ONLY THE EXACT LOCATIONS SHALL BE FIELD VERIFIED BY THE CONTRACTOR PRIOR TO BEGINNING DEMOLITION WORK. ALL UTILITIES SHALL BE LOCATED AND PROTECTED TO PREVENT DAMAGE. ANY DAMAGE WHICH MAY OCCUR DURING THE CONSTRUCTION PROCESS IS TO BE PROMPTLY REPORTED TO THE APPROPRIATE UTILITY AUTHORITY AND REPAIRS SHALL BE MADE IN ACCORDANCE WITH THEIR REQUIREMENTS. THE SAFE DEMOLITION AND REMOVAL OF UTILITIES, STRUCTURES AND EQUIPMENT IS THE SOLE RESPONSIBILITY OF THE CONTRACTOR.
- IT IS THE RESPONSIBILITY OF THE CONTRACTOR TO NOTIFY, AT THE DIRECTION OF THE OWNER OR OWNER'S REPRESENTATIVE, THE UTILITIES HAVING JURISDICTION OVER ANY UTILITY EASEMENTS OF ANY KIND FOR APPROVAL OF WORK WITHIN THE EASEMENT.
- REMOVAL OF ANY AND ALL MATERIALS INDICATED INCLUDES ALL MATERIALS ASSOCIATED WITH THAT ITEM INCLUDING SUBSURFACE MATERIAL, IF APPLICABLE, NOT NEEDED OR IN NEED OF REPAIR OR REPLACEMENT. THE CONTRACTOR SHALL TAKE CARE WHEN WORKING AROUND EXISTING TREES SCHEDULED TO
- REMAIN. PROPER TREE PROTECTION IN ACCORDANCE WITH LOCAL CODES SHALL BE MADE PRIOR TO CONSTRUCTION BEGINNING AND THROUGHOUT THE CONSTRUCTION PROCESS. SOME TREES AND SHRUBS SCHEDULED FOR RELOCATION AND REUSE ON THE PROPERTY MAY NOT BE
- SALVAGEABLE DUE TO UNDERGROUND UTILITIES. 10. BARRIERS AND / OR FLAG MEN MAY BE REQUIRED FOR SAFETY, VERIFY REQUIREMENTS WITH THE
- OWNER FOR SUCH NEEDS PRIOR TO BEGINNING THE WORK.
- I 1. THE OWNER SHALL BE NOTIFIED AS TO THE TIMING OF THE WORK SO THAT PROPER SECURITY NOTIFICATION IS MADE.

GENERAL DISTURBANCE NOTES:

- CONTRACTOR SHALL IMPLEMENT ALL SILT FENCE OR OTHER SEDIMENT CONTROL MEASURES AROUND ALL DISTURBED AREAS PRIOR TO ANY CONSTRUCTION ACTIVITIES. TEMPORARY CONSTRUCTION ENTRANCE SHALL BE INSTALLED AFTER SILT FENCE AND PRIOR TO ALL
- OTHER CONSTRUCTION ACTIVITIES.
- ALL SEDIMENT AND EROSION CONTROL DEVICES SHALL BE INSPECTED BY THE CONTRACTOR AT LEAST ONCE EVERY FOURTEEN (14) CALENDAR DAYS AND WITHIN 24 HOURS OF THE END OF A STORM EVENT OF 0.5 INCHES OR GREATER. IF SITE INSPECTIONS IDENTIFY B.M.P.S. THAT ARE DAMAGED OR ARE NOT 7. OPERATING EFFECTIVELY, MAINTENANCE MUST BE PERFORMED AS SOON AS PRACTICAL AND BEFORE THE NEXT STORM EVENT IF PRACTICAL.
- CONTRACTOR TO PROVIDE SILT FENCE AND / OR OTHER CONTROL DEVICES, AS MAY BE REQUIRED, TO CONTROL SOIL EROSION DURING UTILITY CONSTRUCTION. ALL DISTURBED AREAS SHALL BE CLEANED, Graded and stabilized with grassing immediately after the utility installation. Fill, cover AND TEMPORARY SEEDING AT THE END OF EACH DAY ARE RECOMMENDED. IF WATER IS ENCOUNTERED WHILE TRENCHING, THE WATER SHOULD BE FILTERED TO REMOVE ANY SEDIMENTS BEFORE BEING PUMPED BACK INTO ANY WATERS OF THE STATE.
- ALL EROSION CONTROL DEVICES SHALL BE PROPERLY MAINTAINED BY THE CONTRACTOR DURING ALL PHASES OF CONSTRUCTION UNTIL THE COMPLETION OF ALL CONSTRUCTION ACTIVITIES AND ALL DISTURBED AREAS HAVE BEEN STABILIZED. ADDITIONAL CONTROL DEVICES MAY BE REQUIRED DURING CONSTRUCTION IN ORDER TO CONTROL EROSION AND / OR OFFSITE SEDIMENTATION. ALL TEMPORARY CONTROL DEVICES SHALL BE REMOVED ONCE CONSTRUCTION IS COMPLETE AND THE SITE IS STABILIZED.
- THE CONTRACTOR MUST TAKE NECESSARY ACTION TO MINIMIZE THE TRACKING OF MUD ONTO PAVED SURFACES FROM CONSTRUCTION AREAS AND THE GENERATION OF DUST. THE CONTRACTOR SHALL REMOVE MUD / SOIL DAILY FROM PAVED SURFACES, AS REQUIRED.
- RESIDENTIAL SUBDIVISIONS REQUIRE EROSION CONTROL FEATURES FOR INFRASTRUCTURE AS WELL AS FOR INDIVIDUAL LOT CONSTRUCTION. INDIVIDUAL PROPERTY OWNERS SHALL FOLLOW THESE PLANS DURING CONSTRUCTION OR OBTAIN APPROVAL OF AN INDIVIDUAL PLAN IN ACCORDANCE WITH S.C. REG. 72-300 ET SEQ. AND SCR100000.

TEMPORARY DIVERSION BERMS AND / OR DITCHES WILL BE PROVIDED AS NEEDED DURING

- CONSTRUCTION TO PROTECT WORK AREAS FROM UP SLOPE RUNOFF AND / OR TO DIVERT SEDIMENT-LADEN WATER TO APPROPRIATE TRAPS OR STABLE OUTLETS. ALL WATERS OF THE STATE (W.O.S.), INCLUDING WETLANDS, ARE TO BE FLAGGED OR OTHERWISE
- CLEARLY MARKED IN THE FIELD. A DOUBLE ROW OF SILT FENCE IS TO BE INSTALLED IN ALL AREAS Where a 50-foot buffer can't be maintained between the disturbed area and all w.o.s. A 10-FOOT BUFFER SHOULD BE MAINTAINED BETWEEN THE LAST ROW OF SILT FENCE AND ALL W.O.S.). Litter, construction debris, oils, fuels and building products with significant potential
- FOR IMPACT (SUCH AS STOCKPILES OF FRESHLY TREATED LUMBER) AND CONSTRUCTION CHEMICALS THAT COULD BE EXPOSED TO STORMWATER MUST BE PREVENTED FROM BECOMING A POLLUTANT SOURCE IN STORMWATER DISCHARGES.
- . Stabilization measures shall be initiated as soon as practical in portions of the site where CONSTRUCTION ACTIVITIES HAVE TEMPORARILY OR PERMANENTLY CEASED, BUT IN NO CASE MORE THAN FOURTEEN (14) DAYS AFTER WORK HAS CEASED EXCEPT AS STATED BELOW:
- 11.1. WHERE STABILIZATION BY THE 14TH DAY IS PRECLUDED BY SNOW COVER OR FROZEN GROUND CONDITIONS, STABILIZATION MEASURES MUST BE INITIATED AS SOON AS PRACTICAL.
- 11.2. WHERE CONSTRUCTION ACTIVITY ON A PORTION OF THE SITE IS TEMPORARILY CEASED AND EARTH-DISTUBING ACTIVITIES WILL BE RESUMED WITHIN 14 DAYS, TEMPORARY STABILIZATION MEASURES DO NOT HAVE TO BE INITIATED ON THAT PORTION OF THE SITE.

LAYOUT NOTES:

- ALL CONSTRUCTION STAKING SHALL BE THE RESPONSIBILITY OF THE CONTRACTOR CONTRACTOR TO USE DIGITAL FILES PROVIDED BY WITMER-JONES-KEEFER, LTD. TO LAYOUT AND STAKE ALL SITE IMPROVEMENTS AND ELEMENTS. FINAL LAYOUT AND STAKING TO BE FIELD VERIFIED AND APPROVED BY LANDSCAPE ARCHITECT AND OWNER OR OWNER'S REPRESENTATIVE PRIOR TO
- CONSTRUCTION. CONTRACTOR SHALL FIELD LOCATE, STAKE AND USE COLOR CODED SPRAY PAINT FOR ALL ABOVE AND BELOW GROUND UTILITIES. CONTRACTOR TO CONFIRM / DETERMINE UTILITY ELEVATIONS PRIOR TO CONSTRUCTION. ANY EXISTING UTILITY CONFLICTS WITH SITE IMPROVEMENTS TO BE REPORTED TO OWNER, OWNER'S REPRESENTATIVE AND LANDSCAPE ARCHITECT PRIOR TO CONSTRUCTION. CONTRACTOR IS RESPONSIBLE FOR ANY DAMAGE TO EXISTING UTILITIES AS STATED IN THE GENERAL NOTES.
- 4. ANY LAYOUT AND STAKING DISCREPANCIES TO BE REPORTED TO THE OWNER, OWNER'S REPRESENTATIVE OR LANDSCAPE ARCHITECT. 5. ALL DIMENSIONS ARE TO EDGE OF PAVING AND CENTERLINE OF WALLS AND COLUMNS UNLESS
- OTHERWISE INDICATED.
- ALL ANGLES ARE 90 UNLESS OTHERWISE INDICATED. CONTRACTOR SHALL PROVIDE LIGHTING, IRRIGATION AND ANY OTHER CONDUIT NEEDED TO ALL LANDSCAPE AREAS.
- ANY AND ALL FIELD ADJUSTMENTS SHALL RECEIVE APPROVAL FROM THE OWNER, OWNER'S REPRESENTATIVE OR LANDSCAPE ARCHITECT PRIOR TO CONSTRUCTION

GRADING NOTES:

- CONTRACTOR SHALL VERIFY ALL ELEVATIONS PRIOR TO CONSTRUCTION AND NOTIFY OWNER'S REPRESENTATIVE OF DISCREPANCIES.
- CROSS SLOPES ON ALL HARDSCAPE WALKWAYS / PATHWAYS ARE NOT TO EXCEED 2%. IF DISCREPANCIES DEVELOP BETWEEN THE PROPOSED GRADES AS SHOWN ON THE PLAN AND THE EXISTING GROUND SURFACE, THE CONTRACTOR, WITH PRIOR APPROVAL FROM THE OWNER'S REPRESENTATIVE, SHALL MAKE GRADING ADJUSTMENTS NECESSARY TO MAINTAIN THE GENERAL INTENT OF THE DESIGN.
- CONTRACTOR IS RESPONSIBLE FOR ALL PAVED AREAS DAMAGED DURING CONSTRUCTION.
- CONTRACTOR SHALL PROVIDE POSITIVE DRAINAGE AWAY FROM ALL ADJACENT PROPERTIES, WALLS, WALKS AND PLANTING BEDS AND TOWARDS EXISTING DRAIN INLETS, SWALES, STORMWATER LAGOONS OR ROADS.

ALL DISTURBED AREAS INCLUDING SHALLOW SWALES SHALL BE MULCHED OR PLANTED AS INDICATED

- ON PLANTING PLANS. IF REQUIRED, POP UP EMITTER SHALL BE N.D.S. 6" POP UP DRAINAGE EMITTER BLACK IN COLOR.
- LANDSCAPE DRAIN SHALL BE AS SPECIFIED ON PLANS. LANDSCAPE DRAINS SHALL BE ADDED TO PROVIDE POSITIVE DRAINAGE AWAY FROM BUILDINGS IN LOW / FLAT AREAS THAT DID NOT SHOW UP ON THE TOPOGRAPHIC SURVEY. LANDSCAPE DRAIN SHALL BE APPROVED BY OWNER, OWNER'S REPRESENTATIVE OR LANDSCAPE ARCHITECT PRIOR TO INSTALLATION.

LIGHTING NOTES:

- LIGHTING PLAN IS A DIAGRAMMATIC DRAWING AND EXACT LOCATIONS OF LIGHT FIXTURES SHALL BE APPROVED BY LANDSCAPE ARCHITECT, OWNER OR OWNER'S REPRESENTATIVE PRIOR TO INSTALLATION. CONTRACTOR TO COORDINATE WITH THE BUILDER FOR THE LOCATION OF ELECTRICAL PANEL NEEDED FOR LIGHTING.
- 3. ALL LIGHTING EQUIPMENT SHALL BE INSTALLED PER MANUFACTURERS INSTRUCTIONS AND RECOMMENDATIONS, AND MUST COMPLY WITH ALL APPLICABLE STATE AND COUNTY CODES.
- 4. THE CONTRACTOR IS RESPONSIBLE FOR ACQUIRING ALL NECESSARY PERMITS AND INSPECTION APPROVALS REQUIRED
- THE CONTRACTOR SHALL STAKE OUT ALL LIGHT FIXTURE AND TRANSFORMER LOCATIONS FOR APPROVAL BY THE LANDSCAPE ARCHITECT, OWNER, OR OWNER'S REPRESENTATIVE PRIOR TO INSTALLATION. EXACT LOCATIONS OF CONTROLLERS, ELECTRICAL PANELS, ETC. TO BE COORDINATED WITH AND APPROVED BY OWNER, OWNER'S REPRESENTATIVE OR LANDSCAPE ARCHITECT
- THE CONTRACTOR SHALL COORDINATE, STAKE AND FLAG ALL LOCATIONS WHERE ELECTRICAL CONDUIT OR P.V.C. SLEEVING MAY BE REQUIRED BENEATH WALKS OR OTHER PAVED AREAS PRIOR TO HARDSCAPE INSTALLATION.
- ALL ELECTRICAL WIRING RUNNING UNDER PAVED AREAS SHALL BE PLACED IN ELECTRICAL CONDUIT OR P.V.C. SLEEVES PROVIDED BY CONTRACTOR. THE CONTRACTOR SHALL PROVIDE ALL EQUIPMENT, LABOR, EXCAVATION AND BACKFILL NECESSARY TO
- COMPLETE THE WORK. 9. ALL FIXTURES PER MODELS SPECIFIED UNLESS CONTRACTOR GETS APPROVAL FROM LANDSCAPE ARCHITECT FOR A SUBSTITUTION.
- 10. SYSTEM INSTALLATION, INCLUDING PARTS AND LABOR, SHALL BE GUARANTEED AND REPAIRED AS NECESSARY BY THE CONTRACTOR FOR ONE YEAR.

CONSTRUCTION NOTES:

- ALL CONTRACTORS AND ALL TRADES ARE RESPONSIBLE FOR OBTAINING THE CORRECT PERMITS AND INSPECTIONS PRIOR TO CONSTRUCTION AS REQUIRED BY LOCAL PLANNING, ZONING, BUILDING CODE AND OTHER TOWN AUTHORITIES.
- CONTRACTOR SHALL PROVIDE SAMPLES OF ALL MATERIALS AND OBTAIN APPROVAL FROM OWNER, OWNER'S REPRESENTATIVE OR LANDSCAPE ARCHITECT PRIOR TO CONSTRUCTION.
- ON SITE TOPOGRAPHY MAY REQUIRE ADJUSTMENTS OF FINAL SPOT ELEVATIONS ON SITE FOR PROPOSED VERTICAL CONSTRUCTION ELEMENTS. THE CONTRACTOR SHALL NOTIFY THE OWNER OR OWNER'S REPRESENTATIVE PROMPTLY UPON THE DISCOVERY OF ANY SUCH REQUIRED ADJUSTMENTS. THE CONTRACTOR SHALL PROVIDE FILL AS IS REQUIRED TO OBTAIN PROPER RELATIONSHIP OF FOOTING
- TO FINISH GRADE REQUIREMENTS FEATHER FILL TO ADJACENT EXISTING GRADE TO ASSURE A COORDINATED AND DESIRED EFFECT. 5. THE CONTRACTOR IS RESPONSIBLE FOR ALL DAMAGE TO EXISTING CONDITIONS SCHEDULED TO REMAIN
- DURING CONSTRUCTION.

'IN-FIELD MODIFICATIONS' MAY BE NECESSARY TO PRODUCE DESIRED EFFECT. MODIFICATIONS TO BE

- 6. THE CONTRACTOR IS RESPONSIBLE FOR LOCATING ALL EXISTING UTILITIES AND FOR ANY DAMAGE THAT MAY OCCUR TO EXISTING UTILITIES DURING CONSTRUCTION.
- APPROVED BY LANDSCAPE ARCHITECT AND OWNER OR OWNER'S REPRESENTATIVE. 8. ALL WELDS TO BE CONTINUOUS. 9. FOR ALL WOOD MEMBERS, ALL CUTS SHALL BE EVEN AND JOINTS FLUSH. SAND FOUR SIDES AND FILL
- IMPERFECTIONS, COUNTERSINKS AND NAIL HOLES TO ASSURE EVEN FINISH. CONTRACTOR SHALL VERIFY ALL WOOD MEMBERS FOR APPROPRIATE SIZE, SPACING, ATTACHMENTS AND STRUCTURAL STABILITY PRIOR TO CONSTRUCTION. CONTRACTOR TO REPORT ANY DISCREPANCIES
- TO OWNER, OWNER'S REPRESENTATIVE OR LANDSCAPE ARCHITECT. 11. ALL NOTCHES SHALL BE SHOP CUT TO ASSURE TIGHT JOINTS. EACH MEMBER SHALL BE DRIVEN HOME TO ASSURE TIGHT FIT. PILOT HOLES SHALL BE DRILLED FOR EACH CARRIAGE BOLT. PLUG, SEAL AND
- 12. FINISH ALL SIDES AND CAULK ALL JOINTS WITH APPROPRIATE EXTERIOR CAULK PRIOR TO FINISHING.
- 13. ALL CONNECTORS, UNLESS OTHERWISE SPECIFIED, SHALL BE STAINLESS STEEL. BOLTS, THREADED RODS, WASHERS, NUTS AND ALL BUILDING HARDWARE SHALL BE STAINLESS STEEL AND SUITABLE FOR PRESSURE TREATED WOOD. ALL THROUGH BOLTS TO BE SMOOTH SHAFT WITH STAINLESS STEEL NUTS,
- BOLTS AND WASHERS. ALL NAILS AND FINISH NAILS SHALL BE ANNULAR STAINLESS STEEL 14. ALL DECKING SHALL BE SECURED WITH STAINLESS STEEL SCREWS SIZED FOR DECK APPLICATION.

PLANTING NOTES:

AND LOCAL CODES

- CONTRACTOR IS RESPONSIBLE FOR INSPECTION OF EXISTING CONDITIONS, INCLUDING UTILITIES, AND PROMPTLY REPORTING ANY DISCREPANCIES OR CONFLICTS WITH PLANTING AREAS. REPORT INFORMATION TO OWNER, OWNER'S REPRESENTATIVE AND LANDSCAPE ARCHITECT
 - CONTRACTOR SHALL FIELD LOCATE ALL UTILITIES. CONTRACTOR IS RESPONSIBLE FOR ANY DAMAGE and make repairs that may occur to existing utilities in accordance with national, state
- Landscape Planting and / or mulched areas to be fine graded, hand raked smooth and FREE OF DEBRIS.
- CONTRACTOR TO PERFORM SOIL TESTS AS NECESSARY TO ASSURE PLANT HEALTH AND GROWTH
- MULCH ALL PLANTING BEDS TO A MIN. 3" DEPTH WITH MULCH SPECIFIED IN PLANT SCHEDULE.
- CONTRACTOR VERIFIES THAT ALL PLANT MATERIAL IS DETERMINED AVAILABLE AS SPECIFIED WHEN BID / Proposal is submitted. 7. PLANT SCHEDULE WAS PREPARED FOR ESTIMATING PURPOSES ONLY. CONTRACTOR SHALL MAKE OWN
- QUANTITY TAKEOFFS USING DRAWINGS TO DETERMINE QUANTITIES TO HIS SATISFACTION. REPORTING PROMPTLY ANY DISCREPANCIES WHICH MAY AFFECT BIDDING
- 8. GALLON SIZES ARE FOR PRICING PURPOSES ONLY. PLANT MUST MEET HEIGHTS AND WIDTHS SPECIFIED
- 9. ROOT TYPE MAY BE FREELY SUBSTITUTED IN CASE OF BALLED AND BURLAPPED OR CONTAINER GROWN OTHER SPECIFICATIONS REMAINING UNCHANGED, EXCEPT IN THE CASE OF CONTAINER GROWN SPECIMEN TREES AS INDICATED IN THE TREE PLANTING SCHEDULE
- 10. ANY SIGNIFICANT ROOTS ENCOUNTERED 2" DIA. AND LARGER SHALL BE DUG OUT BY HAND AND cleanly cut back in the footing / foundation area to promote root re-growth and help 11. ALL PLANT MATERIAL (EXCEPT SEASONAL COLOR) SHALL BE GUARANTEED AND REPLACED AS
- NECESSARY BY THE CONTRACTOR FOR ONE YEAR. 12. ALL SEASONAL COLOR SHALL BE GUARANTEED AND REPLACED AS NECESSARY BY THE CONTRACTOR FOR THREE MONTH TIME FRAMES

SOIL AMENDMENT NOTES:

- 1. TOPSOIL SHALL CONSIST OF THE NATURAL LOAM, SANDY LOAM, SILT LOAM, OR CLAY LOAM HUMUS BEARING SOILS, ADAPTED TO THE SUSTENANCE OF PLANT LIFE, WITH THE FOLLOWING TEXTURE
- 1.1. ORGANIC MATERIAL TWO (2) TO TWENTY (20) PERCENT BY MASS 1.2. SAND CONTENT - TWENTY (20) TO SIXTY (60) PERCENT BY MASS
- 1.3. CLAY-SILT CONTENT THIRTY FIVE (35) TO SEVENTY (70) PERCENT BY MASS 1.4. TOPSOIL PH SHALL BE BETWEEN FIVE (5) AND SEVEN (7)
- 2. TOPSOIL SHALL BE OF UNIFORM QUALITY AND FREE FROM FOREIGN MATERIAL SUCH HARD CLODS SOD, STIFF CLAY, HARD PAN, STONES LARGER THAN ONE (1) INCH DIAMETER, LIME CEMENT, ASHES, slag, concrete, tar residues, tarred paper, boards, chips, sticks, or other undesirable MATERIALS. IT SHALL ALSO BE REASONABLY FREE FROM WEEDS AND OBJECTIONABLE PLANT MATERIAL. AFTER ALL DEMOLITION, CLEARING AND DISPOSAL IS COMPLETED, THE CONTRACTOR SHALL STRIP FROM
- THE TOP OF THE EXISTING GROUND ALL TOPSOIL IN ALL AREAS TO BE GRADED
- 4. PRIOR TO STOCKPILING OF TOPSOIL, TOPSOIL SHALL BE SCREENED WITH A ONE HALF (1/2) INCH SIZE SIEVE. STOCKPILE TOPSOIL IN DESIGNATED OR APPROVED LOCATIONS WITH PROPER DRAINAGE AND WHERE IT WILL NOT INTERFERE WITH THE WORK. AFTER TOPSOIL HAS BEEN STOCKPILED, CONTRACTOR SHALL QUANTIFY THE AMOUNTS AT NO ADDITIONAL COST TO THE OWNER. QUANTITIES SHALL BE GIVEN TO THE ARCHITECT, OWNER AND SITE DESIGN PROFESSIONAL.
- IF AMOUNT OF SCREENED TOPSOIL STOCKPILED FROM STRIPING OPERATIONS IS INSUFFICIENT TO provide the necessary amounts (4" minimum depth), it shall be the contractor's RESPONSIBILITY TO OBTAIN (FROM OFF-SITE SOURCE) THE NECESSARY AMOUNT OF SCREENED TOPSOIL TO COMPLETE THE PROJECT.
- SCREENED TOPSOIL SHALL BE DISTRIBUTED WITH A MINIMUM DEPTH OF FOUR (4) INCHES TO ALL GRADED AREAS (NOT INCLUDING BUILDING, PAVED, SYNTHETIC TURF, PERVIOUS PAVEMENT, ETC.) AND / Or as directed by the owner or owner's representative. Ground shall be scarified before PLACING TOPSOIL. AREAS WHERE SCREENED TOPSOIL IS DISTRIBUTED SHALL BE STABILIZED WITH TEMPORARY AND/OR PERMANENT VEGETATION (SEASON DEPENDENT) OR TEMPORARY MULCH WITHIN FOURTEEN (14) CALENDAR DAYS OF DISTRIBUTION.

TURF AND GRASSING NOTES:

- AFTER TOPSOIL HAS BEEN INSTALLED, AND BEFORE ANY SOD IS LAID, CORRECT ALL SOFT SPOTS AND IRREGULARITIES IN GRADE. THE SOD SHALL BE BE LAID BY BUTTING THE ENDS AND SIDES UP EVENLY AND STAGGERING THE ROLLS OF SOD. CONTRACTOR SHALL NOT OVERLAP SOD. AS SOON AS THE SOD IS LAID OR AS IT IS BEING LAID ROLL OVER WITH A LIGHT ROLLER, MAKING CERTAIN THAT ALL OF THE SOD IS IN CONTACT WITH THE SOIL. THE COMPLETED SODDED AREAS SHALL BE TRUE TO FINISH GRADE, EVEN AND FIRM AT ALL POINTS.
- 2. UPON COMPLETION OF PLANTINGS ALL EXCESS SOIL STONES AND DEBRIS WHICH HAS NOT PREVIOUSLY BEEN CLEANED UP SHALL BE REMOVED FROM THE SITE AND DISPOSED OF AS DIRECTED BY THE **OWNER'S REPRESENTATIVE**
- 3. ALL LAWN AREAS THAT DO NOT SHOW SATISFACTORY GROWTH WITHIN (18) DAYS AFTER PLANTING SHALL BE RE-PLANTED AND RE-FERTILISZED AS SPECIFIED UNTIL A SATISFACTORY LAWN IS ESTABLISHED. THE LAWN SHALL BE CONSIDERED ESTABLISHED WHEN ITS REASONABLY FREE FROM WEED, GREEN IN APPEARANCE AND THE SPECIFIED GRASS IS VIGOROUS AND GROWING WELL ON EACH SQ. FT. OF LAWN
- LAWN SHALL BE PROTECTED AND MAINTAINED BY WATERING, MOWING, AND REPLANTING, OVERSEEING, AS NECESSARY FOR AS LONG AS IS NECESSARY TO ESTABLISH A UNIFORM STAND. SCATTERED BARE SPOTS, NONE OF WHICH IS LARGER THAN ONE SQ. FT., WILL BE ALLOWED UP TO MAXIMUM OF THREE PERCENT OF ANY LAWN AREA. IT SHALL BE THE RESPONSIBILITY OF THE CONTRACTOR TO REPAIR ANY EROSIONAL DAMAGE TO THE LAWN AREA. FULL COVERAGE IS REQUIRED
- MAINTENANCE OF GRASSED AREAS SHALL CONSIST OF MOWING, WATERING AND FERTILIZING. ALL GRASSED AREAS SHALL BE MAINTAINED AT A HEIGHT NOT TO EXCEED 6" ABOVE FINISHED GRADE.
- IT SHALL BE THE CONTRACTOR'S RESPONSIBILITY TO MAINTAIN ALL GRASSED AREAS UNTIL ACCEPTANCE BY OWNER AT END OF PROJECT. LAWN MAINTENANCE SHALL OCCUR AT A MINIMUM OF ONCE PER SEVEN CALENDAR DAYS.

IRRIGATION NOTES:

- CONTRACTOR TO SUPPLY AUTOMATIC IRRIGATION SYSTEM, COMPLETE AND INSTALLED. SYSTEM TO INCLUDE ALL VALVES, PIPES, HEADS, FITTINGS, BACK FLOW CONTROLLER, AND IRRIGATION METER AND TO PROVIDE 100% COVERAGE FOR ALL NEW PLANTINGS. DRIP IRRIGATION TO BE USED FOR ALL
- PLANTINGS, EXCEPT LAWNS. 2. NO IRRIGATION COMPONENTS SHALL BE CLOSER THAN 12" TO ANY EDGE OF PAVEMENT OR CURB AND GUTTER. IRRIGATION SHALL NOT SPRAY BEYOND LANDSCAPED AREAS, OR INTO ANY UNDISTURBED BUFFERS. NO OVER SPRAY SHALL BE PERMITTED ONTO ADJACENT PROPERTIES OR PEDESTRIAN SIDEWALK AREAS.
- 3. LANDSCAPE CONTRACTOR TO FIELD VERIFY ALL COMPONENT LOCATIONS TO ENSURE APPROPRIATE COVERAGE.
- LANDSCAPE CONTRACTOR SHALL LOCATE WATER SOURCE AND PROVIDE POWER TO CONTROLLER. CONTROLLER LOCATION TO BE SPECIFIED BY OWNERS REPRESENTATIVE IN FIELD PRIOR TO
- CONSTRUCTION.
- ALL DRIP TUBING SHALL BE COVERED WITH MIN. 3" OF MULCH.
- ALL DRIP AND SPRAY ZONES SHALL BE SEPARATE. CONTRACTOR SHALL SUBMIT FINAL IRRIGATION PLANS TO OWNER'S REPRESENTATIVE AND ALL REVIEWING BODIES / AGENCIES FOR FINAL APPROVAL PRIOR TO INSTALLATION.

SHEET INDEX

- CS COVER SHEET AND PROJECT NOTES
- L1 SWPP PLAN
- L2 KEY SHEET AND LAYOUT PLAN
- L3 GRADING PLAN
- L4 LIGHTING AND PLANTING PLAN
- L5 PLANT SCHEDULE AND DETAILS
- L6 SITE DETAILS 01
- L7 SITE DETAILS 02

ISSUED: MAR 11, 2024 **REVISIONS:**

PROJECT TEAM

01 - JUL 08, 2025

LANDSCAPE ARCHITECT WITMER JONES KEEFER

BLUFFTON, SC (843) 757.7411

ARCHITECTURE

ALL ARCHITECTURAL INFORMATION WAS TAKEN FROM DIGITAL FILES PROVIDED BY:

COURT ATKINS ARCHITECTS BLUFFTON, SC (843) 815.2557

SURVEYING

ALL TOPOGRAPHY, EXISTING TREES, SITE BOUNDARY, SITE SURVEY DATA, ETC. WERE TAKEN FROM DIGITAL FILES PROVIDED BY:

T SQUARE SURVEYING BLUFFTON, SC (843) 757.2650

PROJECT REQUIREMENTS

SITE COVERAGE					
IMPERVIOUS COVERAGE ACTUAL COVERAGE (SF)					
BUILDING FOOTPRINT(S)	5,386				
IMPERVIOUS HARDSCAPE (TABBY CONCRETE, SPORT COURT)	3,875				
SAND SET BRICK (50%) (193 SF/2 = 96.5)	97				
TOTAL IMPERVIOUS	9,358				
HOMESITE SF TOTAL	25,601				
% SITE COVERAGE	36.5%				

ones.

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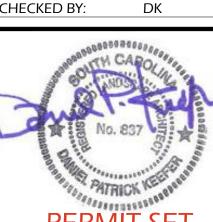
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****CAUTION****

MAR 11, 2024 PROJECT NO.: 18-083-01 DRAWN BY: JM / AS


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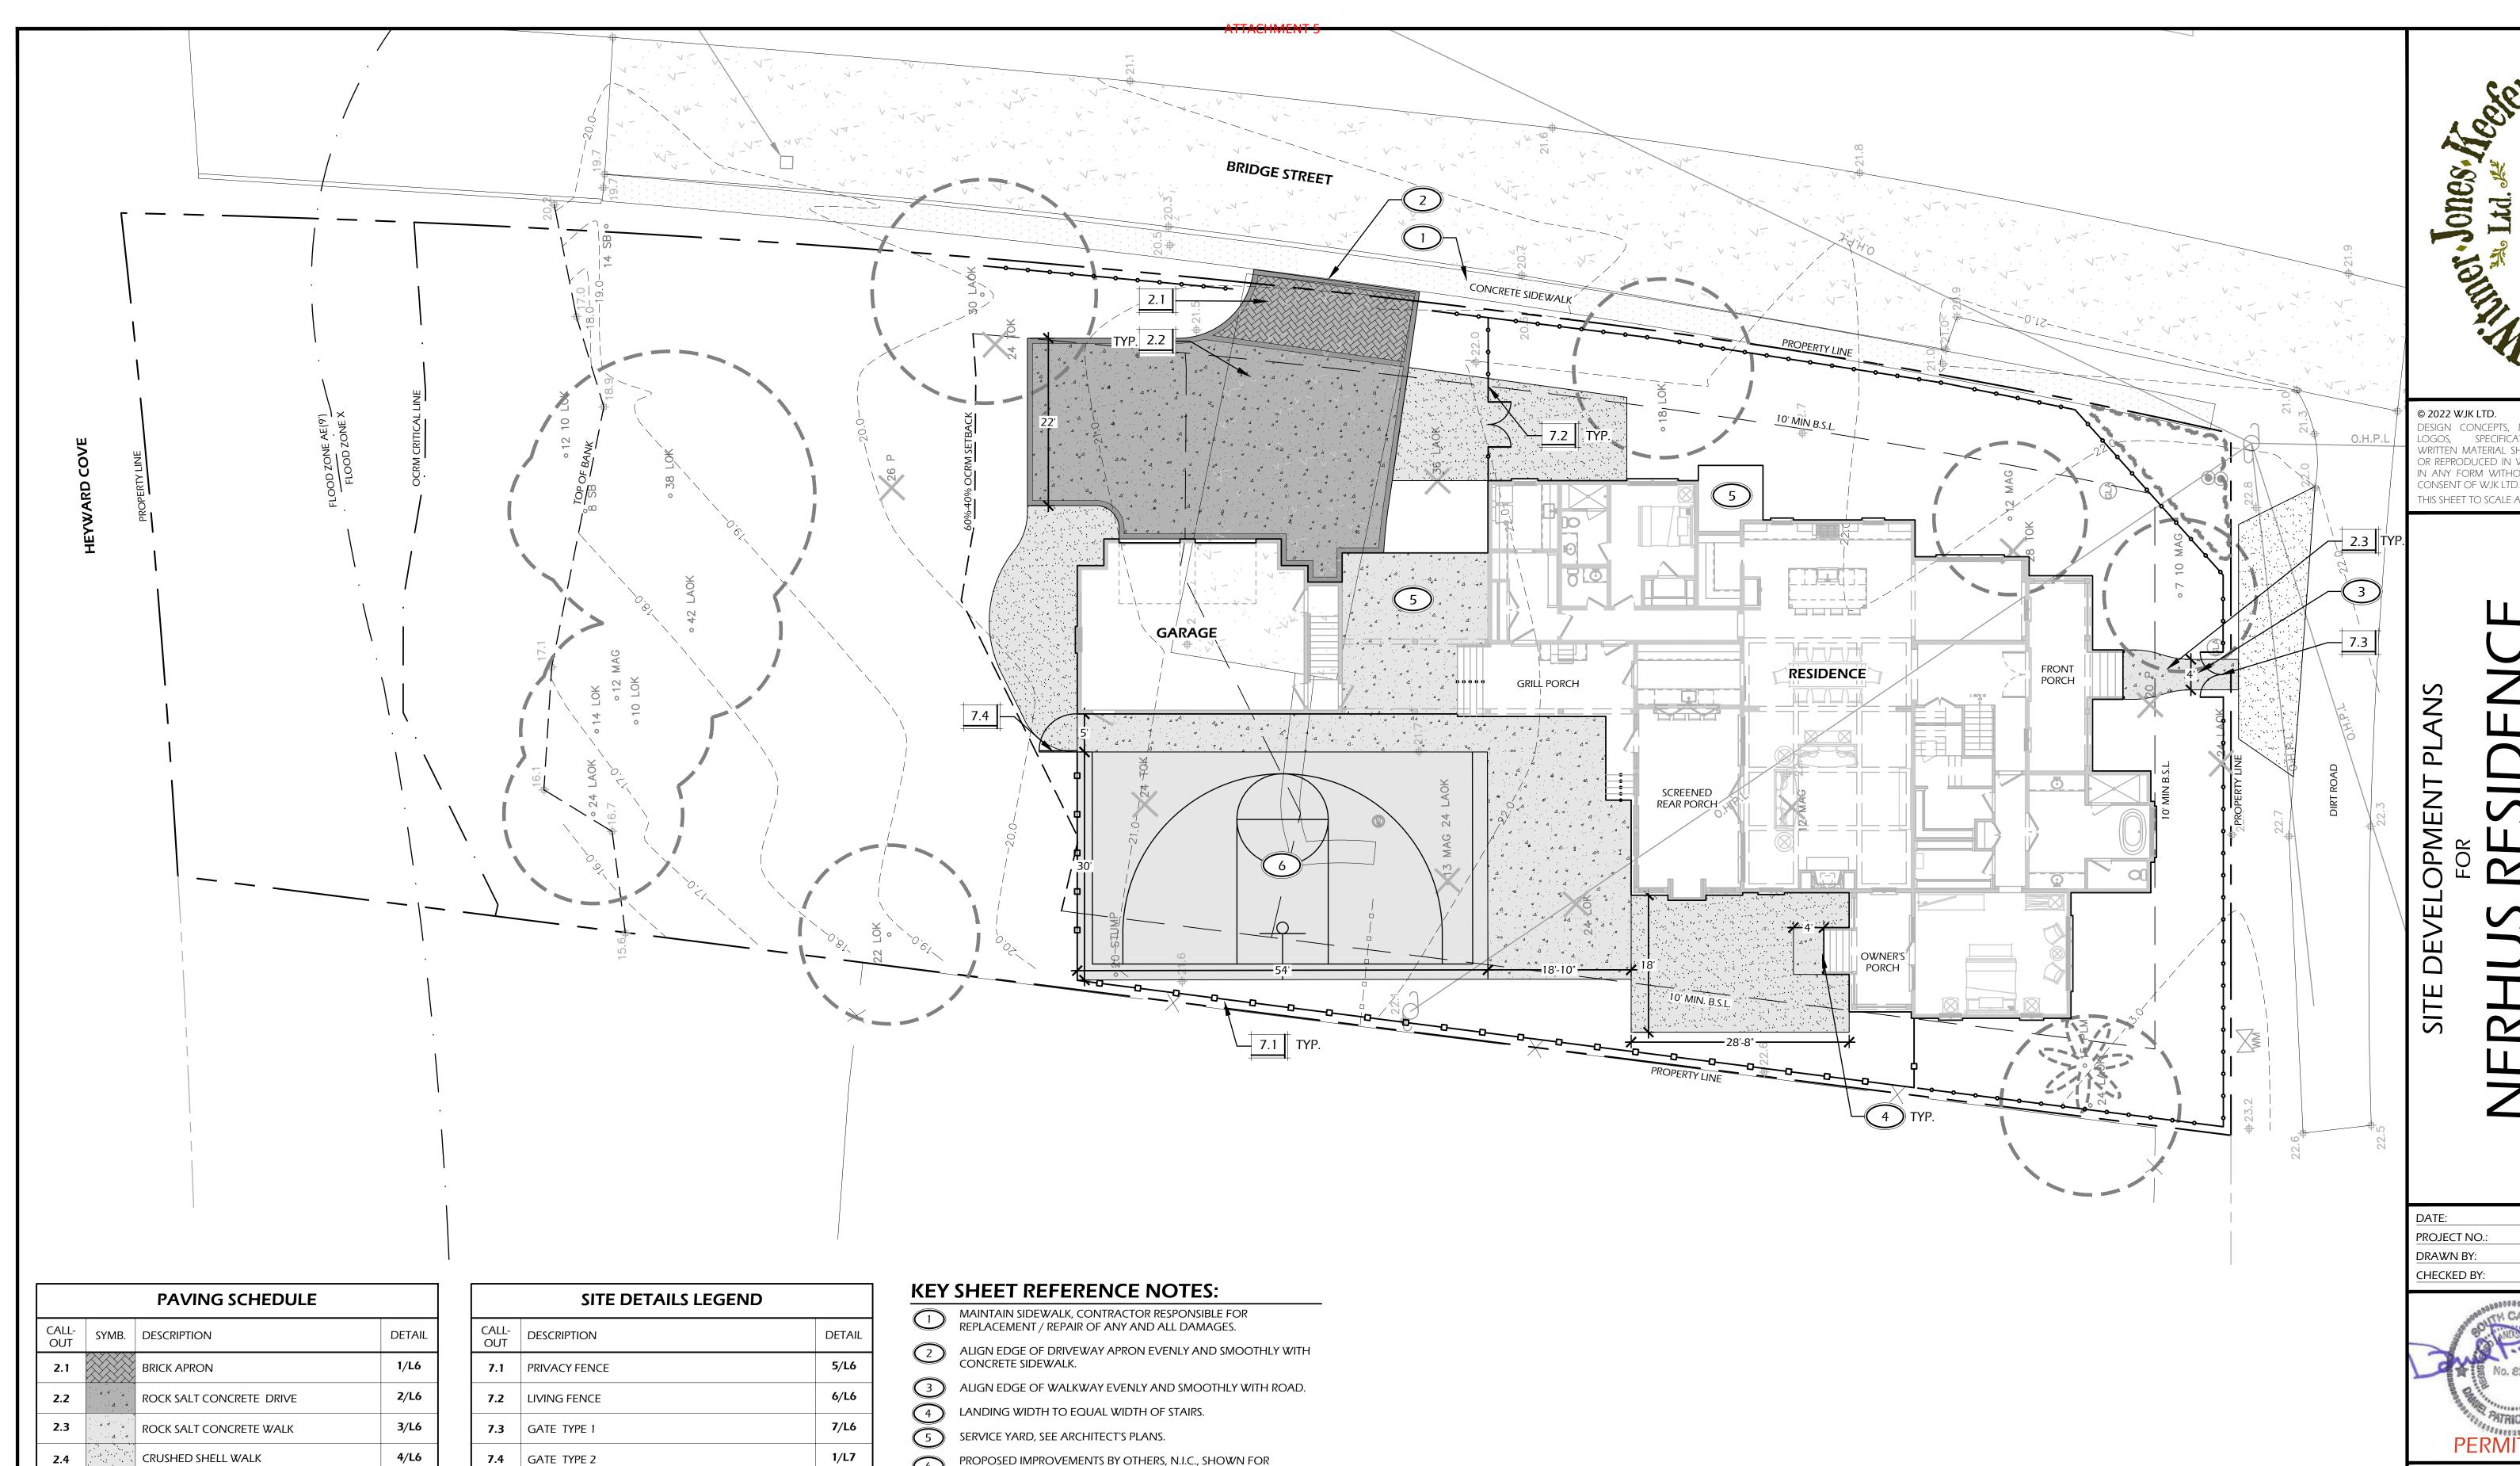


REVISIONS: 07-08-2025 REVISION - 01

DRAWING TITLE **COVER SHEET AND**

PROJECT NOTES




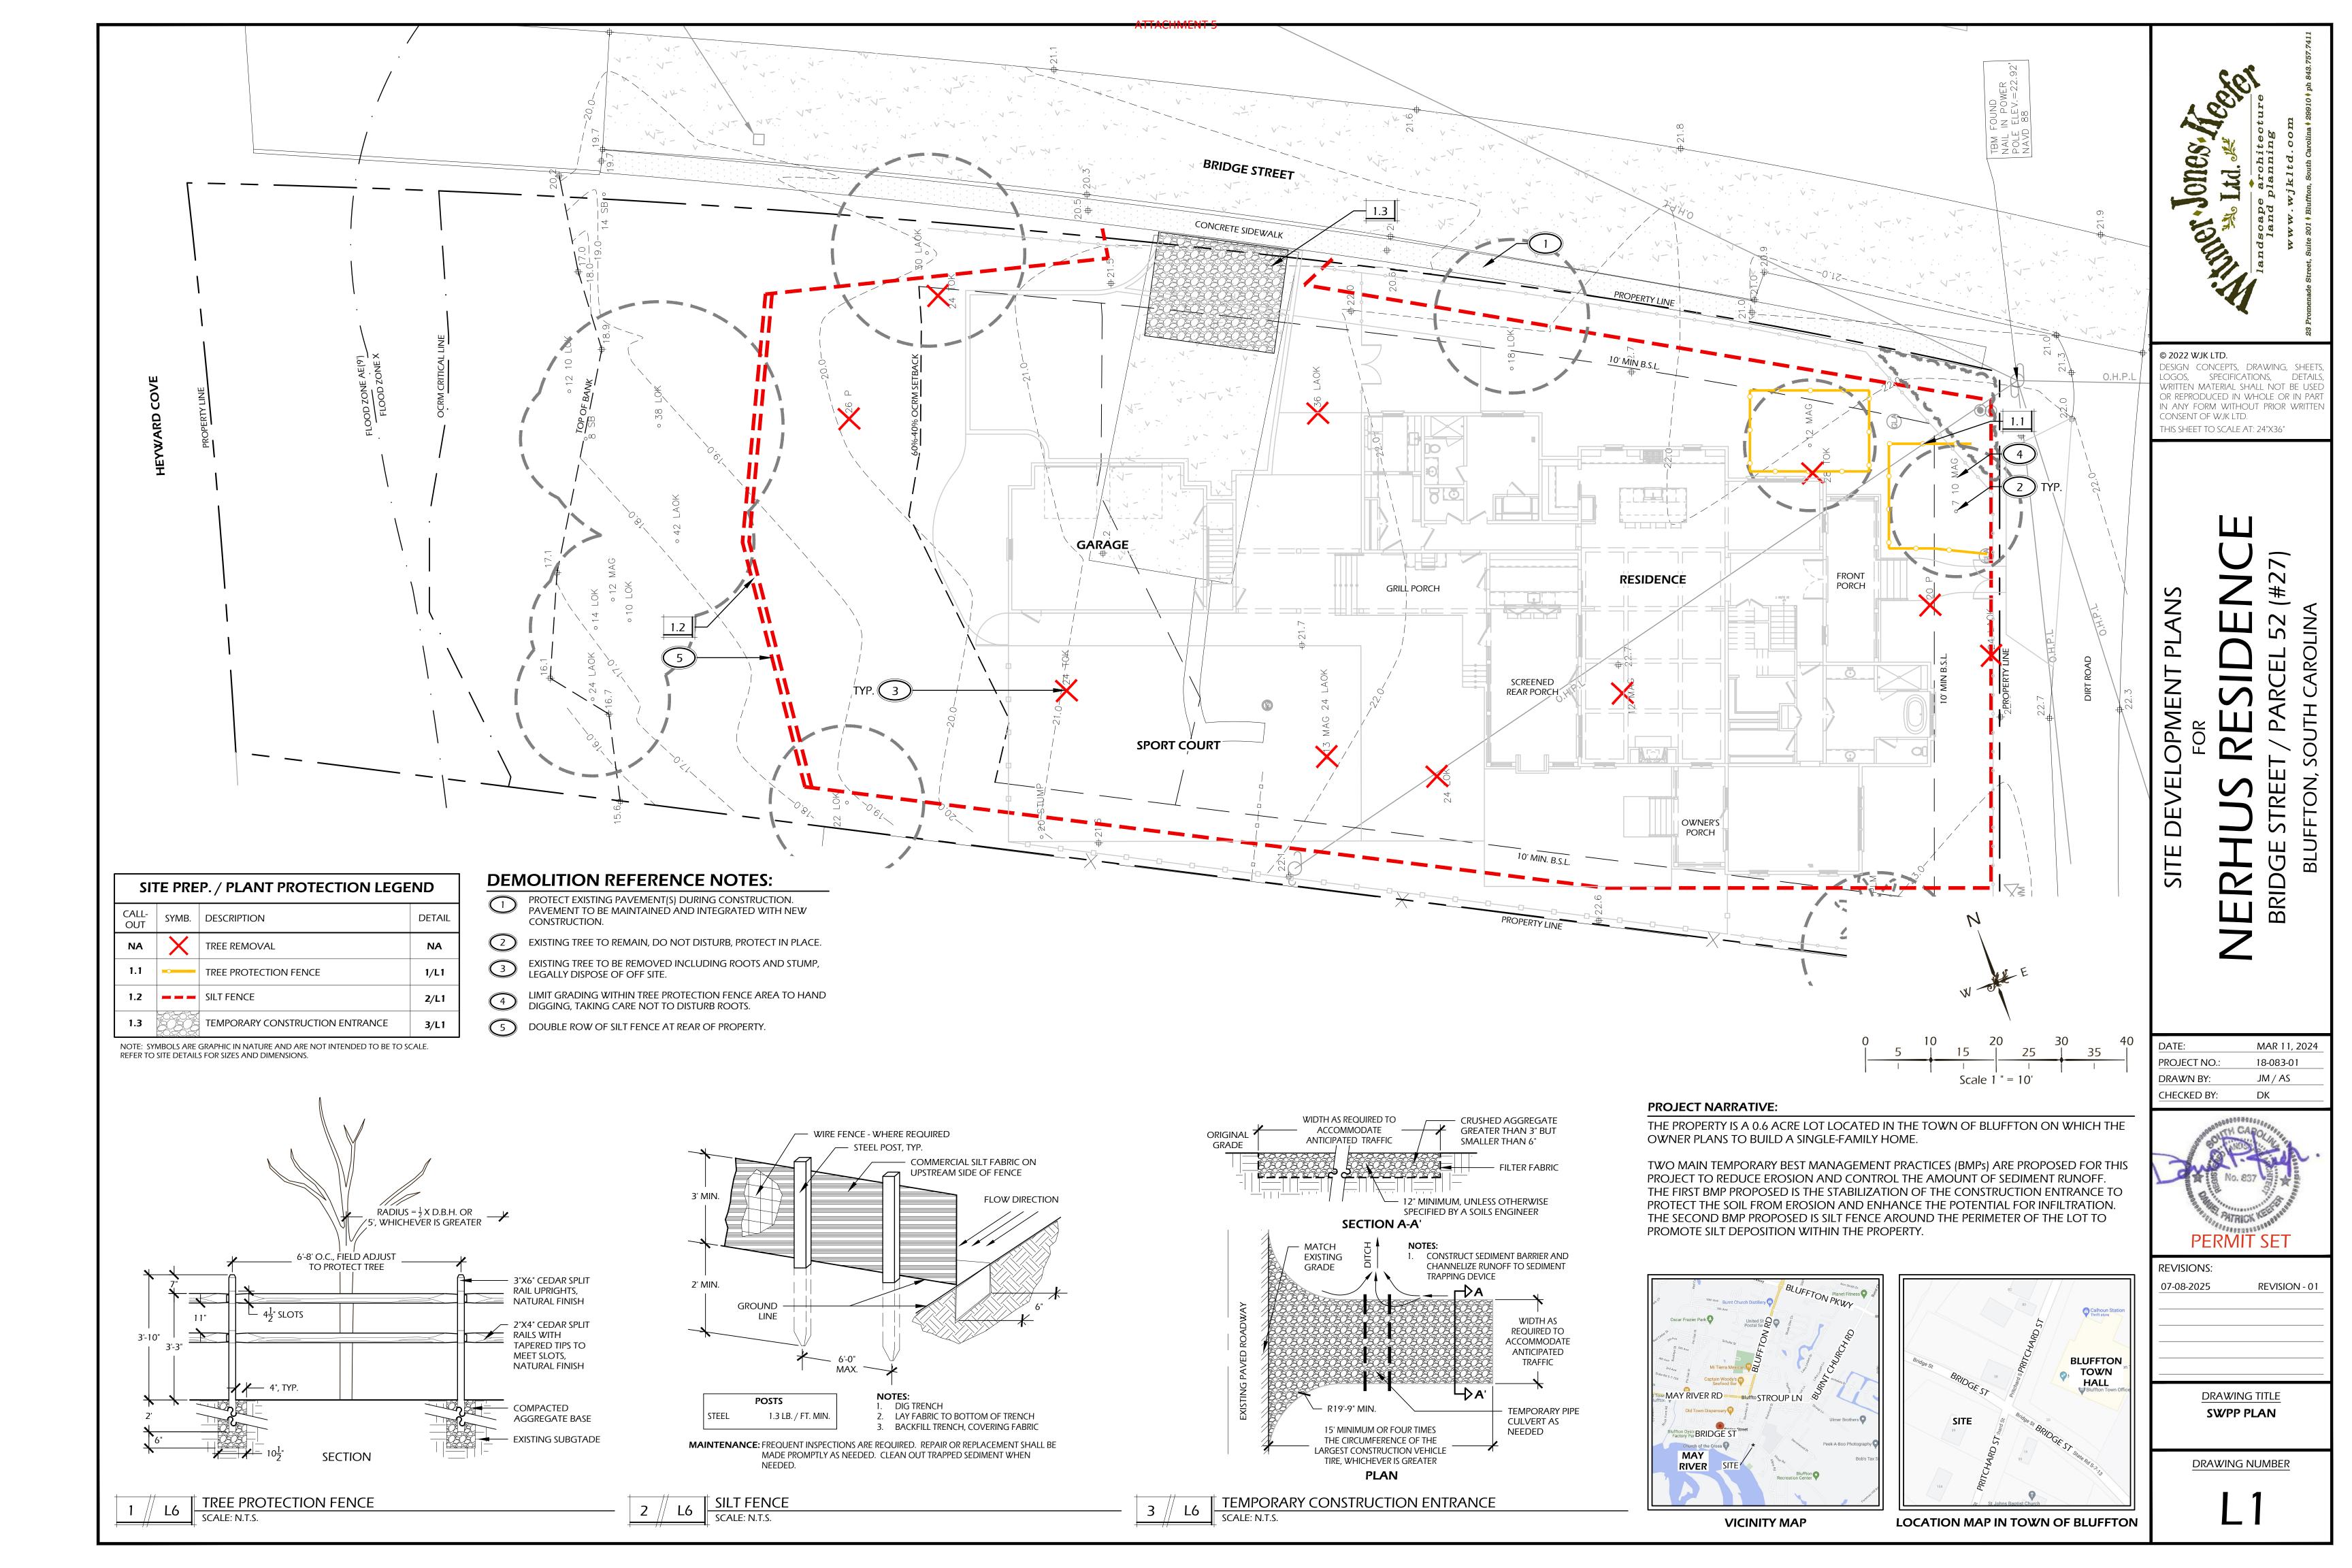

CRUSHED SHELL WALK 2.4 BORDERS, REFER TO DETAILS 1/L6, NA

NOTE: MATERIAL SYMBOLS / HATCHES ARE GRAPHIC IN NATURE AND ARE NOT INTENDED TO BE TO SCALE. REFER TO SITE DETAILS AND LAYOUT PLANS FOR SIZES AND DIMENSIONS.

PROPOSED IMPROVEMENTS BY OTHERS, N.I.C., SHOWN FOR REFERENCE ONLY (SPORT COURT).

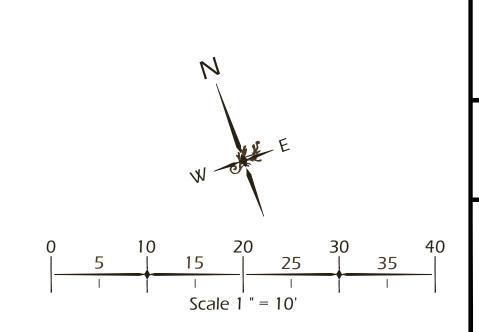

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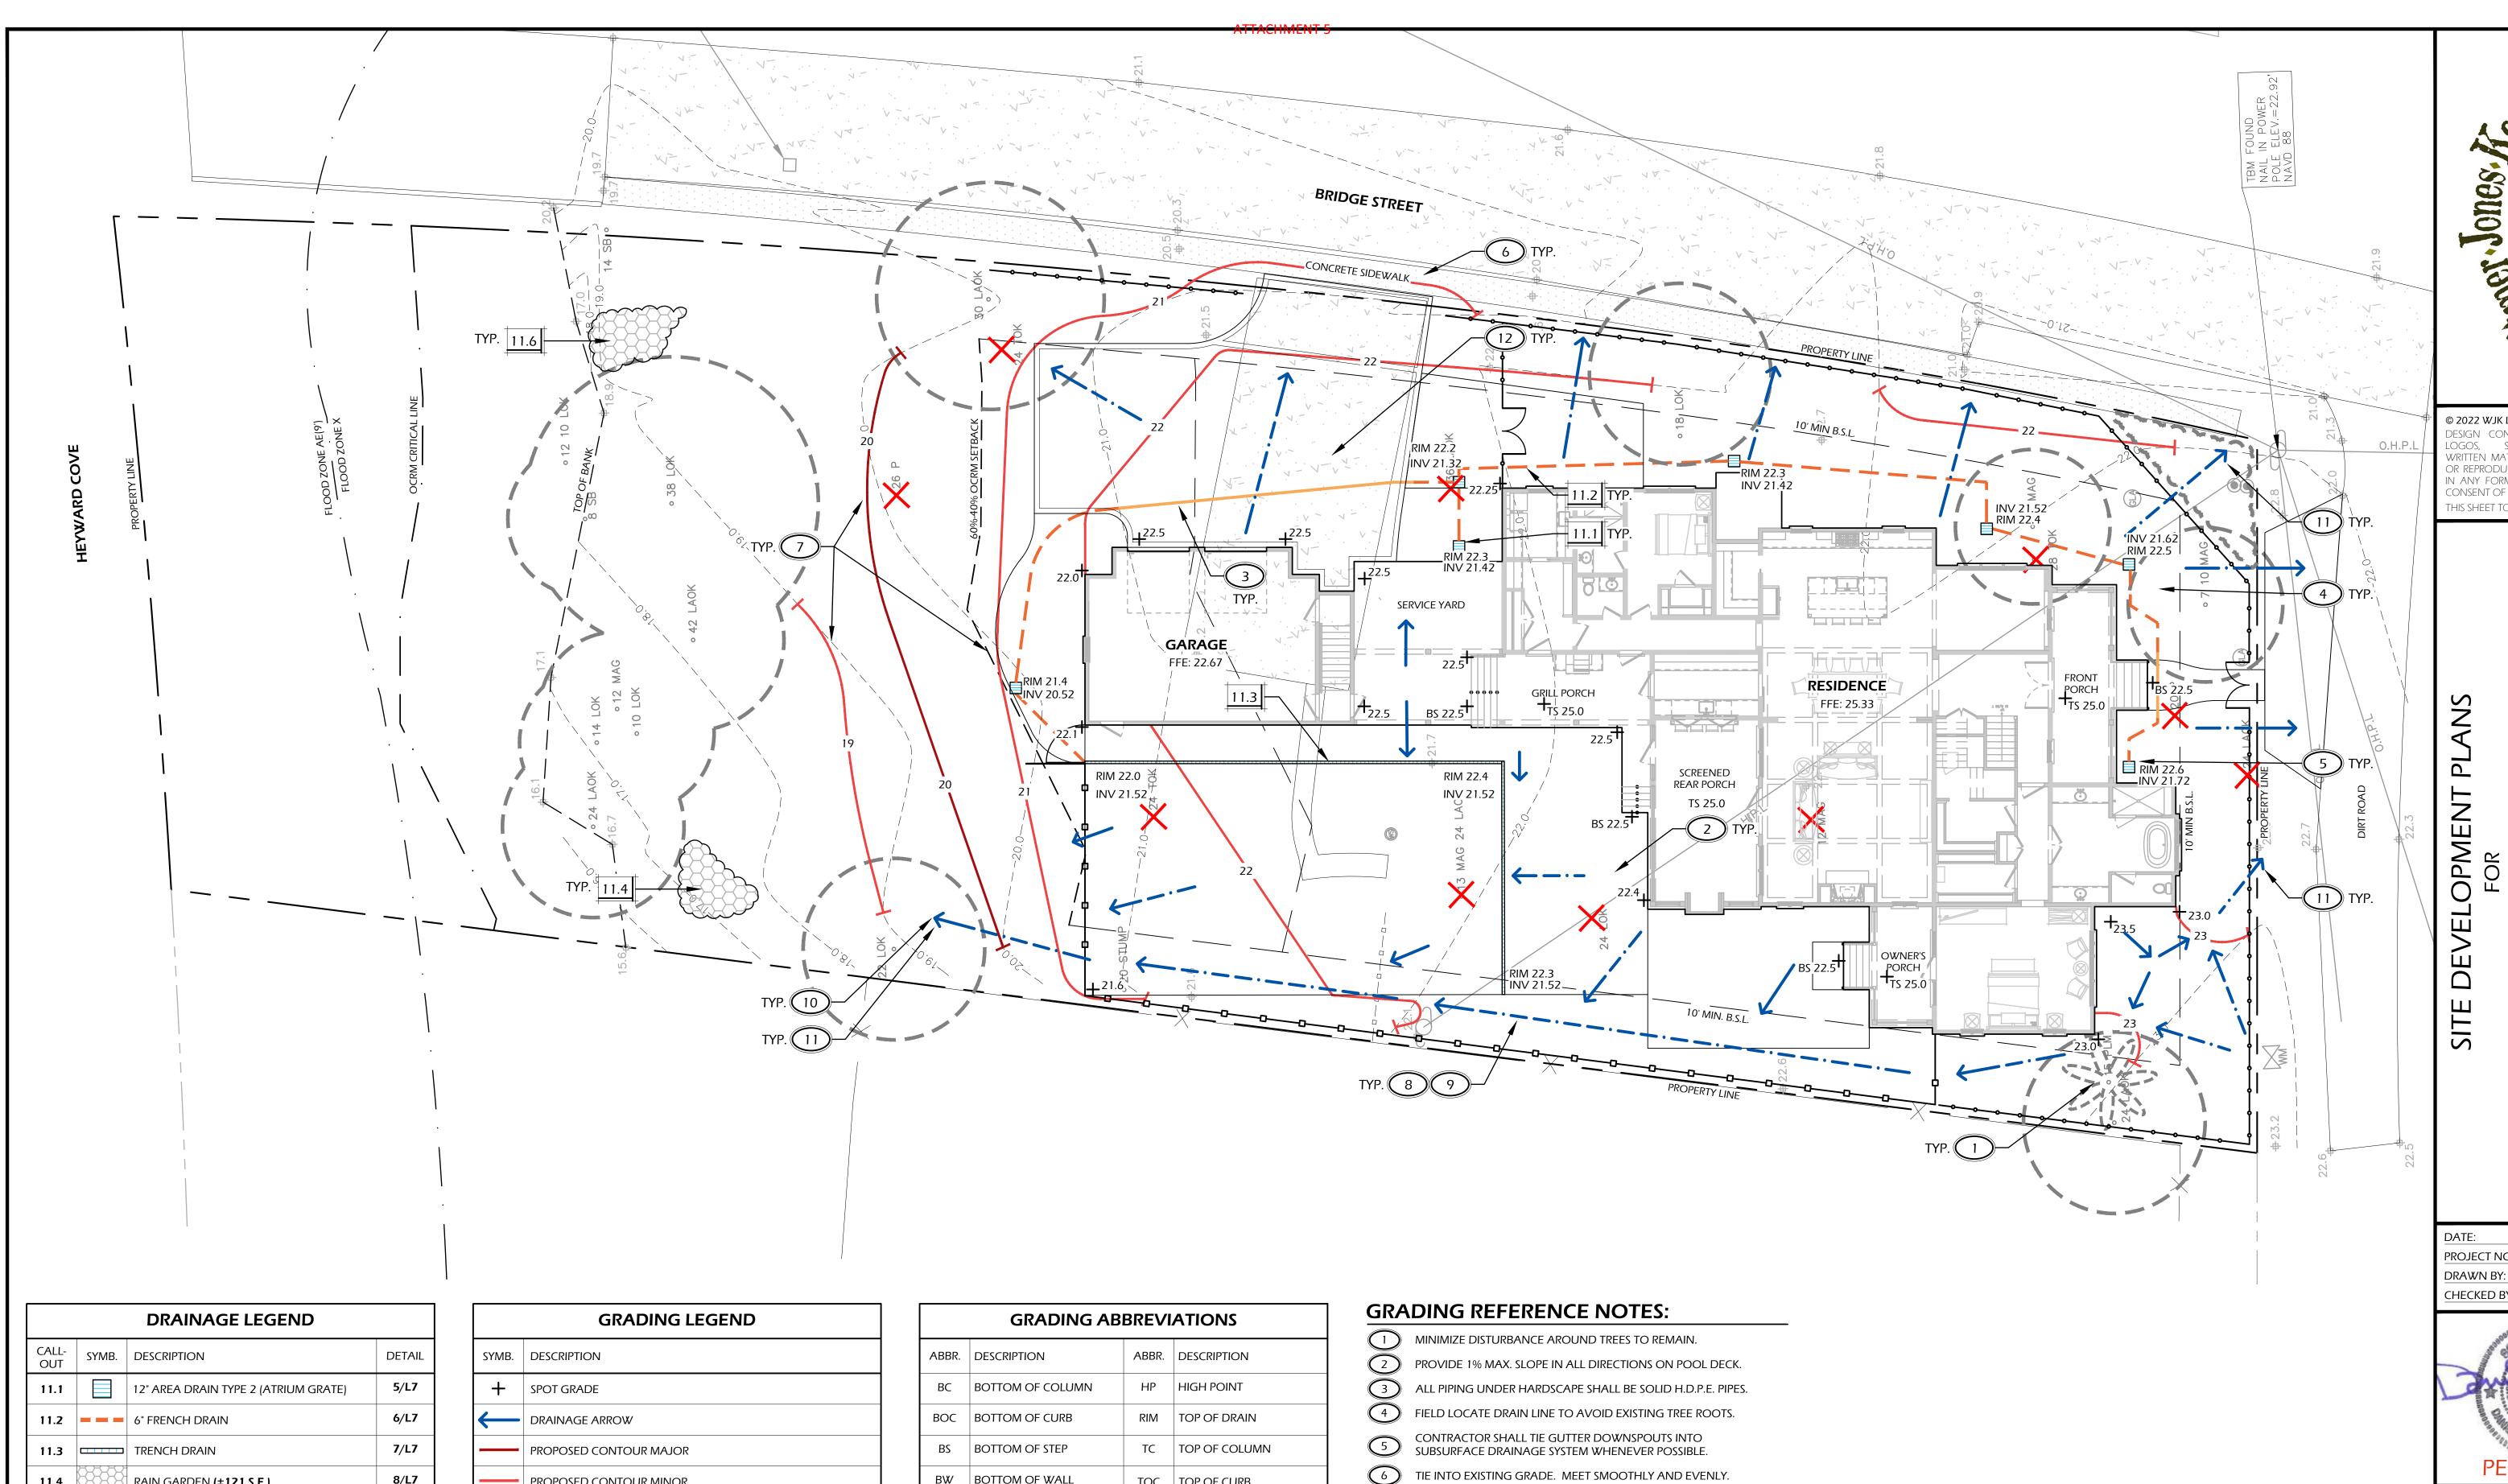
MAR 11, 2024 PROJECT NO.: 18-083-01 DRAWN BY: JM/AS



REVISIONS:

07-08-2025 **REVISION - 01**

> DRAWING TITLE **KEY SHEET AND** LAYOUT PLAN



DRAINAGE LEGEND				
CALL- OUT	SYMB.	DESCRIPTION	DETAIL	
11.1		12" AREA DRAIN TYPE 2 (ATRIUM GRATE)	5/L7	
11.2		6" FRENCH DRAIN	6/L7	
11.3		TRENCH DRAIN	7/L7	
11.4		RAIN GARDEN (±121 S.F.)	8/L7	

NOTE: DRAINAGE SYMBOLS ARE GRAPHIC IN NATURE AND ARE NOT INTENDED TO BE TO SCALE. REFER TO SITE DETAILS FOR SIZES AND DIMENSIONS. **IF NOT LOCATED ON PLAN** AND SUB SURFACE DRAINAGE IS NEEDED, CONTRACTOR SHALL SUPPLY AREA DRAINS, FRENCH DRAINS AND DRY WELLS AS REQUIRED TO PROMOTE PROPER STORMWATER DRAINAGE (REFER TO DRAINAGE DETAILS, SHEET L7, L8)

	GRADING LEGEND				
SYMB.	DESCRIPTION				
+	SPOT GRADE				
\leftarrow	DRAINAGE ARROW				
	PROPOSED CONTOUR MAJOR				
	PROPOSED CONTOUR MINOR				
	EXISTING GRADE				

GRADING ABBREVIATIONS					
ABBR.	DESCRIPTION	ABBR.	DESCRIPTION		
ВС	BOTTOM OF COLUMN	HP	HIGH POINT		
ВОС	BOTTOM OF CURB	RIM	TOP OF DRAIN		
BS	BOTTOM OF STEP	TC	TOP OF COLUMN		
BW	BOTTOM OF WALL	TOC	TOP OF CURB		
FFE	FINISHED FLOOR ELEVATION	TS	TOP OF STEP		
FG	FINISHED GRADE	TW	TOP OF WALL		
LP	LOW POINT	INV	INVERT OF DRAIN		

FEATHER BOTTOM OF SLOPE SMOOTHLY TO MEET EXISTING CONDITIONS.


CREATE SWALE AND BERM TO DIRECT WATER AWAY FROM HOUSE AND ADJACENT PROPERTIES.

9 DRAINAGE SWALE PITCH AT 2% MIN.

PROVIDE POSITIVE DRAINAGE AWAY FROM BUILDING AND ADJACENT PROPERTY LINES.

DIRECT STORMWATER TOWARDS STREET OR EXISTING DRAINAGE DITCH, DRAINAGE SHALL NOT BE DIRECTED TOWARDS ADJACENT PROPERTY. CONTRACTOR SHALL PROVIDE SUPPLEMENTAL AREA DRAINS, FRENCH DRAINS, AND DRY WELLS AS REQUIRED TO PROMOTE PROPER STORMWATER DRAINAGE, REFER TO SITE DETAILS.

GENERAL CONTRACTOR SHALL PROVIDE STRUCTURAL SUBGRADE FOR DRIVEWAY. CONTRACTOR SHALL ADJUST GRADES TO PROVIDE POSITIVE DRAINAGE TO ROADWAY AND NATURAL

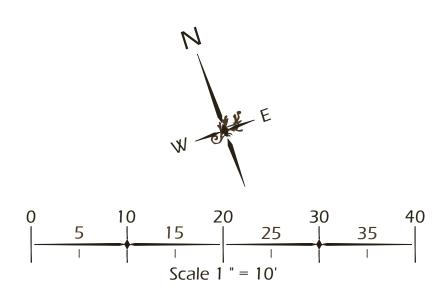



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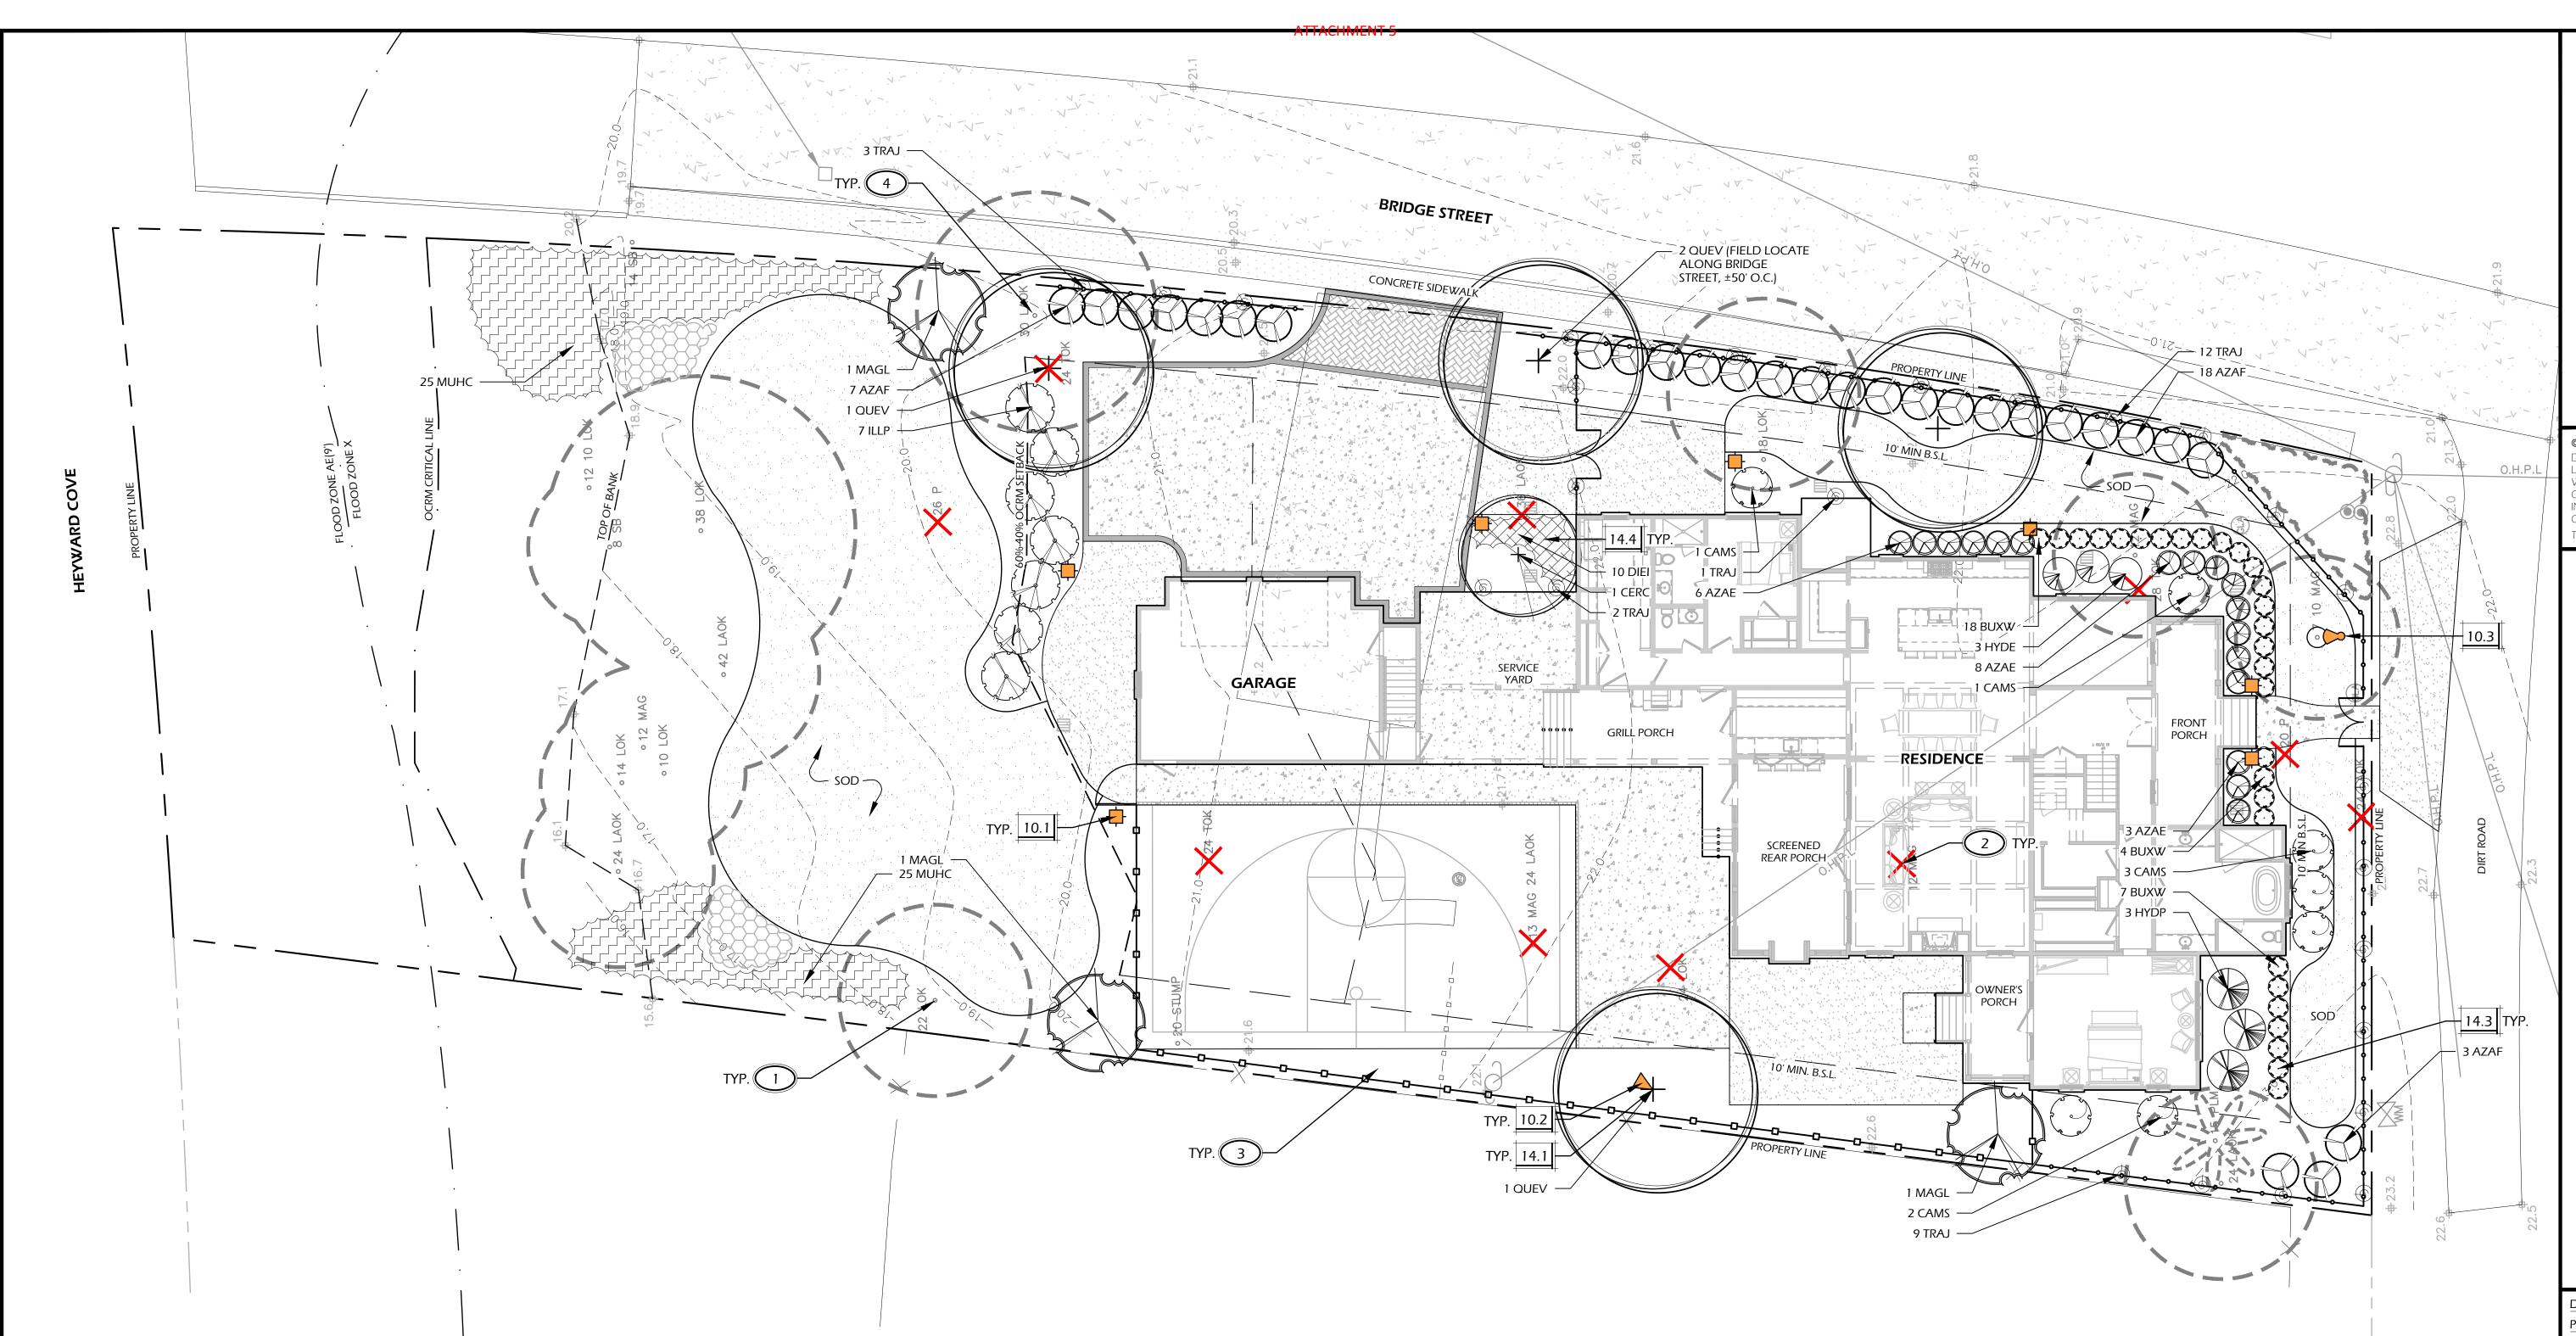
MAR 11, 2024 PROJECT NO.: 18-083-01

JM / AS

CHECKED BY: DK

REVISIONS: 07-08-2025 **REVISION - 01**

DRAWING TITLE **GRADING PLAN**



PLANTING DETAILS				
CALL- OUT	DESCRIPTION	DETAIL		
14.1	TREE PLANTING	1/L5		
14.2	PALM TREE PLANTING	2/L5		
14.3	SHRUB PLANTING	3/L5		
14.4	GROUND COVER PLANTING	4/L5		

		LIGH	HTING SCHEDULE	
CALL- OUT	SYMB.	QTY.	DESCRIPTION	DETAIL
10.1		7	PATH LIGHT	2/L7
10.2	\bigvee	1	DOWN LIGHT	3/L7
10.3	8	1	UP LIGHT	4/L7

NOTE: LIGHTING SYMBOLS ARE GRAPHIC IN NATURE AND ARE NOT INTENDED TO BE TO SCALE. REFER TO SITE DETAILS FOR SIZES AND DIMENSIONS.

PLANTING REFERENCE NOTES:

1 EXISTING TREES TO REMAIN.


2 EXISTING TREES TO BE REMOVED.


MULCH DISTURBED AREAS DUE TO CONSTRUCTION.

CAREFULLY EXCAVATE PLANTING PITS IN VICINITY OF EXISTING TREES, WITHOUT DISTURBING TREE ROOTS.

PLANT KEY LEGEND

Abbrev	<u>Botanical Name</u>	Common Name
TREES		
QUEV	Quercus virginiana	Live Oak
UNDERSTOR	Y TREES	
CERC	Cercis canadensis	Eastern Redbud
MAGL	Magnolia grandiflora 'Little Gem'	Little Gem Magnolia
SHRUBS		
AZAE	Azalea x encore	Encore Azalea
AZAF	Azalea indica 'Formosa'	Formosa Azalea
BUXW	Buxus microphylla 'Wintergreen'	Wintergreen Boxwood
CAMS	Camellia sasanqua	Sasanqua Camellia
HYDE	Hydrangea macrophylla 'Endless Summer"	Endless Summer Hydrangea
HYDP	Hydrangea paniculata 'Limelight'	Limelight Hydrangea
ILLP	Illicium parviflorum	Yellow Anise
ORNAMENTA	AL GRASSES & FERNS	
MUHC	Muhlenbergia capillaris	Pink Muhly Grass
GROUND CO	OVERS, VINES & PERENNIALS	
DIEI	Dietes iridioides	White African Iris
TRAJ Trachelospermum jasminoides		Confederate jasmine

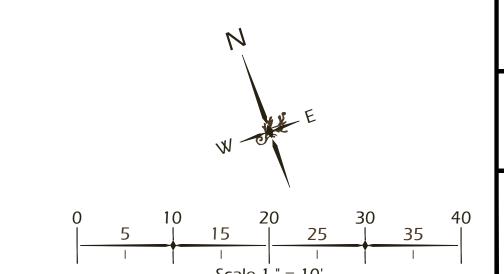

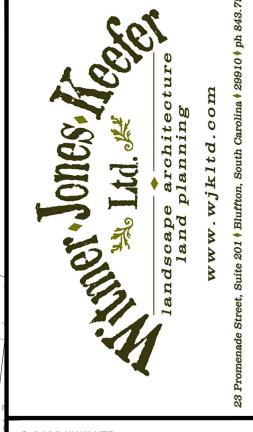

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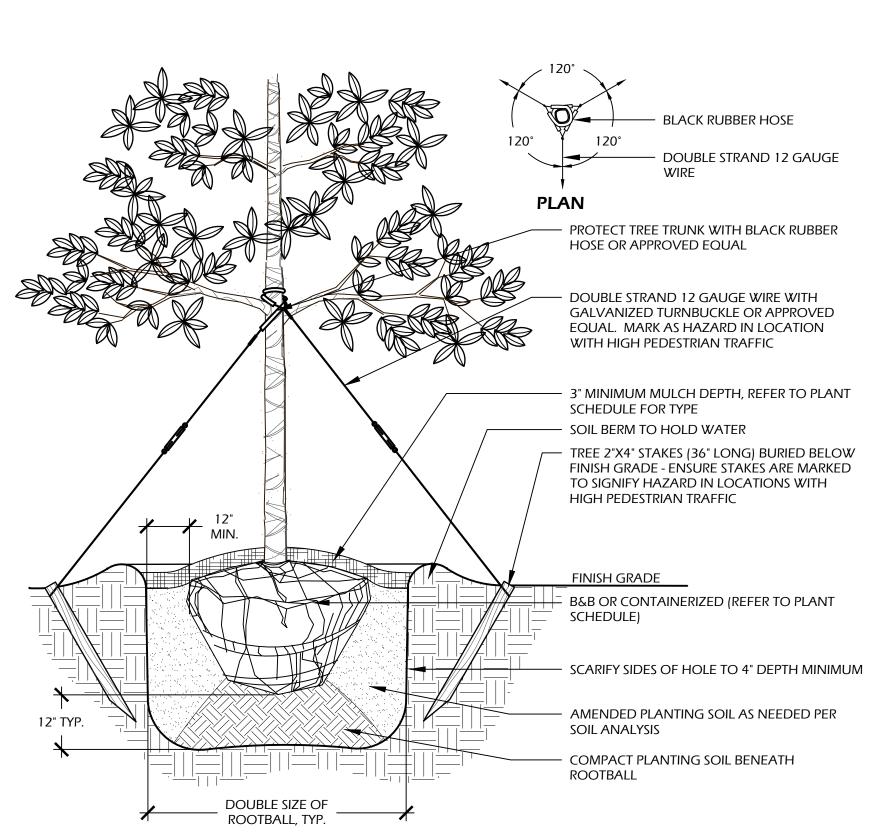
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DRAWING TITLE LIGHTING AND PLANTING PLAN




NOTES:

- 1. TREE STAKING OPTIONAL, HOWEVER, LANDSCAPE CONTRACTOR RESPONSIBLE FOR MAINTAINING TREES IN AN UPRIGHT (90 DEGREE/PERPENDICULAR) POSITION FOR 1 YEAR AFTER PLANTING IS COMPLETE OR UNTIL TREE ROOT SYSTEM IS FULLY ESTABLISHED AND STURDY.
- FINAL TREE STAKING DETAILS AND PLACEMENT TO BE APPROVED BY OWNER'S REPRESENTATIVE.

 2. CONTRACTOR SHALL ASSURE PERCOLATION OF ALL PLANTING PITS PRIOR TO INSTALLATION.
- 3. IN SEMI-IMPERVIOUS SOIL CONDITIONS, ROOTBALL ELEVATION SHALL BE 2" ABOVE FINISH GRADE. COORDINATE WITH OWNER'S

REPRESENTATIVE PRIOR TO SETTING ROOTBALL ELEVATIONS.

1 // I5 TREE PLANTING

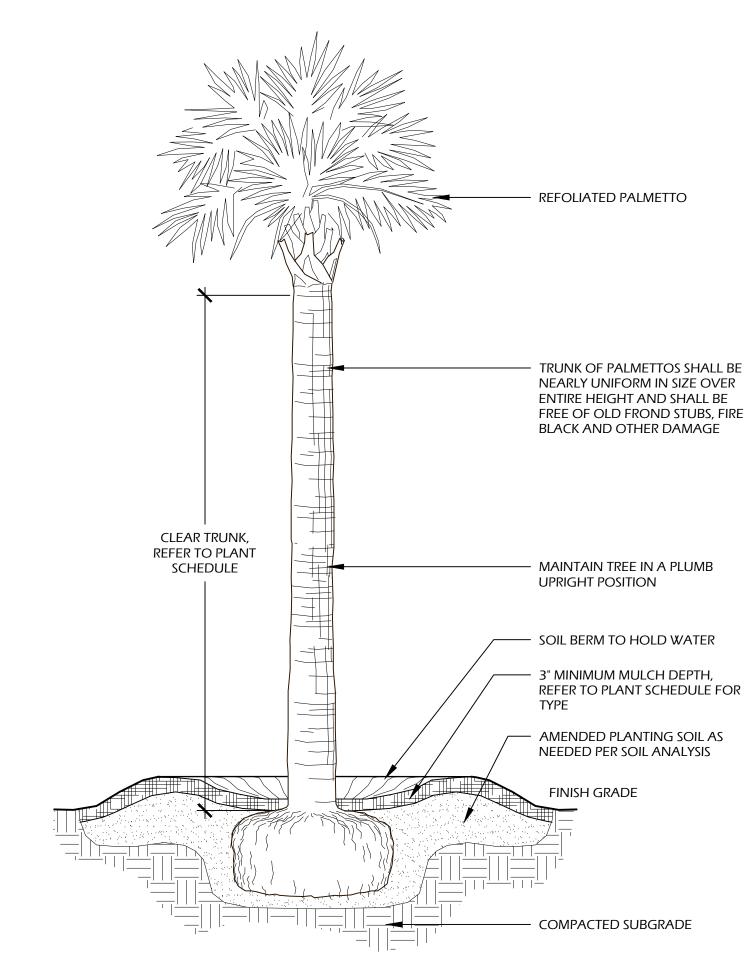

NOTES:

- 1. FINAL TREE STAKING DETAILS AND PLACEMENT TO BE APPROVED BY OWNER OR OWNER'S REPRESENTATIVE,
- CONTRACTOR SHALL ASSURE PERCOLATION OF ALL PLANTING PITS PRIOR TO INSTALLATION.
 SABAL PALMETTOS SHALL BE REFOLIATED, PROTECT CABBAGE HEAD FROM DAMAGE.

2 // L5

PALM TREE PLANTING

NOTES: 1. WHEN GROUNDCOVERS AND SHRUBS ARE USED IS MASSES, ENTIRE BED TO BE EXCAVATED TO RECEIVE PLANTING SOIL AND

OOUBLE SIZE OF ROOTBALL, TYP.

CONTRACTOR SHALL ASSURE PERCOLATION OF ALL PLANTING PITS PRIOR TO INSTALLATION.
 IN SEMI-IMPERVIOUS SOIL CONDITIONS, ROOTBALL ELEVATION SHALL BE ±2" ABOVE FINISH GRADE. COORDINATE WITH OWNER'S REPRESENTATIVE PRIOR TO SETTING ROOTBALL ELEVATIONS.

3" MINIMUM MULCH DEPTH, REFER TO PLANT SCHEDULE FOR

- SOIL BERM TO HOLD WATER


B&B OR CONTAINERIZED (SEE PLANTING SCHEDULE, THIS SHEET)

AMENDED PLANTING SOIL AS NEEDED PER SOIL ANALYSIS

- FINISH GRADE

3 / L5 | SHRUB PLANTING

4" TYP.

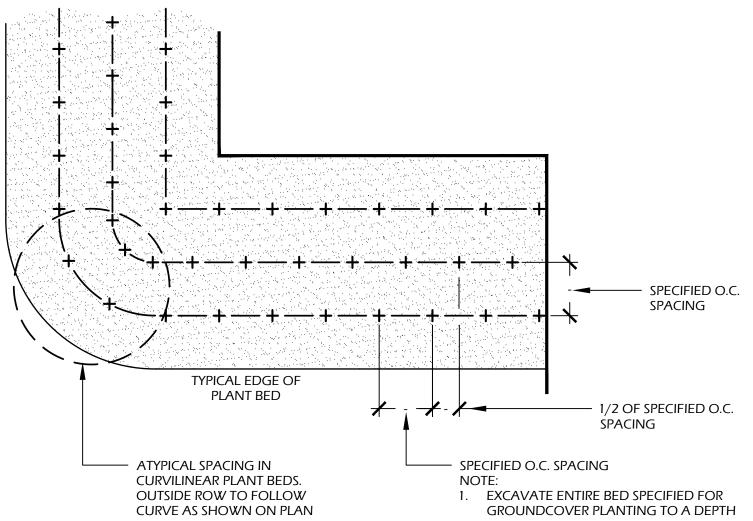


GROUND COVER PLANTING

SCALE: NITS

PLANT SCHEDULE:

Quantity	Abbrev	Botanical Name	Common Name	Height	Spread	Container	Cal,/Spacing	<u>Notes</u>
TREES								
4	QUEV	Quercus virginiana	Live Oak	14'-16'	6'-8'	Cont.	4"	Full
UNDERSTOR	Y TREES							
1	CERC	Cercis canadensis	Eastern Redbud	8'-10'	6'-8'	30 gal.	_	Full
3	MAGL	Magnolia grandiflora 'Little Gem'	Little Gem Magnolia	8'-10'	4'-5'	30 gal.	-	Full
SHRUBS								
17	AZAE	Azalea x encore	Encore Azalea	24"-30"	24"-30"	7 gal.	-	Full
28	AZAF	Azalea indica 'Formosa'	Formosa Azalea	30"-36"	24"-30"	7 gal.	1 <u>2</u> 10	Full
29	BUXW	Buxus microphylla 'Wintergreen'	Wintergreen Boxwood	12"-18"	12"-18"	7 gal.	-	Full
7	CAMS	Camellia sasanqua	Sasanqua Camellia	3'-4'	2'-3'	15 gal.	-	Full
3	HYDE	Hydrangea macrophylla 'Endless Summer"	Endless Summer Hydrangea	24"-30"	24"-30"	7 gal.	-	Full
3	HYDP	Hydrangea paniculata 'Limelight'	Limelight Hydrangea	24"-30"	24"-30"	7 gal.	-	Full
7	ILLP	Illicium parviflorum	Yellow Anise	30"-36"	24"-30"	7 gal.	-	Full
ORNAMENT/	AL GRASSES &	FERNS						
50	MUHC	Muhlenbergia capillaris	Pink Muhly Grass	14"-16"	10"-16"	1 gal.	30" O.C.	Full
GROUND CO	OVERS, VINES &	& PERENNIALS						
10	DIEI	Dietes iridioides	White African Iris	12"-18"	8"-12"	1 gal.	24" O.C.	Full
27	TRAJ	Trachelospermum jasminoides	Confederate jasmine	4"-6"	12" runners	1 gal.	18" O.C.	Full
SOD & MULC	<u> </u> Н							
3,850	SOD-SF	=	Empire Zoysia Sod	-	-	(-)	-	-
8,050	MULCH-SF	Pine Straw - all disturbed areas	Pine Straw	-	-	-	-	-

TREE CANOPY DIAGRAM:

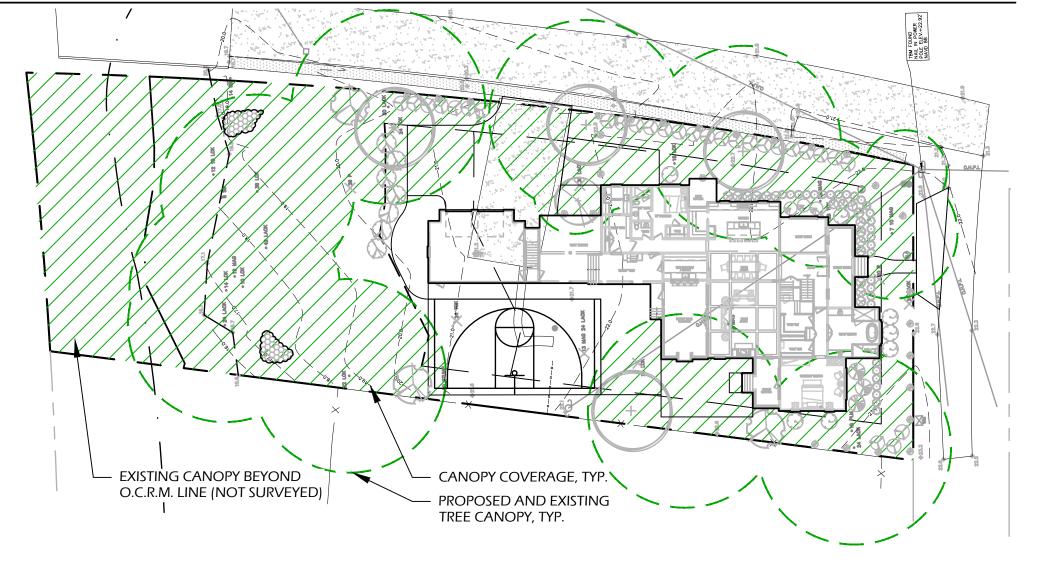



SCALE: 1" - 30'-0"

CANOPY COVERAGE TABLE				
DESCRIPTION	ACTUAL COVERAGE (SF)			
TOTAL LIMIT OF WORK AREA	25,601 S.F.			
BUILDING FOOTPRINT	±5,386 S.F.			
REMAINING SITE AREA	20,215 S.F.			
MATURE CANOPY COVERAGE (EXISTING AND PROPOSED)	16,576 S.F.			
% CANOPY COVERAGE (75% MIN.)	81.9%			



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ESIDENCE PARCEL 52 (#22)

VERHUS RESID BRIDGE STREET / PARCEL

SITE

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PROJECT NO.: 18-083-01
DRAWN BY: JM / AS
CHECKED BY: DK





REVISIONS: 07-08-2025 REVISION - 01

DRAWING TITLE
PLANT SCHEDULE AND
DETAILS

DRAWING NUMBER

L5

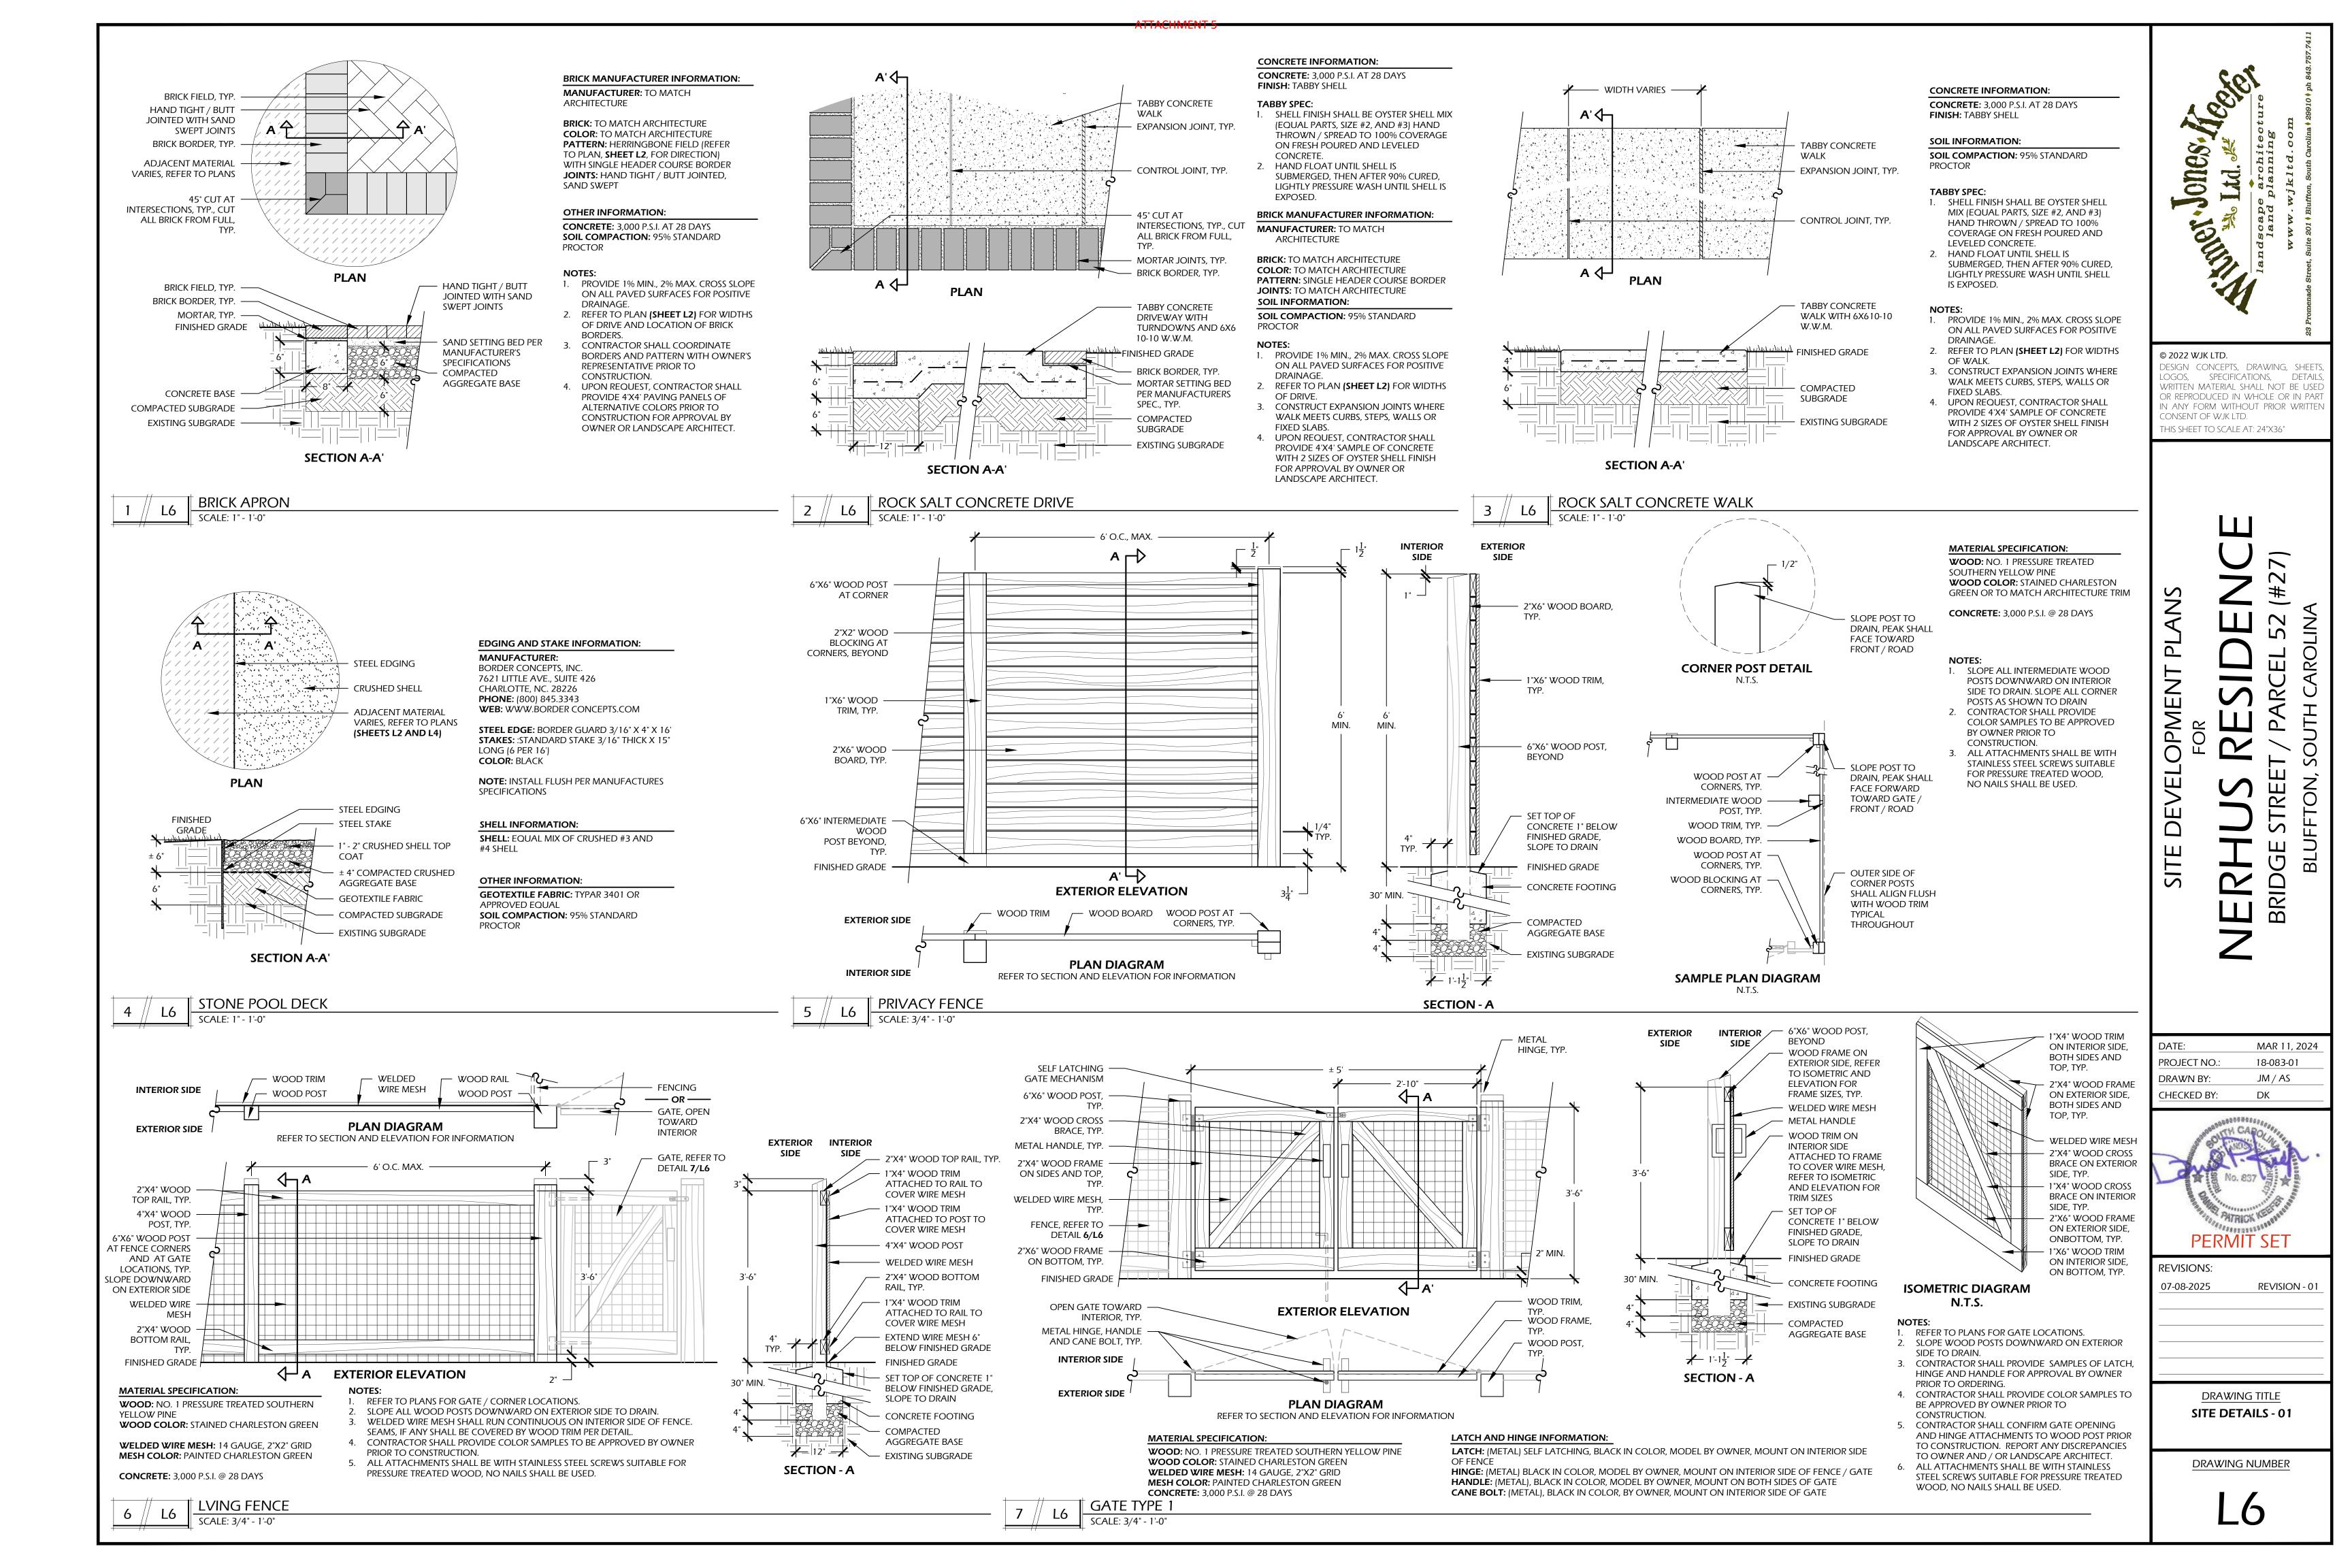

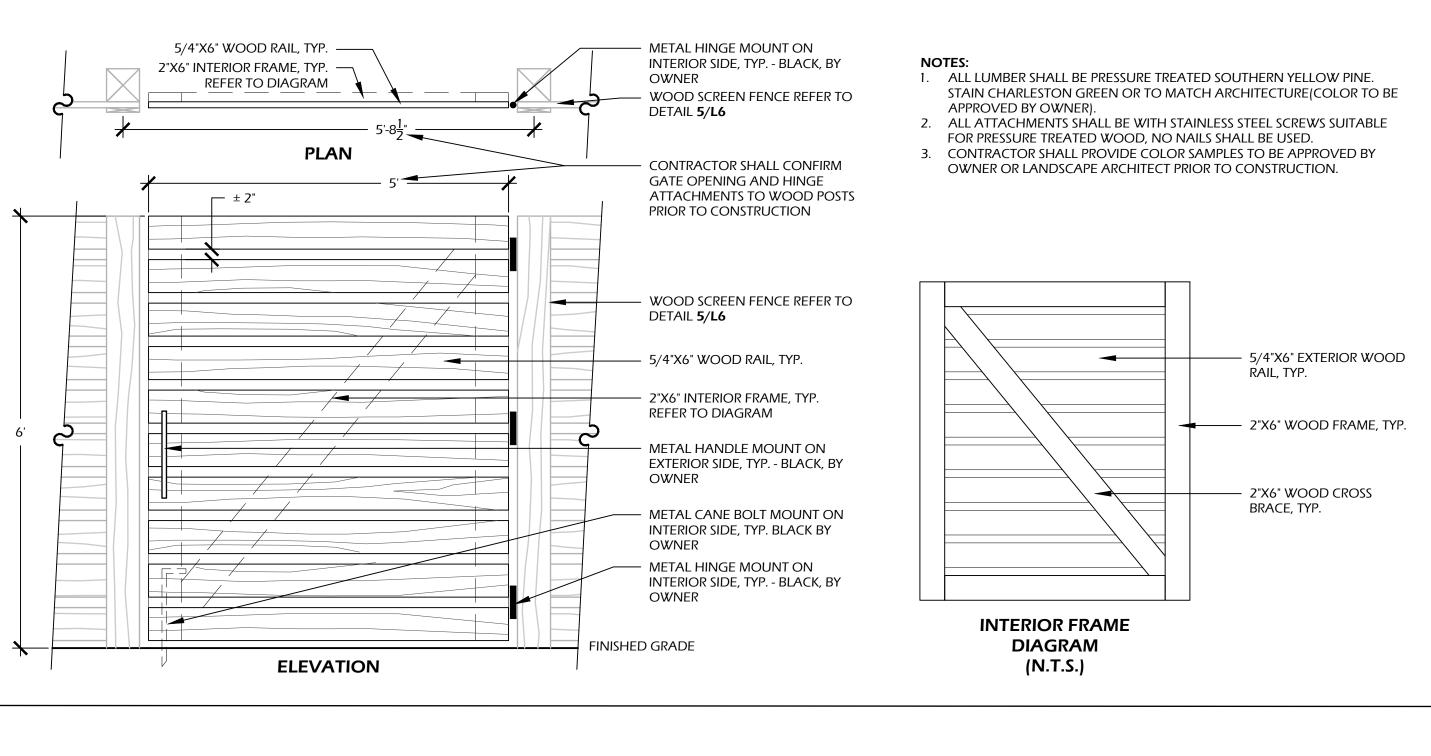



MANUFACTURER INFORMATION: COASTAL SOURCE

1270 GLEN AVENUE

MOORESTOWN, NJ 08057 **PHONE:** (800) 719.1996 **WEB:** WWW.COASTALSOURCE.COM

MODEL: 7" CHINA HAT PATH LIGHT **FINISH:** VINTAGE BRASS **BULB:** MR16 LED **WATTAGE:** 6 WATTS **TEMPERATURE: 3000K MOUNTING:** STAKE

OR APPROVED EQUAL

COASTAL SOURCE

DEFYING THE ELEMENTS



DOWN LIGHT

w/Uniball Mount Size: 10" long x 3" wide Fixture/Mour with 4.5" x .375" diameter Uniball Screw

Construction: Solid Brass

Weight: 4.0 lbs Construction: Solid Brass Voltage: 7-18VAC/7-24VDC

Finish: Vintage Brass Shroud: 360° Rotational with O-ring Lamp: MR16 LED Wattage: Maximum 9W G3 MR16 LED Lens: Clear Flat Borosilicate Glass Mounting: Uniball Tree Mount (Stainless Steel bolt) Fixture Connector: CMC Male Direct Connector Wiring: Removable 6" CMC-CC Y-Cable (not included) Warranty: 5-Year Limited Warranty

DOWN LIGHT

CS OFFICE LOCATIONS -

MANUFACTURER INFORMATION:

COASTAL SOURCE 1270 GLEN AVENUE MOORESTOWN, NJ 08057 **PHONE**: (800) 719.1996 **WEB:** WWW.COASTALSOURCE.COM

MODEL: MR16 UNIBALL TREE LIGHT **FINISH:** VINTAGE BRASS **BULB**: MR16 LED **WATTAGE**: 6 WATTS **TEMPERATURE: 3000K MOUNTING: UNIBALL TREE MOUNT**

OR APPROVED EQUAL

 DRAINAGE GRATE PERFORATIONS FINISHED SLOPE CATCH BASIN WITH GRADE FILTER UNIVERSAL OUTLET, DRAINAGE PIPE, REFER 12-15/16" TO GRADING PLAN DEPTH **SHEET L3** AND DETAIL WEEP HOLE, REFER TO NOTE 2, TYP. 3/4" GRAVEL BASE REFER TO NOTE 3

PATH LIGH SCALE: N.T.S.

MANUFACTURER INFO: NATIONAL DIVERSIFIED SALES, INC. 851 N. HARVARD AVE. LINDSAY, CA. 93247 **PHONE:** (800) 726.1994

WITH U.V. INHIBITOR

FILTER COLOR: BLUE FRAME / Black Bag **WEB**: WWW.NDSPRO.COM UNIVERSAL OUTLET: #1266, 6" UNIVERSAL LOCKING OUTLET AND **DRAINAGE GRATE**: #1290, 12"X12" ATRIUM GRATE **GRATE COLOR:** BLACK

#1206, 6" UNIVERSAL ADAPTER **GRATE INFO:** STRUCTURAL FOAM **OUTLET COLOR:** BLACK POLYOLEFIN DOME ATRIUM GRATE **OUTLET INFO:** STYRENE, USE ADAPTER PLUG AS REQUIRED

FILTER

CATCH BASIN: #1200, 12"X12" CATCH BASIN, 2 OPENINGS **BASIN COLOR:** BLACK **BASIN INFO:** POLYOLEFIN TAPERED CATCH BASIN WITH U.V. INHIBITORS

(WHERE ONLY ONE DRAIN LINE RUNS INTO CATCH BASIN)

COMPACTED SOIL

FILTER: #1200FF, 12" CATCH BASIN

RISER: #1216, 12"X12" CATCH BASIN RISER, BLACK, STYRENE, USE AS REQUIRED

- 1. THIS DETAIL IS USED FOR DESIGN INTENT ONLY. REFER TO TO MANUFACTURERS DETAIL AND SPECIFICATIONS FOR ACTUAL INSTALLATION.
- DRILL WEEP HOLE TYPICAL OF 4 PLACES AT BOTTOM CORNERS. GRAVEL BASE SHALL BE USED TO PREVENT STANDING WATER. GRATE TO BE ATTACHED TO CATCH BASIN WITH SCREW(S) PROVIDED
- AT TIME OF INSTALLATION. RISER (IF NEEDED) CAN BE CUT TO ACHIEVE EXACT ELEVATION, DO
- NOT USE OVER FIVE (5) RISERS WITH CATCH BASIN.
- 6. N.D.S. ADAPTERS THAT FIT THIS CATCH BASIN ARE AS FOLLOWS: #1242, #1243, #1245, #1266, AND #1889, USE #1206 IF PLUGGING AN
- OUTLET. 7. PERFORATION ON NON OPEN SIDES AND BOTTOM TO BE CUT OUT
- WHEN ADDING EXTRA OUTLETS. 8. EXISTING SOILS SHOULD BE EVALUATED TO ENSURE PROPER
- STRUCTURAL AND PERMEABILITY PROPERTIES. DO NOT SCALE DRAWING. 10. THIS DRAWING IS INTENDED FOR USE BY ARCHITECTS, ENGINEERS,
- CONTRACTORS, CONSULTANTS AND DESIGN PROFESSIONALS FOR PLANNING PURPOSES ONLY. 11. ALL INFORMATION CONTAINED HEREIN WAS CURRENT AT THE TIME
- OF DEVELOPMENT BUT MUST BE REVIEWED AND APPROVED BY THE PRODUCT MANUFACTURER TO BE CONSIDERED ACCURATE. 12. CONTRACTORS NOTE: FOR PRODUCT AND COMPANY INFORMATION VISIT WWW.CADDETAILS.COM/INFO AND ENTER REFERENCE NUMBER

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Jones.

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07-08-2025

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2

CARO

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TON,

MAR 11, 2024


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18-083-01

JM / AS

DK

12" AREA DRAIN TYPE 2 (ATRIUM GRATE

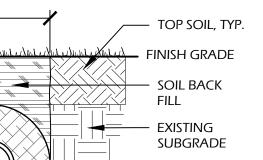

MR16 BULLET

SECTION

1. INSTALL PER MANUFACTURER'S SPECIFICATIONS. 2. ADDITIONAL COVER MAY BE REQUIRED BASED ON SITE CONDITIONS.

12" COVER REQUIRED TO OBTAIN AN H-10 LOAD RATING. 3. DO NOT SCALE DRAWING.

GATE TYPE 2

COASTAL SOURCE

DEFYING THE ELEMENTS

2.500

LLCBT16

Shroud: 360 Rotational with O-ring

Wattage: Maximum 50 Watts

Wire: Marine-Grade Tinned Wire

Warranty: 5-Year Limited Warranty*

Florida

UP LIGHT SCALE: N.T.S

Lens: Clear Convex Glass Mounting: 8" Brass Stake

CS OFFICE LOCATIONS

15" MIN.

20" MIN. IN

CLAY SOIL

6" MIN.

4. ALL INFORMATION CONTAINED HEREIN WAS CURRENT AT THE TIME OF DEVELOPMENT BUT MUST BE REVIEWED AND APPROVED BY THE PRODUCT MANUFACTURER TO BE CONSIDERED ACCURATE.

CONTRACTORS NOTE: FOR PRODUCT AND COMPANY INFORMATION

VISIT WWW.CADDETAILS.COM/INFO AND ENTER REFERENCE

MANUFACTURER INFO:

MANUFACTURER INFORMATION:

WEB: WWW.COASTALSOURCE.COM

COASTAL SOURCE

1270 GLEN AVENUE

MOORESTOWN, NJ 08057

PHONE: (800) 719.1996

MODEL: MR16 BULLET

WATTAGE: 6 WATTS

MOUNTING: STAKE

OR APPROVED EQUAL

TEMPERATURE: 3000K

BULB: MR16 LED

FINISH: VINTAGE BRASS

NATIONAL DIVERSIFIED SALES, INC. 851 N. HARVARD AVE. LINDSAY, CA. 93247 **PHONE:** (800) 726.1994 WEB: WWW.NDSPRO.COM

PIPE: #EZ-1501F, 15" MESH WITH 6" CORRUGATED PERFORATED PIPE PIPE COLOR: BLACK **PIPE INFO: POLYETHYLENE** SLOTTED DRAIN PIPE SURROUNDED BY 100% RECYCLED POLYSTYRENE AGGREGATE AND ENCLOSED IN **30-SIEVE POLYETHYLENE GEOTEXTILE MESH**

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COUPLING: #6C07, 6"

CORRUGATED INTERNAL

COUPLING, AS REQUIRED

END CAP, AS REQUIRED.


END CAP COLOR: BLACK

COUPLING COLOR: BLACK


END CAP: #6C06, 6" CORRUGATED

SOIL INFO: SOIL BACK FILL: TOP SOIL BACK FILL, OR GRAVEL WITH 3" TOP SOIL IN CLAY

STORAGE AND FLOW INFO:

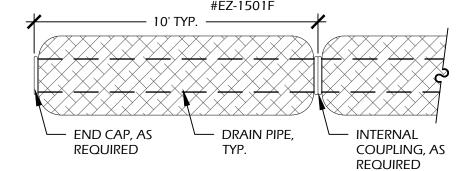

STORAGE VOLUME = 45.8 GALLONS (6.1225 CU. FT.) PER SECTION. FLOW RATE = 345.0 GPM (1% SLOPE)

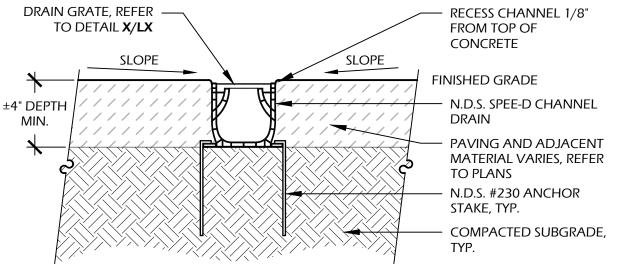

MANUFACTURER INFO: NATIONAL DIVERSIFIED SALES, INC. 851 N. HARVARD AVE. LINDSAY, CA. 93247 PHONE: (800) 726.1994 WEB: WWW.NDSPRO.COM PROTECTED BY COPYRIGHT ©2015 CADDETAILS.COM LTD. REVISION DATE 09/23/2015


1. THIS DETAIL IS USED FOR DESIGN INTENT ONLY. REFER TO TO MANUFACTURERS DETAIL AND SPECIFICATIONS FOR

2. EXISTING SOILS SHOULD BE EVALUATED TO ENSURE PROPER STRUCTURAL AND PERMEABILITY PROPERTIES.

INSTALLATION TO BE COMPLETED IN ACCORDANCE WITH MANUFACTURER'S SPECIFICATIONS. . DO NOT SCALE DRAWING.

5. THIS DRAWING IS INTENDED FOR USE BY ARCHITECTS, ENGINEERS, CONTRACTORS, CONSULTANTS AND DESIGN PROFESSIONALS FOR PLANNING PURPOSES ONLY. 6. ALL INFORMATION CONTAINED HEREIN WAS CURRENT AT THE TIME OF DEVELOPMENT BUT MUST BE REVIEWED AND APPROVED BY

THE PRODUCT MANUFACTURER TO BE CONSIDERED ACCURATE. 7. CONTRACTORS NOTE: FOR PRODUCT AND COMPANY INFORMATION VISIT WWW.CADDETAILS.COM/INFO AND ENTER REFERENCE NUMBER 558-173

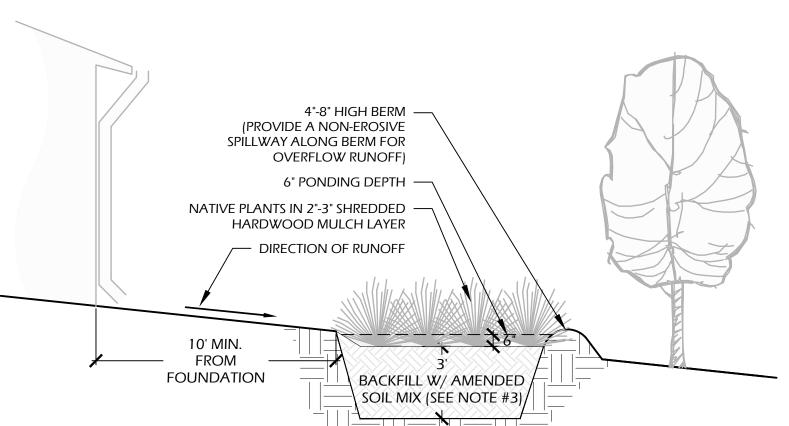

2. LOCATE RAIN GARDEN AT LEAST 25 FEET AWAY FROM SEPTIC SYSTEM DRAINFIELDS AND 10 FEET AWAY FROM WELLS 3. THE RAIN GARDENS IN SC MANUAL BY CLEMSON UNIV. RECOMMENDS THE FOLLOWING BACKFILL MIX FOR HEALTHY SOIL: 20-30% EXISTING SOIL,

20-30% COMPOST, AND 40-60% SAND.

RAIN GARDEN

NOTES:

1. CALL 8-1-1 IN SC BEFORE YOU DIG TO AVOID BURIED CABLES AND PIPES.

DRAWING NUMBER

DRAWING TITLE

SITE DETAILS - 02

6" FRENCH DRAIN

NUMBER 558-028