

- A. ALL DIMENSIONS ARE TO FACE OF STUD UNLESS NOTED OTHERWISE. B. ALL DENOTED DIMENSIONS ARE TO BE USED. PLANS SHALL NOT BE SCALED. C. EXTERIOR WALL ARE 2x6, INTERIOR WALLS 2x4 U.N.O., SEE STRUCTURAL
 - PLANS FOR FRAMING REQUIREMENTS. D. SEE PLUMBING PLANS FOR DIMENSIONS TO PLUMBING FIXTURES
- REFER TO SHEET Q1.1 FOR FOR EQUIPMENT PLAN. REFER TO SHEET Q2.1 FOR EQUIPMENT SCHEDULE.
- G. ALL EQUIPMENT SHALL MEET ACCESSIBILITY REACH RANGE REQUIREMENTS. H. PROVIDE PLASTIC CORNER GUARDS AT EDGES BELOW 6'-0".
- I. ALL COUNTERTOPS SHALL BE MAX. 34" A.F.F. WITH A 3-FOOT WIDE TRANSACTION AREA AT CASHIER. CONTRACTOR SHALL COORDINATE WORK WITH CABINET INSTALLER FOR CABINET INSTALLATION. CONTRACTOR TO ROUTE UTILITIES THROUGH CABINETS. CONTACT CABINET INSTALLER FOR SITE SPECIFIC CABINET SHOP DRAWINGS.
- J. 4" HIGH BACKSPLASH AT ALL COUNTERTOPS THAT TERMINATE AT WALL. BACKSPLASH TO MATCH COUNTERTOP MATERIAL.
- K. THE CONTRACTOR SHALL ASSIST STORE PERSONNEL BY ASSEMBLING
- MERCHANDISE GONDOLAS AND SHELVING AS SHOWN ON Q1.1. ALL EQUIPMENT AND CABINETS SHALL BE FREE OF SHARP EDGES. CONTACT
- M. CONTRACTOR SHALL ROUTE ALL CONDENSATE DRAIN LINES TO FLOOR SINKS. N. CONTRACTOR SHALL INSTALL NEW PARTITIONS/WALLS WITH GYPSUM WALL BOARD AND FINISHES AS NOTED ON FINISH SCHEDULE AND INTERIOR ELEVATIONS ON SHEET A2.3 THRU A2.6. ALL PARTITIONS/WALLS SHALL BE
- BRACED FOR LATERAL FORCES, PER BUILDING CODE REQUIREMENTS. O. FLAME SPREAD CLASSIFICATIONS FOR INTERIOR WALLS SHALL COMPLY WITH
- P. FIRE EXTINGUISHERS (2A:10B:C) SHALL BE INSTALLED AT SALES COUNTER, BACK ROOM, OFFICE, & FUEL CANOPY LOCATIONS IF NOT SHOWN ELSEWHERE ON THESE DRAWINGS. VERIFY WITH OWNER FOR DETAILS,
- CONFIRM FINAL DETAILS WITH LOCAL FIRE INSPECTOR. Q. CONTRACTOR SHALL ASSIST THE OWNER WITH STORE EQUIPMENT TO PREPARE A DELIVERY STAGING AREA. COORDINATE WITH OWNER FOR THE
- R. CONTRACTOR SHALL PROVIDE A CLEAN, SMOOTH SURFACE FOR GRAPHICS
- S. ALL DIMENSIONS SHALL BE FIELD VERIFIED BY CONTRACTOR FROM CABINET AND EQUIPMENT CLEARANCES PRIOR TO WALL ERECTION. DISCREPANCIES SHALL BE DIRECTED TO OWNER.
- T. WATER HEATERS SHALL BE CAPABLE OF DELIVERING MIN. 120° WATER TO
- U. ALL FLOOR/WALL TILE AND COVE BASE SHALL BE INSTALLED BY THE GENERAL CONTRACTOR ACCORDING TO THE MANUFACTURER'S INSTRUCTIONS. V. ALL DOORS MUST HAVE <u>NO MORE</u> THAN 5 LBS OPENING FORCE AND MUST
- OPEN TO 3" FROM THE LATCH. W. CARBONATOR BACK-FLOW PREVENTOR DRAIN LINE OUTLET SHALL BE TO NEW FLOOR SINK PROVIDED FOR THIS AREA.

- ALUMINUM ENTRANCE AND STOREFRONT SYSTEM, REFER TO SHEET A5.1 & SPECIFICATION.
- $\langle 2 \rangle$ INSTALL 6"ø PVC CHASE FOR FOUNTAIN SYRUP LINES.
- (3) FLOOR RECEPTACLES, REFER TO ELECTRICAL PLANS.
- (5) 1" MINIMUM AIR GAP AT PREFABRICATED COOLER/FREEZER
- \langle 6 \rangle DEPRESSED SLAB, REFER TO SLAB PLAN.
- 7 LINE OF CANOPY ABOVE
- $\langle 8 \rangle$ double swing metal gate provided by shopco
- $\langle 9 \rangle$ THRESHOLD, REFER TO DOOR SCHEDULE ON SHEET A5.1
- $\langle 10 \rangle$ LINE OF SOFFIT ABOVE
- LINE OF CLERESTORY CEILING OPENING, REFER TO WINDOW SCHEDULE ON SHEET A5.1
- (13) TRANSITION STRIP
- $\langle 14 \rangle$ STEEL COLUMNS UNDER WINDOW SILL FOR STOREFRONT PROTECTION, REFER TO STRUCTURAL PLANS FOR SIZE AND LOCATION.
- (15) ROOF DRAIN AND OVERFLOW, REFER TO CIVIL PLANS FOR CONTINUATION
- $\langle 16
 angle$ canopy downspout, refer to civil plans for continuation
- (18) CO2 SAFETY MONITORING EQUIPMENT, REFER TO SHEETS Q1.1 AND Q2.1 FOR LOCATION AND SPECIFICATION
- RECESSED STAINLESS STEEL FILL BOX WITH QUICK-DISCONNECT MALE FILL AND VENT HOSE CONNECTION FOR CO2 TANK

WOOD FRAMED WALL

PREFABRICATED COOLER/FREEZER WALL

- 1 2x6 STUDS @ 16"o.c.
- 1A 2x6 STUDS @ 16"o.c. W/ THERMAL INSULATION
- 2x4 STUDS @ 16"o.c.
- 2x4 STUDS @ 16"o.c. W/ SOUND BATT INSULATION
- DOOR SYMBOL, REFER TO SHEET A5.1 FOR DETAILS
- WINDOW SYMBOL, REFER TO SHEET A5.1 FOR DETAILS

- SALES 2,319 S.F. (2319/60) OFFICE - 72 S.F. (72/100) RESTROOMS - 136 S.F. (EXEMPT)
- COOLER/FREEZER 622 S.F. (622/300)
- TOTAL (NET): 3,681 S.F. = 46 OCCUPANTS TOTAL (GROSS): 3,799 S.F.
- *COOLER IS A NON OCCUPIABLE SPACE PER SECTION 202 DEFINITION OF AN OCCUPIABLE SPACE.

= 1

= 0

= 3

= 3

EXITS REQUIRED: 2 EXITS PROVIDED: 2

GYPSUM BOARD. REFER TO REFER TO SPECIFICATION

ON Q1.2.

BY COOLER MFR.

Q1.2 AND A1.3.

REFER TO CALLOUT ON

CALLOUT ON A2.5.

WHITE CEILING TILE

REFER TO CALLOUT ON

REFER TO CALLOUT ON

SHEET A2.6.

PAINTED PLYWOOD AND PAINTED SMOOTH FINISH PAINTED SMOOTH FINISH PAINTED SMOOTH FINISH WASHABLE SUSPENDED STUCCO-GALVALUM. 5/8" WATER RESISTANT | 5/8" GYPSUM BOARD.

GYPSUM BOARD. REFER REFER TO CALLOUT ON

BOARD. REFER TO

TO CALLOUT ON A1.3.

CALLOUT ON A2.6.

FASCIA PAINTED SMOOTH FINISH 1/2" GYPSUM BOARD. NOT APPLICABLE

5/8" GYPSUM BOARD.

REFER TO CALLOUT ON

REFER TO CALLOUT ON A2.3 & A2.4. SOFFIT PAINTED

SMOOTH FINISH 5/8" WATER RESISTANT GYPSUM

BOARD. REFER TO CALLOUT ON A1.3.

OPEN WEB TRUSSES.


REFER TO CALLOUT ON

DATE SIGNED: _ SEAL

ISSUES / REVISIONS						
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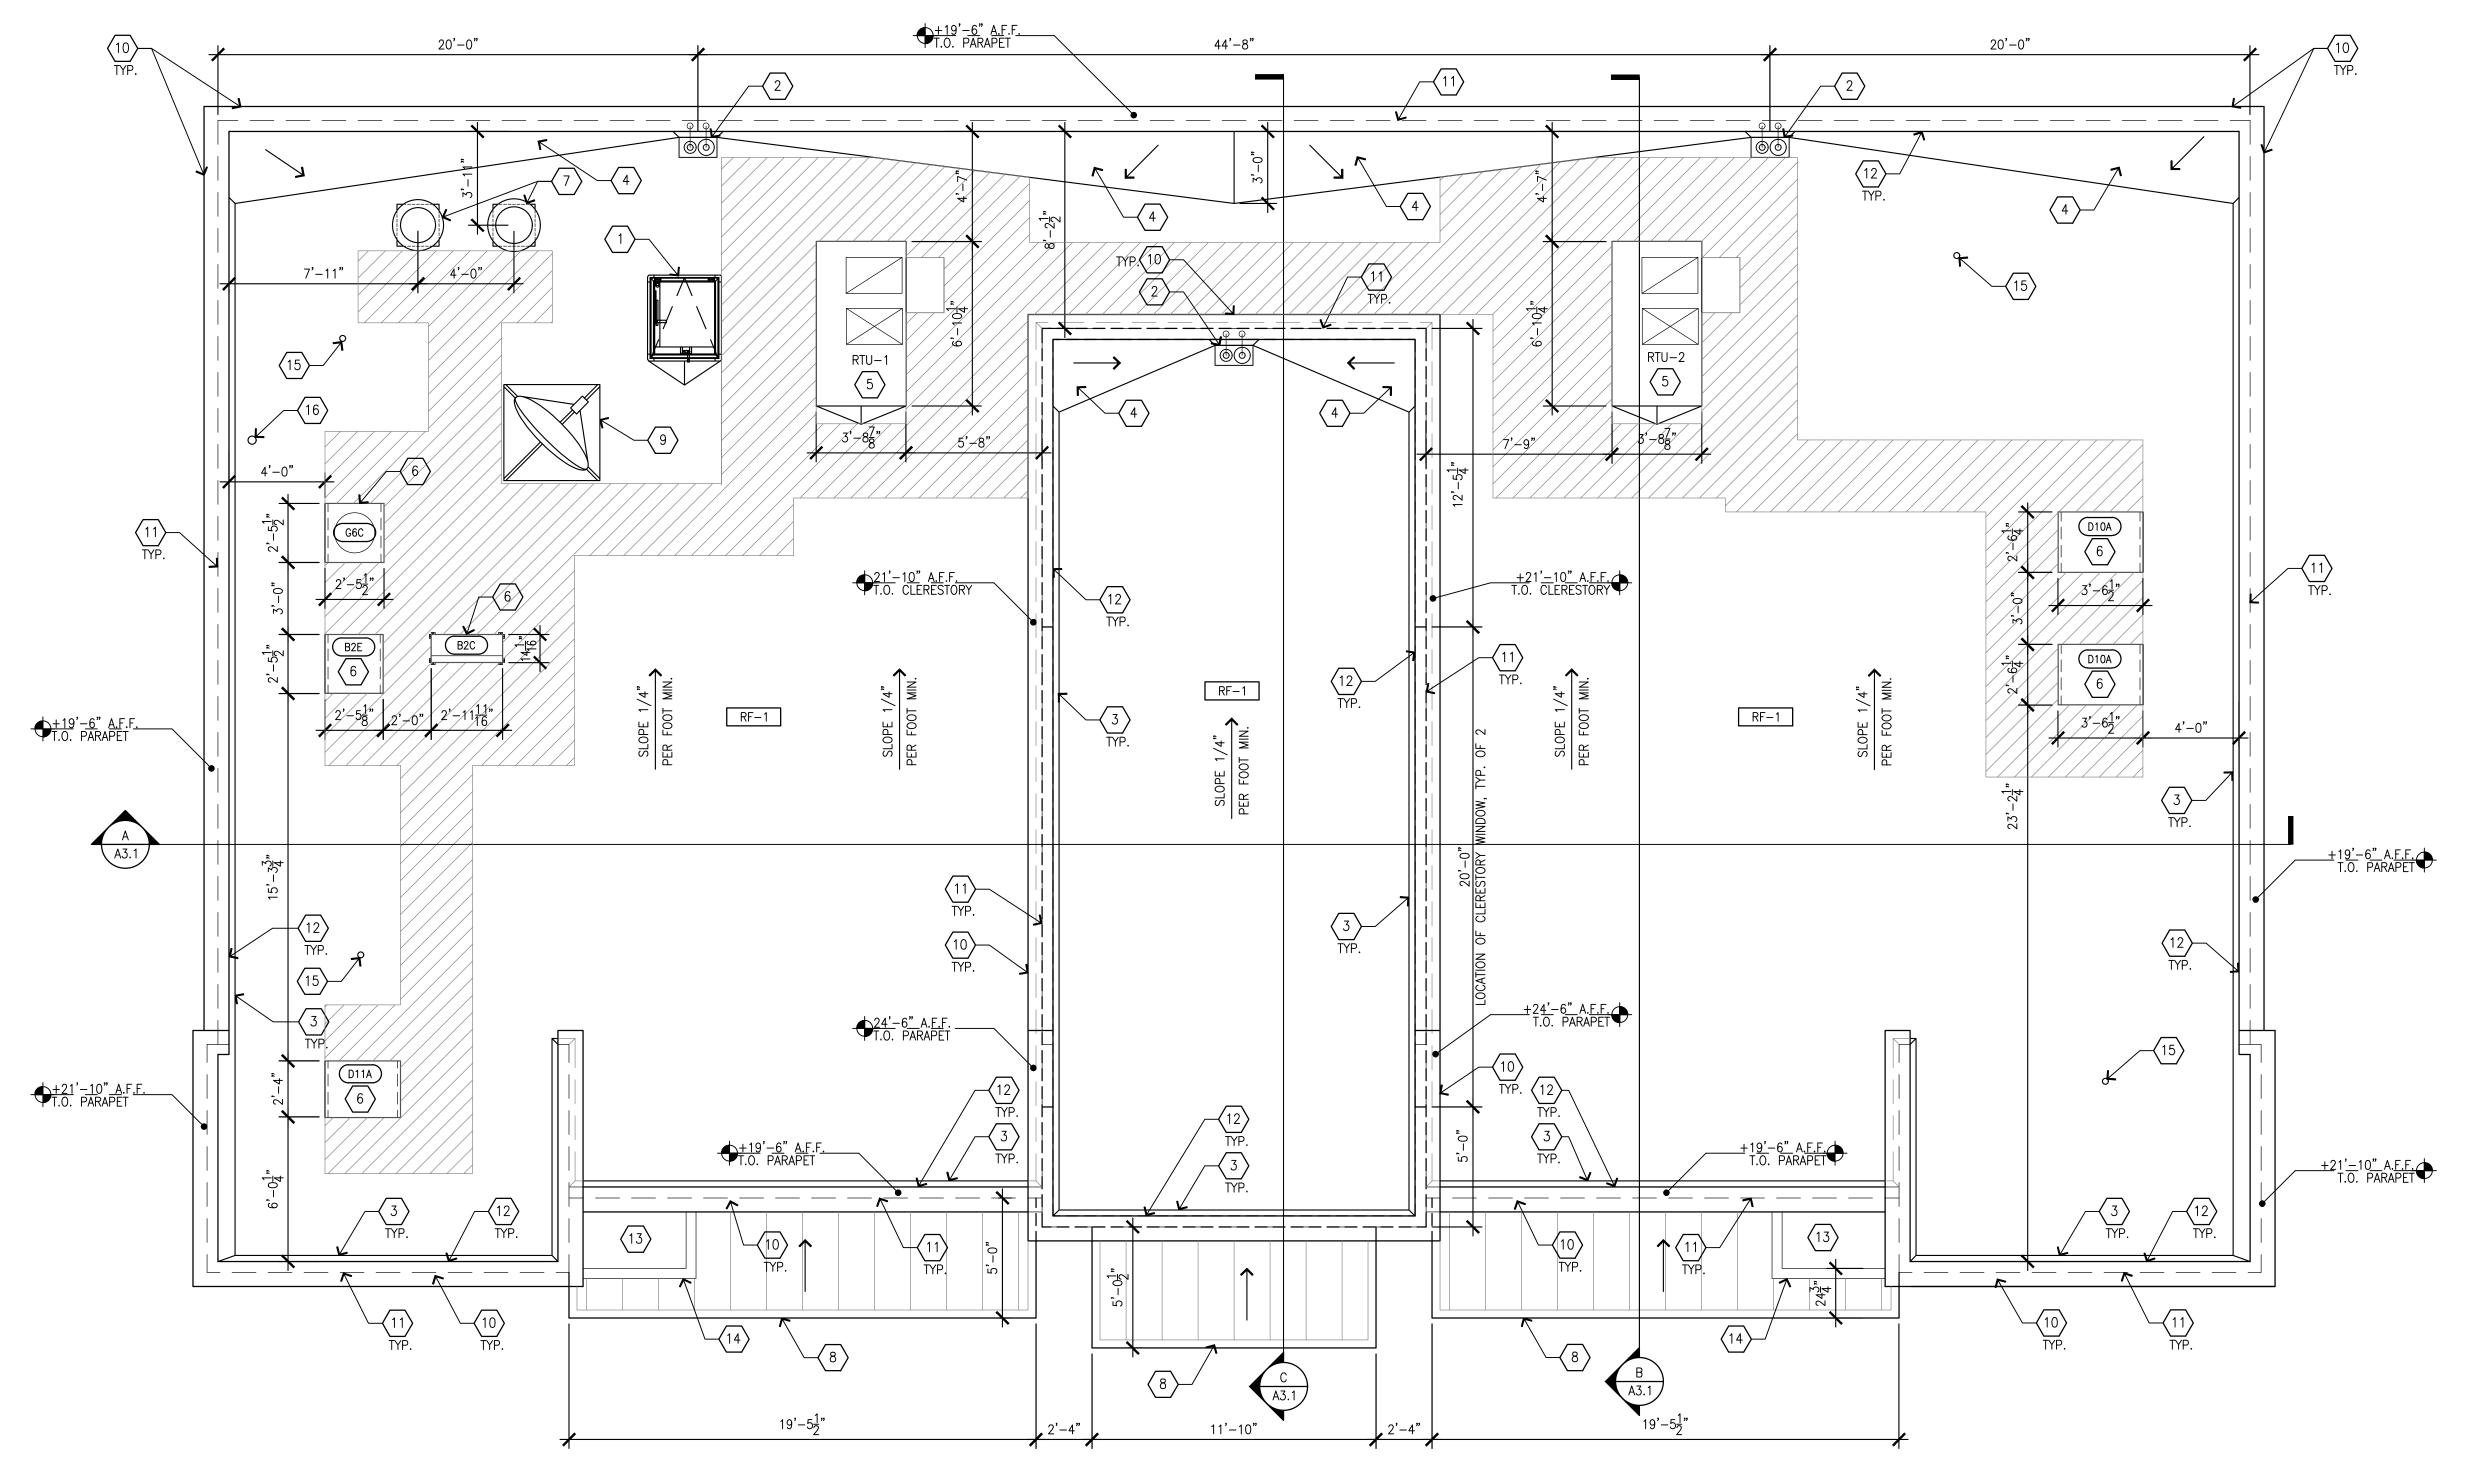
DATE DESCRIPTION DRAWN BY: G. DE VERA CHK'D BY: F. COHEN

3800 AM/PM + CAR WASH S.E.C. OAK VALLEY PKWY INTERSTATE 10 BEAUMONT CA 92223 PROJECT NAME AND ADDRESS

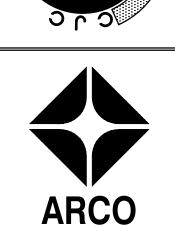

SHEET TITLE





01 **ROO P** SCALE: 1/4"=1'-0"

□ □ □ □ RA□ □ O□ □

- A. REFER TO SPECIFICATION SHEETS A7.3 & A7.4 FOR ROOF SYSTEM, INCLUDING GUARANTEES, CURBS, FLASHING, AND ECT.
- B. REFER TO ROOFING MANUFACTURERS WRITTEN INSTRUCTIONS AND DETAILS FOR ROOFING SYSTEM INSTALLATION. CONTRACTOR TO PROVIDE COMPLETE ROOFING PACKAGE PER MANUFACTURERS RECOMMENDATIONS.
- C. ROOF ASSEMBLY SHALL COMPLY WITH U.L. I—90 AND FM CLASS "B"
 RATINGS INCLUDING COPING, FLASHING, PARAPET WALL, AND ROOF
- D. DO NOT STOCKPILE EQUIPMENT OR MATERIALS ON THE ROOF STRUCTURE, UNLESS APPROVED IN WRITING BY THE ARCHITECT,
- STRUCTURAL ENGINEER, AND THE TRUSS MANUFACTURER.

 E. FOR EQUIPMENT COMPRESSOR & CONDENSER REFER TO EQUIPMENT PLAN ON SHEET Q1.1 AND EQUIPMENT SCHEDULE ON SHEET Q2.1.
- F. GENERAL CONTRACTOR IS TO PROVIDE TEMPORARY CONSTRUCTION PERIMETER GUARDRAIL TO COMPLY WITH CODE OF FEDERAL REGULATIONS 29 CFT 1926, SUBPART M (OSCA), GUARDRAIL TO BE 42" HEIGHT AND BE ABLE TO WITHSTAND 200 POUNDS AT TOP EDGE.
- H. REFER TO MECHANICAL PLANS FOR VENT PIPE PENETRATION AND CURB DETAILS. ALL ROOF PENETRATIONS SHALL BE THROUGH THE CURBS, UNLESS NOTED OTHERWISE.
- I. PARAPET ADJACENT TO MECHANICAL EQUIPMENT / ROOF ACCESS TO BE MINIMUM 42" HIGH WHEN WITHIN 10 FEET OF ROOF EDGE.

- 1 ROOF HATCH PER DETAIL 7/A4.1
- 2 ROOF DRAIN AND OVERFLOW
- $\langle 3 \rangle$ CANT STRIP PER DETAIL 8/A4.1
- 4 TAPERED INSULATION CRICKET
- 5 ROOFTOP UNIT, REFER TO MECHANICAL PLANS.
- 6 CONDENSER, REFER TO EQUIPMENT AND ELECTRICAL PLAN
- $\overline{\left\langle 7\right\rangle }$ EXHAUST FAN, REFER TO MECHANICAL PLANS
- (8) STEEL CANOPY BELOW, REFER TO SHEET A1.3 FOR DOWNSPOUT LOCATION
- (9) SATELLITE ON BALLASTED CURB
- $\langle 10 \rangle$ shop formed pre-finished metal coping, refer to detail 1/A4.1
- (11) FACE OF EXTERIOR WALL BELOW
- $\langle 12 \rangle$ face of parapet wall
- $\langle 13 \rangle$ METAL LID FLASHING
- STEEL CANOPY GUTTER, REFER TO SHEET A1.3 FOR DOWNSPOUT LOCATION
- (15) ROOF JACK, REFER TO MECHANICAL PLANS.
- (16) GAS WATER HEATER FLUE, REFER TO MECHANICAL PLANS.

ROO[[[[[]]

RF-1 TPO ROOFING MEMBRANE WITH PROTECTION BOARD AND RIGID INSULATION.
REFER TO SPECIFICATIONS

EQUIPMENT MAINTENANCE PATH

DATE SIGNED: _____

SEAL

ISSUES / REVISIONS

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DATE DESCRIPTION

DRAWN BY: G. DE VERA
CHK'D BY: F. COHEN

3800 AM/PM + CAR WASH
S.E.C. OAK VALLEY PKWY
INTERSTATE 10

BEAUMONT
CA 92223
PROJECT NAME AND ADDRESS

Permitting
inda, CA 92887
(714) 920–9643
(714) 917.0250

sign 22485 La Palma Av







SHEET TITLE

ROO[] P[]A[]



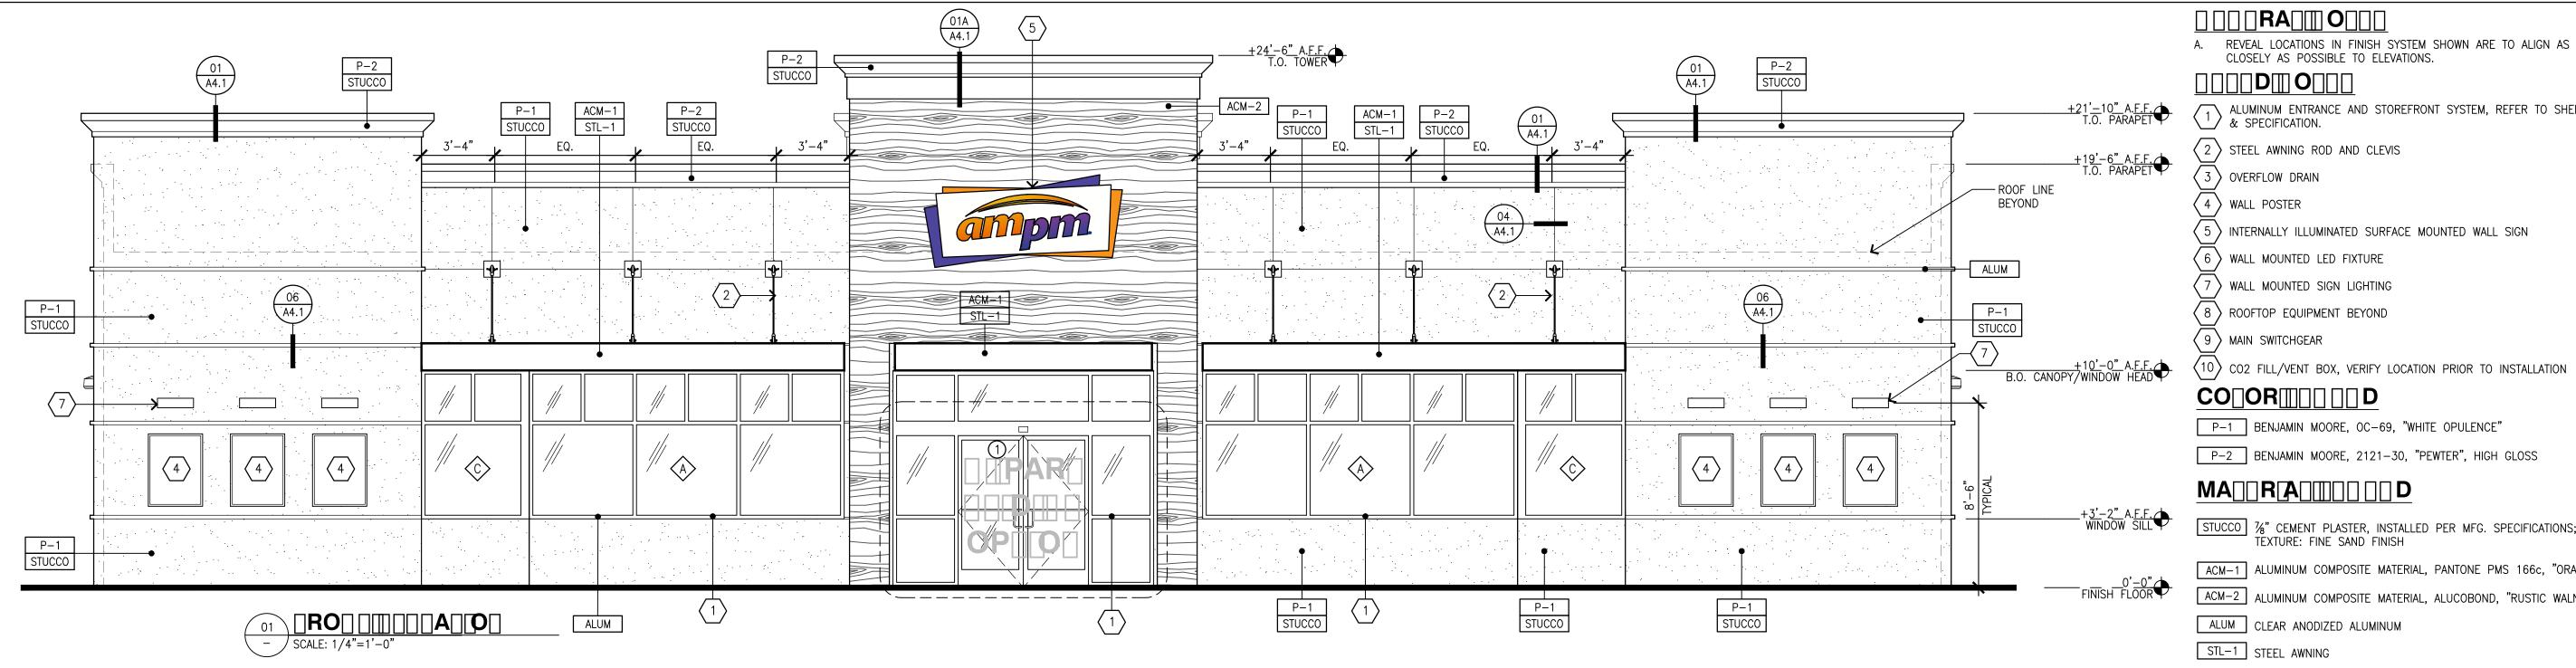

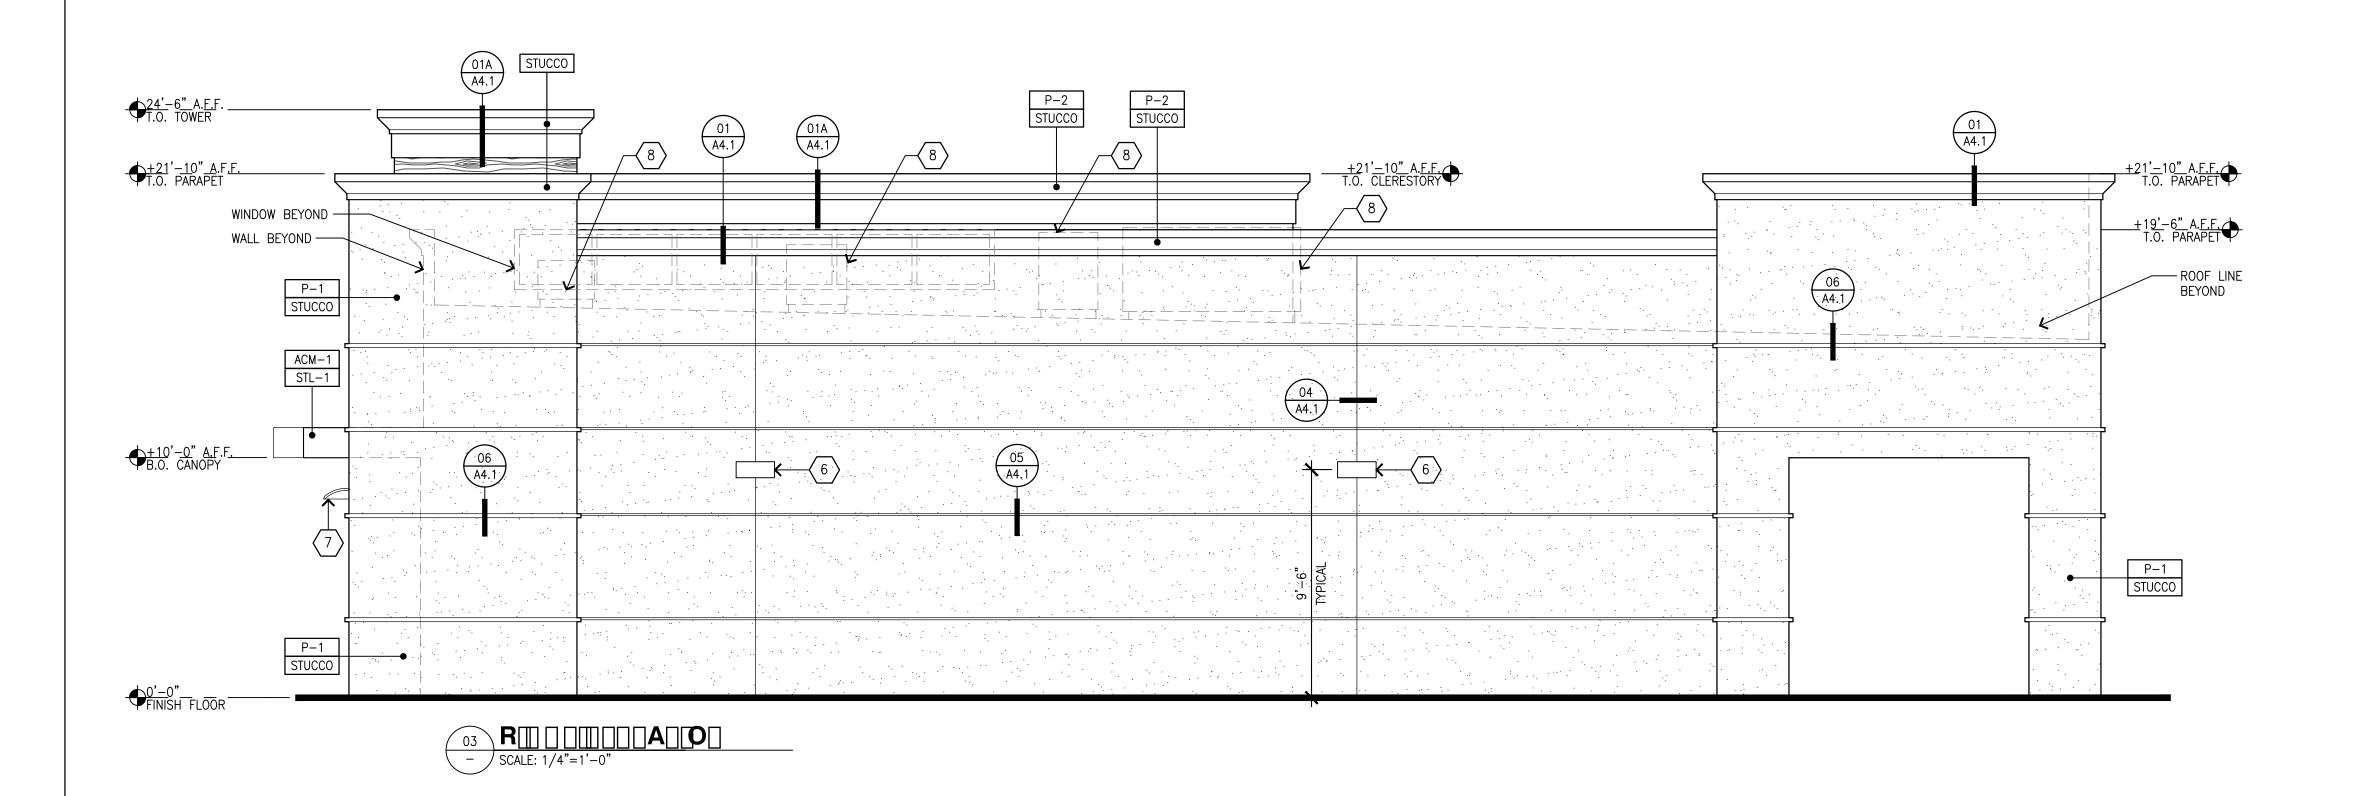

P-2

____**RA**___**O**___

A. REVEAL LOCATIONS IN FINISH SYSTEM SHOWN ARE TO ALIGN AS CLOSELY AS POSSIBLE TO ELEVATIONS.

- ALUMINUM ENTRANCE AND STOREFRONT SYSTEM, REFER TO SHEET A5.1 & SPECIFICATION.
- $\langle 2 \rangle$ STEEL AWNING ROD AND CLEVIS 3 > OVERFLOW DRAIN
- (5) INTERNALLY ILLUMINATED SURFACE MOUNTED WALL SIGN
- $\langle 6 \rangle$ WALL MOUNTED LED FIXTURE
- 7 > WALL MOUNTED SIGN LIGHTING
- (8) ROOFTOP EQUIPMENT BEYOND

P-1 BENJAMIN MOORE, OC-69, "WHITE OPULENCE"

P-2 BENJAMIN MOORE, 2121-30, "PEWTER", HIGH GLOSS

MA | | | R | A | | | | | | | D

STUCCO 7/8" CEMENT PLASTER, INSTALLED PER MFG. SPECIFICATIONS; TEXTURE: FINE SAND FINISH

ACM-1 ALUMINUM COMPOSITE MATERIAL, PANTONE PMS 166c, "ORANGE"

ACM-2 ALUMINUM COMPOSITE MATERIAL, ALUCOBOND, "RUSTIC WALNUT"

ALUM CLEAR ANODIZED ALUMINUM

STL-1 STEEL AWNING

DATE SIGNED: _ SEAL

ISSUES / REVISIONS

/4\	
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DATE DESCRIPTION

DRAWN BY: G. DE VERA CHK'D BY: F. COHEN 3800 AM/PM + CAR WASH AT 1. OAK VALLEY PKWY INTERSTATE 10 BEAUMONT


CA 92223 PROJECT NAME AND ADDRESS

D E





SHEET TITLE

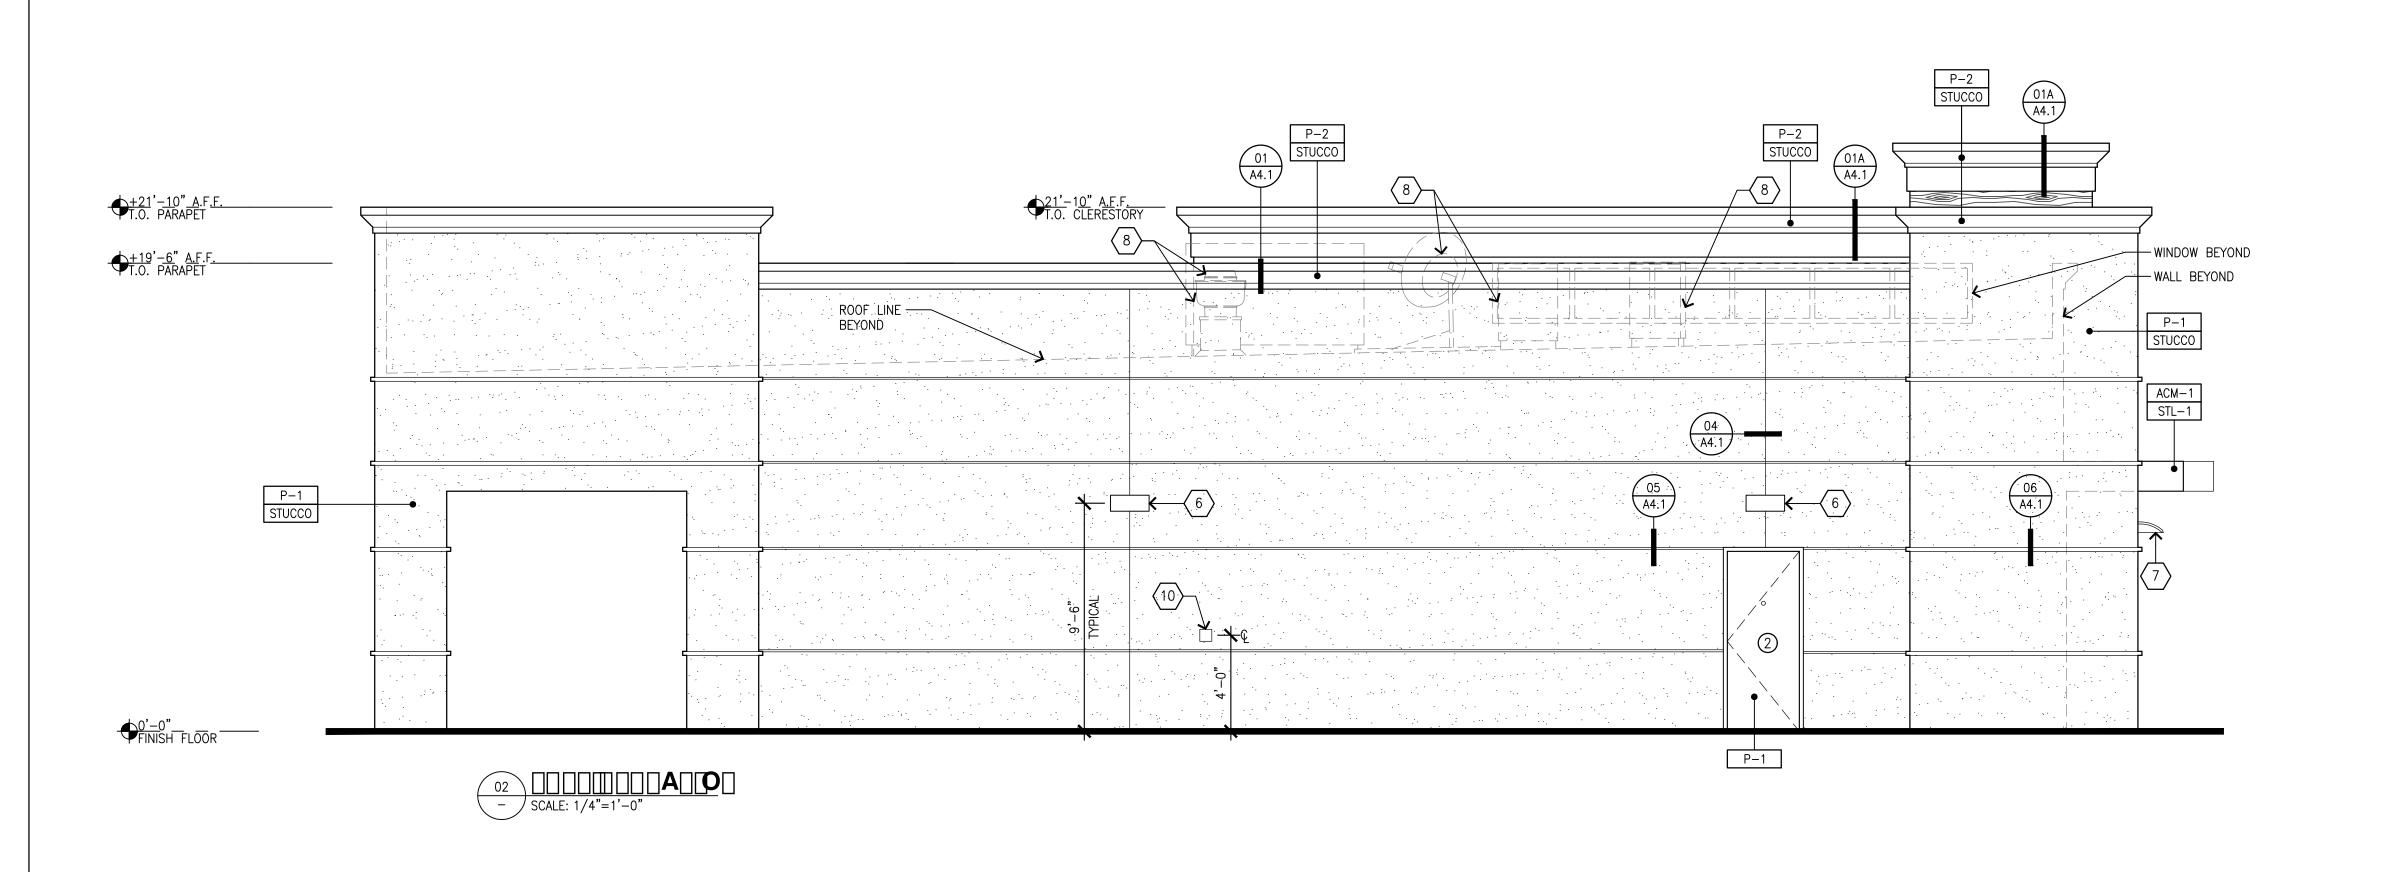



A. REVEAL LOCATIONS IN FINISH SYSTEM SHOWN ARE TO ALIGN AS CLOSELY AS POSSIBLE TO ELEVATIONS.

- ALUMINUM ENTRANCE AND STOREFRONT SYSTEM, REFER TO SHEET A5.1 & SPECIFICATION.
- $\langle 2 \rangle$ STEEL AWNING ROD AND CLEVIS
- 2 STEEL AWNING ROD AND CL
 3 OVERFLOW DRAIN
- $\overline{4}$ WALL POSTER
- $\overline{\left(5\right)}$ Internally illuminated surface mounted wall sign
- 6 WALL MOUNTED LED FIXTURE
- 7) WALL MOUNTED SIGN LIGHTING
- 8 ROOFTOP EQUIPMENT BEYOND
- 8 ROOFTOP EQUIPMENT BEY

 9 MAIN SWITCHGEAR
- (10) CO2 FILL/VENT BOX, VERIFY LOCATION PRIOR TO INSTALLATION

P-1 BENJAMIN MOORE, OC-69, "WHITE OPULENCE"

P-2 BENJAMIN MOORE, 2121-30, "PEWTER", HIGH GLOSS

MA | | | R A | | | | | | | D


STUCCO %" CEMENT PLASTER, INSTALLED PER MFG. SPECIFICATIONS; TEXTURE: FINE SAND FINISH

ACM-1 ALUMINUM COMPOSITE MATERIAL, PANTONE PMS 166c, "ORANGE"

ACM-2 ALUMINUM COMPOSITE MATERIAL, ALUCOBOND, "RUSTIC WALNUT"

ALUM CLEAR ANODIZED ALUMINUM

STL-1 STEEL AWNING

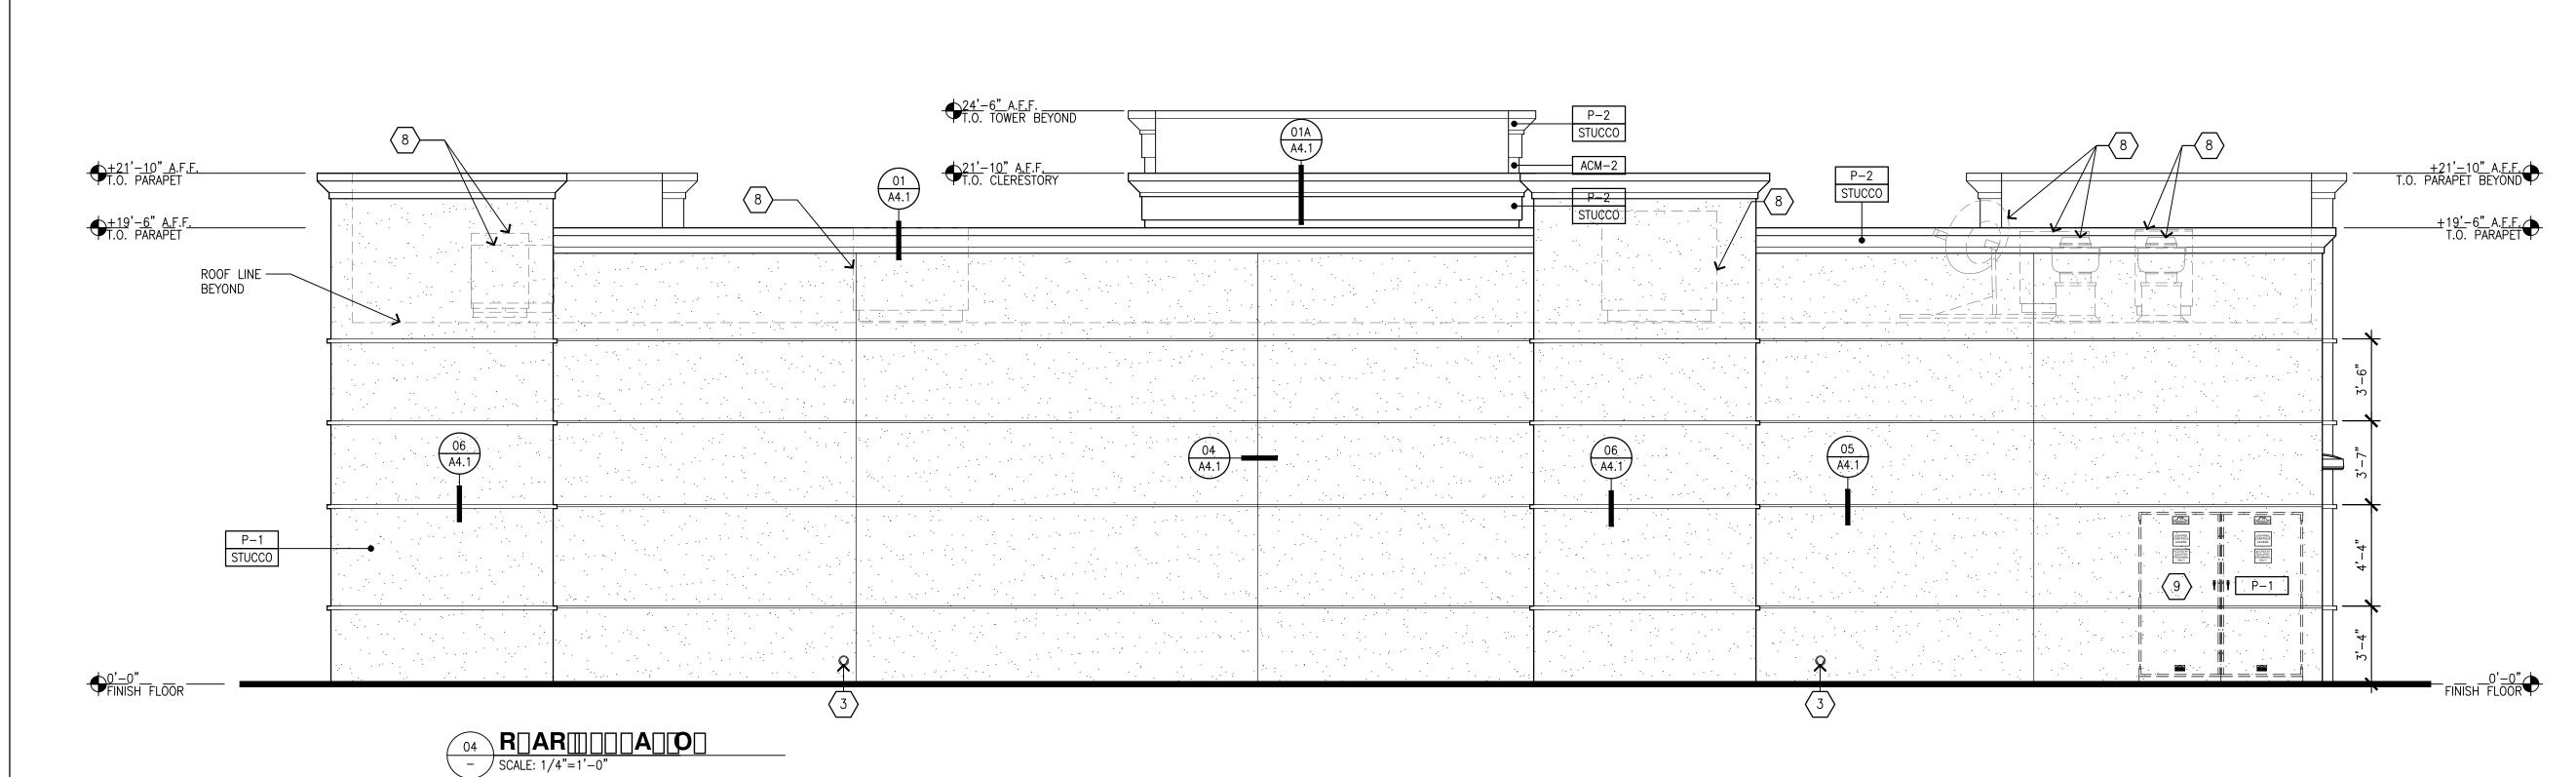

DATE SIGNED:

SEAL

ISSUES / REVISIONS

DATE DESCRIPTION

DRAWN BY: G. DE VERA
CHK'D BY: F. COHEN

3800 AM/PM + CAR WASH
S.E.C. OAK VALLEY PKWY

INTERSTATE 10

BEAUMONT

CA 92223

CA 92223

PROJECT NAME AND ADDRESS

Permitting
Yorba Linda, CA 92887
Tel: (714) 920–9643
Fax: (714) 917.0250

Planning
Plane, Suite 202, Yorba L


Design 22485







SHEET TITLE



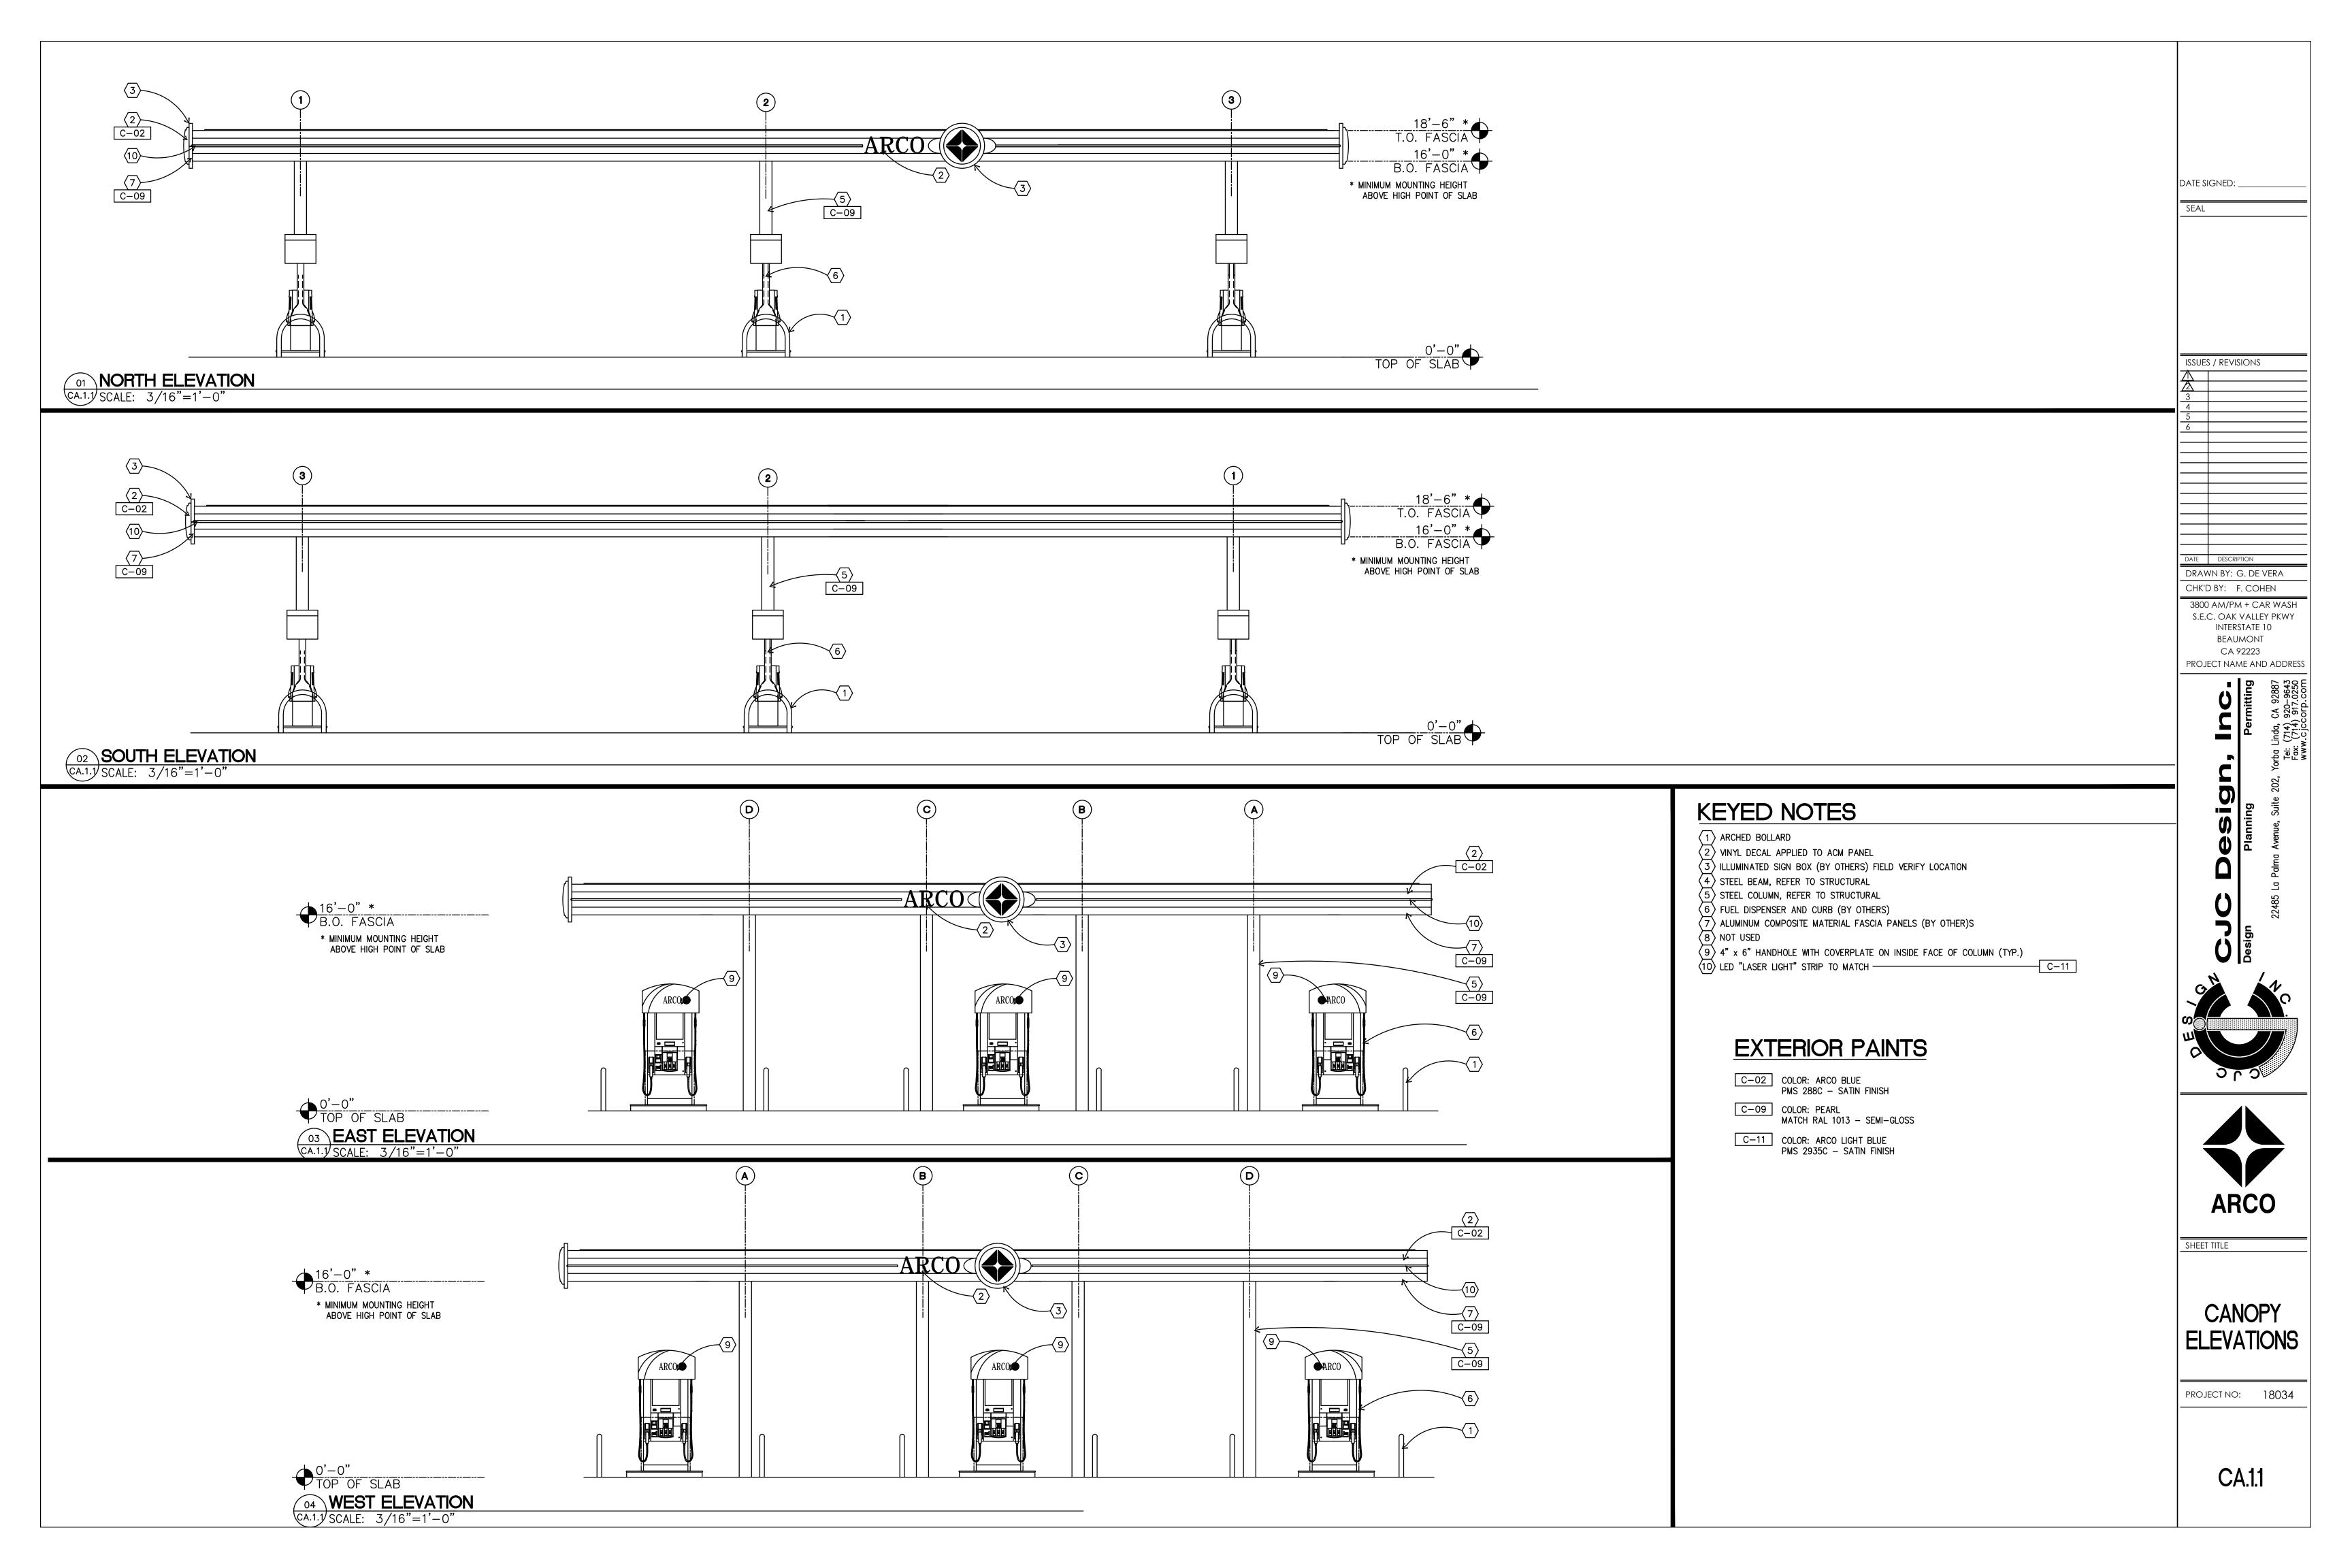

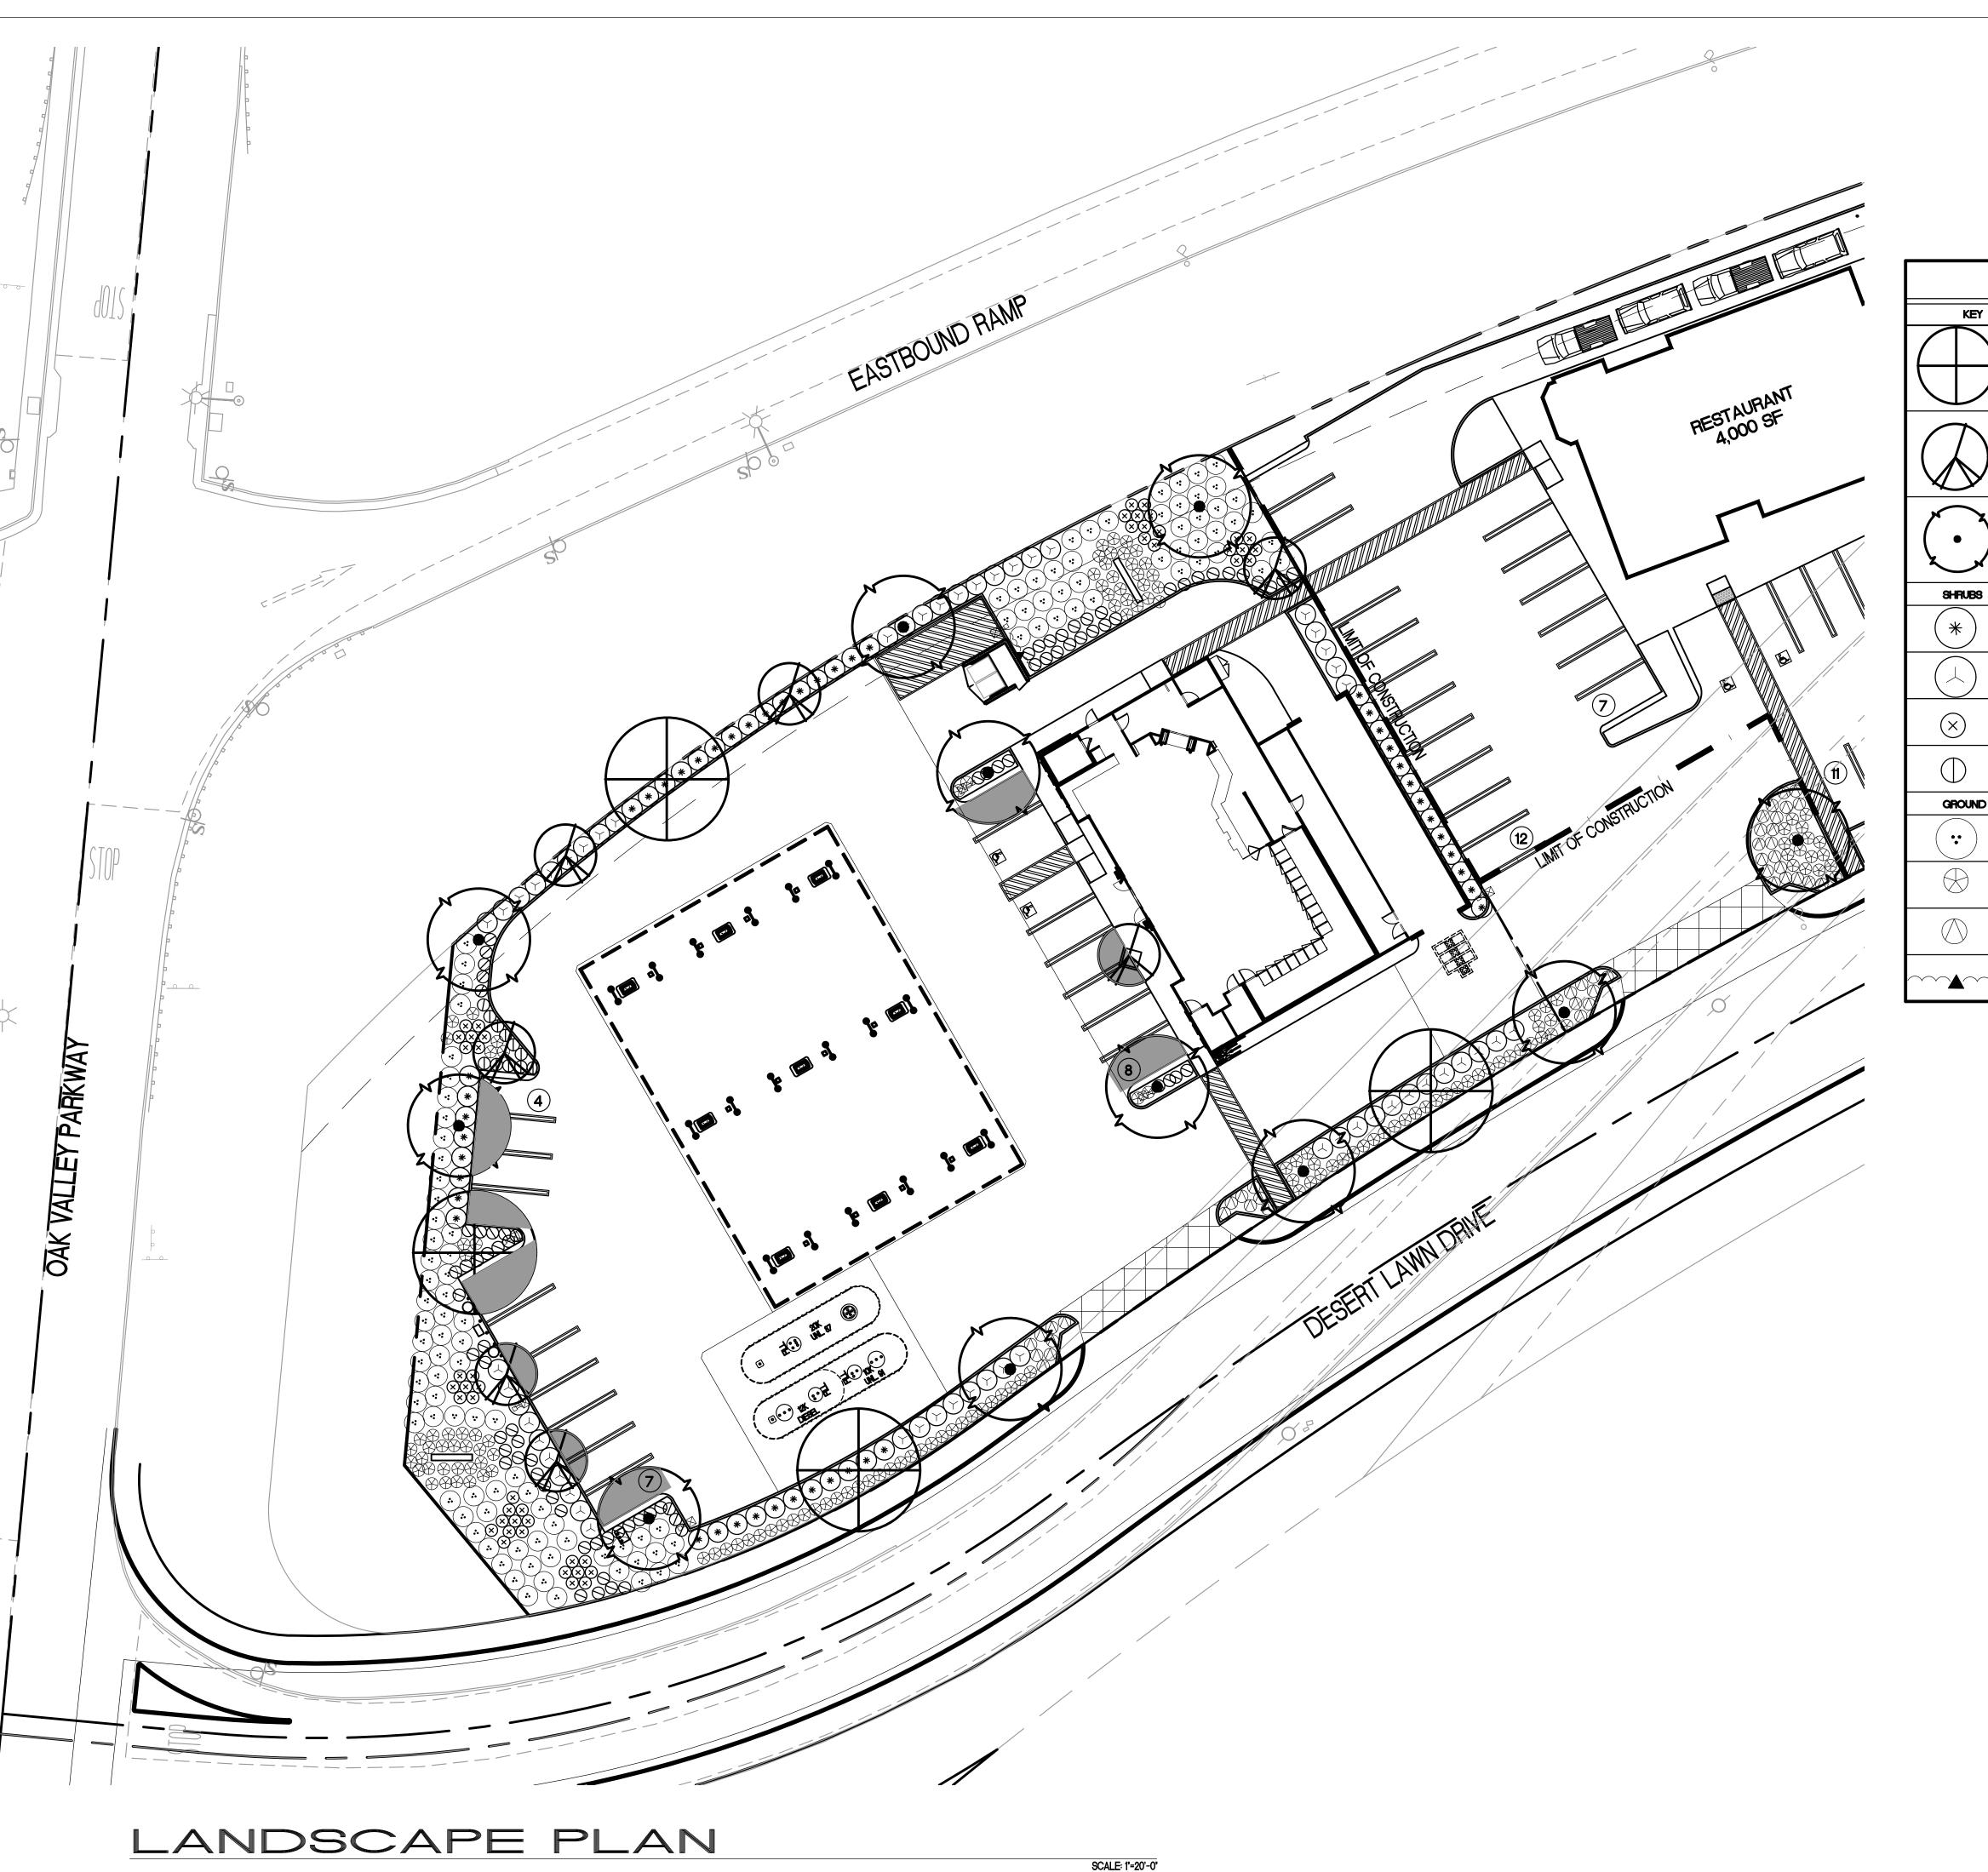

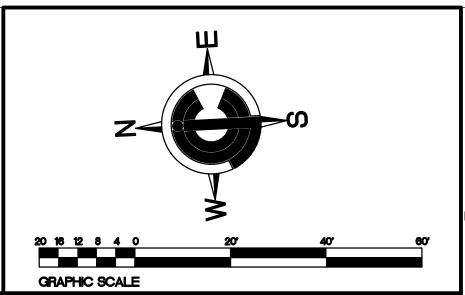

DATE SIGNED: _

KEY	BOTANICAL NAMES	COMMON NAMES	WULCOS	SIZE	SPACING	
	OLEA EUROPEA 'SWAN HILL'	FRUITLESS OLIVE	LOW	24" BOX	30' O.C.	
	LAURS NOBILIS 'SARATOGA'	BAY LAUREL	LOW	24" BOX	20' O.C.	ISSUES / REVISIONS 03/16/20 REV. PER CITY PLNG
	CERCIDIUM X 'DESERT MUSEUM'	DESERT MUSEUM PALO VERDE	LOW	24" BOX	30' O.C.	6
SHRUBS	_		_	_		
*	HETEROMELES ARBUTIFOLIA	TOYON	LOW	5 GALLON	5' O.C.	
(\downarrow)	LEUCOPHYLLUM FRUTESCENS 'GR. CLOUD'	TEXAS RANGER	LOW	5 GALLON	5' O.C.	DATE DESCRIPTION DRAWN BY: G. DE VERA
\otimes	CALLISTEMON VIMINALIS 'LITTLE JOHN'	DWARF BOTTLE BRUSH	LOW	5 GALLON	3' O.C.	CHK'D BY: F. COHEN 3800 AM/PM + CAR WASH S.E.C. OAK VALLEY PKWY
\bigcirc	HESPERALOE PARVIFLORA	RED YUCCA	LOW	5 GALLON	3' O.C.	INTERSTATE 10 BEAUMONT CA 92223
GROUND COVER			<u> </u>			PROJECT NAME AND ADDRESS
•	WESTRINGIA FRUTICOSA 'MUNDI'	MUNDI WESTRINGIA	LOW	5 GALLON	5' O.C.	7 Inc. Permitting Yorba Linda, CA 92887 Tel: (714) 920–9643 Fax: (714) 917.0250 www.cjccorp.com
\bigoplus	DIANELLA 'CASA BLUE' 'LITTLE JOHN'	BLUE DIANELLA	LOW	1 GALLON	3' O.C.	Perr Perr (714) 9 xx: (714) 9 vw.c.jcco
	ROSMARINUS OFFICINALIS 'PROSTRATUS'	PROSTRATE ROSEMARY	LOW	1 GALLON	3' O.C.	202, Yorba
~~ \	MACFADYENA UNGUIS-CATI 'PROSTRATUS'	CAT'S CLAW	LOW	5 GALLON	10' O.C.	ing Suite
**	RRIGATION CONCEPT: DRIP IRE	RIGATION WITH SING	LE HYD	ROZONE	1	Planning Avenue, Sui

PLANTING NOTES

- A. PLANTING PITS SHALL BE DUG WITH LEVEL BOTTOMS, THE WIDTH TWICE THE DIAMETER OF THE ROOTBALL AND 6" DEEPER THAN THE LENGTH OF THE ROOTBALL EACH PLANT PIT SHALL BE BACKFILLED WITH THE FOLLOWING PREPARED SOIL MIX: 2 PARTS NITROLIZED REDWOOD SHAVINGS 1 PART 'NITROHUMUS' 3 PARTS EXCAVATED SOIL 21 GRAM 'AGRIFORM' PLANTING TABLET
- PLANTING TABLETS SHALL BE APPLIED AS FOLLOWS:

 1 TABLET PER 1 GALLON SIZE PLANT

 2 TABLETS PER 5 GALLON SIZE PLANT

 3 TABLETS PER 15 GALLON SIZE PLANT LARGER PLANT MATERIAL WILL BE GIVEN ONE (1) TABLET PER 1/2 " DIAMETER OF TRUNK CALIPER
- B. PREPARED SOIL SHALL BE TAMPED FIRMLY AT BOTTOM OF PLANT PIT. FILL PREPARED SOIL AROUND BALL OF PLANT 1/2 WAY AND INSERT PLANT TABLETS. COMPLETE BACKFILLING AND WATER IN THOROUGHLY.
- C. TURF AREAS SHALL BE ROTOTILLED 3" DEEP WITH 3 CUBIC YARDS NITROLIZED REDWOOD SHAVINGS PER 100 SQ FT AFTER ROTOTILL SOIL SHALL BE GRADED SMOOTH

ALL SHRUB AND GROUNDCOVER AREAS TO RECEIVE 3" DEPTH SHREDDED BARK MULCH. SUBMIT SAMPLE TO CITY INSPECTOR FOR APPROVAL PRIOR TO INSTALLATION CONTRACTOR TO CONDUCT THEIR OWN PLANT MATERIAL QUANTITY TAKEOFFS CONTRACTOR TO CONDUCT AGRONOMIC SOIL TEST REPORT AND CONVEY RESULTS TO OWNER. TO BE PROVIDED WITH CONSTRUCTION DOCUMENTS SUBMITTAL.

TREE SHADING LEGEND:

PARKING AREA SHADED BY TREES

SHADING SUMMARY (ALL SHEETS)

TOTAL PARKING AREA: 3,2
EXCLUDES DRIVE AISLES AND FUELING CANOPY AREA 30% SHADING REQUIRE FOR UNCOVERED AREAS: 975 S.F. PARKING AREA SHADED BY TREES: 42% OF UNCOVERED PARKING

TREE SIZE SHOWN AT 10 YEARS MATURITY

SHADING NOTES

(1) 19' PARKING SPACE PER CITY MINIMUM REQUIREMENTS



SHEET TITLE

GAS STATION LANDSCAPE

