

City of Beaumont

550 E. 6th Street Beaumont, CA 92223 (951) 769-8520 www.ci.beaumont.ca.us

Case No. PW 2021-0741	
Receipt No. <u>R01183462</u>	
Receipt No. <u>ROH83462</u> Fee \$484.43 App /3,000.01	Insp
Date Paid	

BOND EXONERATION APPLICATION

Bond 7	Type: Performance Maintenance Final Monument In	nspection Other:
1.	Contact's Name Jeff Gertino	Phone858-922-1100
2.	Contact's Address 36310 Inland Valley Drive,	Wildomar, CA 92595
5.	Contact's E-mail jgertino@theeod.com	City/State/Zip
3.	Developer Name KB Home (If corporation or partnership application must include names of principal corporation or partnership application must include names of principal corporation or partnership application must include names of principal corporation or partnership application must include names of principal corporation or partnership application must include names of principal corporation or partnership application must include names of principal corporation or partnership application must include names of principal corporation or partnership application must include names of principal corporation or partnership application must include names of principal corporation or partnership application must include names of principal corporation or partnership application must include names of principal corporation or partnership application must include names of principal corporation or partnership application must include names of principal corporation or partnership application must include names of principal corporation or partnership application or partnership	Phone 951-691-5239 pal officers or partners)
4.	Developer Address 36310 Inland Valley Drive	Wildomar, CA 92595 City/St/Zip
5.	Description of Bonds (including Bond Number, Tract Map number, and description of improvements covered): Bond Number - 1047933-M; Tract #36558; 1 year Ma Sewer; 1 Year maintenance period ended on 8/1/202	/Application number, Lot
6.	CERTIFICATION OF ACCURACY AND COMPLET to the best of my knowledge the information in this applica and exhibits are true, complete, and correct.	•
	Print Name and Sign - Contact/Applicant	Date
7.	Contractor shall indemnify, defend, and hold harmless the employees and volunteers from and against any and all liab costs (including without limitation costs and fees of litigation of or in connection with contractor's performance of work comply with any of its obligations for which this Bond exo for such loss or damage which was caused by the active negative.	only of every nature arising out thereunder or its failure to neration is requested, except
	Orm	8(26/21
	Print Name and Sign - Contact/Applicant Attento A Good	Date

- 8. Developer/Contractor has completed all the following items prior to requesting release or has included them in the application.
 - Remove and replace concrete and AC as needed where lifting.
 - Provide AC crack fill as needed. Crack fill/seal shall be hot asphaltic emulsion.
 - Provide Type II slurry coat for all road surfaces.
 - Restore/Verify pavement striping/markings.
 - Restore/Verify blue dots and signage as needed.
 - Clean and camera sewer. Provide report and video copy of camera survey.
 - Provide all final geotechnical reports.
 - Provide Engineers' certification for line and grade within Right-of-Way.
 - Provide Landscape Architects Certification as required.

JEFF M. LAERHIND

Print Name and Sign – Contact/Applicant

Authorizes Agest

2/26/21 Date

Bond No: 1047933-M

MAINTENANCE BOND

WHEREAS, the City of Beaumont ("City"), a municipal corporation, and KB Home California LLC
(hereinafter "principal"), have entered into an agreement by which Principal agrees to install and complet
certain designated public improvements and to guarantee and warrant the work for the period of one year
following its completion and acceptance, which said agreement, dated, and
identified as Tract Map No. 36558 is hereby referred to and made a part hereof; and:
WHEREAS, Principal is required under the terms of the agreement to furnish a bond to guarantee and warrant the work for a period of one year following its completion and acceptance against any defective work or labor done, or defective materials furnished, to comply with the terms of the agreement.
NOW, THEREFORE, we, the principal and The Hanover Insurance Company surety admitted and duly
enthorized to transact husiness under the laws of the State of California as questy, are held and firmly
authorized to transact business under the laws of the State of California as surety, are held and firmly bound unto the City of Beaumont as obligee, in the penal sum of Hundred Twenty Five & 32/100 dollars (\$\frac{272,325.32}{\text{325.32}}\$) lawful money of the United States, for the payment of which sum well and truly to be
made, we bind ourselves, our heirs, successors, executors, and administrators, jointly and severally, firmly
by these presents.
The condition of this obligation is such that if the above bounded principal, his or its heirs, executors,

The condition of this obligation is such that if the above bounded principal, his or its heirs, executors, administrators, successors or assigns, shall in all things stand to and abide by, provisions in the agreement and any alteration thereof made as therein provided, on his or its part to be kept and performed at the time and in the manner therein specified, and in all respects according to their true intent and meaning, and shall indemnify and save harmless the City of Beaumont, its officers, agents and employees, as therein stipulated, then this obligation shall become null and void; otherwise it shall be and remain in full force and effect.

As a condition precedent to the satisfactory completion of the agreement, the obligation of the Principal and surety under this bond shall remain in effect for a period of one (1) year after the completion and acceptance of the work. During that time, if the Principal or the Principal's, his or its heirs, executors, administrators, successors or assigns, fails to make full, complete and satisfactory repair and replacement or totally protect the City from any loss or damage made evident during that year which results from or is caused by either defective materials or faulty workmanship in the prosecution of the work, then the obligation shall remain in full force and effect. However, anything in this paragraph to the contrary notwithstanding, the obligation of the Surety shall continue so long as any obligation of the Principal remains.

As a part of the obligation secured hereby and in addition to the face amount specified therefor, there shall be included costs and reasonable expenses and fees, including reasonable attorney's fees, incurred by the City of Beaumont in successfully enforcing such obligation, all to be taxed as costs and included in any judgment rendered.

The surety hereby stipulates and agrees that no change, extension of time, alteration of addition to the terms of the agreement or to the work to be performed there under or the specifications accompanying the same shall in anywise affect its obligations of this bond, and it does hereby waive notice of any such change, extension of time, alteration or addition to the terms of the agreement or to the work or to the specifications. The surety waives all rights of subrogation against the City or any person employed by the City.

SIGNED AND SEALED THIS	8th	DAY OF	May	2020.	Replaces Bond issued on March 17,	2020

(Seal)	(Seal)
The Hanover Insurance Company	KB Home California LLC
By: Muldelly	PRINCIPAL By:
Brenda Wong, Attorney-in-Fact	MOTTHON RIZZE UPF
(Name)	(Name)
(Address)	(Title)
	(Address)
	By:
	(Name)
The Hanover Insurance Company	(Title)
440 Lincoln St, Worcester, MA 01653	(Title) (Address)
,	(Address)

ALL SIGNATURES MUST BE ACKNOWLEDGED BY A NOTARY PUBLIC

A notary public or other officer completing this certificate verifies only the identity of the individual who signed the document to which this certificate is attached, and not the truthfulness, accuracy, or validity of that document.
STATE OFCalifornia)SS COUNTY OFRiverside) OnMay 12, 2020 , before me,Christina Villa, Notary Public, personally appearedMatthew Rizzo
who proved to me on the basis of satisfactory evidence to be the person(s) whose name(s) is/are subscribed to the within instrument and acknowledged to me that he/she/they executed the same in his/her/their authorized capacity(ies), and that by his/her/their signature(s) on the instrument the person(s), or the entity upon behalf of which the person(s) acted, executed the instrument.
I certify under PENALTY OF PERJURY under the laws of the State of California that the foregoing paragraph is true and correct.
Signature CHRISTINA VILLA Notary Public - California Riverside County Commission # 2321325 My Comm. Expires Feb 13, 2024
My Commission Expires: February 13, 2024 This area for official notarial seal
Notary Name: <u>Christina Villa</u> Notary Phone: <u>(951) 691-5300</u> Notary Registration Number: <u>2321325</u> County of Principal Place of Business: <u>Riverside</u>

CALIFORNIA ALL-PURPOSE ACKNOWLEDGMENT CIVIL CODE §1189

A notary public or other officer completing this certificate verifies only the identity of the individual who signed the document to which this certificate is attached, and not the truthfulness, accuracy, or validity of that document.

State of California	
County of Los Angeles	
OnMAY 0 8 2020before me, _R.Rangel, Notary Public, personally appearedBrenda Wong who proved to me on the basis of satisfactory evidence to be the person(s) whose name(s) is/are-subscribed to the within instrument and acknowledged to me that he/she/they executed the same in his/her/their authorized capacity(ies), and that by his/her/their-signature(s) or the instrument the person(s), or the entity upon behalf of which the person(s) acted, executed the instrument.	n
I certify under PENALTY OF PERJURY under the laws of the State of California the foregoing paragraph is true and correct.	hat
WITNESS my hand and official seal.	
(seal) Signature R. Rangel, Notary Public	
R. RANGEL	

THE HANOVER INSURANCE COMPANY MASSACHUSETTS BAY INSURANCE COMPANY CITIZENS INSURANCE COMPANY OF AMERICA

POWER OF ATTORNEY

THIS Power of Attorney limits the acts of those named herein, and they have no authority to bind the Company except in the manner and to the extent herein stated.

KNOW ALL PERSONS BY THESE PRESENTS:

That THE HANOVER INSURANCE COMPANY and MASSACHUSETTS BAY INSURANCE COMPANY, both being corporations organized and existing under the laws of the State of New Hampshire, and CITIZENS INSURANCE COMPANY OF AMERICA, a corporation organized and existing under the laws of the State of Michigan, (hereinafter individually and collectively the "Company") does hereby constitute and appoint,

Mechelle Larkin, My Hua, Kathy R. Mair, Regina Rangel, Brenda Wong, Tenzer V. Cunningham, Martha Gonzales and/or Joaquin Perez

Of Marsh Risk & Insurance Services, Inc. of Los Angeles, CA each individually, if there be more than one named, as its true and lawful attorney(s)-in-fact to sign, execute, seal, acknowledge and deliver for, and on its behalf, and as its act and deed any place within the United States, any and all surety bonds, recognizances, undertakings, or other surety obligations. The execution of such surety bonds, recognizances, undertakings or surety obligations, in pursuance of these presents, shall be as binding upon the Company as if they had been duly signed by the president and attested by the secretary of the Company, in their own proper persons. Provided however, that this power of attorney limits the acts of those named herein; and they have no authority to bind the Company except in the manner stated and to the extent of any limitation stated below:

Any such obligations in the United States, in any amount

That this power is made and executed pursuant to the authority of the following Resolutions passed by the Board of Directors of said Company, and said Resolutions remain in full force and effect:

RESOLVED: That the President or any Vice President, in conjunction with any Vice President, be and they hereby are authorized and empowered to appoint Attorneys-in-fact of the Company, in its name and as it acts, to execute and acknowledge for and on its behalf as surety, any and all bonds, recognizances, contracts of indemnity, waivers of citation and all other writings obligatory in the nature thereof, with power to attach thereto the seal of the Company. Any such writings so executed by such Attorneys-in-fact shall be binding upon the Company as if they had been duly executed and acknowledged by the regularly elected officers of the Company in their own proper persons.

RESOLVED: That any and all Powers of Attorney and Certified Copies of such Powers of Attorney and certification in respect thereto, granted and executed by the President or Vice President in conjunction with any Vice President of the Company, shall be binding on the Company to the same extent as if all signatures therein were manually affixed, even though one or more of any such signatures thereon may be facsimile. (Adopted October 7, 1981 – The Hanover Insurance Company; Adopted April 14, 1982 — Massachusetts Bay Insurance Company; Adopted September 7, 2001 – Citizens Insurance Company of America and affirmed by each Company on March 24, 2014)

IN WITNESS WHEREOF, THE HANOVER INSURANCE COMPANY, MASSACHUSETTS BAY INSURANCE COMPANY and CITIZENS INSURANCE COMPANY OF AMERICA have caused these presents to be sealed with their respective corporate seals, duly attested by two Vice Presidents, this 6th day of **November, 2019**.

THE HANOVER INSURANCE COMPANY
MASSACHUSETTS BAY INSURANCE COMPANY
CITIZENS INSURANCE COMPANY OF AMERICA

Dryan J Savatore, Executive Vice President

THE HANOVER INSURANCE COMPANY MASSACHUSETTS BAY INSURANCE COMPANY CITIZENS INSURANCE COMPANY OF AMERICA

lanes H. Kawiecki, Vice President

THE COMMONWEALTH OF MASSACHUSETTS COUNTY OF WORCESTER

ΓS) \ss

On this 6th day of **November, 2019** before me came the above named Executive Vice President and Vice President of The Hanover Insurance Company, Massachusetts Bay Insurance Company and Citizens Insurance Company of America, to me personally known to be the individuals and officers described herein, and acknowledged that the seals affixed to the preceding instrument are the corporate seals of The Hanover Insurance Company, Massachusetts Bay Insurance Company and Citizens Insurance Company of America, respectively, and that the said corporate seals and their signatures as officers were duly affixed and subscribed to said instrument by the authority and direction of said Corporations.

ARLEEN V. SIMONS
Notary Public
COMMONNEAUTH OF MASSACHUSETTS
My Commission Expires
June 15, 2023

Arieen V. Simons, Notary Public My Commission Expires June 15, 2023

I, the undersigned Vice President of The Hanover Insurance Company, Massachusetts Bay Insurance Company and Citizens Insurance Company of America, hereby certify that the above and foregoing is a full, true and correct copy of the Original Power of Attorney issued by said Companies, and do hereby further certify that the said Powers of Attorney are still in force and effect.

GIVEN under my hand and the seals of said Companies, at Worcester, Massachusetts, this

day of MAY 0 8 2020

CERTIFIED COPY

THE HANOVER INSURANCE COMPANY
MASSACHUSETTS BAY INSURANCE COMPANY
CITIZENS INSURANCE COMPANY OF AMERICA

Carrick A. Bligh, Vice President



City of Beaumont

550 E. 6th Street Beaumont, CA 92223

Phone: (951) 769-8520 · Fax: (951) 769-8526

March 4, 2020

KB Homes

Attn: Jeanne Fite

RE: Bond #1047933 Street, Sewer, and Storm Drain Improvements Tract 36558

Dear Jeanne,

The City of Beaumont has received your request in regards to a reduction of bonds in the above referenced tract. Upon receipt of a maintenance bond in the amount listed below, the city will return the original Performance bond 45 days after recordation and replace it with the maintenance bond to be in place for no less than one year. The amount is as follows:

Project Name	Maintenance Amount	
Tract 36558 Street, Sewer, & Storm Drain	\$272,325.32	

If you wish to discuss this matter further please do not hesitate to contact me at (951) 769-8520 ext. 329

Thank you,


Suzanne Foxworth Public Works Technician

SITE LOCATION OAK VALLEY

GENERAL NOTES:

- 1. THE CONTRACTOR SHALL BE RESPONSIBLE FOR THE CLEARING OF THE PROPOSED WORK AREA, RELOCATION COSTS OF ALL EXISTING UTILITIES. PERMITTEE MUST INFORM CITY OF CONSTRUCTION SCHEDULE AT LEAST 48 HOURS PRIOR TO BEGINNING OF CONSTRUCTION. AT (951) 769-8520.
- 2. ALL WORK SHALL CONFORM TO THE REQUIREMENTS OF THE RIVERSIDE COUNTY TRANSPORTATION DEPARTMENT IMPROVEMENT STANDARDS AND SPECIFICATIONS, "LATEST EDITION," COUNTY ORDINANCE NO. 461 AND SUBSEQUENT AMENDMENT.
- 3. ALL UNDERGROUND FACILITIES, WITH LATERALS, SHALL BE IN PLACE PRIOR TO PAVING THE STREET INCLUDING, BUT NOT LIMITED TO, THE FOLLOWING; SEWER, WATER, ELECTRIC, GAS AND STORM DRAIN.
- 4. IT SHALL BE THE RESPONSIBILITY OF THE CONTRACTOR OR DEVELOPER TO INSTALL AND MAINTAIN ALL CONSTRUCTION, REGULATORY, GUIDE AND WARNING SIGNS WITHIN THE PROJECT LIMITS AND ITS SURROUNDINGS TO PROVIDE SAFE PASSAGE FOR THE TRAVELING PUBLIC AND WORKERS UNTIL THE FINAL COMPLETION AND ACCEPTANCE OF THE PROJECT BY THE CITY.
- 5. ANY PRIVATE DRAINAGE FACILITIES SHOWN ON THESE PLANS ARE FOR INFORMATION ONLY. BY SIGNING THESE IMPROVEMENT PLANS, NO REVIEW OR APPROVAL OF THESE PRIVATE FACILITIES IS IMPLIED OR INTENDED BY CITY OF BEAUMONT PUBLIC WORKS DEPARTMENT.
- 6. IT SHALL BE THE RESPONSIBILITY OF THE DEVELOPER/OWNER OR CONTRACTOR TO APPLY TO THE CITY OF BEAUMONT PUBLIC WORKS DEPARTMENT, PERMIT SECTION, FOR ENCROACHMENT PERMIT FOR ALL WORK PERFORMED WITHIN PUBLIC RIGHT-OF-WAY, DEDICATED AND ACCEPTED FOR PUBLIC USE; AND TO BE RESPONSIBLE FOR SATISFACTORY COMPLIANCE FOR ALL CURRENT ENVIRONMENTAL REGULATIONS DURING THE LIFE OF CONSTRUCTION ACTIVITIES FOR THIS PROJECT. ADDITIONAL STUDIES AND/OR PERMIT MAY BE REQUIRED.
- 7. THE DEVELOPER WILL INSTALL STREET NAME SIGNS CONFORMING TO COUNTY STANDARD NO. 816.
- 8. ALL STREET SECTIONS ARE TENTATIVE. ADDITIONAL SOIL TESTS SHALL BE TAKEN AFTER ROUGH GRADING TO DETERMINE THE EXACT STREET SECTION REQUIREMENTS. USE STANDARD NO. 401 IF EXPANSIVE SOIL ARE ENCOUNTERED.
- 9. IT SHALL BE THE RESPONSIBILITY OF THE DEVELOPER TO NOTIFY THE ENGINEER TO INSTALL STREET CENTERLINE MONUMENTS AS REQUIRED BY RIVERSIDE COUNTY ORDINANCE NO. 461.
- 10. ASPHALTIC EMULSION (FOG SEAL) SHALL BE APPLIED NOT LESS THAN FOURTEEN DAYS FOLLOWING PLACEMENT OF THE ASPHALT SURFACING. FOG SEAL AND PAINT BINDER SHALL BE APPLIED AT A RATE OF 0.05 AND 0.03 GALLON PER SQUARE YARD RESPECTIVELY. ASPHALTIC EMULSION SHALL CONFORM TO SECTION 37, 39 AND 94 OF THE STATE STANDARD SPECIFICATIONS.
- 11. AS DETERMINED BY THE PUBLIC WORKS DIRECTOR, THE DEVELOPER IS RESPONSIBLE AS A MINIMUM FOR ROAD IMPROVEMENTS TO CENTERLINE, AND MAY BE REQUIRED TO RECONSTRUCT EXISTING PAVEMENT, INCLUDING BASE, AND MATCHING OVERLAY REQUIRED TO MEET THE STRUCTURAL STANDARDS FOR THE CURRENT ASSIGNED TRAFFIC INDEX.
- 12. CONSTRUCTION PROJECTS DISTURBING MORE THAN ONE ACRE MUST OBTAIN A NATIONAL POLLUTANT DISCHARGE ELIMINATION SYSTEM (NPDES) PERMIT. OWNERS/DEVELOPERS ARE REQUIRED TO FILE A NOTICE OF INTENT (NOI) WITH THE STATE WATER RESOURCES CONTROL BOARD (SWRCB), PREPARE A STORM WATER POLLUTION PREVENTION PLAN (SWPPP) AND MONITORING PLAN FOR THE SITE.
- 13. THE DEVELOPER SHALL BE RESPONSIBLE FOR THE INSTALLATION OF ADDITIONAL SIGNS AND MARKINGS NOT INCLUDED IN THE SIGNING AND STRIPING PLAN WITHIN THE PROJECT AREAS, OR ON ROADWAYS ADJACENT TO THE PROJECT BOUNDARIES, UPON THE REQUEST OF THE DIRECTOR OF PUBLIC WORKS OR HIS DESIGNEE TO IMPROVE TRAFFIC SAFETY ON THE ROADS UNDER THE JURISDICTION OF THE DEVELOPER.
- 14. EXISTING STORM DRAIN PIPES / CULVERTS (WHETHER TO BE CONNECTED TO, EXTENDED, ADJUSTED, DRAINED TO, OR JUST IN THE PROJECT VICINITY) MUST BE REPAIRED, AND/OR CLEANED TO MAKE THEM FUNCTIONAL AND ACCEPTABLE AS DIRECTED BY THE PUBLIC WORKS DEPARTMENT.
- 15. ALL STORM DRAIN, CATCH BASINS AND STORM WATER RUNOFF STRUCTURES WILL BE PROVIDED WITH ADEQUATE CAPABILITIES TO FILTER AND RETAIN SEDIMENT AND GRIT, OIL AND GREASE, TO PREVENT POLLUTION IN STORM WATER RUNOFF IN COMPLIANCE WITH THE CITY OF BEAUMONT'S BEST MANAGEMENT PRACTICES AND THE BEAUMONT DRAINAGE MASTER PLAN FOR STORM WATER AS WELL AS BEST MANAGEMENT PRACTICES IDENTIFIED IN THE CURRENT REPORT OF WASTE DISCHARGE FOR RIVERSIDE COUNTY PERMITTEES.
- 16. DEVELOPER SHALL BE FULLY RESPONSIBLE IN ASSURING THAT PROPOSED IMPROVEMENTS CONFORM TO THE APPROVED PLANS. SPECIFICATIONS AND CITY OF BEAUMONT STANDARDS. WHERE DEVIATIONS EXIST, DEVELOPER SHALL PROPOSE CORRECTIVE MEASURES FOR REVIEW AND APPROVAL BY THE CITY.
- 17. THE DEVELOPER SHALL HAVE GEOTECHNICAL/SOILS ENGINEERING FIRM OBSERVE TRENCHING, BACKFILLING, AND SOIL COMPACTION OF ALL UTILITY TRENCHES WITHIN EASEMENTS AND ROAD RIGHT OF WAY. TWO SETS OF COMPACTION REPORTS CERTIFYING THAT WORKS WERE DONE IN CONFORMANCE TO STANDARDS AND GEOTECHNICAL REPORT SHALL BE SUBMITTED AFTER EACH UTILITY TRENCH IS COMPLETED AND CERTIFIED. COMPACTION REPORT MUST BE SUBMITTED TO THE DEPARTMENT OF PUBLIC WORKS AT LEAST TWO WORKING DAYS BEFORE AGGREGATE BASE MATERIALS ARE PLACED ONSITE.

CITY OF BEAUMONT, CALIFORNIA STREET IMPROVEMENT PLANS TRACT NO. 36558

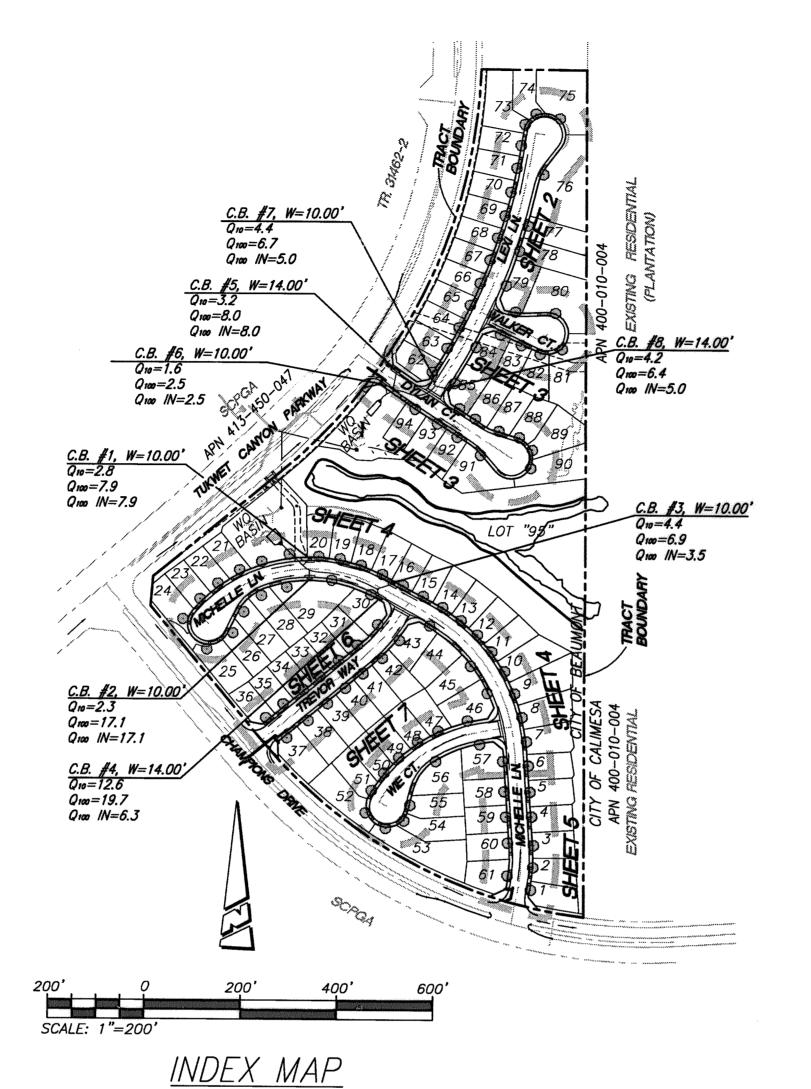

CONSTRUCTION NOTES AND ESTIMATED QUANTITIES

(2) CONSTRUCT TYPE A-6 CURB PER COUNTY OF RIVERSIDE STANDARD NO. 200

(7) CONSTRUCT SIDEWALK PER COUNTY OF RIVERSIDE STANDARD PLAN NO. 401

(8) CONSTRUCT CROSS-GUTTER PER COUNTY OF RIVERSIDE STANDARD NO. 209

(6) CONSTRUCT CONCRETE DRIVEWAY APPROACH PER RIVERSIDE COUNTY STANDARD NO. 207

(9) CONSTRUCT GUTTER DEPRESSION, CASE B, PER RIVERSIDE COUNTY STANDARD NO. 311

(10) CONSTRUCT GUTTER DEPRESSION, CASE C. PER RIVERSIDE COUNTY STANDARD NO. 311

3) SAWCUT AND REMOVE EX. PAVEMENT PER PLAN. SEE SAWCUT AND OVELAY DETAIL THIS SHEET

(14) COLD PLANE AND OVERLAY EX. PAVEMENT PER PLAN (0.10' MIN.) SEE SWACUT AND OVERLAY DETAIL THIS SHEET

CONSTRUCT CURB RAMP PER COUNTY OF RIVERSIDE STANDARD NO. 403, CASE A

(1) CONSTRUCT 0.25' A.C. OVER 0.50' A.B.


(DRIVEWAY S.F. REMOVED FROM QUANTITY)

(16) INSTALL STREET TREES (PER LANDSCAPE PLANS)

2) INSTALL STREET NAME SIGN PER RIVERSIDE STD. NO. 816

LEGEND

	The Glas IVI		
PROP.	PROPOSED	FH	FIRE HYDRANT
EXIST.	EXISTING	ST	STREET
CL, C/L	CENTERLINE	R/W	RIGHT OF WAY
TC	TOP OF CURB	D/W	DRIVEWAY
FL	FLOW LINE	V.C.	VERTICAL CURVE
FS	FINISHED SURFACE	PI	POINT OF INTERSECTION
EP	EDGE OF PAVEMENT	PVI	POINT OF VERTICAL INTERSECTION
CB	CATCH BASIN		BOUNDARY
AC	ASPHALTIC CONCRETE		CENTER LINE
AB	AGGREGATE BASE		DIRECTION OF FLOW
BCR	BEGIN CURB RETURN	*	PROP. STREET LIGHTS
ECR	END CURB RETURN		
BVC	BEGIN VERTICAL CURVE		PROP. A.C.
MVC	MIDDLE VERTICAL CURVE	777777	COLD PLANE
EVC	END VERTICAL CURVE	1	STOP SIGN
PRC	POINT OF REVERSE CURVE	**	STUP SIGN
PCC	POINT OF COMPOUND CURVE		EXISTING FIRE HYDRANT
PRVC	POINT OF REVERSE VERTICAL CURVE	- -	STREET NAME SIGN
(1329.02)	EXISTING ELEVATION	1	
1479.70	PROPOSED ELEVATION	©	PROP. STREET TREE
LT	LEFT		
RT	RIGHT		

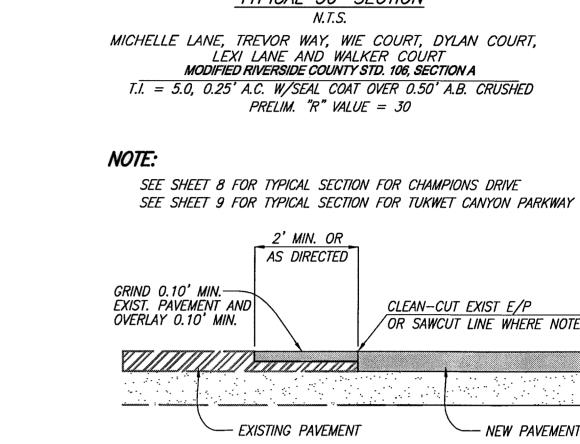

SAWCUT AND OVERLAY DETAIL

N.T.S.

ALL UNDERGROUND UTILITIES OR STRUCTURES REPORTED BY THE OWNER OR OTHERS AND THOSE SHOWN ON THE RECORD EXAMINED ARE INDICATED WITH THEIR APPROXIMATE LOCATION AND EXTENT. THE OWNER BY ACCEPTING THESE PLANS OR PROCEEDING WITH IMPROVEMENTS PURSUANT THERETO AGREES TO ASSUME LIABILITY AND TO HOLD UNDERSIGNED HARMLESS FOR ANY DAMAGES RESULTING FROM THE EXISTENCE OF UNDERGROUND UTILITIES OR STRUCTURES NOT REPORTED TO THE UNDERSIGNED; NOT OR SHOWN ON RECORDS EXAMINED. THE CONTRACTOR IS REQUIRED TO TAKE DUE PRECAUTIONARY MEASURES TO PROTECT THE UTILITIES OR STRUCTURES SHOWN AND ANY OTHER UTILITIES OR STRUCTURES FOUND AT THE SITE. IT SHALL BE THE CONTRACTOR'S RESPONSIBILITY TO NOTIFY THE OWNERS OF THE UTILITIES OR STRUCTURES CONCERNED BEFORE STARTING WORK.

UNDERGROUND STRUCTURES

TOTAL

115,950 S.F.

6,692 L.F.

47,375 S.F.

3,174 S.F.

3 EA.

3 EA.

8 EA.

4 EA.

108 S.F.

216 S.F.

104 EA.

210 S.F.

DECLARATION OF ENGINEER OF RECORD:

I HEREBY DECLARE THAT IN MY PROFESSIONAL OPINION, THE DESIGN OF THE PLAN CHECK OF THESE PLANS BY THE CITY OF BEAUMONT IS A REVIEW FOR THE PROCESS IS NOT A DETERMINATION OF THE TECHNICAL ADEQUACY OF THE DESIGN OF THE IMPROVEMENTS. SUCH PLAN CHECK DOES NOT THEREFORE RELIEVE ME OF

AS THE ENGINEER OF RECORD, I AGREE TO DEFEND AND INDEMNIFY THE CITY OF BEAUMONT, ITS OFFICERS, ITS AGENTS, AND ITS EMPLOYEES FROM ANY AND ALL LIABILITY. CLAIMS, DAMAGES, OR INJURIES TO ANY PERSON OR PROPERTY ARISING FROM NEGLIGENT ACTS, ERRORS OR OMISSIONS OF THE ENGINEER OF RECORD, HIS EMPLOYEES. HIS AGENTS OR HIS CONSULTANTS.

TOTAL

7 EA.

4 EA.


4 EA.

1 EA.

160 L.F.

212 L.F.

4 EA.

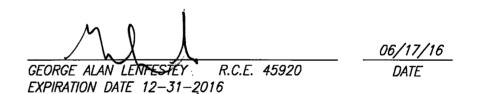

NOTE:


- 1. APPROVAL OF THESE PLANS APPLY ONLY WITHIN THE JURISDICTION OF THE CITY OF BEAUMONT
- 2. TRENCHING FOR UTILITIES AND STRUCTURES IS NOT ALLOWED UNTIL SOIL COMPACTION REPORT IS SUBMITTED AND APPROVED BY THE PUBLIC WORK DEPARTMENT.
- THE CITY RESERVES THE RIGHT TO REQUIRE REVISION OF THE APPROVED PLANS TO CONFORM WITH CURRENT STANDARDS AND TO POST A NEW BOND IF CONSTRUCTION HAS NOT COMMENCED
- 4. SIDEWALKS AND DRIVEWAYS APPROACHES WILL BE POURED/CONSTRUCTED ONLY AFTER DRIVEWAY LOCATIONS ARE DETERMINED.

PREPARED BY:

PROACTIVE ENGINEERING CONSULTANTS WEST, INC. 25109 JEFFERSON AVENUE SUITE 200 MURRIETA, CA 92562 (951) 200-6840

APPLICANT/SUBDIVIDER:

ARGENT MANAGEMENT 2392 MORSE AVE. IRVINE, CA 92614 (949) 777-4000 OFFICE (949) 241-8439 OFFICE CONTACT: DEREK HICKS

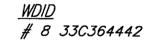

INDEX OF SHEETS:

SHEET 1 - TITLE SHEET - VICINITY MAP - GENERAL NOTES -LEGEND - CONSTRUCTION NOTES - QUANTITIES -

INDEX MAP — TYPICAL SECTION SHEET 2 - LEXI LANE 10+00 to 16+32.47

SHEET 3 - DYLAN CT. 10+73.84 to 13+96.61 WALKER CT. 10+00 to 11+48.09 SHEET 4 - MICHELLE LANE 10+00 to 19+50.00

SHEET 5 - MICHELLE LANE 19+50.00 to 22+09.89 SHEET 6 - TREVOR WAY 10+00 to 14+78.07 SHEET 7 - WIE COURT 10+00 to 13+41.42

SHEET 8 - SIGNING AND STRIPING

DIAL TOLL FREE AT LEAST TWO DAYS BEFORE YOU DIG

UNDERGROUND SERVICE ALERT OF SOUTHERN CALIFORNIA


BASIS OF BEARINGS: DESCRIPTION: THE BASIS OF COORDINATES FOR THIS MAP IS THE CALIFORNIA STATE PLANE COORDINATE SYSTEM. 1983, ZONE 6, BASED LOCALLY ON CONTROL STATIONS "REST" AND "RABBIT"

DESCRIPTION: USGS MONUMENT "REST" BENCHMARK DISK SET IN TOP OF CONCRETE MONUMENT STAMPED "REST 1972" ON DESERT LAWN DRIVE ACROSS THE DRIVE FROM DESERT LAWN CEMETERY 25.3 FT. N.E. OF THE DRIVE CENTERLINE 24.9 FT. S.W. OF THE S.W. EDGE OF THE SOUTH EASTBOUND LANES OF INTERSTATE HIGHWAY 10

BY MARK

CONSULTANTS WEST, INC. 25109 JEFFERSON AVE. SUITE 200 MURRIETA, CA 92562 951-200-6840 PROACTIVE ENGINEERING WEST APPR. DATE

PROACTIVE ENGINEERING No. 45920 Exp. 12/31/16 06/17/16

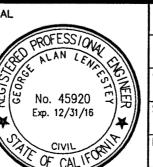

CHECKED BY: 06/17/16

OB NUMBER:

06.002.000

(40) INSTALL R1 STOP SIGN ON STREET NAME SIGN POST

(45) INSTALL R41 "RIGHT TURN ONLY" SIGN

48) SANDBLAST AND REMOVE EXISTING STRIPING

(47) APPLY TYPE IV ARROW

(41) THERMOPLASTIC WHITE LIMIT LINE PER CALTRANS STANDARD A24E

6) APPLY 8" SOLID WHITE CHANNELIZING LINE PER DETAIL 38

(42) THERMOPLASTIC "STOP" PAVEMENT MARKING PER CALTRANS STANDARD A24D

Reviewed By PEC Recommended for PEC AS NOTED City of Beaumont, Public Works Department

Staff Engineer

Date: ____ _ Date: & | 가/#

CITY OF BEAUMONT, CALIFORNIA STREET IMPROVEMENT PLANS TRACT NO. 36558

TITLE SHEET AND INDEX MAP

SHEE

OF **8** SHEET!

DRAWING NAME:


Plotted: Jun 17, 2016 - 2:35pm By: mikehanna DWG: Z:\01.104.000 FC-PA14\Drawings\Street Improvements\36558-SHT-01.dwg


BEARING: N 27'39'52" I GEORGE ALAN LENPESIEY R.C.E. 45920 EXP. 12-31-2010 ELEV. 2491.44. NGVD 29 **ENGINEER** REVISIONS

DESCRIPTION

Engineering Division

209 L ARGENT MANAGEMENT

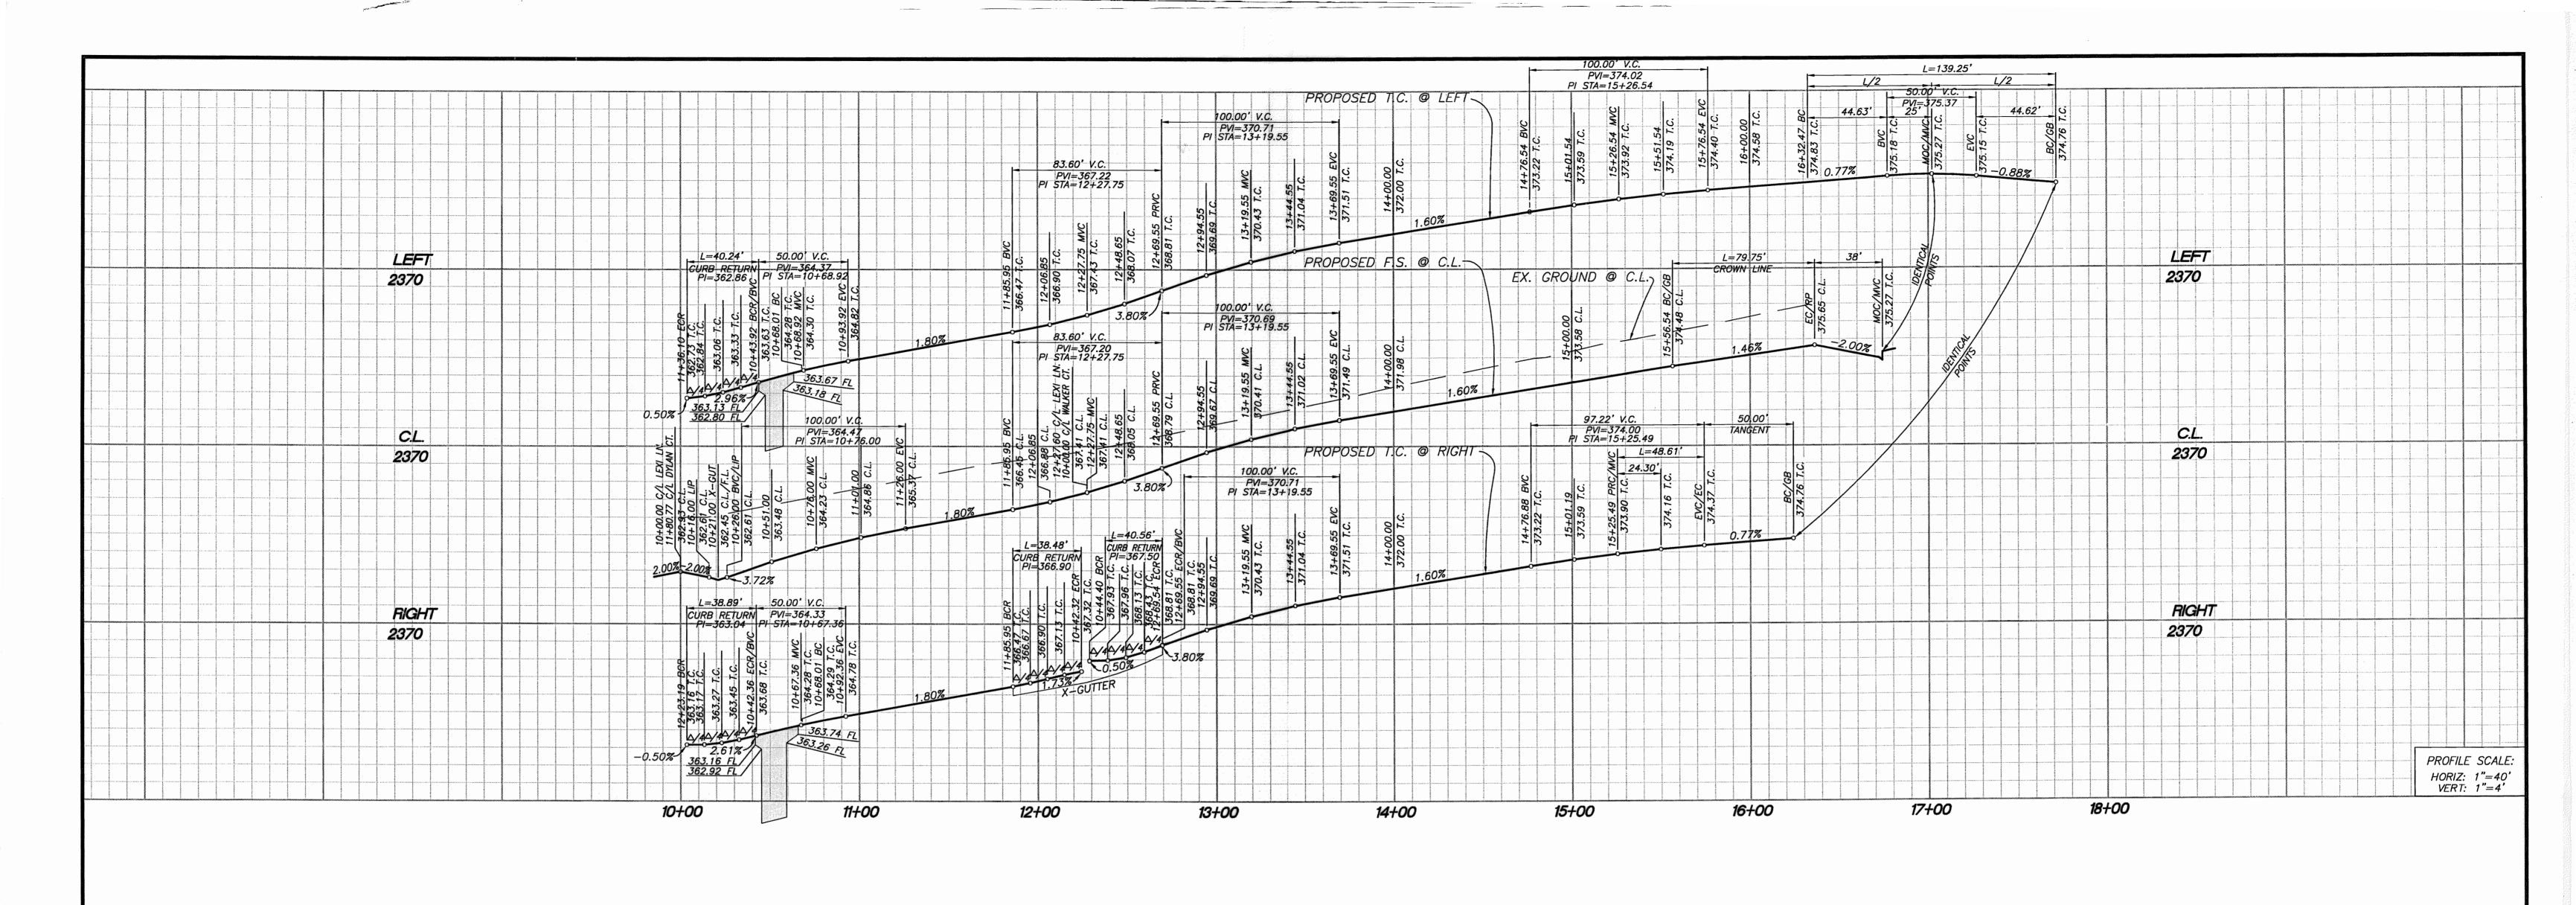

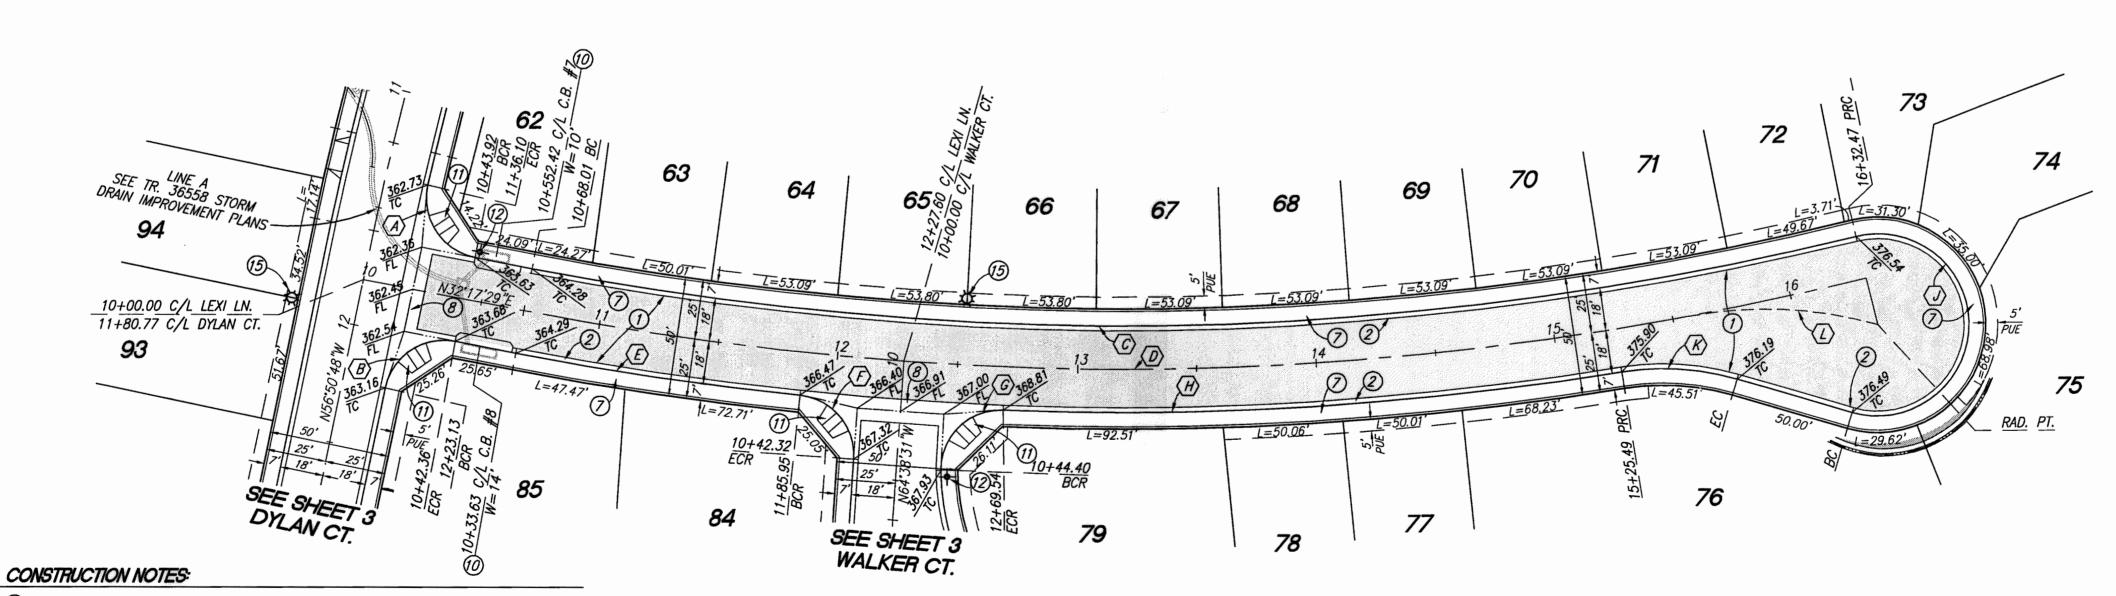

CURVE/LINE DATA NO.
A
B RADIUS BEARING/DELTA LENGTH TANGENT 9213'05" *25.00* ' 40.24 *25.99* **'** 24.63' 89°08'18" *25.00* ' *38.89* **'** 282.71° 1301.00 *556.76* **'** 24°31′11″ 1319.00' *286.62* ′ 24'31'11" *564.47*' *59.82* ′ *05°07′24*″ 1337.00' 119.55' 24.22' 8871**'**27" *25.00* ' *38.48*' *92'58'02"* 40.56 *26.33* ′ *25.00* ' 130.13**'** 11°07'06" 1337.00* *259.45* ' 209°57′56″ *38.00*′ 139.25' ____ 110.00 24.71° *2519'04"* 48.61' *40.57*' 175.80° *79.75* ' *25°59'32"*

THE PRIVATE ENGINEER SIGNING THESE PLANS IS RESPONSIBLE FOR ASSURING THE ACCURACY AND ACCEPTABILITY OF THE DESIGN HEREON. IN THE EVENT OF DISCREPANCIES ARISING AFTER CITY APPROVAL OR DURING CONSTRUCTION, THE PRIVATE ENGINEER SHALL BE RESPONSIBLE FOR DETERMINING AN ACCEPTABLE SOLUTION AND REVISING THE PLANS FOR APPROVAL BY THE CITY.


NOTE: WORK CONTAINED WITHIN THESE PLANS SHALL NOT COMMENCE UNTIL AN ENCROACHMENT PERMIT AND/OR A GRADING PERMIT HAS BEEN ISSUÉD.

UNDERGROUND SERVICE ALERT OF SOUTHERN CALIFORNIA | BEARING: N 27'39'52" E

(1) CONSTRUCT 0.25' A.C. OVER 0.50' A.B.

- (2) CONSTRUCT TYPE A-6 CURB PER COUNTY OF RIVERSIDE STANDARD NO. 200
- 7 CONSTRUCT SIDEWALK PER COUNTY OF RIVERSIDE STANDARD PLAN NO. 401 (DRIVEWAY S.F. REMOVED FROM QUANTITY)
- (10) CONSTRUCT GUTTER DEPRESSION, CASE C, PER RIVERSIDE COUNTY STANDARD NO. 311
- (1) CONSTRUCT CURB RAMP PER COUNTY OF RIVERSIDE STANDARD NO. 403, CASE A (12) INSTALL STREET NAME SIGN PER RIVERSIDE STD. NO. 816

LEXI LANE

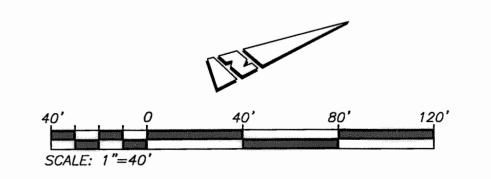


AT LEAST TWO DAYS BEFORE YOU DIG

BASIS OF BEARINGS: **DESCRIPTION:** THE BASIS OF COORDINATES FOR THIS MAP IS THE CALIFORNIA STATE PLANE COORDINATE SYSTEM, 1983, ZONE 6, BASED LOCALLY ON CONTROL STATIONS "REST" AND "RABBIT".

BENCHMARK: DESCRIPTION: USGS MONUMENT "REST" BENCHMARK DISK SET IN TOP OF CONCRETE MONUMENT STAMPED "REST 1972" ON DESERT LAWN DRIVE ACROSS THE DRIVE FROM DESERT LAWN CEMETERY 25.3 FT. N.E. OF THE DRIVE
CENTERLINE 24.9 FT. S.W. OF THE S.W.
EDGE OF THE SOUTH EASTBOUND LANES
OF INTERSTATE HIGHWAY 10 ELEV. 2491.44, NGVD 29

				1	CONSULTA	E ENGINEERING NTS WEST, INC. ON AVE. SUITE 200 92562
~	MARK	2500205701	- 4		u A	
٢	MARK	DESCRIPTION	APPR.	DATE		06/17/16
ENGI	NEER	REVISIONS	CI	ſΥ	GEORGE ALAN LENFESTEY R.C.E. 45920 EXP. 12-31-2016	DATE

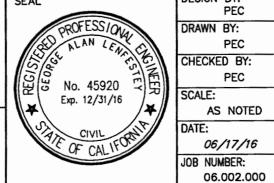

PEC CHECKED BY: PEC AS NOTED 06/17/16 JOB NUMBER: Engineering Division

Date: ___ Recommended for Approv Date: 6 | 14 | [6 City of Beaumont, Public Works Department

CITY OF BEAUMONT, CALIFORNIA STREET IMPROVEMENT PLANS TRACT NO. 36558

LEXI LANE STA: 10+00.00 TO STA: 16+32.47

ARGENT MANAGEMENT


SHEE


OF 8 SHEETS

DRAWING NAME:

FILE NO.: 2096

Plotted: Jun 17, 2016 - 2:36pm By: mikehanna DWG: Z:\01.104.000 FC-PA14\Drawings\Street Improvements\36558-SHT-02.dwg

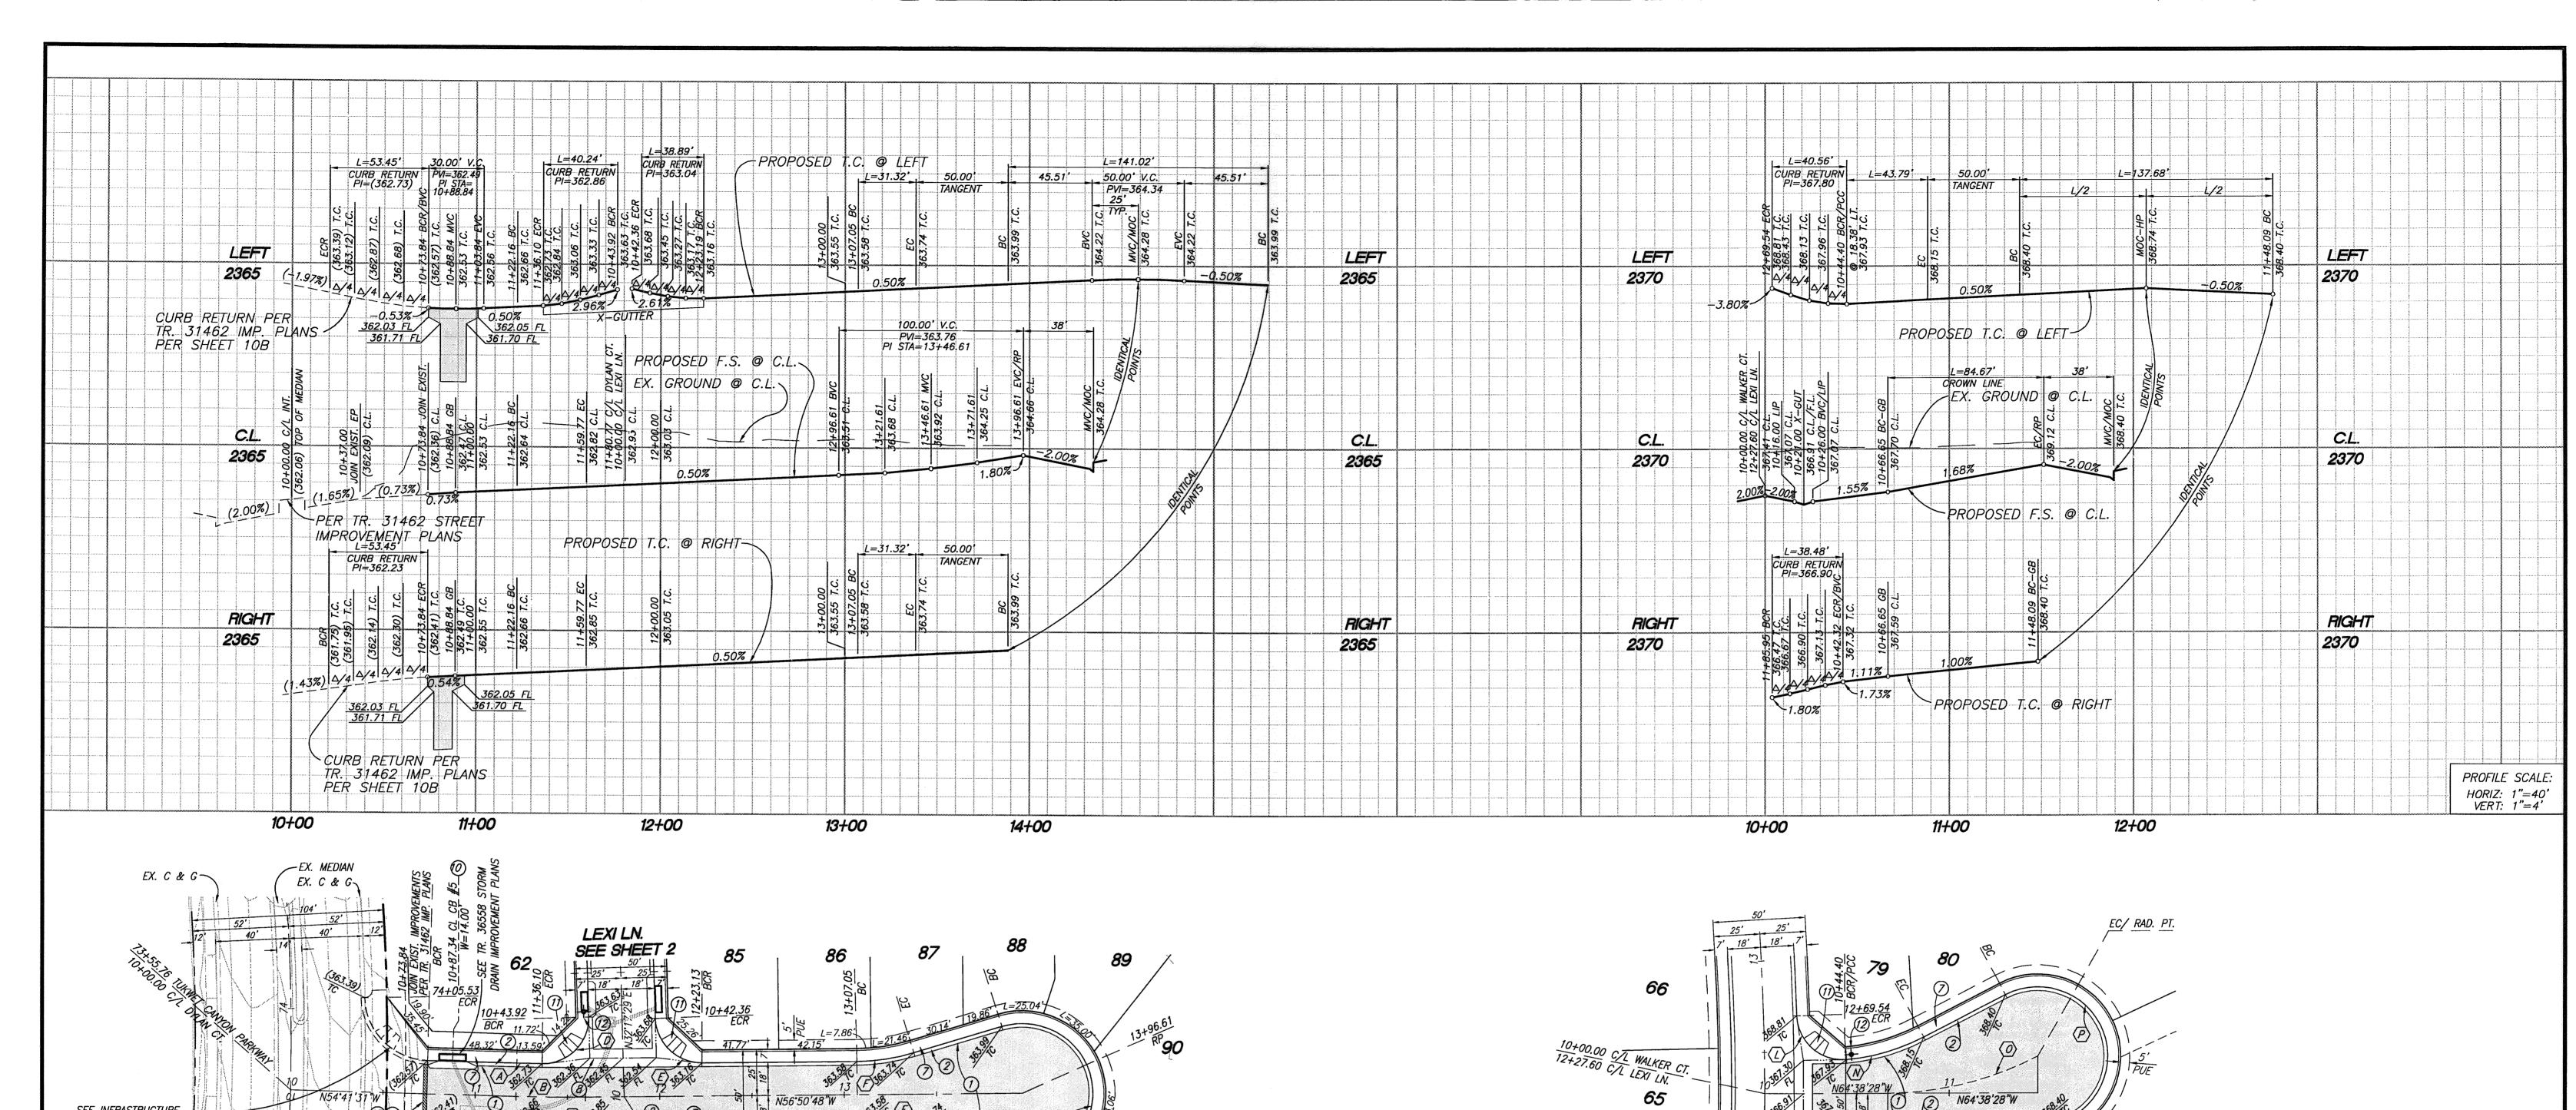

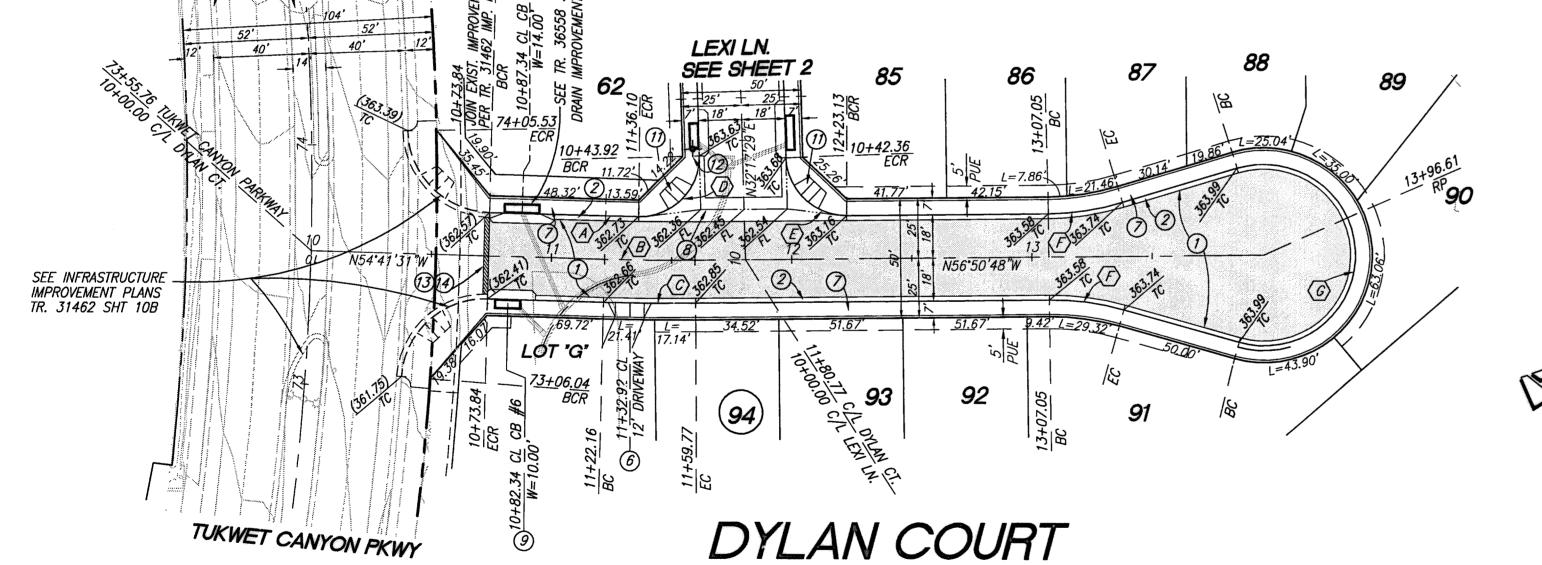

THE PRIVATE ENGINEER SIGNING THESE PLANS IS RESPONSIBLE FOR ASSURING THE ACCURACY AND ACCEPTABILITY OF THE DESIGN HEREON. IN THE EVENT OF DISCREPANCIES ARISING AFTER CITY APPROVAL OR DURING CONSTRUCTION, THE PRIVATE ENGINEER SHALL BE RESPONSIBLE FOR DETERMINING AN ACCEPTABLE SOLUTION AND REVISING THE PLANS FOR APPROVAL BY THE CITY.

NOTE: WORK CONTAINED WITHIN THESE PLANS SHALL NOT COMMENCE UNTIL AN ENCROACHMENT PERMIT AND/OR A GRADING PERMIT HAS

NO.	BEARING/DELTA	RADIUS	LENGTH	TANGENT
$\langle A \rangle$	00°47′54″	982.00'	13.68'	6.84'
$\langle B \rangle$	02'09'17"	1000.00'	37.61'	18.81'
(C)	02'09'17"	1018.00'	38.28'	19.14'
0	9273'05"	25.00'	40.24'	25.99'
$\langle E \rangle$	89 08'18"	25.00'	38.89'	24.63'
$\langle F \rangle$	1678'41"	110.00'	31.32'	<i>15.76</i> ′

CURVE/LINE DATA

1678'41" 110.00' 31.32' 212'37'22" *38.00*′ 141.02' CONSTRUCTION NOTES:

(1) CONSTRUCT 0.25' A.C. OVER 0.50' A.B.

REVISIONS

(2) CONSTRUCT TYPE A-6 CURB PER COUNTY OF RIVERSIDE STANDARD NO. 200

6 CONSTRUCT CONCRETE DRIVEWAY APPROACH PER RIVERSIDE COUNTY STANDARD NO. 207 (RESIDENTIAL LOT DRIVEWAY LOCATION PER PRECISE GRADING PLAN)

(7) CONSTRUCT SIDEWALK PER COUNTY OF RIVERSIDE STANDARD PLAN NO. 401

(DRIVEWAY S.F. REMOVED FROM QUANTITY)

(8) CONSTRUCT CROSS-GUTTER PER COUNTY OF RIVERSIDE STANDARD NO. 209


(9) CONSTRUCT GUTTER DEPRESSION, CASE B, PER RIVERSIDE COUNTY STANDARD NO. 311

10) CONSTRUCT GUTTER DEPRESSION, CASE C, PER RIVERSIDE COUNTY STANDARD NO. 311 11) CONSTRUCT CURB RAMP PER COUNTY OF RIVERSIDE STANDARD NO. 403, CASE A

(2) INSTALL STREET NAME SIGN PER RIVERSIDE STD. NO. 816


(3) SAWCUT AND REMOVE EX. PAVEMENT PER PLAN. SEE SAWCUT AND OVERLAY DETAIL SHEET 1

(14) COLD PLANE AND OVERLAY EX. PAVEMENT PER PLAN (1.00' MIN.) SEE SAWCUT AND OVERLAY DETAIL SHEET 1

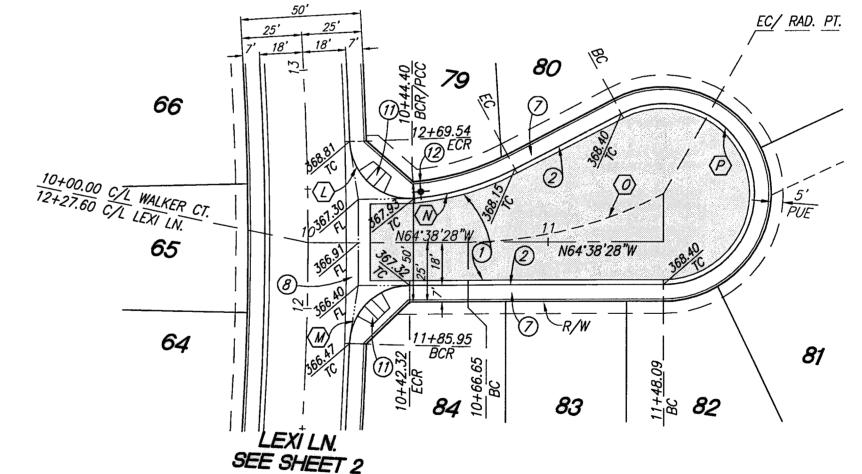

WALKER COURT

	C	CURVE/LINE DATA		
NO.	BEARING/DELTA	RADIUS	LENGTH	TANGENT
(\(\)	92'58'02"	<i>25.00</i> ′	40.56°	<i>26.33</i> '
M	8871'27"	<i>25.00</i> ′	<i>38.48</i> ′	24.22'
(N)	22°48′28″	110.00'	43.79'	22.19'
0	27'35'48"	175.79'	84.67'	43.17'
$\langle P \rangle$	207'35'48"	<i>38.00</i> ′	137.68'	

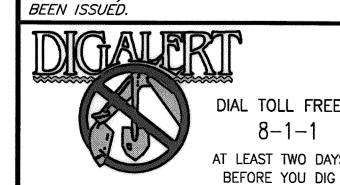

BASIS OF BEARINGS: DESCRIPTION: THE BASIS OF COORDINATES FOR THIS MAP IS THE CALIFORNIA STATE PLANE COORDINATE SYSTEM, 1983, ZONE 6, BASED LOCALLY ON CONTROL STATIONS "REST" AND "RABBIT".

UNDERGROUND SERVICE ALERT OF SOUTHERN CALIFORNIA | BEARING: N 27'39'52" E


ELEV. 2491.44, NGVD 29

BENCHMARK: ESCRIPTION: USGS MONUMENT "REST" ENCHMARK DISK SET IN TOP OF ONCRETE MONUMENT STAMPED "REST 072" ON DESERT LAWN DRIVE ACROSS HE DRIVE FROM DESERT LAWN					
EMETERY 25.3 FT. N.E. OF THE DRIVE					
ENTERLINE 24.9 FT. S.W. OF THE S.W. DGE OF THE SOUTH EASTBOUND LANES					
F INTERSTATE HIGHWAY 10	BY	MARK	DESCRIPTION	APPR.	DATE

ENGINEER

PROACTIVE ENGINEERING WEST	PROACTIVE ENGINEERING CONSULTANTS WEST, INC. 25109 JEFFERSON AVE. SUITE 200 MURRIETA, CA 92562 951-200-6840
	1

GEORGE ALAN LENFESTEY R.C.E. 45920 EXP. 12-31-2016

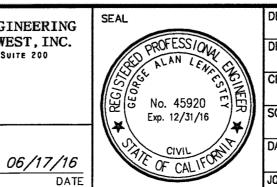

GN BY: PEC	Mh	Date: 4/4/10	
WN BY: PEC	Reviewed By: Staff Engineer	Date: 4/ -4/1	
CKED BY: PEC	Recommended for Approval By:	Date:	
E: AS NOTED	Approved By:	Date Le 21/11	
: 06/17/16	City Engineer City of Beaumont, Public Works Department		


Engineering Division


CITY OF BEAUMONT, CALIFORNIA SHEE STREET IMPROVEMENT PLANS TRACT NO. 36558 **DYLAN COURT** STA: 10+73.84 TO STA: 13+96.61 OF_**8**_ SHEET:

WALKER COURT STA: 10+00.00 TO STA: 11+48.09 ARGENT MANAGEMENT

DRAWING NAME:

2096

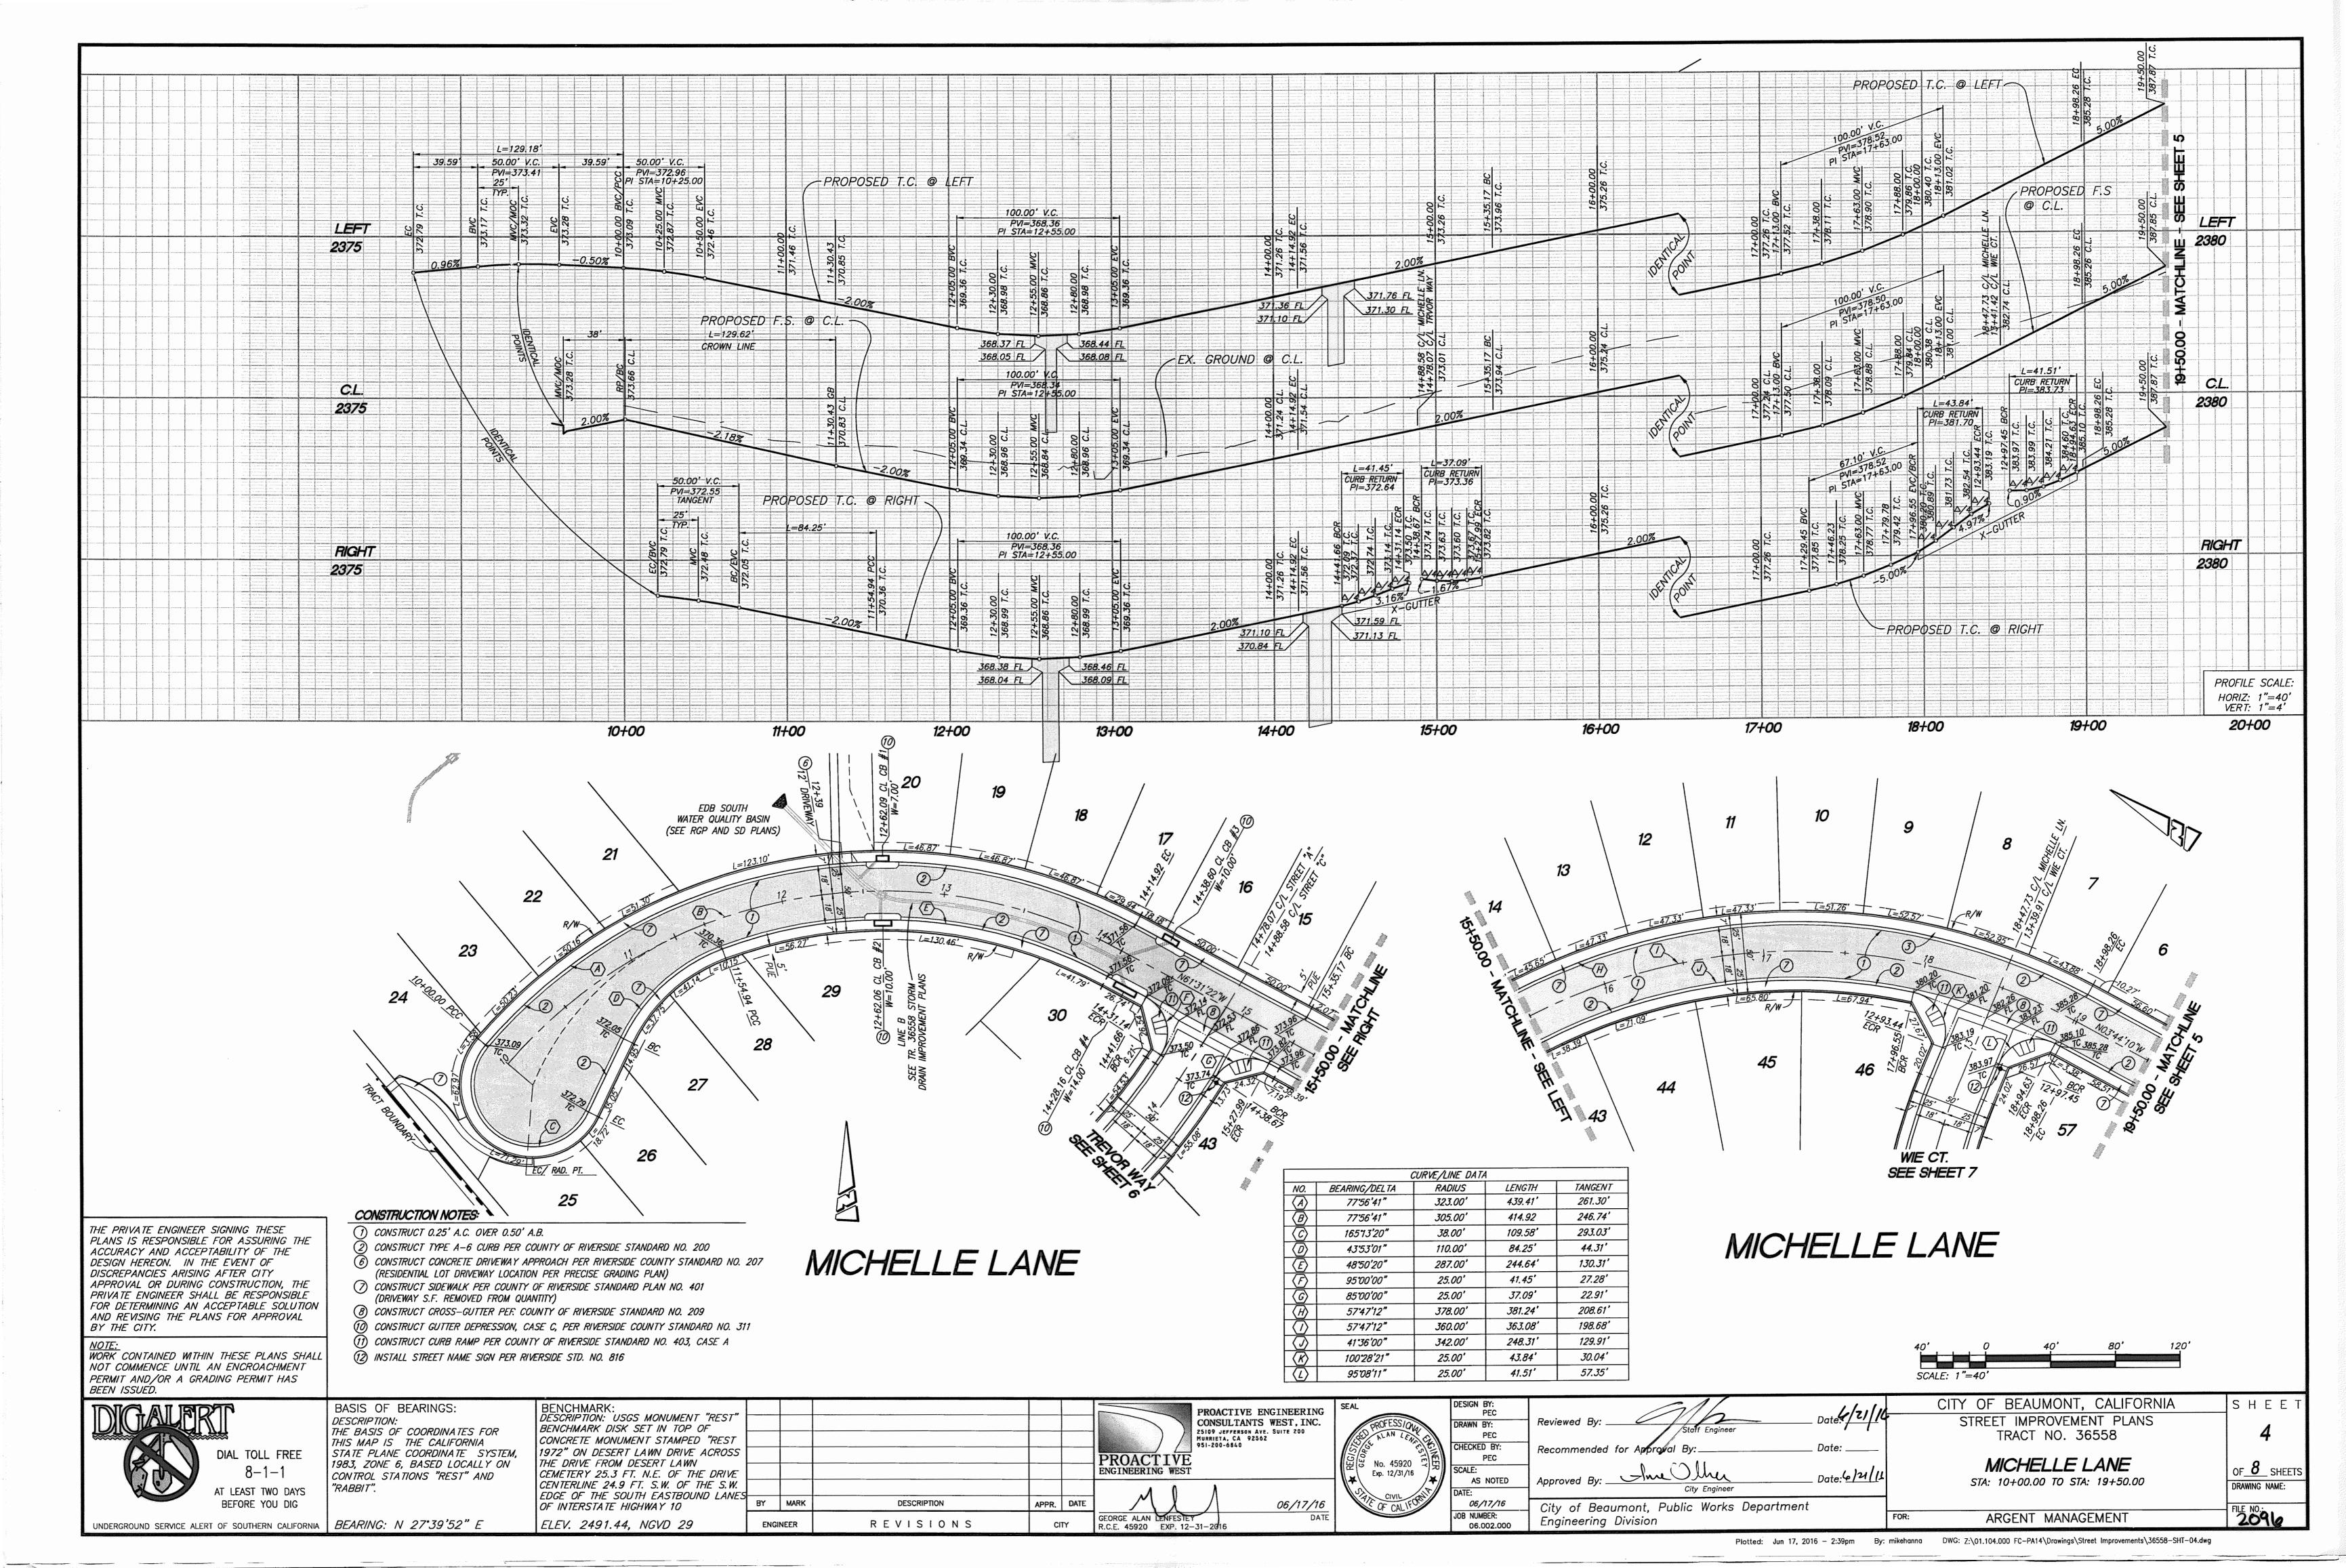

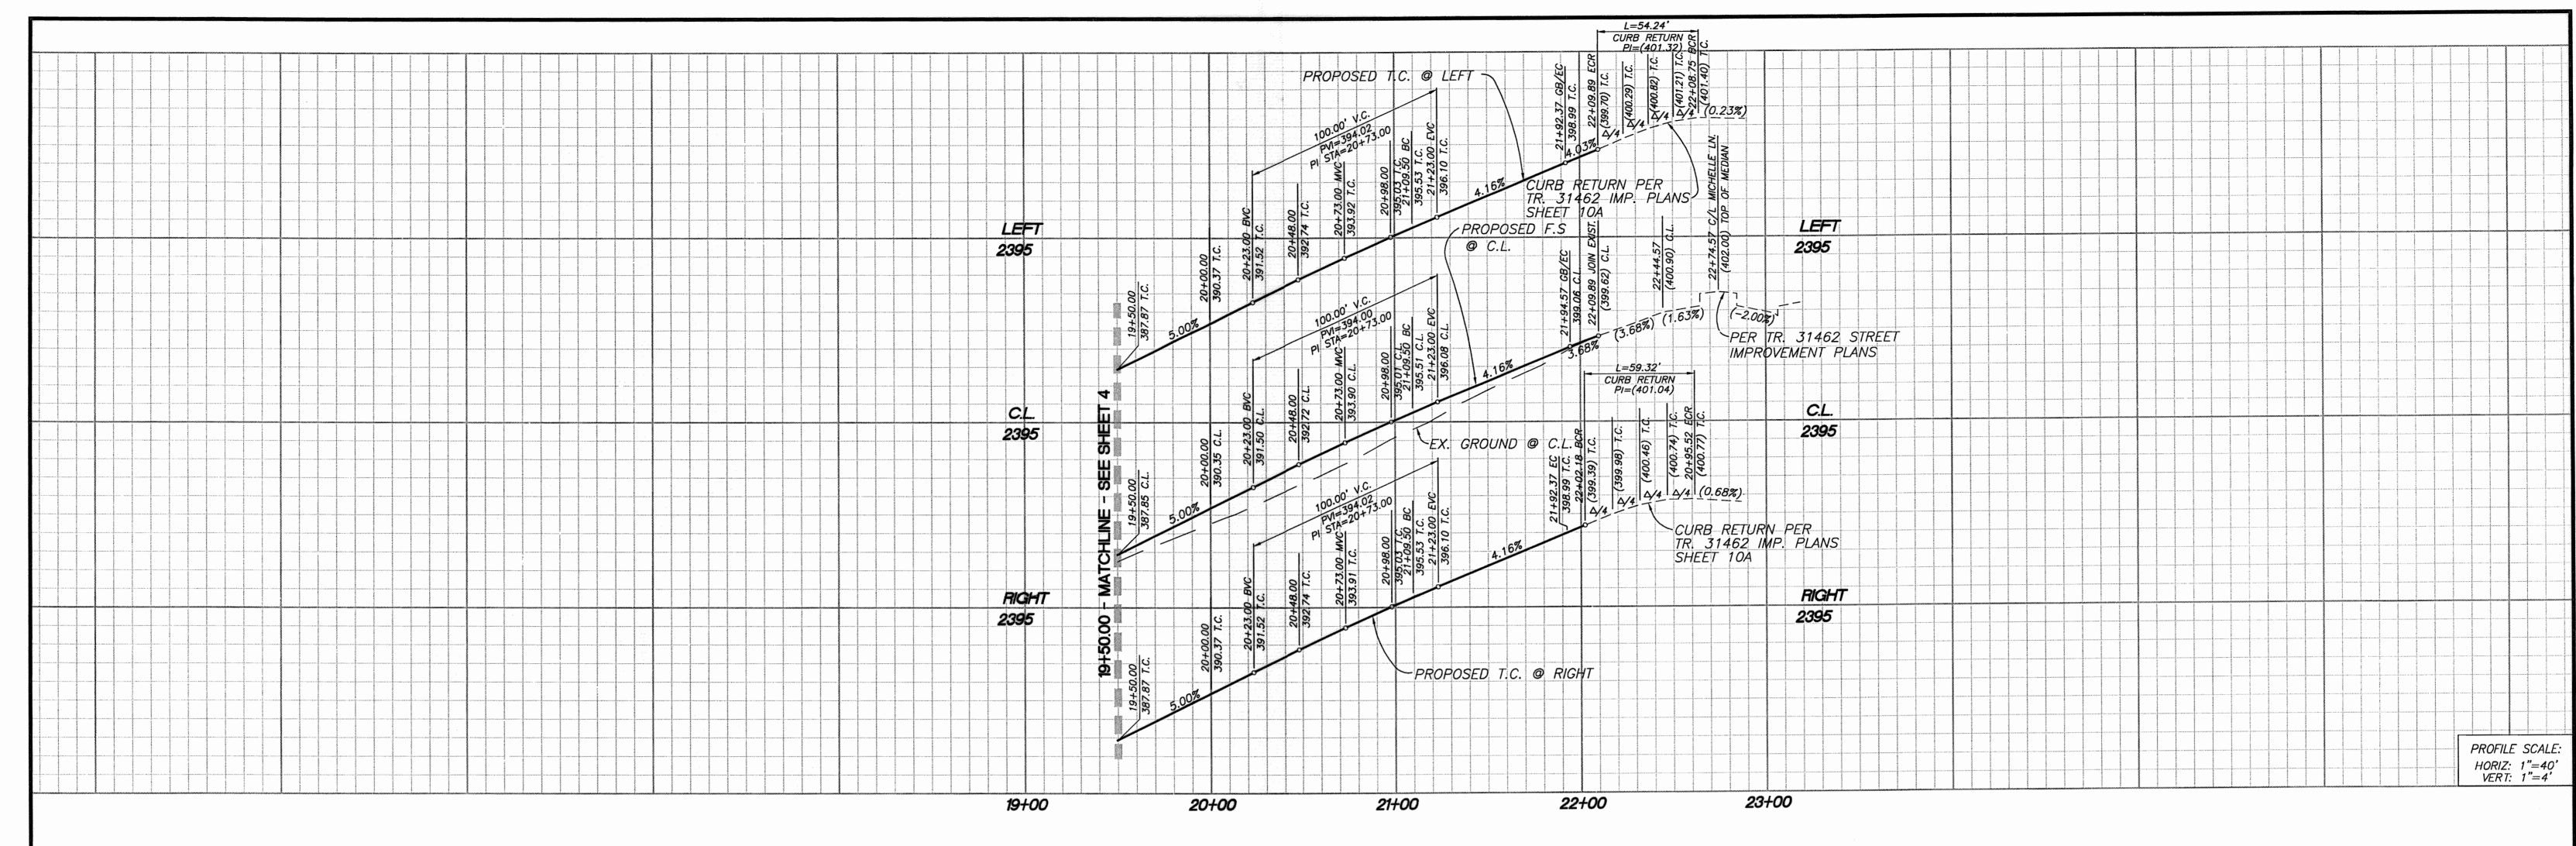

SEE INFRASTRUCTURE IMPROVEMENT PLANS TR./31462/SHT 10A 59


CONSTRUCTION NOTES:


- (1) CONSTRUCT 0.25' A.C. OVER 0.50' A.B.
- (2) CONSTRUCT TYPE A-6 CURB PER COUNTY OF RIVERSIDE STANDARD NO. 200
- (7) CONSTRUCT SIDEWALK PER COUNTY OF RIVERSIDE STANDARD PLAN NO. 401
- (DRIVEWAY S.F. REMOVED FROM QUANTITY)
- (3) SAWCUT AND REMOVE EX. PAVEMENT PER PLAN. SEE SAWCUT AND OVERLAY DETAIL SHEET 1
- (4) COLD PLANE AND OVERLAY EX. PAVEMENT PER PLAN (0.10' MIN.) SEE SAWCUT AND OVERLAY DETAIL SHEET 1

MICHELLE LANE

		CURVE/LINE DATA		
NO.	BEARING/DELTA	RADIUS	<i>LENGTH</i>	TANGENT
$\langle A \rangle$	14'36'30"	343.00'	87.45'	43.96
$\langle B \rangle$	14'36'30"	325.00°	82.86	41.66'
(0)	14'36'30"	307.00'	78.27'	39.35'

Engineering Division

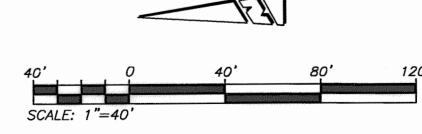

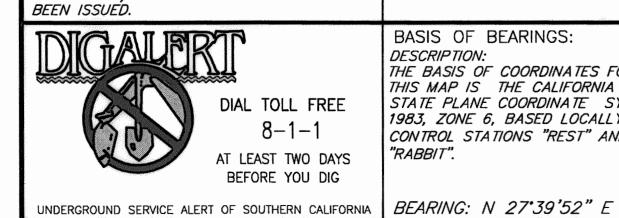

THE PRIVATE ENGINEER SIGNING THESE

ACCURACY AND ACCEPTABILITY OF THE

DESIGN HEREON. IN THE EVENT OF DISCREPANCIES ARISING AFTER CITY

BY THE CITY.

PLANS IS RESPONSIBLE FOR ASSURING THE

APPROVAL OR DURING CONSTRUCTION, THE PRIVATE ENGINEER SHALL BE RESPONSIBLE FOR DETERMINING AN ACCEPTABLE SOLUTION AND REVISING THE PLANS FOR APPROVAL

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> 1983, ZONE 6, BASED LOCALLY ON CONTROL STATIONS "REST" AND "RABBIT".


BENCHMARK: DESCRIPTION: USGS MONUMENT "REST" BENCHMARK DISK SET CONCRETE MONUMENT 1972" ON DESERT LAW THE DRIVE FROM DESE CEMETERY 25.3 FT. N. CENTERLINE 24.9 FT. EDGE OF THE SOUTH DOF INTERSTATE HIGHWA ELEV. 2491.44, NO

T IN TOP OF STAMPED "REST			 _
WN DRIVE ACROSS			 -
ERT LAWN I.E. OF THE DRIVE			 _
S.W. OF THE S.W. EASTBOUND LANES			
VAY 10	BY	MARK	
GVD 29	ENGI	NEER	

DESCRIPTION

REVISIONS

	CONSULTAN 25109 JEFFERSON MURRIETA, CA 9 951-200-6840 PROACTIVE ENGINEERING WEST	
DATE	MII	06 47 46
DATE		06/17/16
TY	GEORGE ALAN LENFESTEY / R.C.E. 45920 EXP. 12-31-2016	DATE

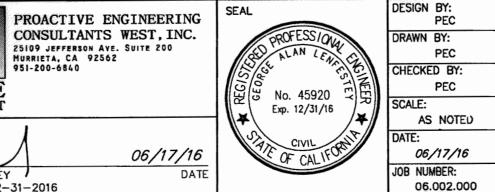

DESIGN BY: PEC	11/2	Date 4/21/16	
DRAWN BY: PEC	Reviewed By: Staff Engineer	die 7 - 1/1	
CHECKED BY: PEC	Recommended for Approval By:D	Date:	
SCALE: AS NOTED	Approved By:	Date: <u>6/21/1</u> 4	
DATE:	City Engineer		
06/17/16	City of Beaumont, Public Works Department		
IOR NIMBER.	1 = 2	1	

,,	CITY OF BEAUMONT
16	O111221 1111 110 1211
_	TRACT NO. 3
110	MICHELLE


MICHELLE LANE	o
TREET IMPROVEMENT PLANS TRACT NO. 36558	5
OF BEAUMONT, CALIFORNIA S	НЕ

STA: 19+50.00 TO STA: 22+09.89

ARGENT MANAGEMENT

OF O SHEETS DRAWING NAME: FILE NO.: 96

Plotted: Jun 17, 2016 - 2:40pm By: mikehanna DWG: Z:\01.104.000 FC-PA14\Drawings\Street Improvements\36558-SHT-05.dwg

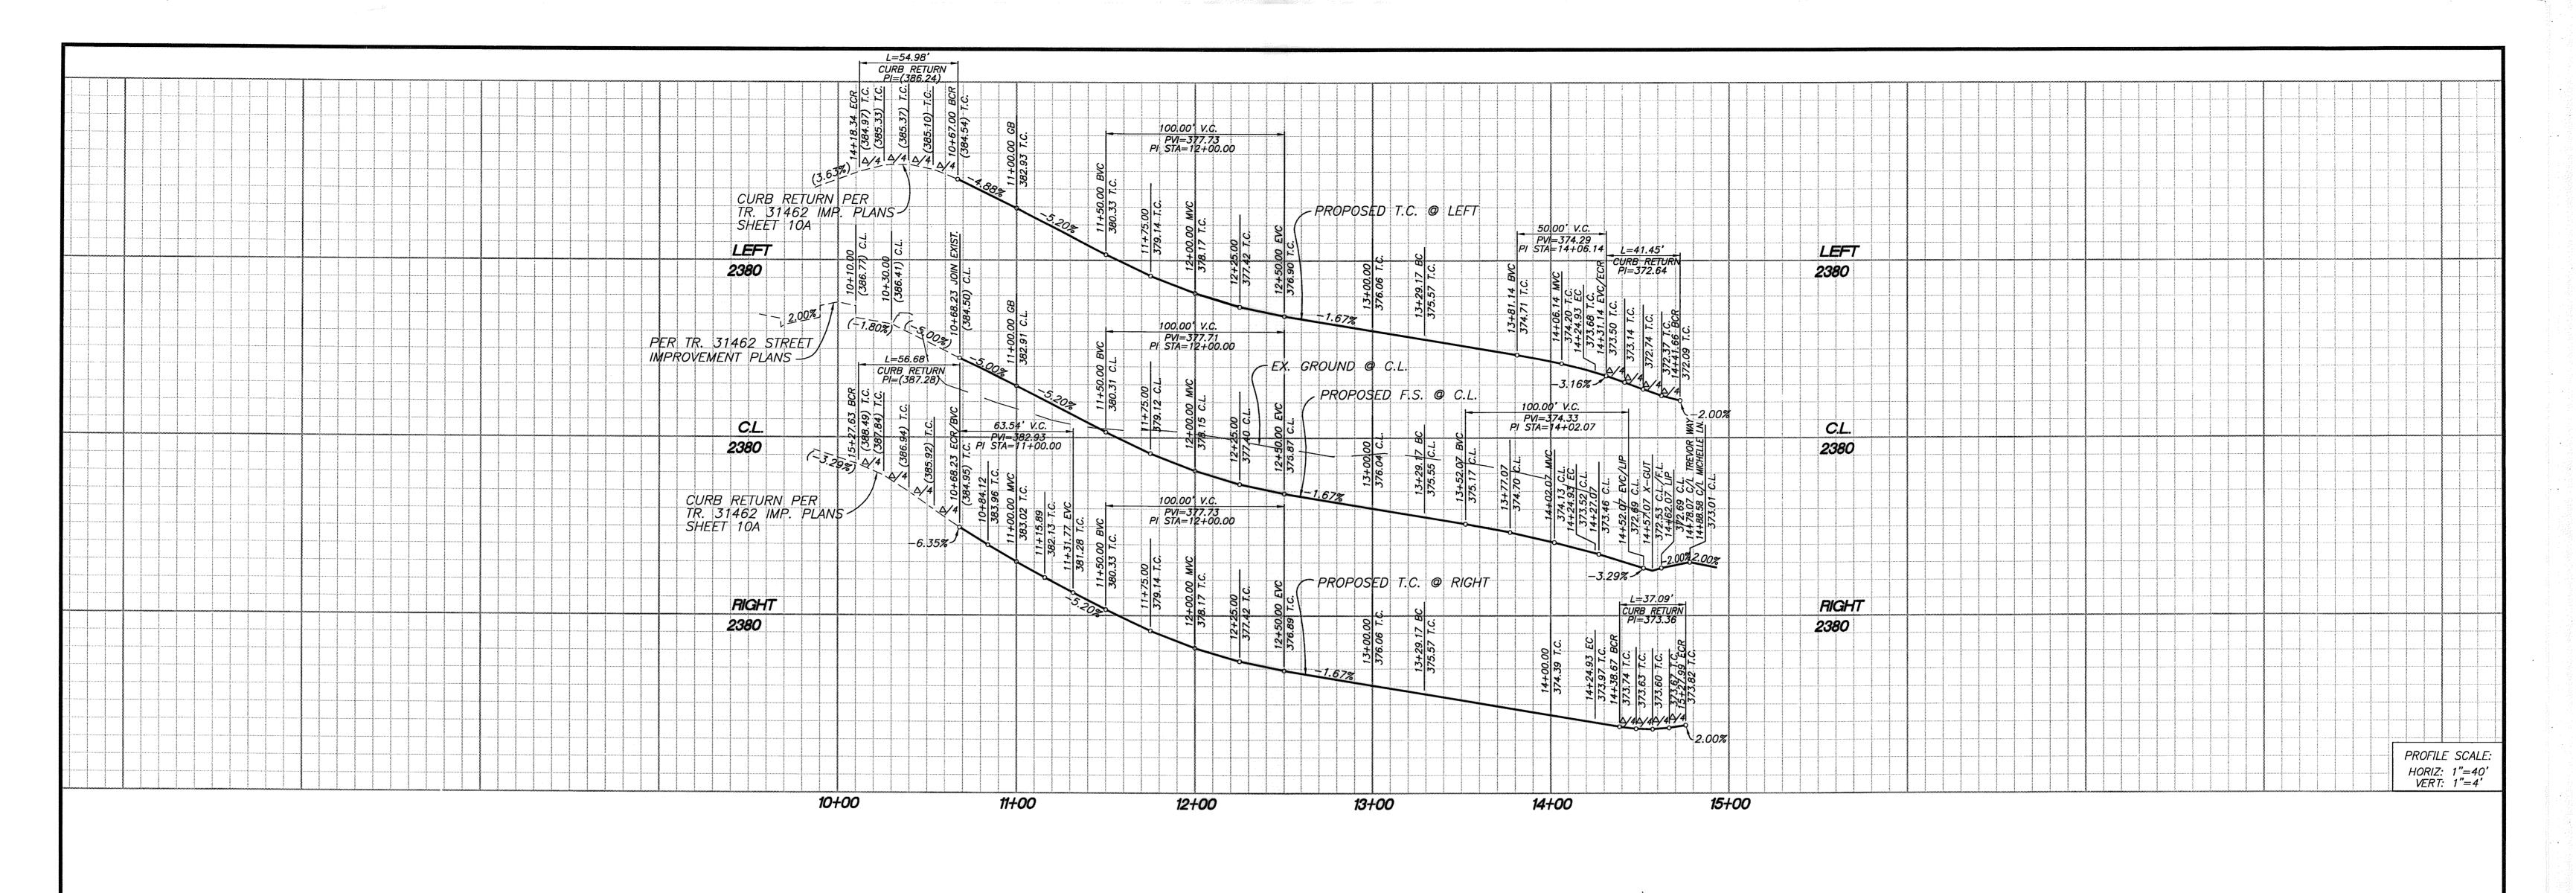


CONSTRUCTION NOTES:

- (1) CONSTRUCT 0.25' A.C. OVER 0.50' A.B.
- (2) CONSTRUCT TYPE A-6 CURB PER COUNTY OF RIVERSIDE STANDARD NO. 200
- (7) CONSTRUCT SIDEWALK PER COUNTY OF RIVERSIDE STANDARD PLAN NO. 401 (DRIVEWAY S.F. REMOVED FROM QUANTITY)
- (8) CONSTRUCT CROSS-GUTTER PER COUNTY OF RIVERSIDE STANDARD NO. 209
- (1) CONSTRUCT CURB RAMP PER COUNTY OF RIVERSIDE STANDARD NO. 403, CASE A

UNDERGROUND SERVICE ALERT OF SOUTHERN CALIFORNIA | BEARING: N 27'39'52" E

- (12) INSTALL STREET NAME SIGN PER RIVERSIDE STD. NO. 816
- (13) SAWCUT AND REMOVE EX. PAVEMENT PER PLAN. SEE SAWCUT AND OVERLAY DETAIL SHEET 1
- (4) COLD PLANE AND OVERLAY EX. PAVEMENT PER PLAN (0.10' MIN.) SEE SAWCUT AND OVERLAY DETAIL SHEET 1

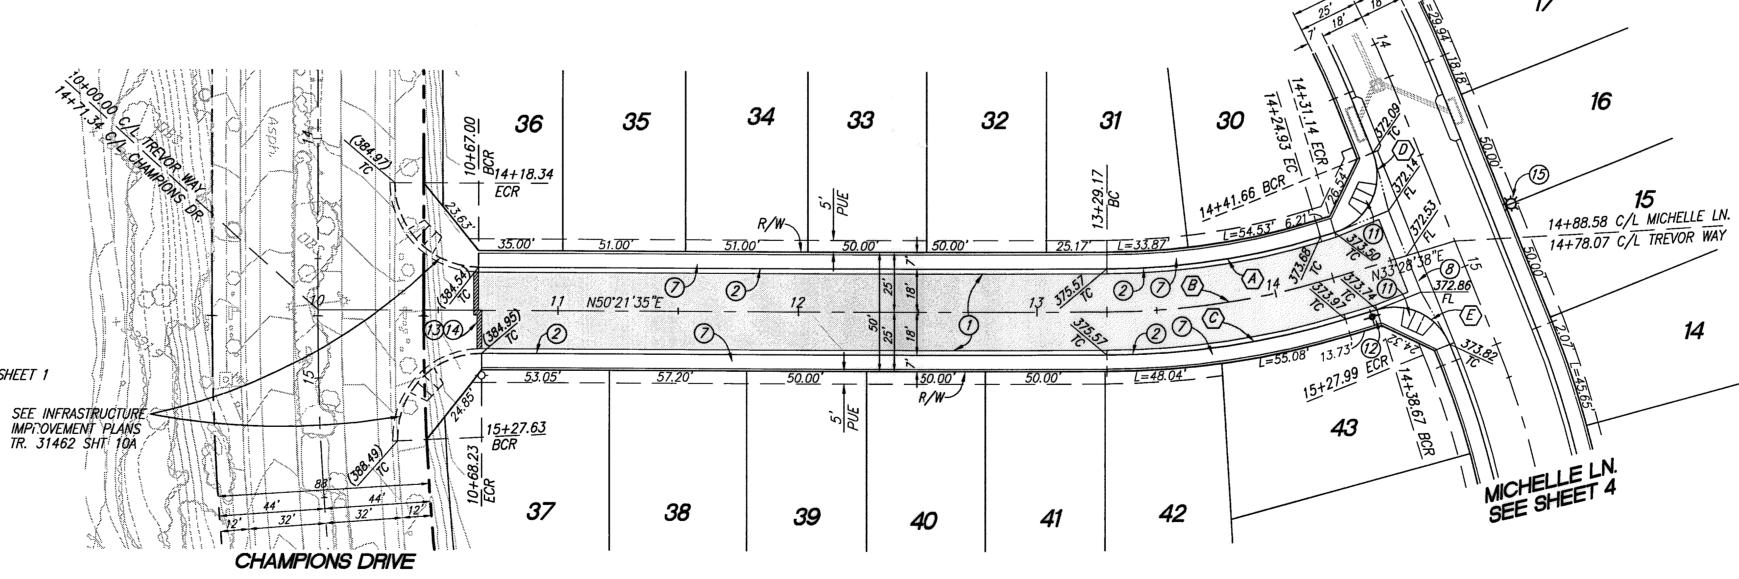


	C	CURVE/LINE DATA	1	
NO.	BEARING, DELTA	RADIUS	<i>LENGTH</i>	TANGENT
$\langle A \rangle$	16°52′57″	307.00'	90.46	<i>45.56</i> ′
$\langle B \rangle$	16°52'57"	<i>325.00</i> ′	95.76°	48.23'
(C)	16°52′57"	343.00'	101.07'	<i>50.90</i> ′
D	95′00′00″	25.00°	41.45'	27.28'
$\langle E \rangle$	85°00'00"	<i>25.00</i> ′	37.09'	22.91'

THE PRIVATE ENGINEER SIGNING THESE PLANS IS RESPONSIBLE FOR ASSURING THE ACCURACY AND ACCEPTABILITY OF THE DESIGN HEREON. IN THE EVENT OF DISCREPANCIES ARISING AFTER CITY APPROVAL OR DURING CONSTRUCTION, THE PRIVATE ENGINEER SHALL BE RESPONSIBLE FOR DETERMINING AN ACCEPTABLE SOLUTION AND REVISING THE PLANS FOR APPROVAL BY THE CITY.

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TREVOR WAY

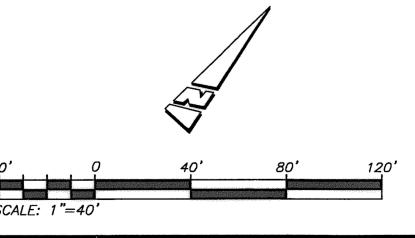


BEFORE YOU DIG

BASIS OF BEARINGS: DESCRIPTION: THE BASIS OF COORDINATES FOR THIS MAP IS THE CALIFORNIA STATE PLANE COORDINATE SYSTEM, 1983, ZONE 6, BASED LOCALLY ON CONTROL STATIONS "REST" AND "RABBIT".

BENCHMARK: DESCRIPTION: USGS MONUMENT "REST" BENCHMARK DISK SET IN TOP OF CONCRETE MONUMENT STAMPED "REST 1972" ON DESERT LAWN DRIVE ACROSS THE DRIVE FROM DESERT LAWN CEMETERY 25.3 FT. N.E. OF THE DRIVE CENTERLINE 24.9 FT. S.W. OF THE S.W. EDGE OF THE SOUTH EASTBOUND LANES OF INTERSTATE HIGHWAY 10

PROACTIVE ENGINEERING CONSULTANTS WEST, INC. 25109 JEFFERSON AVE. SUITE 200 MURRIETA, CA 92562 951-200-6840 PROACTIVE ENGINEERING WEST BY MARK DESCRIPTION APPR. DATE 06/17/16 GEORGE ALAN LENFESTEY R.C.E. 45920 EXP. 12-31-2016 ELEV. 2491.44, NGVD 29 REVISIONS

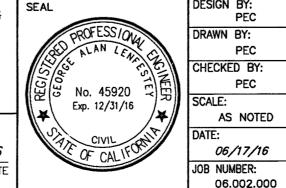

Recommended for Approval Date 4/21/16 City of Beaumont, Public Works Department

Engineering Division


CITY OF BEAUMONT, CALIFORNIA STREET IMPROVEMENT PLANS TRACT NO. 36558

ARGENT MANAGEMENT

TREVOR WAY STA: 10+00.00 TO STA: 14+78.07


OF **8** SHEETS DRAWING NAME: 2096

SHEE

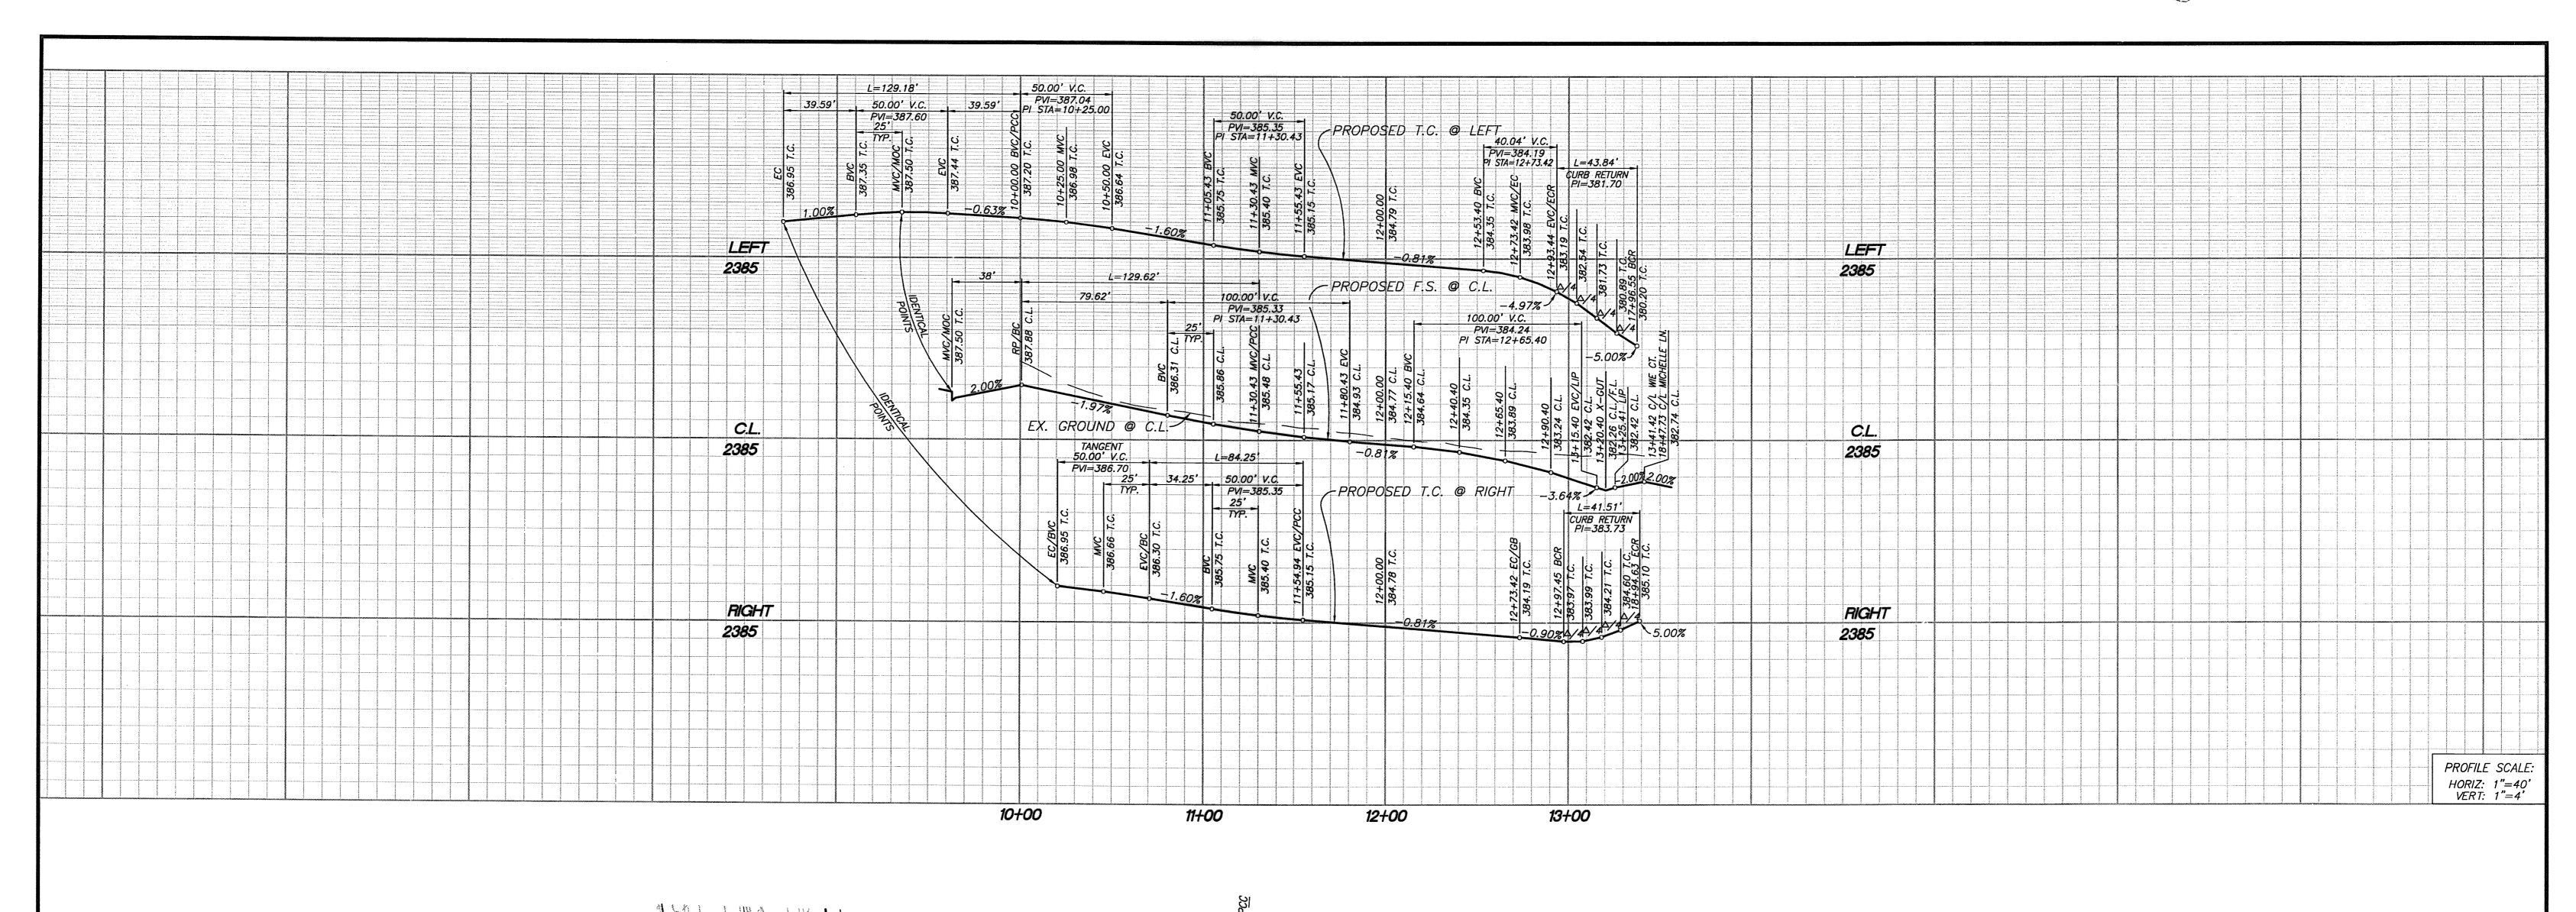

CONSTRUCTION NOTES:

- (1) CONSTRUCT 0.25' A.C. OVER 0.50' A.B.
- 2 CONSTRUCT TYPE A-6 CURB PER COUNTY OF RIVERSIDE STANDARD NO. 200 ONSTRUCT SIDEWALK PER COUNTY OF RIVERSIDE STANDARD PLAN NO. 401 (DRIVEWAY S.F. REMOVED FROM QUANTITY)
- B) CONSTRUCT CROSS-GUTTER PER COUNTY OF RIVERSIDE STANDARD NO. 209
- (11) CONSTRUCT CURB RAMP PER COUNTY OF RIVERSIDE STANDARD NO. 403, CASE A
- 12) INSTALL STREET NAME SIGN PER RIVERSIDE STD. NO. 816
- 17) INSTALL W53 "NOT A THROUGH STREET" SIGN PER CALTRANS TRAFFIC MANUAL

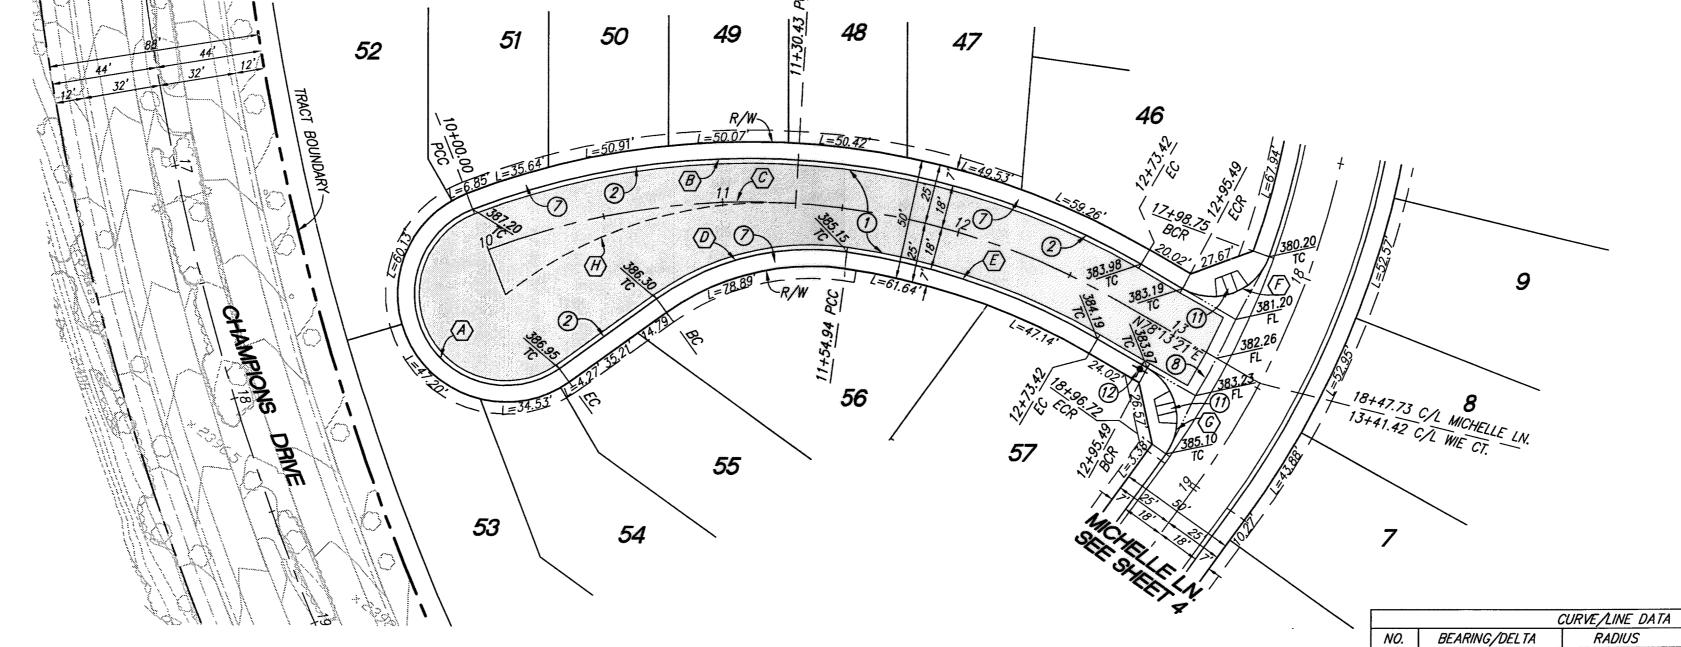

THE PRIVATE ENGINEER SIGNING THESE PLANS IS RESPONSIBLE FOR ASSURING THE ACCURACY AND ACCEPTABILITY OF THE DESIGN HEREON. IN THE EVENT OF DISCREPANCIES ARISING AFTER CITY APPROVAL OR DURING CONSTRUCTION, THE PRIVATE ENGINEER SHALL BE RESPONSIBLE FOR DETERMINING AN ACCEPTABLE SOLUTION AND REVISING THE PLANS FOR APPROVAL BY THE CITY.

PERMIT AND/OR A GRADING PERMIT HAS

NOTE: WORK CONTAINED WITHIN THESE PLANS SHALL NOT COMMENCE UNTIL AN ENCROACHMENT

BEEN ISSUÉD.

AT LEAST TWO DAYS BEFORE YOU DIG

UNDERGROUND SERVICE ALERT OF SOUTHERN CALIFORNIA | BEARING: N 27°39'52" E

BASIS OF BEARINGS: DESCRIPTION: THE BASIS OF COORDINATES FOR
THIS MAP IS THE CALIFORNIA
STATE PLANE COORDINATE SYSTEM,
1983, ZONE 6, BASED LOCALLY ON CONTROL STATIONS "REST" AND "RABBIT".

BENCHMAR CONCRETE 1972" ON THE DRIVE CEMETERY CENTERLIN EDGE OF OF INTERS

BENCHMARK:	ı	1
DESCRIPTION: USGS MONUMENT "REST"		
BENCHMARK DISK SET IN TOP OF		<u> </u>
CONCRETE MONUMENT STAMPED "REST		
1972" ON DESERT LAWN DRIVE ACROSS		
THE DRIVE FROM DESERT LAWN		ļ
CEMETERY 25.3 FT. N.E. OF THE DRIVE		
CENTERLINE 24.9 FT. S.W. OF THE S.W.		
EDGE OF THE SOUTH EASTBOUND LANES		
OF INTERSTATE HIGHWAY 10	BY	MARK
ELEV. 2491.44, NGVD 29	ENGI	NEER

DESCRIPTION

REVISIONS

PROACTIVE ENGINEERING WEST	PROACTIVE ENGINEERING CONSULTANTS WEST, INC. 25109 JEFFERSON AVE. SUITE 200 MURRIETA, CA 92562 951-200-6840	

GEORGE ALAN LENFESTEY
R.C.E. 45920 EXP. 12-31-2010

06/17/16

WIE COURT

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	PROFESS/ON		DRAWN B
	AN AN		P
RECISTE GEORGE	PROFESSION PROFESSION	3	CHECKED
SEG	No. 45920	司用	Р
	Exp. 12/31/16		SCALE:
 #/		/ * //	AS N
	CIVIL		DATE:
	E OF CALIFO		06/1
			JOB NUMBI
			ไกรกา

	DESIGN BY: PEC	In/h_
	DRAWN BY: PEC	Reviewed By: Staff Engineer
CHECKED BY: PEC SCALE: AS NOTED DATE:	1	Recommended for Approval By:
	1	Approved By: Ine Sher
	DATE:	City Engineer
	06/17/16 JOB NUMBER:	City of Beaumont, Public Works Department

Engineering Division

194**86'68*"

51°21'50"

51°21'50"

43*53'01"

2275'29"

100'28'21"

95°08'11"

4274'52"

Reviewed By: _	Mh	Date.4/21/14
-	for Approval By:	Date:
Approved By: _		

38.00°

323.00′

305.00′

110.00'

287.00′

25.00′

25.00 '

175.80°

CITY OF BEAUMONT, CALIFORNIA STREET IMPROVEMENT PLANS TRACT NO. 36558

WIE COURT STA: 10+00.00 TO STA: 13+41.42

ARGENT MANAGEMENT

OF_8 SHEETS DRAWING NAME: FILE NO.: 2096

SHEE

TANGENT

155.32'

146.67°

44.31

56.46 [′]

30.04 **'**

67.92'

LENGTH

129.18

289.56


273.42'

84.25'

111.49'

43.84°

129.62'

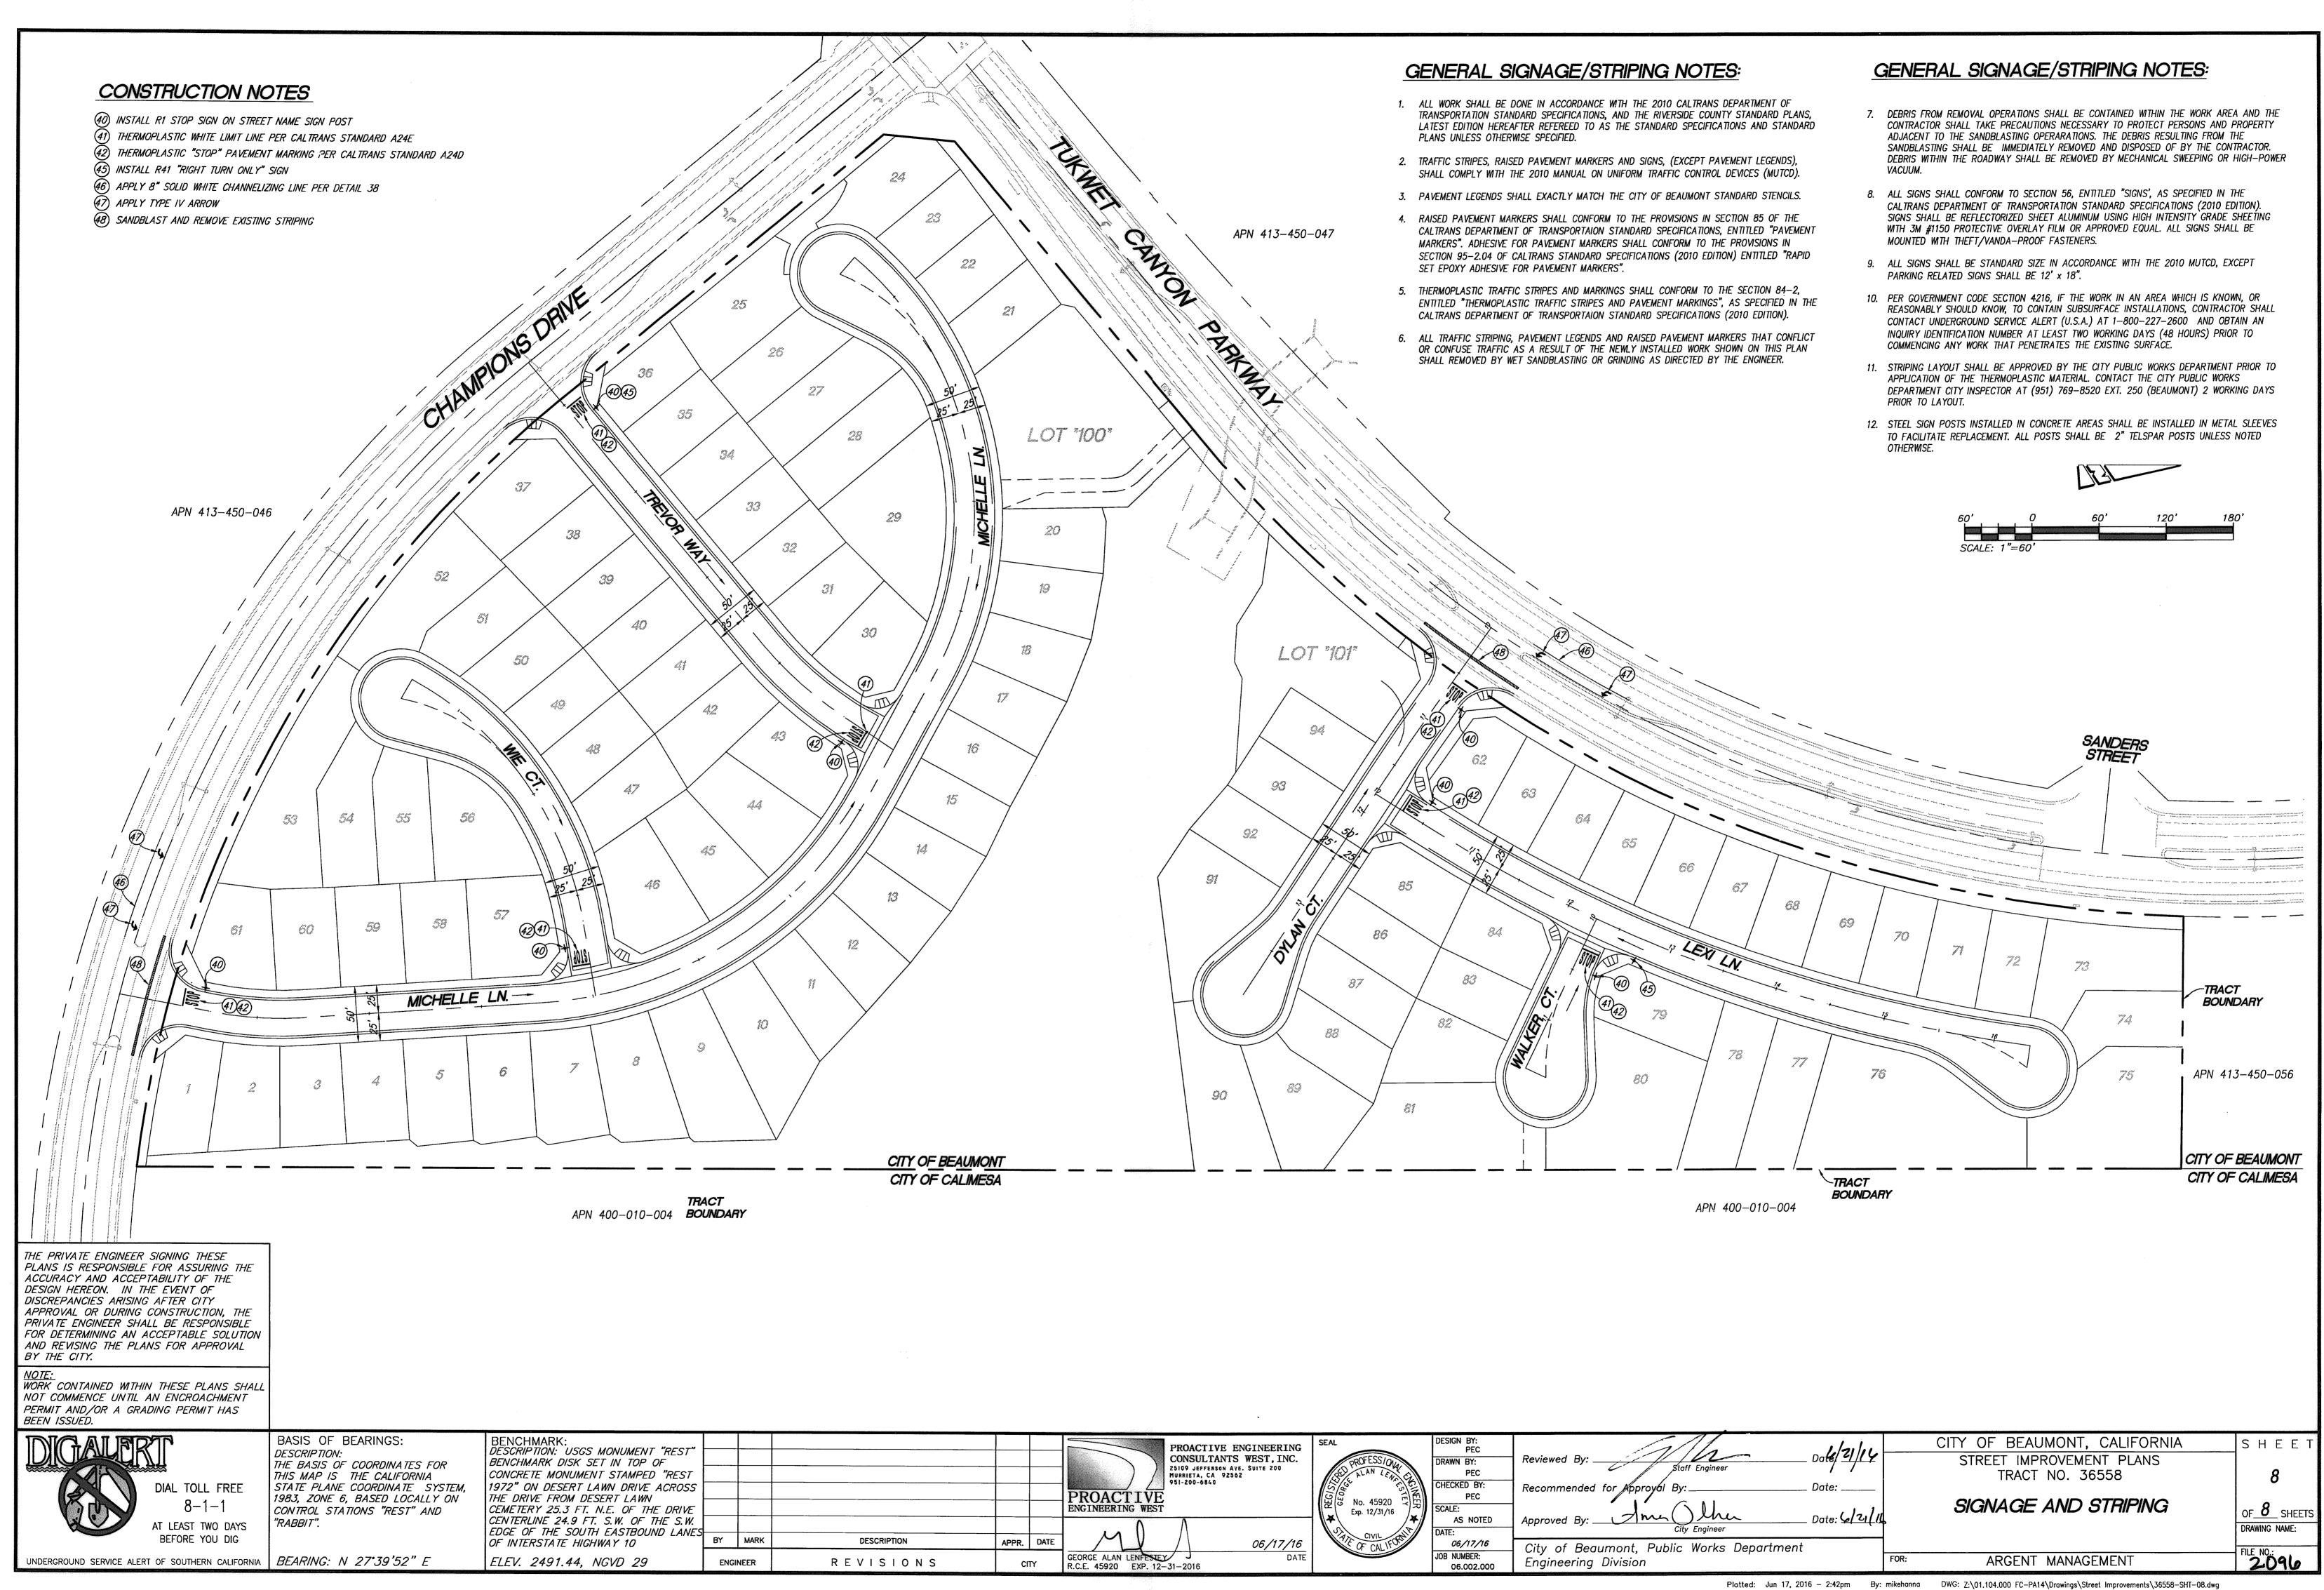


GENERAL NOTES

- 1. THE CONTRACTOR SHALL CONSTRUCT THE DRAINAGE IMPROVEMENT SHOWN ON THE DRAWINGS IN CONFORMANCE WITH THE REQUIREMENTS OF THE RIVERSIDE COUNTY FLOOD CONTROL AND WATER CONSERVATION DISTRICT DESIGN MANUAL STANDARD DRAWINGS, RECENT EDITION, AND IN CONFORMANCE WITH THE REQUIREMENTS OF THE BEAUMONT DRAINAGE MANAGEMENT PLAN.
- 2. THE CONTRACTOR IS REQUIRED TO CONTACT ALL UTILITY AGENCIES REGARDING TEMPORARY SUPPORT AND SHORING REQUIREMENTS FOR THE VARIOUS UTILITIES SHOWN IN THE PLANS.
- 3. CONSTRUCTION INSPECTION WILL BE PERFORMED BY CITY OF BEAUMONT. CONTACT (951) 769-8520. THE CITY MUST BE NOTIFIED ONE WEEK PRIOR TO CONSTRUCTION.
- 4. ALL STATIONING REFERS TO THE CENTERLINE OF CONSTRUCTION UNLESS OTHERWISE NOTED.
- 5. STATIONING FOR LATERALS AND CONNECTOR PIPE REFER TO THE CENTERLINE—CENTERLINE—INTERSECTION
- 6. FORTY-EIGHT HOURS BEFORE EXCAVATION, CALL UNDERGROUND SERVICE ALERT 1-800-227-2600.
- 7. ALL CROSS SECTIONS ARE TAKEN LOOKING UPSTREAM.
- 8. ELEVATIONS AND LOCATIONS OF UTILITIES SHOWN ARE APPROXIMATE UNLESS OTHERWISE NOTED. ALL UTILITIES SHOWN ARE TO BE PROTECTED IN PLACE UNLESS OTHERWISE NOTED.
- 9. OPENINGS RESULTING FROM THE CUTTING OR PARTIAL REMOVAL OF EXISTING CULVERTS, PIPES OR SIMILAR STRUCTURES TO BE ABANDONED SHALL BE SEALED WITH 6 INCHES OF CLASS "B" CONCRETE.
- 10. PIPE CONNECTED TO THE MAINLINE PIPE SHALL CONFORM TO JUNCTION STRUCTURE NO. 4 (JS 229) UNLESS OTHERWISE NOTED.
- 11. PIPE BEDDING SHALL CONFORM TO R.C.F.C. & W.C.D. STD. DWG. M 815
- 12. "V" IS THE DEPTH OF INLET AT THE CATCH BASINS MEASURED FROM THE TOP OF THE CURB TO THE INVERT OF CONNECTOR PIPE.
- 13. ALL CURBS, GUTTERS, SIDEWALKS, DRIVEWAYS, AND OTHER EXISTING IMPROVEMENTS TO BE RECONSTRUCTED IN KIND PER LATEST COUNTY STANDARD AND AT THE SAME ELEVATION AND LOCATION AS THE EXISTING IMPROVEMENTS UNLESS OTHERWISE NOTED. FOR PAVEMENT OVERLAY, 0.10' MIN. FOR FULL LANE WIDTH IS REQUIRED.
- 14. HYDRAULIC GRADE LINES SHOWN IN PROFILES ARE FOR 100 YEAR FREQUENCY FLOWS, UNLESS
- 15. THE CONTRACTOR SHALL COMPLY WITH THE STATE AND LOCAL SAFETY CODES DURING THE PROGRESS OF
- 16. THE CONTRACTOR SHALL MAINTAIN ADJACENT STREETS IN A NEAT, SAFE, CLEAN AND SANITARY CONDITION AT ALL TIMES AND TO THE SATISFACTION OF THE COUNTY'S OR DISTRICT'S INSPECTOR. THE ADJACENT STREETS SHALL BE KEPT CLEAN OF DEBRIS, WITH DUST AND OTHER NUISANCE BEING CONTROLLED AT ALL TIMES. THE DEVELOPER SHALL BE RESPONSIBLE FOR ANY CLEAN UP ON ADJACENT STREETS AFFECTED BY HIS CONSTRUCTION. METHOD OF STREET CLEANING SHALL BE DRY SWEEPING OF ALL
- 17. THE CONTRACTOR AGREES THAT HE/SHE SHALL ASSUME SOLE AND COMPLETE RESPONSIBILITY FOR THE JOB SITE CONDITIONS DURING THE COURSE OF CONSTRUCTION OF THIS PROJECT. INCLUDING SAFETY OF ALL PERSONS AND PROPERTY, THAT THIS REQUIREMENT SHALL APPLY CONTINUOUSLY AND NOT BE LIMITED TO NORMAL WORKING HOURS AND THAT THE CONTRACTOR SHALL DEFEND, INDEMNIFY, AND HOLD THE OWNER. CITY OF BEAUMONT. AND THE DEVELOPER'S ENGINEER. HARMLESS FROM ANY AND ALL LIABILITY, REAL OR ALLEGED, IN CONNECTION WITH THE PERFORMANCE OF WORK ON THIS PROJECT EXCEPTING FOR LIABILITY ARISING FROM THE SOLE NEGLIGENCE OF THE OWNERS OR THE DEVELOPER'S
- 18. ALL PIPE LENGTHS ARE HORIZONTAL PROJECTIONS (NOT TRUE LENGTHS OF PIPE) AND ARE THE BASIS OF THE ESTIMATES OF QUANTITIES. THE CONTRACTOR SHALL DETERMINE THE TRUE QUANTITY OF PIPE REQUIRED FOR THIS PROJECT PRIOR TO PLACING THE ORDER.
- 19. ALL ELEVATIONS SHOWN ARE TO THE INVERTS OF PIPE, EXCEPT WHERE OTHERWISE NOTED.
- 20. AT THE DISCRETION OF THE ENGINEER AND THE CITY OF BEAUMONT, THE CONTRACTOR MAY BE REQUIRED TO VERIFY. BY POTHOLING, THE LOCATION OF POTENTIALLY AFFECTED UTILITIES.
- 21. CONTRACTOR SHALL DISPOSE OF ALL EXCESS EXCAVATED MATERIAL AT MANDATORY DISPOSAL SITE.
- 22. ALL BACKFILL AND BEDDING AROUND STRUCTURES AND PIPES SHALL BE COMPACTED TO NOT LESS THAN 90 PERCENT RELATIVE COMPACTION EXCEPT WHERE SUCH MATERIAL IS PLACED UNDER EXISTING PAVED ROADWAYS. THE TOP 3 FEET, MEASURED FROM THE FINISH PAVING, SHALL BE COMPACTED TO 95 * PERCENT RELATIVE COMPACTION.
- 23. ALL SURVEY MONUMENTS SHALL BE REPLACED AS REQUIRED. MONUMENTS SHALL BE TIED OUT PRIOR TO CONSTRUCTION AND REPLACED UPON COMPLETION OF CONSTRUCTION.
- 24. IT SHALL BE THE RESPONSIBILITY OF THE DEVELOPER/OWNER OR CONTRACTOR TO APPLY TO THE DIRECTOR OF PUBLIC WORKS, CITY OF BEAUMONT FOR AN ENCROACHMENT PERMIT FOR ALL WORK PERFORMED WITHIN PUBLIC RIGHT-OF-WAY, DEDICATED AND ACCEPTED FOR PUBLIC USE; AND TO BE RESPONSIBLE FOR SATISFACTORY COMPLIANCE FOR ALL CURRENT ENVIRONMENTAL REGULATIONS DURING THE LIFE OF CONSTRUCTION ACTIVITIES FOR THIS PROJECT. ADDITIONAL STUDIES AND/OR PERMITS MAY BE REQUIRED.
- 25. THE CONTRACTOR SHALL BE RESPONSIBLE FOR THE CLEARING OF THE PROPOSED WORK AREA, AND RELOCATION COSTS OF ALL EXISTING UTILITIES. PERMITTEE MUST INFORM CITY OF CONSTRUCTION SCHEDULE AT LEAST 48 HOURS PRIOR TO BEGINNING CONSTRUCTION.
- 26. ALL UNDERGROUND FACILITIES WITH LATERALS SHALL BE IN PLACE PRIOR TO PAVING THE STREET, INCLUDING BUT NOT LIMITED TO, THE FOLLOWING: SEWER, WATER, ELECTRIC, STORM DRAINS.
- 27. IT SHALL BE THE RESPONSIBILITY OF THE DEVELOPER OR CONTRACTOR TO INSTALL AND MAINTAIN DURING CONSTRUCTION, REGULATORY GUIDE AND WARNING SIGNS WITHIN THE PROJECT LIMITS AND ITS SURROUNDINGS TO PROVIDE SAFE PASSAGE FOR THE TRAVELING PUBLIC AND WORKERS UNTIL THE FINAL COMPLETION AND ACCEPTANCE OF THE PROJECT BY THE CITY OF BEAUMONT.
- 28. CONSTRUCTION PROJECTS THAT DISTURB MORE THAN ONE ACRE MUST OBTAIN A NATIONAL POLLUTANT DISCHARGE ELIMINATION SYSTEM (NPDES) PERMIT. OWNER/DEVELOPERS ARE REQUIRED TO FILE A NOTICE OF INTENT (NOI) WITH THE STATE WATER RESOURCES CONTROL BOARD (SWRCB) AND COMPLY WITH ALL REQUIREMENTS OF THE BEAUMONT DRAINAGE MANAGEMENT PLAN. BEAUMONT IS CO-PERMITTEE WITH R.C.F.C. & W.C.D.
- 29. ALL STORM DRAINS, CATCH BASINS, AND STORM WATER RUNOFF STRUCTURES WILL BE PROVIDED WITH ADEQUATE CAPABILITIES TO FILTER AND RETAIN SEDIMENT AND DIRT. OIL. AND GREASE, TO PREVENT POLLUTION IN STORM WATER RUNOFF IN COMPLIANCE WITH THE CITY OF BEAUMONT'S BEST MANAGEMENT PRACTICES AND THE BEAUMONT DRAINAGE MASTER PLAN FOR STORM WATER AS WELL AS BEST MANAGEMENT PRACTICES IDENTIFIED IN THE CURRENT REPORT OF WASTE DISCHARGE FOR RIVERSIDE COUNTY PERMITTEES.
- DEVELOPER SHALL BE FULLY RESPONSIBLE IN ASSURING THAT PROPOSED IMPROVEMENTS CONFORM TO THE APPROVED PLANS, SPECIFICATIONS AND CITY OF BEAUMONT STANDARDS. WHERE DEVIATIONS FXIST. DEVELOPER SHALL PROPOSE CORRECTIVE MEASURES FOR REVIEW AND APPROVAL BY THE CITY.

UNDERGROUND SERVICE ALERT OF SOUTHERN CALIFORNIA | BEARING: N 27°39'52" F


CITY OF BEAUMONT, CALIFORNIA STORM DRAIN IMPROVEMENT PLAN TRACT NO. 36558 LINE "A" AND LINE "B"

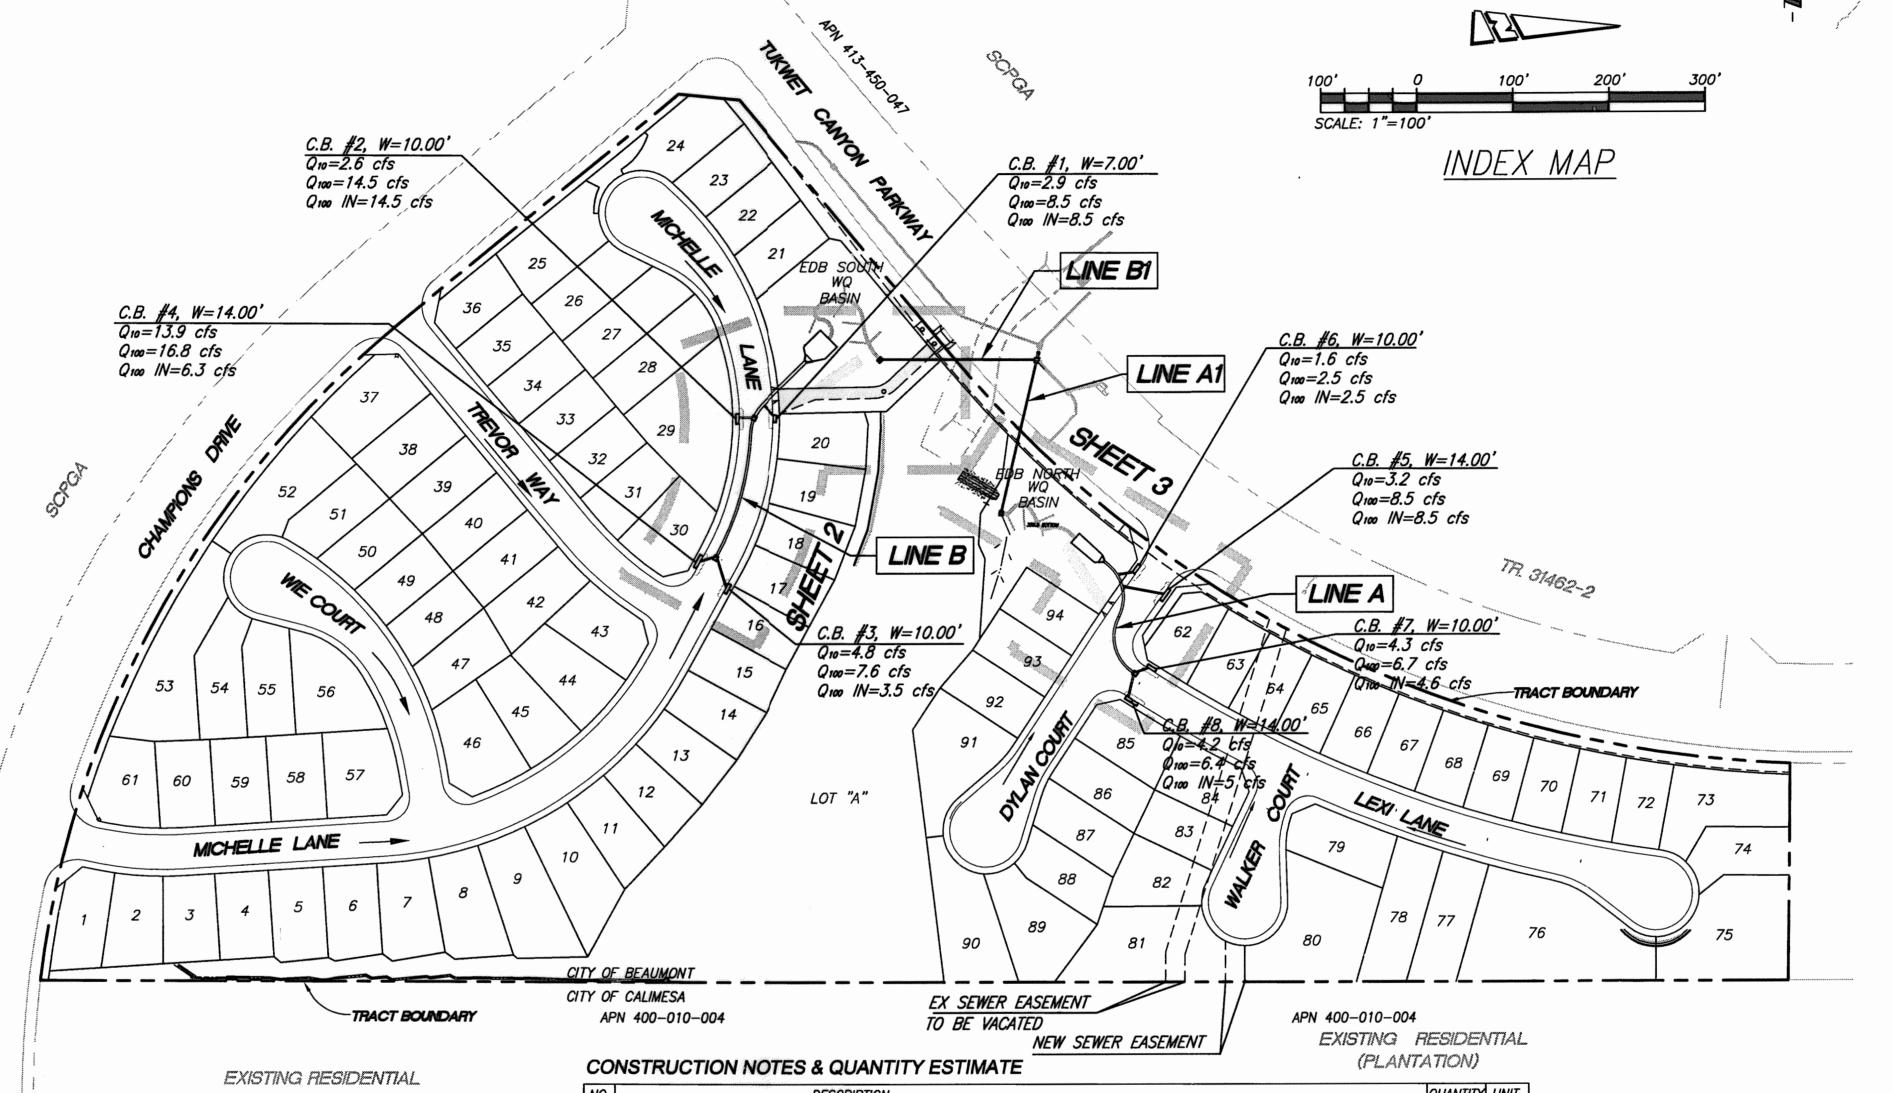

DECLARATION OF ENGINEER OF RECORD:


I HEREBY DECLARE THAT IN MY PROFESSIONAL OPINION. THE DESIGN OF THE IMPROVEMENTS AS SHOWN ON THESE PLANS COMPLIES WITH THE CURRENT PROFESSIONAL ENGINEERING STANDARDS AND PRACTICES. AS THE ENGINEER IN RESPONSIBLE CHARGE OF THE DESIGN OF THESE IMPROVEMENTS. I ACCEPT FULL RESPONSIBILITY FOR SUCH DESIGN. I UNDERSTAND AND ACKNOWLEDGE THAT THE PLAN CHECK OF THESE PLANS BY THE CITY OF BEAUMONT IS A REVIEW FOR THE LIMITED PURPOSE OF ENSURING THAT THESE PLANS COMPLY WITH THE CITY PROCEDURES AND OTHER APPLICABLE CODES AND ORDINANCES. THE PLAN REVIEW PROCESS IS NOT A DETERMINATION OF THE TECHNICAL ADEQUACY OF THE DESIGN OF THE IMPROVEMENTS. SUCH PLAN CHECK DOES NOT THEREFORE RELIEVE ME OF MY DESIGN RESPONSIBILITY.

AS THE ENGINEER OF RECORD. I AGREE TO DEFEND AND INDEMNIFY THE CITY OF BEAUMONT, ITS OFFICERS, ITS AGENTS, AND ITS EMPLOYEES FROM ANY AND ALL LIABILITY. CLAIMS. DAMAGES. OR INJURIES TO ANY PERSON OR PROPERTY ARISING FROM NEGLIGENT ACTS. ERRORS OR OMISSIONS OF THE ENGINEER OF RECORD, HIS EMPLOYEES. HIS AGENTS OR HIS CONSULTANTS.

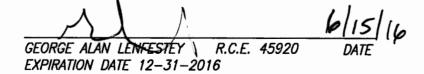

QUANTITY UNIT DESCRIPTION (1) CONSTRUCT 18" RCP (2000D) 166 | L.F. 614 | L.F. (2) CONSTRUCT 24" RCP (2000D) (3) CONSTRUCT 36" RCP (2000D) 80 | L.F. (4) CONSTRUCT CURB INLET CATCH BASIN PER COUNTY OF RIVERSIDE STD. NO. 300 (W & V PER PLAN) (7) CONSTRUCT MANHOLE NO. 1 PER R.C.F.C. & W.C.D. STD. DWG. NO. MH251 4 | EA. (9) CONSTRUCT JUNCTION STRUCTURE #2 PER R.C.F.C. & W.C.D. STD. JS227. 3 | EA. (10) CONSTRUCT FOREBAY AND CONCRETE CURB PER DETAIL ON SHEET 2. (T) NOT USED [12] INSTALL CATCH BASIN TRASH RACK — DRAINPAC CURB INLET FILTER OR APPROVED EQUAL 8 | EA. (14) CONSTRUCT CONCRETE COLLAR PER R.C.F.D. & W.C.D. STD. DWG. NO. M803 2 | EA. (15) CONSTRUCT WING-WALL TYPE HEADWALL PER DETAIL ON SHEET 3 2 | EA. 781 | S.F. (16) REMOVE AND REPLACE A.C. IN KIND (7) REMOVE AND REPLACE CURB IN KIND (18) REMOVE AND REPLACE SIDEWALK IN KIND 97 | S.F. (19) REMOVE AND REPLACE STREET MEDIAN IN KIND 189 | S.F.

* SEE DETAILS ON SHEET 2 AND 3

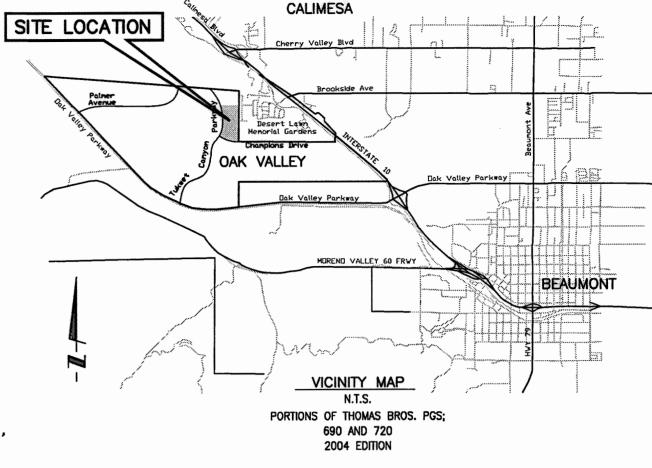

PREPARED BY:

PROACTIVE ENGINEERING CONSULTANTS WEST, INC. 25109 JEFFERSON AVENUE SUITE 200 MURRIETA, CA 92562 (951) 200-6840

APPLICANT/SUBDIVIDER:

ARGENT MANAGEMENT 2392 MORSE AVE. IRVINE, CA 92614 (949) 777-4000 OFFICE (949) 241-8439 OFFICE CONTACT: DEREK HICKS

LEGEND

REINFORCED CONCRETE PIPE CORRUGATED METAL PIPE HYDRAULIC GRADE LINE TOP OF PIPE BOTTOM OF PIPE STORM DRAIN **PROPOSED** EXISTING TOP OF CURB FLOWLINE FINISHED SURFACE CATCH BASIN POINT OF REVERSE CURVE

NOTE:

- 1. APPROVAL OF THESE PLANS APPLY ONLY WITHIN THE JURISDICTION OF THE CITY OF BEAUMONT
- 2. TRENCHING FOR UTILITIES AND STRUCTURES IS NOT ALLOWED UNTIL SOIL COMPACTION REPORT IS SUBMITTED AND APPROVED BY THE PUBLIC WORK DEPARTMENT.
- 3. THE CITY RESERVES THE RIGHT TO REQUIRE REVISION OF THE APPROVED PLANS TO CONFORM WITH CURRENT STANDARDS AND TO POST A NEW BOND IF CONSTRUCTION HAS NOT COMMENCED WITHIN TWO YEARS AFTER PLANS WERE APPROVED.
- 4. THE DEVELOPER SHALL HAVE GEOTECHNICAL/SOILS ENGINEERING FIRM OBSERVE TRENCHING, BACKFILLING, AND SOIL COMPACTION OF ALL UTILITY TRENCHES WITHIN ALL EASEMENTS AND ROAD RIGHTS OF WAY. TWO SETS OF COMPACTION REPORTS CERTIFYING THAT WORKS WERE DONE IN CONFORMANCE TO STANDARDS AND GEOTECHNICAL REPORT SHALL BE SUBMITTED AFTER EACH UTILITY TRENCH IS COMPLETED AND CERTIFIED. COMPACTION REPORT MUST BE SUBMITTED TO THE DEPT. OF PUBLIC WORKS AT LEAST TWO WORKING DAYS BEFORE AGGREGATE BASE MATERIALS ARE PLACED ONSITE.

WDID #: 8 33C364442

INDEX OF SHEETS:

SHEET 1 - TITLE SHEET - VICINITY MAP - GENERAL NOTES -LEGEND - CONSTRUCTION NOTES - QUANTITIES -INDEX MAP

SHEET 2 - STORM DRAIN LINE "B" AND "B1" SHEET 3 - STORM DRAIN LINE "A" AND "A1"

CITY OF BEAUMONT, CALIFORNIA

TITLE SHEET - VICINITY MAP - GENERAL NOTES LEGEND - CONSTRUCTION NOTES -

STORM DRAIN IMPROVEMENT PLANS

TRACT NO. 36558


DRAWING NAME:

SHEET

OF 3 SHEETS

Date: 6-23-16

Plotted: Jun 15, 2016 - 3:45pm By: alexj DWG: Z:\01.104.000 FC-PA14\Drawings\Storm Drain Improvements\36558-SD_SHT-01.dwg

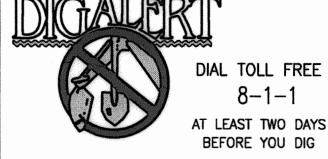

BASIS OF BEARINGS: **DESCRIPTION:**

THE BASIS OF COORDINATES FOR THIS MAP IS THE CALIFORNIA STATE PLANE COORDINATE SYSTEM, 1983, ZONE 6, BASED LOCALLY ON CONTROL STATIONS "REST" AND "RABBIT".

DESCRIPTION: USGS MONUMENT "REST" BENCHMARK DISK SET IN TOP OF CONCRETE MONUMENT STAMPED "REST 1972" ON DESERT LAWN DRIVE ACROSS THE DRIVE FROM DESERT LAWN CEMETERY 25.3 FT. N.E. OF THE DRIVE CENTERLINE 24.9 FT. S.W. OF THE S.W. EDGE OF THE SOUTH EASTBOUND LANES

OF INTERSTATE HIGHWAY 10 ELEV. 2491.44, NGVD 29

DESCRIPTION GEORGE ALAN LENFESTEY R.C.E. 45920 EXP. 12-31-2016 REVISIONS

PROACTIVE ENGINEERING CONSULTANTS WEST, INC. 25109 JEFFERSON AVE. SUITE 200 PROACTIVE 06/15/16

No. 45920 Exp. 12/31/16

CHECKED BY: AS NOTED 06/15/16


Approved By: JOB NUMBER: 01.104.000


Reviewed By:

Date: 6-23-16 _ Date: <u>५/२२/</u>॥ City of Beaumont, Public Works Department Engineering Division

QUANTITIES - INDEX MAP

ARGENT MANAGEMENT

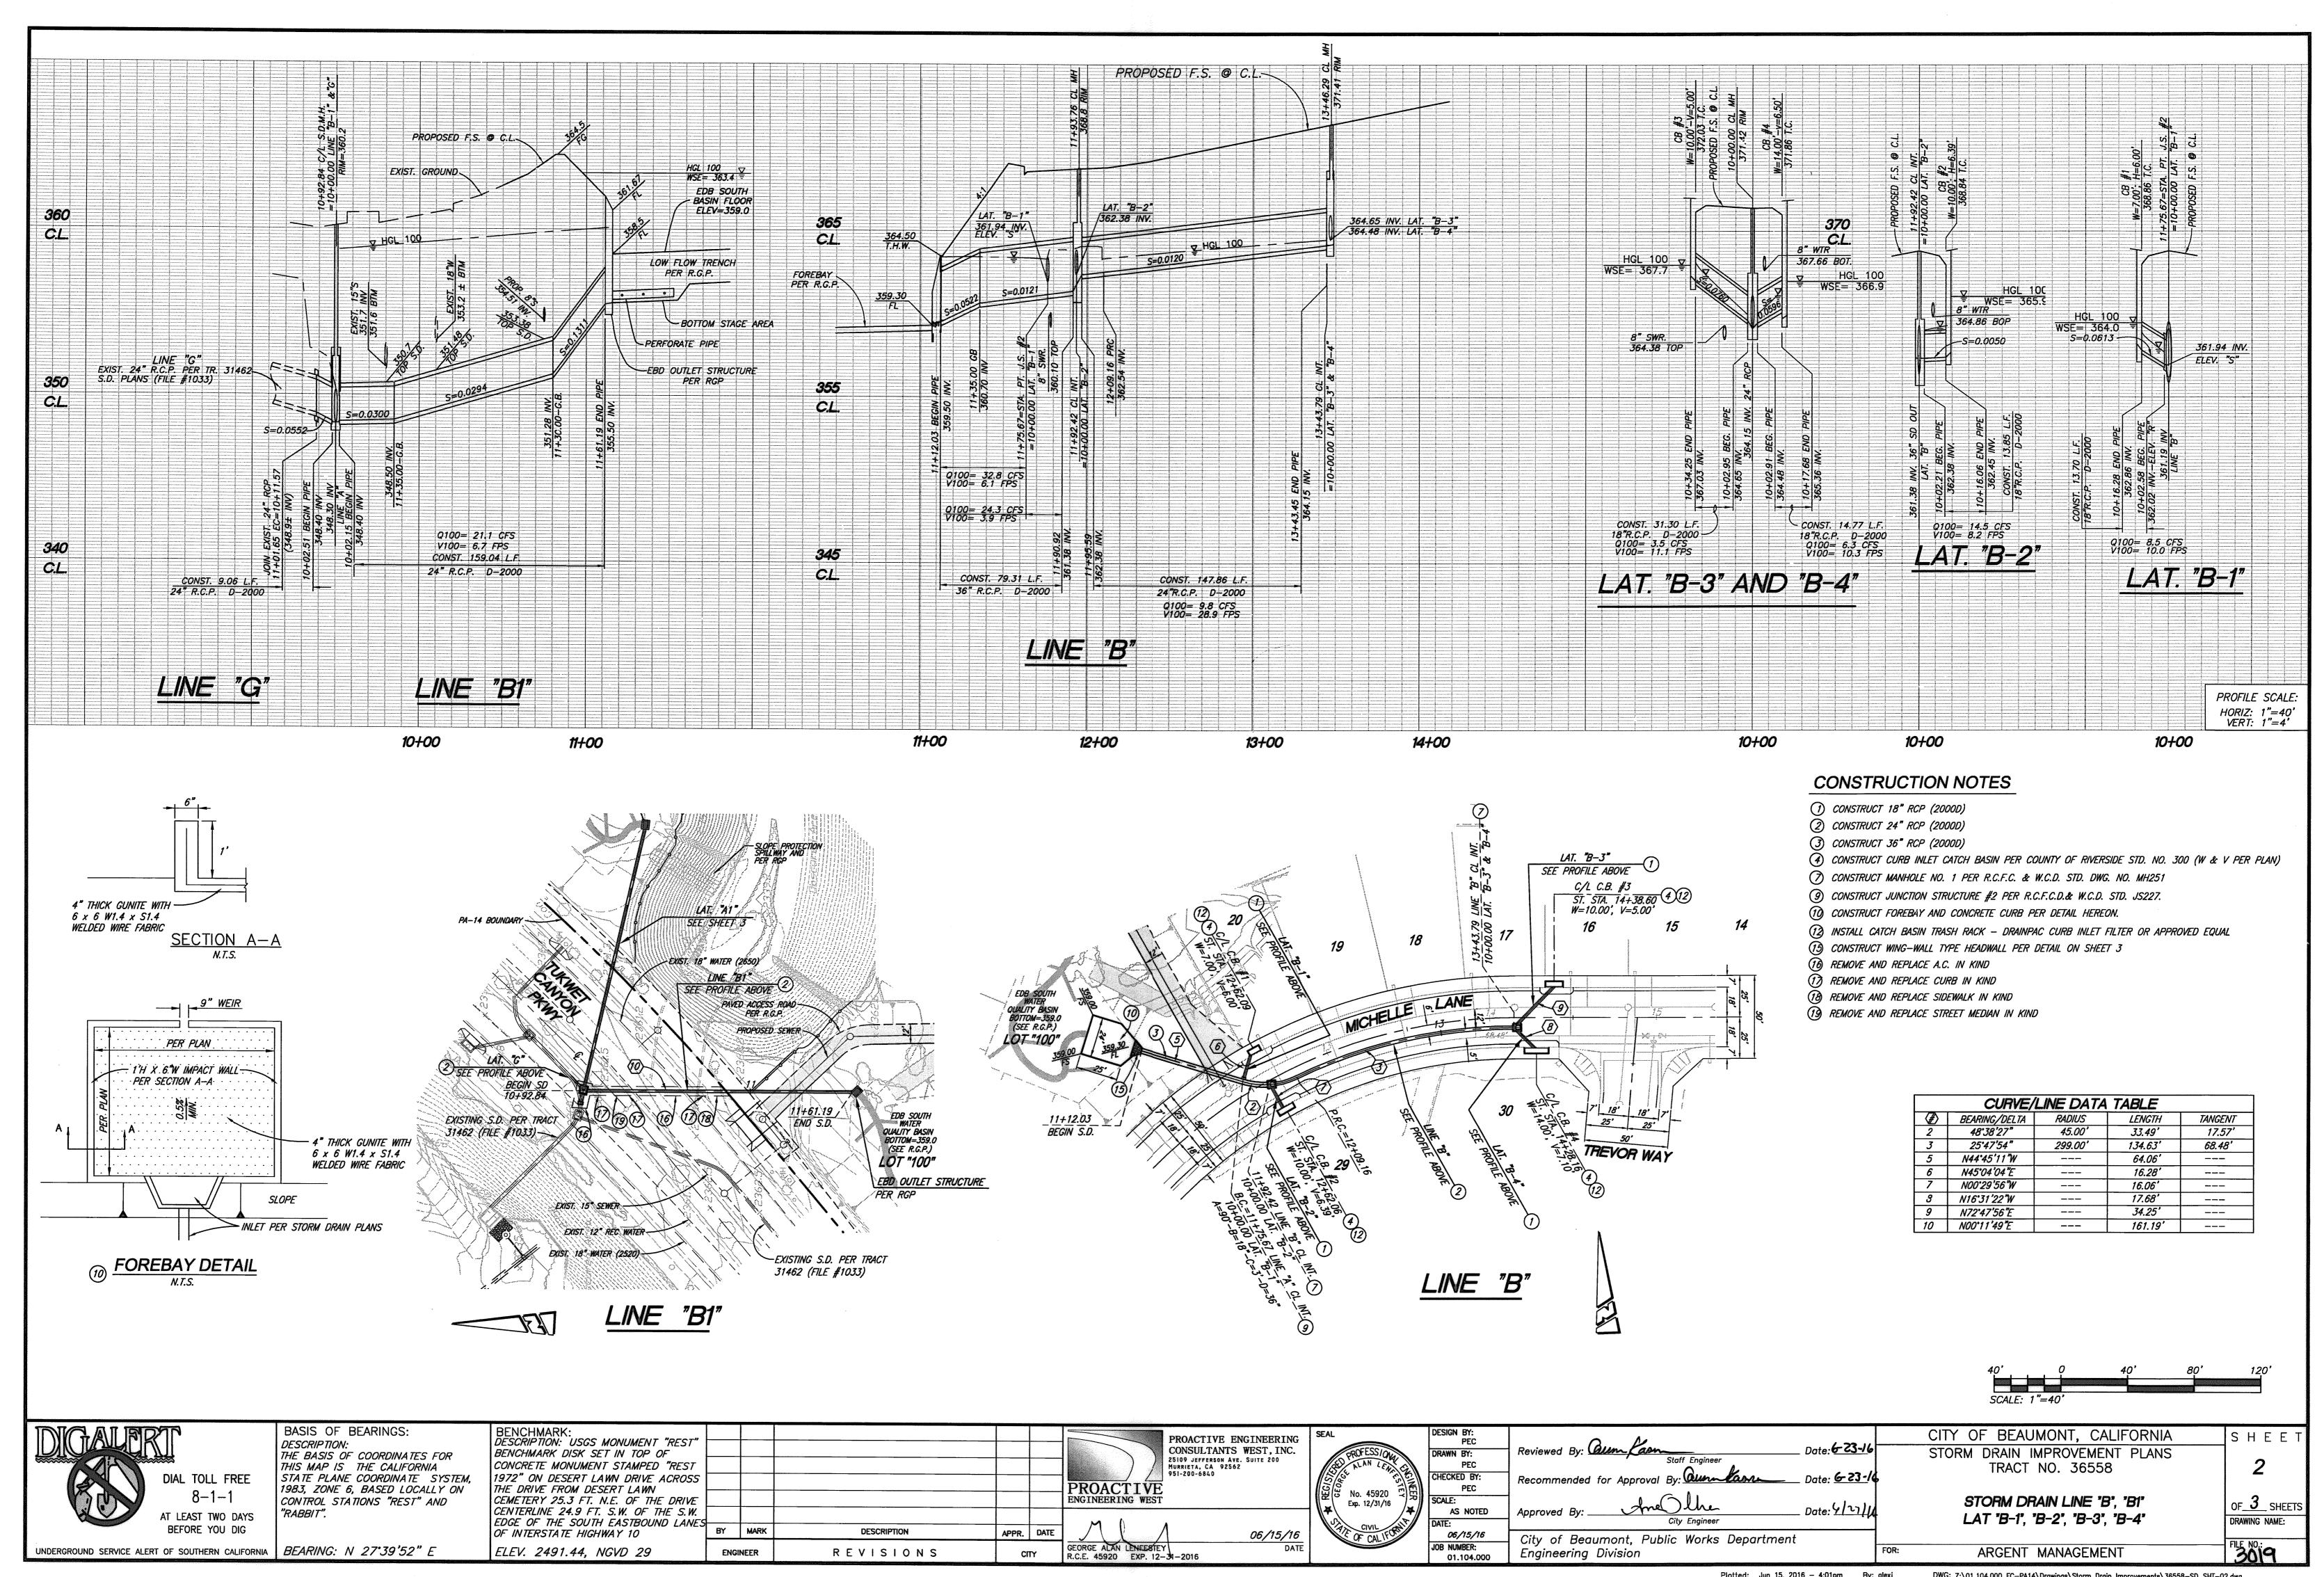

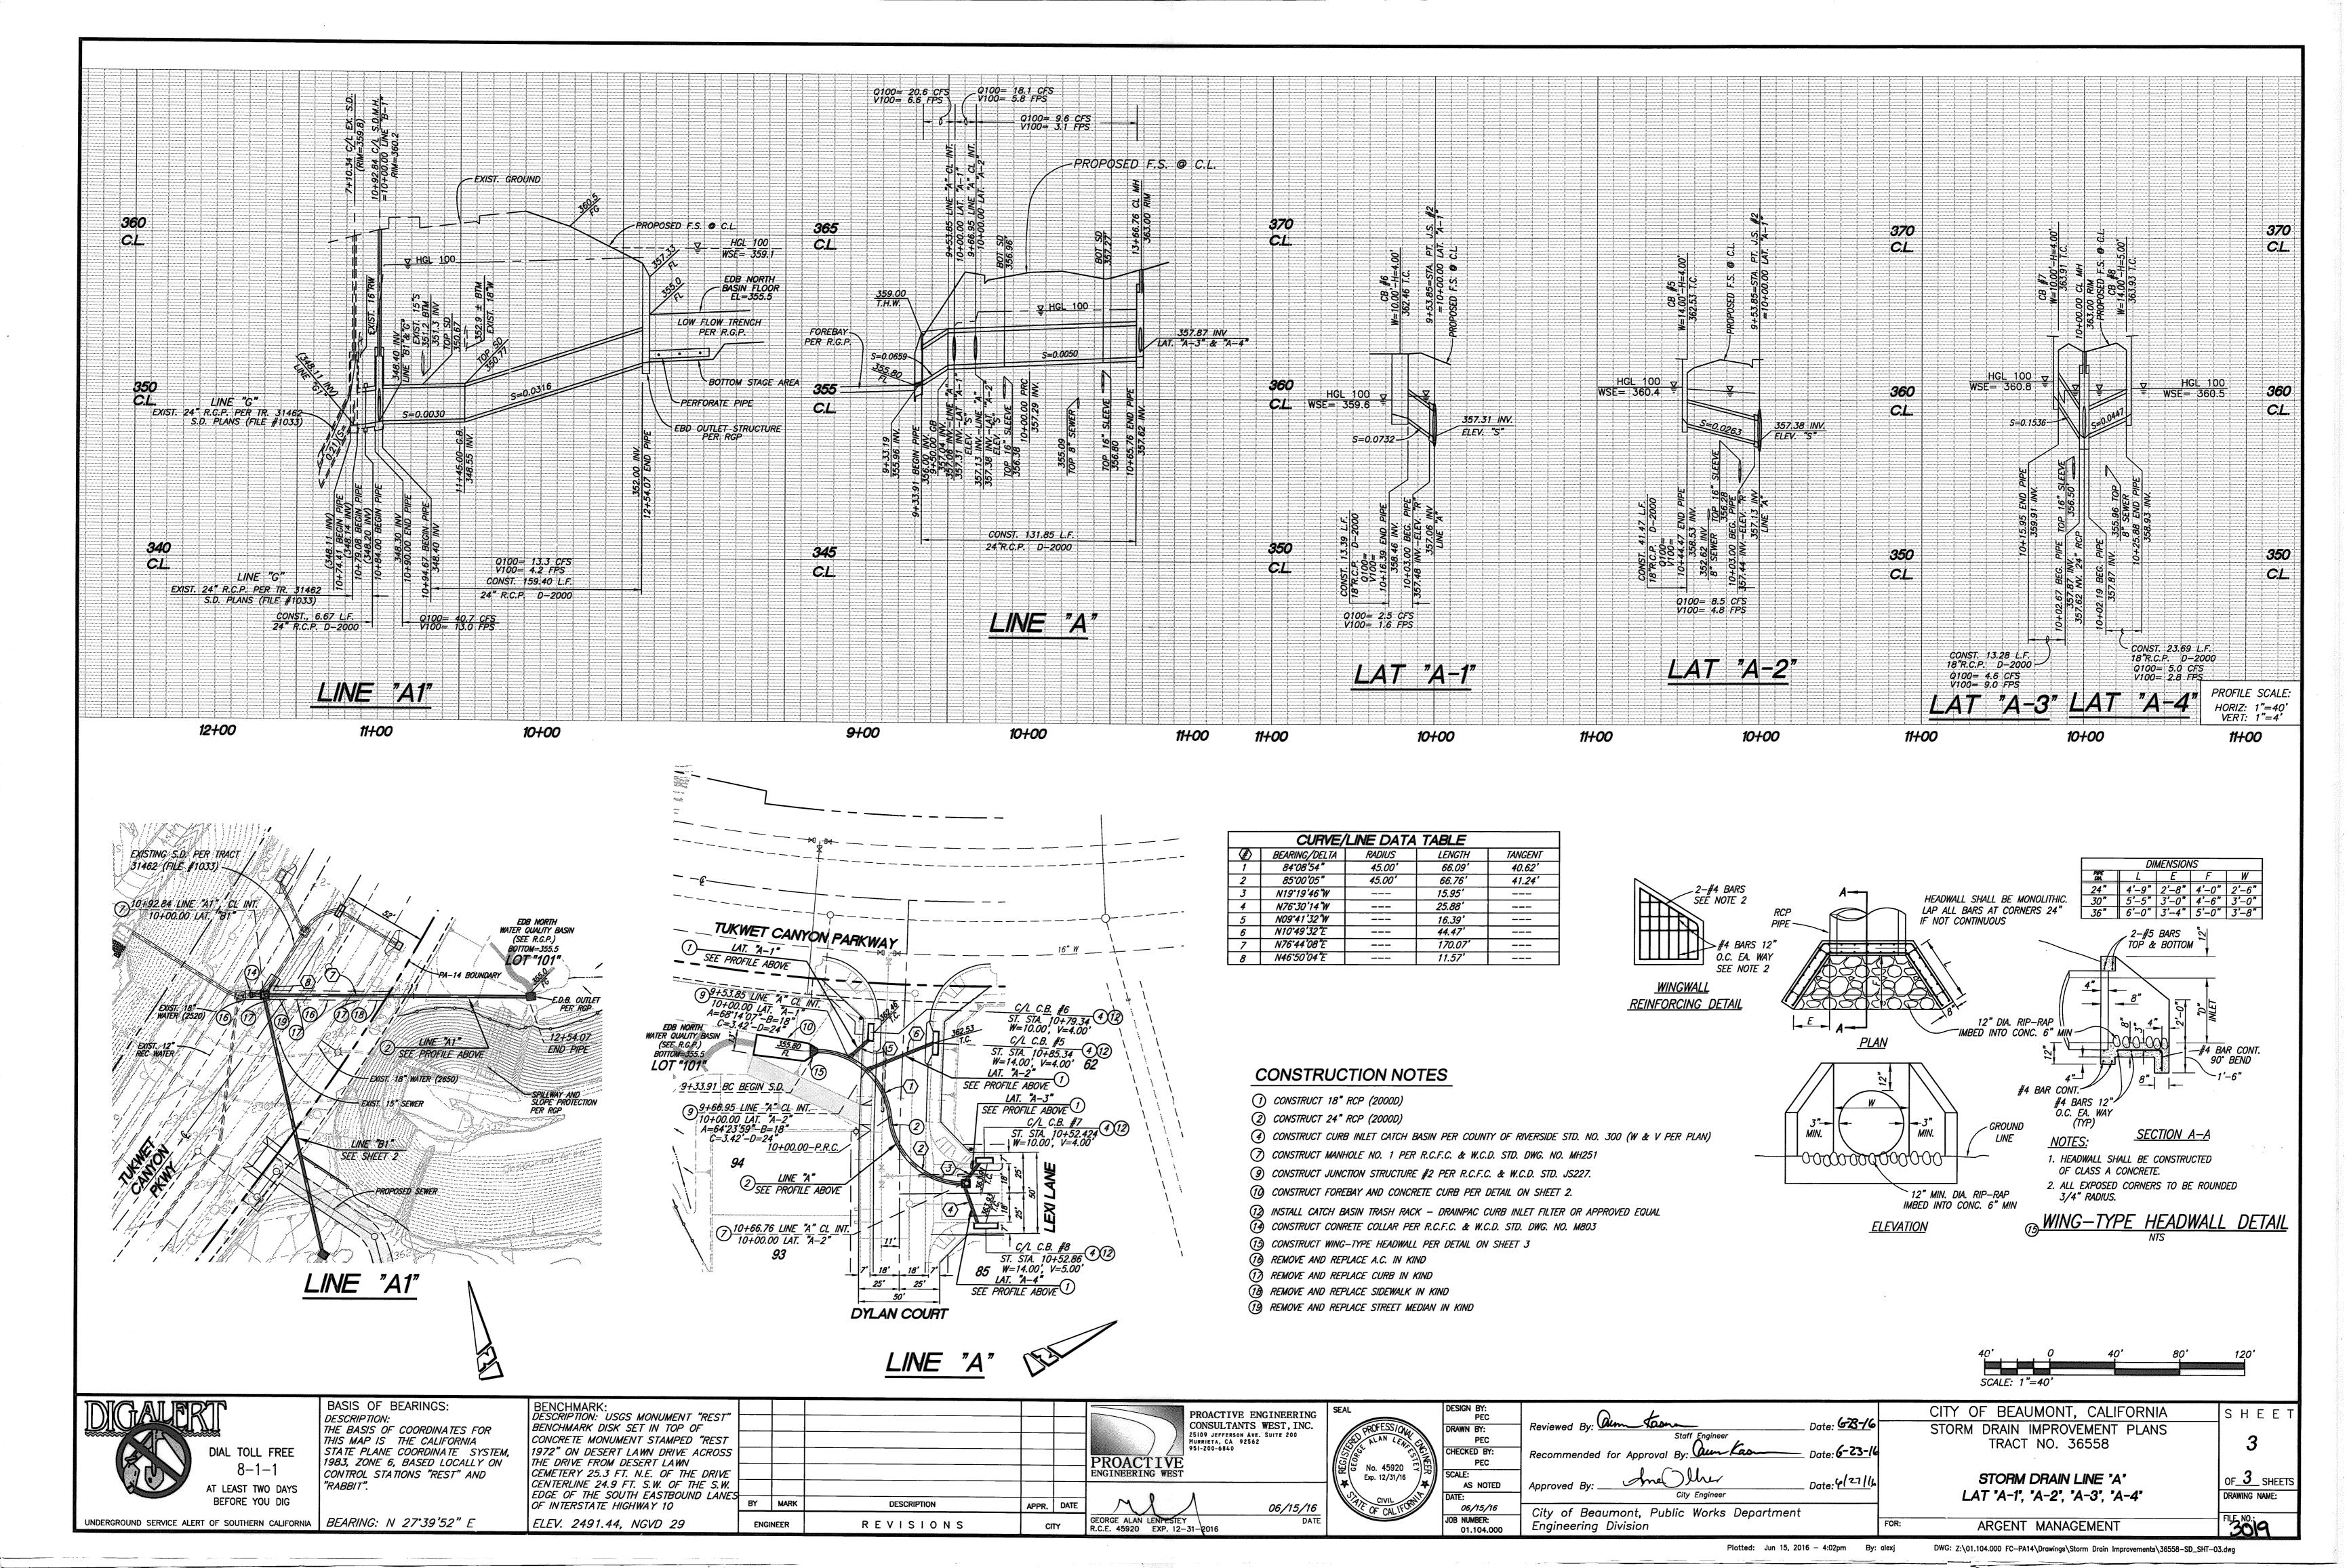

SITE LOCATION OAK VALLEY BEAUMON N.T.S. PORTIONS OF THOMAS BROS. PGS: 690 AND 720 2004 EDITION

APPLICANT/SUBDIVIDER:


ARGENT MANAGEMENT 2692 MORSE AVENUE IRVINE, CA 92614 OFFICE: (949) 777-4000 FAX: (949) 777-4050

ABBREVIATIONS LEGEND TRACT BOUNDARY FINISH SURFACE RIGHT OF WAY INVERT OF PIPE PROPOSED 8" & 10" SEWER MAIN CENTERLINE RIGHT-OF-WAY PROPOSED 4" SEWER SERVICE SEWER MANHOLE STATION PROPOSED WATER BY OTHERS **LENGTH** PROPOSED 8" WATER NOT TO SCALE PROPOSED WATER SERVICE ELEV./EL. ELEVATION PE=2367.1 PAD ELEVATION MAXIMUM B.W. PROPOSED BACKFLOW PREVENTER TYPICAL "WYE" STATION @ MAIN TOP OF PIPE BOTTOM OF PIPE 10+35.22 SEWER LATERAL CALLOUT WTR SEW SEWER CONSTRUCTION NOTE REFERENCE -

DECLARATION OF ENGINEER OF RECORDS

I HEREBY DECLARE THAT IN MY PROFESSIONAL OPINION, THE DESIGN OF THE IMPROVEMENTS AS SHOWN ON THESE PLANS COMPLIES WITH THE CURRENT PROFESSIONAL ENGINEERING STANDARDS AND PRACTICES. AS THE ENGINEER IN RESPONSIBLE CHARGE OF THE DESIGN OF THESE IMPROVEMENTS, I ACCEPT FULL RESPONSIBILITY FOR SUCH DESIGN. I UNDERSTAND AND ACKNOWLEDGE THAT THE PLAN CHECK OF THESE PLANS BY THE CITY OF BEAUMONT IS A REVIEW FOR THE LIMITED PURPOSE OF ENSURING THAT THESE PLANS COMPLY WITH THE CITY PROCEDURES AND OTHER APPLICABLE CODES AND ORDINANCES. THE PLAN REVIEW PROCESS IS NOT A DETERMINATION OF THE TECHNICAL ADEQUACY OF THE DESIGN OF THE IMPROVEMENTS. SUCH PLAN CHECK DOES NOT THEREFORE RELIEVE ME OF MY DESIGN RESPONSIBILITY.


AS THE ENGINEER OF RECORD, I AGREE TO DEFEND AND INDEMNIFY THE CITY OF BEAUMONT, ITS OFFICERS, ITS AGENTS, AND ITS EMPLOYEES FROM ANY AND ALL LIABILITY, CLAIMS, DAMAGES, OR INJURIES TO ANY PERSON OR PROPERTY ARISING FROM NEGLIGENT ACTS, ERRORS OR OMISSIONS OF THE ENGINEER OF RECORD. HIS EMPLOYEES, HIS AGENTS OR HIS CONSULTANTS.

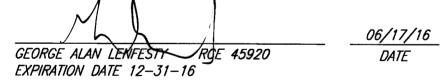

PRIVATE ENGINEERS NOTICE TO CONTRACTOR(S)

- 1. THE EXISTENCE AND LOCATION OF ANY UNDERGROUND UTILITIES OR STRUCTURES SHOWN ON THESE PLANS ARE OBTAINED BY A SEARCH OF AVAILABLE RECORDS. TO THE BEST OF OUR KNOWLEDGE THERE ARE NO EXISTING UTILITIES EXCEPT THOSE SHOWN ON THESE PLANS. THE CONTRACTOR IS REQUIRED TO TAKE ALL PRECAUTIONARY MEASURES TO PROTECT THE UTILITIES SHOWN, AND ANY OTHER LINES OR STRUCTURES NOT SHOWN ON THESE PLANS, AND IS REQUIRED FOR THE PROTECTION OF, AND ANY DAMAGE TO THESE LINES OR STRUCTURES.
- 2. IT SHALL BE THE CONTRACTORS RESPONSIBILITY TO NOTIFY THE OWNER OF ALL UTILITIES OR STRUCTURES CONCERNED BEFORE STARTING WORK.
- 3. QUANTITIES SHOWN HEREON ARE PROVIDED FOR BIDDING PURPOSES ONLY. CONTRACTOR SHALL BE RESPONSIBLE FOR VERIFYING ALL QUANTITIES PRIOR TO BIDDING FOR CONSTRUCTION.
- 4. THE PRIVATE ENGINEER SIGNING THESE PLANS IS RESPONSIBLE FOR ASSURING THE ACCURACY AND ACCEPTABILITY OF THE DESIGN HEREON. IN THE EVENT OF DISCREPANCIES ARISING AFTER CITY APPROVAL OR DURING CONSTRUCTION, THE PRIVATE ENGINEER SHALL BE RESPONSIBLE FOR DETERMINING AN ACCEPTABLE SOLUTION AND REVISING THE PLANS FOR APPROVAL BY THE CITY.

CITY OF BEAUMONT, CALIFORNIA SEWER IMPROVEMENT PLANS TRACT NO. 36558

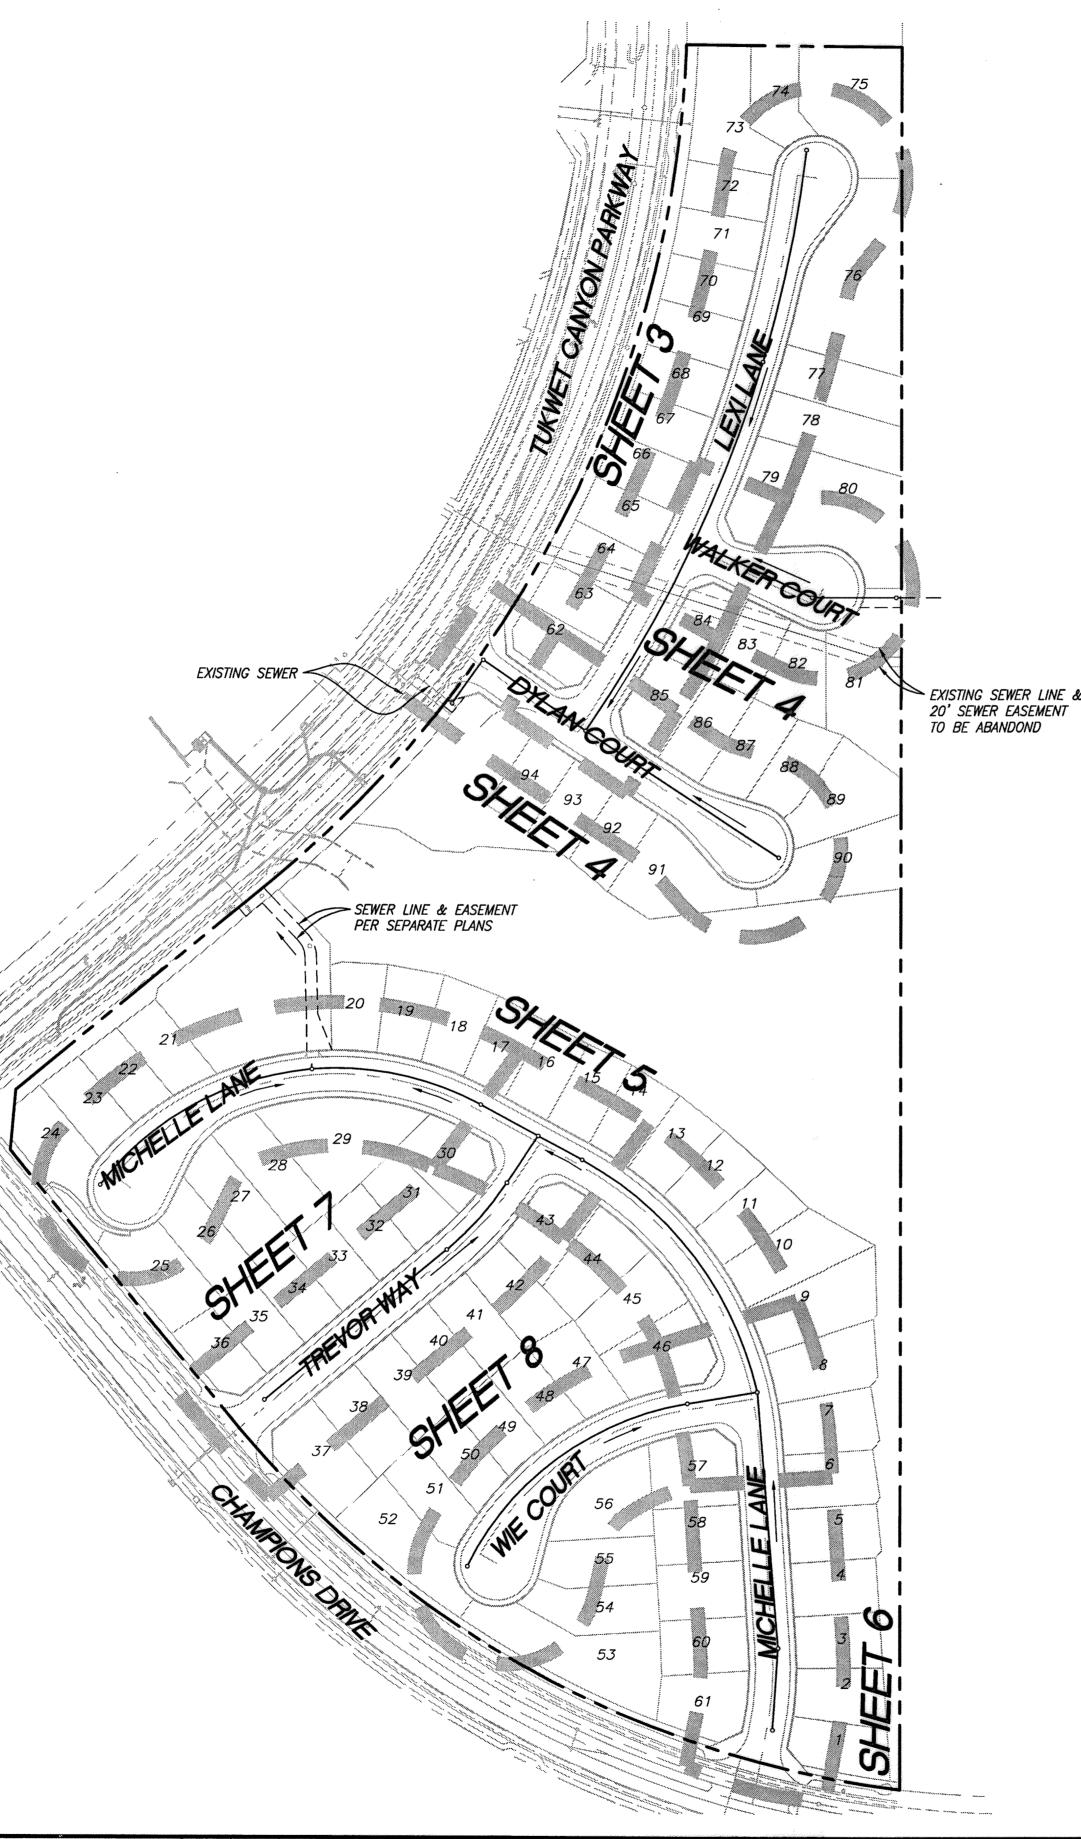

SEWER NOTES

- 1. SEWER CONSTRUCTION AND MATERIALS SHALL BE IN ACCORDANCE WITH THE CITY OF BEAUMONT'S STANDARDS AND SPECIFICATIONS.
- 2. GRAVITY SEWER PROFILE ELEVATIONS ARE TO BE FLOW LINES (CONDUIT INVERTS).
- MANHOLES SHALL BE CONSTRUCTED IN ACCORDANCE WITH RCTD STD 606. SEWER MAINS MAY BE LAID THROUGH THE MANHOLES AND USED AS A FORM FOR THE INVERT. CAST IRON SHALL BE USED FOR MANHOLE COVERS AND SHALL HAVE A 12" COVERING RING.
- 4. PRIOR TO CONSTRUCTION OF SEWER, CONTRACTOR SHALL EXPOSE EXISTING SEWER AND VERIFY ITS EXISTING ELEVATION. WHERE CONNECTION TO EXISTING MANHOLES AND INLET STUB OF PROPER SIZE EXISTS, NO ALTERATIONS SHALL BE MADE TO EXISTING MANHOLE BASE OR STUB EXCEPT AS SPECIFICALLY AUTHORIZED BY THE CITY OF BEAUMONT.
- 5. WHERE A NEW INLET MUST BE CONSTRUCTED IN AN EXISTING MANHOLE, THE ELEVATION OF THE INLET SHALL BE SUCH THAT ITS CROWN SHALL BE LEVELED WITH THE CROWN OF THE OUTLET PIPE, AT THEIR PROJECTIONS TO THE MANHOLE CENTERLINE.
- 6. ALL SEWER INLETS AT THE MANHOLE SHALL BE SUCH THAT ITS CROWN SHALL BE LEVEL WITH THE CROWN OF THE OUTLET PIPE, AT THEIR PROJECTION TO THE MANHOLE
- 7. THE CONTRACTOR IS ADVISED THAT THE WORK ON THIS PROJECT MAY INVOLVE WORKING IN A CONFINED AIR SPACE. CONTRACTOR SHALL BE RESPONSIBLE FOR "CONFINED AIR SPACE" ARTICLE 108, TITLE 8 CALIFORNIA ADMINISTRATION CODE.
- 8. PROVIDE BACKFLOW PREVENTION DEVICES WHERE UPSTREAM MANHOLE RIM IS HIGHER THAN PAD ELEVATION.
- 9. PROVIDE APPROPRIATE MARKING TAPE AT TOP OF THE PIPE CENTERLINE ON TOP OF PIPE BEDDING.
- 10. SEWER LATERAL SHALL BE 45 DEGREE WYE FITTING, UNLESS OTHERWISE NOTED OR DETAILED ON PLANS.
- 11. DEVELOPER SHALL HAVE GEOTECHNICAL/ SOIL ENGINEERING FIRM OBSERVE TRENCHING, BACKFILLING AND SOIL COMPACTION OF ALL UTILITY TRENCHES WITHIN EASEMENTS AND ROAD RIGHT OF WAY. TWO SETS OF COMPACTION REPORTS CERTIFYING THAT WORK WAS DONE IN CONFORMANCE TO STANDARDS AND GEOTECHNICAL REPORT SHALL BE SUBMITTED TO THE DEPARTMENT OF PUBLIC WORKS AT LEAST TWO WORKING DAYS BEFORE AGGREGATE BASE MATERIALS ARE PLACED ONSITE.
- 12. UTILITY TRENCH BACKFILL PER PLAN, PROFILE, RCTD STD 818 AND LATEST GREEN BOOK SECTION 306. CRUSH ROCK BEDDING, HAUNCHING, INITIAL BACKFILL PER GREEN BOOK TABLE 306.-1.2.13(B), MAXIMUM ROCK GRADATION 1/2 INCH FOR PVC PIPE SIZE 15 INCH AND SMALLER AND 3/4 INCH CRUSH ROCK FOR PVC PIPE LARGER THAN 15 INCHES DIAMETER.
- 13. TRENCHING AND EXCAVATION PER 29 CFR 1926.651AND 1926.652 OR COMPARABLE OSHA-APPROVED STATE PLAN REQUIREMENTS.
- 14. FOR SEWER MAINS 15 INCH IN DIAMETER AND SMALLER AT DEPTHS BETWEEN 15 AND 20 FEET (FROM FINISH SURFACE TO THE TOP OF THE PIPE) HIGHER CLASS OF BEDDING OR STRONGER PIPE OR BOTH CAN BE USED, OTHERWISE PROVIDE A SOILS REPORT/ SUPPORTING CALCULATIONS TO SUBSTANTIATE THE USE OF PVC SDR 35 SEWER PIPE.
- 15. MAX VELOCITY OF THE SEWER MAIN SHALL NOT EXCEED 10FT/SAT DESIGN FLOW AND MINIMUM ACCEPTED VELOCITY SHALL BE 2FT/SAT DESIGN FLOW (MAX DEPTHS: 1/2 FULL FOR 12" DIAMETER AND SMALLER AND 3/4 FULL FOR 15" AND LARGER DIAMETER). MAXIMUM SLOPES ARE AS FOLLOWS: 8".0.1200, 10"-0.085, 12"-0.0660, 15"-0.0500, 18"-0.3700, 21"·0.0300, 24"0.0250. MINIMUM SLOPES ARE AS FOLLOWS: LATERALS: 4 & 6 INCHES- 0.020, MAIN LINES 8"-0.0040, 10"-0.0032, 12"-0.0024, 15"-0.0016, *18"-0.0014, 21"-0012, 24"- 0.0010.*
- 16. VERTICAL AND HORIZONTAL SEPARATION OF LATERALS OR SEWER MAIN FROM WATER OR RECYCLE WATER LINE SHALL BE IN ACCORDANCE WITH CALIFORNIA HEALTH DEPARTMENT.
- 17. WHEN SEWER LINE CROSS OTHER UTILITIES, STORM DRAINS, OR OTHER OBSTRUCTIONS, THE OUTSIDE PIPE ELEVATIONS SHOULD BE SHOWN TO INDICATE THE AVAILABLE CLEARANCES.
- 18. MANHOLES OF DEPTH MORE THAN 15 FEET FROM FINISH STREET GRADE TO SEWER PIPE SHELF SHALL BE A MINIMUM 60" IN DIAMETER AND SHALL BE CONSTRUCTED PER RCTD STD 606 WITH A MANHOLE FRAMES AND COVERS PER RCTD STD 608.
- 19. MANHOLES OF DEPTH MORE THAN 12 FEET FROM FINISH STREET GRADE TO SEWER PIPE SHELF SHALL BE LINED WITH APPROVED CITY'S PVC LINER. THE BASE AND ALL REMAINING EXPOSED CONCRETE SHALL BE COATED WITH AN APPROVED POLYURETHANE COATING. THE LINING AND COATING SHALL BE FREE FROM DEFECTS, HOLES OR SURFACE
- 20. MANHOLE SPACING THE MAXIMUM DISTANCE BETWEEN MANHOLES FOR PIPE 15 INCHES IN DIAMETER OR SMALLER IS 400 FEET, FOR 18 INCH DIAMETER AND OVER IS 500 FEET. MANHOLES ARE REQUIRED AT THE BEGINNING AND END OF THE CURVES. FOR RADIUS LESS THAN 500 FEET. THE MAXIMUM MANHOLE SPACING IS 200 FEET.
- 21. MAINLINE AND LATERAL CLEANOUTS SHALL BE CONSTRUCTED IN ACCORDANCE WITH RCTD STD DRAWING 603 FOR VCP PIPE AND MODIFIED TO PVC PIPE. CLEANOUT PIPE MUST BE THE SAME DIAMETER AND MATERIAL AS MAIN SEWER LINE. CLEANOUT SHALL BE PLACED ON EACH LATERAL INSIDE OF THE PROPERTY LINE AND SHALL BE COORDINATED AND APPROVED BY BUILDING AND SAFETY DEPARTMENT.
- 22. TESTING PIPELINES PER LATEST EDITION GREEN BOOK, SECTION 306-1.4.
- 23. IN NO CASE SHALL THE SEWER SYSTEM BE ENTERED UNTIL ALL TESTING, CLEANING AND FINAL INSPECTION IS COMPLETED. NO FLUSHING WATER OR DEBRIS SHALL BE ALLOWED TO ENTER THE EXISTING SYSTEM.

Reviewed By:

Recommended for Approval By

GENERAL NOTES


- '. IT SHALL BE RESPONSIBILITY OF THE DEVELOPER/OWNER OR CONTRACTOR TO APPLY TO THE DIRECTOR OF PUBLIC WORKS, CITY OF BEAUMONT FOR AN ENCROACHMENT PERMIT FOR ALL WORK PERFORMED WITHIN PUBLIC RIGHT-OF-WAY.
- 2. IT SHALL BE THE RESPONSIBILITY OF THE CONTRACTOR TO INSTALL AND MAINTAIN ALL CONSTRUCTION, REGULATORY, GUIDE AND WARNING SIGNS WITHIN THE PROJECT LIMITS AND ITS SURROUNDESS AND TO PROVIDE SAFE PASSAGE FOR THE TRAVELING PUBLIC AND WORKERS UNTIL THE FINAL COMPLETION AND ACCEPTANCE.
- CONSTRUCTION PROJECTS THAT DISTURB MORE THAN ONE ACRE MUST OBTAIN A NATIONAL POLLUTANTS DISCHARGE ELIMINATION SYSTEM (NPDES) PERMIT. OWNER/DEVELOPERS ARE REQUIRED TO FILE A NOTICE OF INTENT (NOI) WITH THE STATE WATER RESOURCES CONTROL BOARD (SWRCB) AND COMPLY WITH ALL REQUIREMENTS OF THE BEAUMONT DRAINAGE MANAGEMENT PLAN.
- 4. ALL WORK SHALL CONFORM TO THE LATEST EDITION OF COUNTY OF RIVERSIDE TRANSPORTATION DEPARTMENT (RCTD) ROAD IMPROVEMENT STANDARDS AND SPECIFICATIONS, COUNTY ORDINANCE 461 AND SUBSEQUENT AMENDMENTS.
- 5. THE CONTRACTOR SHALL BE RESPONSIBLE FOR THE CLEARING OF THE PROPOSED WORK AREA AND RELOCATION COST OF ALL EXISTING UTILITIES. PERMITTEE MUST INFORM CITY OF CONSTRUCTION SCHEDULE AT LEAST 48 HOURS PRIOR TO BEGINNING OF CONSTRUCTION AT (951)
- 6. ALL EXISTING SURVEY MONUMENTS SHALL BE PROTECTED IN PLACE OR RELOCATED BY A LICENSE PROFESSIONAL LAND SURVEYOR PRIOR TO CONSTRUCTION COMPLETION.
- TRENCHING FOR UTILITIES AND STRUCTURES IS NOT ALLOWED UNTIL SOIL COMPACTION REPORT IS SUBMITTED TO AND APPROVED BY THE PUBLIC WORKS DEPARTMENT. PRELIMINARY GEOTECHNICAL INVESTIGATION REPORT NO. 1301-06.2-B-1, DATED MARCH 11, 2015, PREPARED BY ADVANCED GEOTECHNICAL SOLUTIONS, INC. SHALL BE AVAILABLE UPON REQUEST.
- 8. ALL UNDERGROUND FACILITIES WITH LATERALS, SHALL BE IN PLACE PRIOR TO PAVING THE STREET, INCLUDING, BUT NOT LIMITED TO, THE FOLLOWING; SEWER, WATER, GAS, ELECTRIC, STORM DRAINS
- 9. ALL MANHOLES, SURVEY MARKERS AND VALVES SHALL BE ADJUSTED TO GRADE BY THE CONTRACTOR AFTER COMPLETION OF THE OVERLAY.
- 10. ASPHALTIC EMULSION (FOG SEAL) SHALL BE APPLIED NOT LESS THAN FOURTEEN DAYS FOLLOWING PLACEMENT OF THE ASPHALT SURFACING. SEAL AND PAINT BINDER SHALL BE APPLIED AT A RATE OF 0.05 AND 0.03 GALLON PER SQUARE YARD RESPECTIVELY. ASPHALTIC EMULSION SHALL CONFORM TO SECTION# 37, #39, AND #94 OF THE STATE STANDARD SPECIFICATION.
- 11. DURING PAVING OPERATION, TRAFFIC CONTROL SHALL BE PERFORMED AS REQUIRED BY THE CITY
- 12. DEVELOPER SHALL BE FULLY RESPONSIBLE IN ASSURING THAT PROPOSED IMPROVEMENTS
 CONFORM TO THE APPROVED PLAN, SPECIFICATIONS AND THE CITY OF BEAUMONT STANDARDS,
 WHEREOUT THE CITY, DEVELOPER SHALL PROPOSED CORRECTIVE MEASURES FOR REVIEW AND
- 13. THE CONTRACTOR SHALL BEAR ALL COST FOR THE CORRECTION OR REMOVAL AND REPLACEMENT OF DEFECTIVE WORK, AND ALL ADDITIONAL DIRECT OR INDIRECT COSTS THE CITY MAY INCUR ON ACCOUNT OF DEFECTIVE WORK, INCLUDING THE COSTS OF ADDITIONAL ADMINISTRATIVE, PROFESSIONAL, CONSULTANT, INSPECTION, TESTING AND OTHER SERVICES.
- 14. THE CITY RESERVE THE RIGHTS TO REQUIRED REVISION OF THE APPROVED PLANS TO CONFORM WITH CURRENT STANDARDS AND TO POST A NEW BOND IF CONSTRUCTION HAS NOT COMMENCED WITHIN TWO YEARS AFTER PLANTS WERE APPROVED.

CONSTRUCTION NOTES AND ESTIMATED QUANTITIES

(5) INSTALL 60" DIA. MANHOLE WITH PVC LINER

PER R.C.T.D. STD. 606 AND 608.

<u>ITEM</u>	<u>QTY. </u>
1) INSTALL 8" PVC SEWER MAIN.	3,257 L.F.
(2) INSTALL PRECAST 4' CONCRETE MANHOLE W/ CAST IRON MANHOLE COVER PER R.C.T.D. STD. 606.	21 EA.
③ INSTALL 4" PVC SEWER LATERAL PER R.C.T.D. SEWER HOUSE CONNECTION STD. NO. 600 (A=5') WITH C.O. PER STD. 603.	94 EA.
(4) INSTALL 4" BACKFLOW PREVENTION DEVICE AMERICAN FOUNDARY'S NH53-A OR EQUAL).	30 EA.

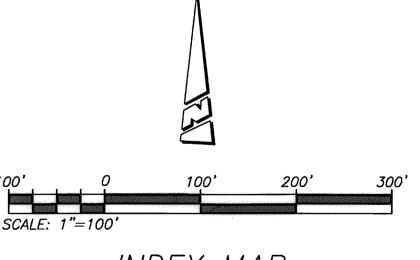

1 EA.


INDEX MAP

INDEX OF SHEETS:

SHEET 1 - TITLE SHEET-INDEX MAP-VICINITY MAP-GENERAL NOTES SHEET 2 - DEVELOPER/BUILDER KEY MAP - TYPICAL SECTION SHEET 3 - LEXI LANE STA 10+05.91 TO STA 16+59.86 SHEET 4 - DYLAN COURT STA 10+01.14 TO STA 14+27.02

WALKER COURT STA 10+06.00 TO STA 12+60.87 SHEET 5 - MICHELLE LANE STA 9+82.70 TO STA 19+50.00 SHEET 6 - MICHELLE LANE STA 19+50.00 TO STA 21+94.77

SHEET 7 - TREVOR WAY STA 10+83.00 TO STA 14+83.57 SHEET 8 - WIE COURT STA 9+82.70 TO STA 13+47.14

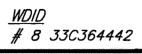

CITY OF BEAUMONT, CALIFORNIA

SEWER IMPROVEMENT PLANS TRACT NO. 36558

TITLE SHEET - INDEX MAP VICINITY MAP - GENERAL NOTES

OF **8** SHEETS DRAWING NAME:

SHEE

ARGENT MANAGEMENT

AT LEAST TWO DAYS BEFORE YOU DIG UNDERGROUND SERVICE ALERT OF SOUTHERN CALIFORNIA | BEARING: N 27°39'52" E

BASIS OF BEARINGS: DESCRIPTION: THE BASIS OF COORDINATES FOR THIS MAP IS THE CALIFORNIA STATE PLANE COORDINATE SYSTEM. 1983, ZONE 6, BASED LOCALLY ON CONTROL STATIONS "REST" AND "RABBIT".

BENCHMARK: DESCRIPTION: USGS MONUMENT "REST" BENCHMARK DISK SET IN TOP OF CONCRETE MONUMENT STAMPED "REST 1972" ON DESERT LAWN DRIVE ACROSS THE DRIVE FROM DESERT LAWN CEMETERY 25.3 FT. N.E. OF THE DRIVE CENTERLINE 24.9 FT. S.W. OF THE S.W. EDGE OF THE SOUTH EASTBOUND LANES OF INTERSTATE HIGHWAY 10 ELEV. 2491.44, NGVD 29

PROACTIVE ENGINEERING CONSULTANTS WEST. INC. 25109 JEFFERSON AVE. SUITE 200 MURRIETA, CA 92562 951-200-6840 PROACTIVE ENGINEERING WEST BY MARK DESCRIPTION 06/17/16 GEORGE ALAN LENFESTEY
R.C.E. 45920 EXP. 12-31-2016 REVISIONS CITY



PEC CHECKED BY: PEC SCALE: AS NOTED 06/17/16 OB NUMBER:


06.002.000

City of Beaumont, Public Works Department Engineering Division

Date: ____

Date: 4/21/16

Plotted: Jun 17, 2016 - 3:37pm By: mikehanna DWG: Z:\01.104.000 FC-PA14\Drawings\Sewer Improvements\36558-SHT-01.dwg

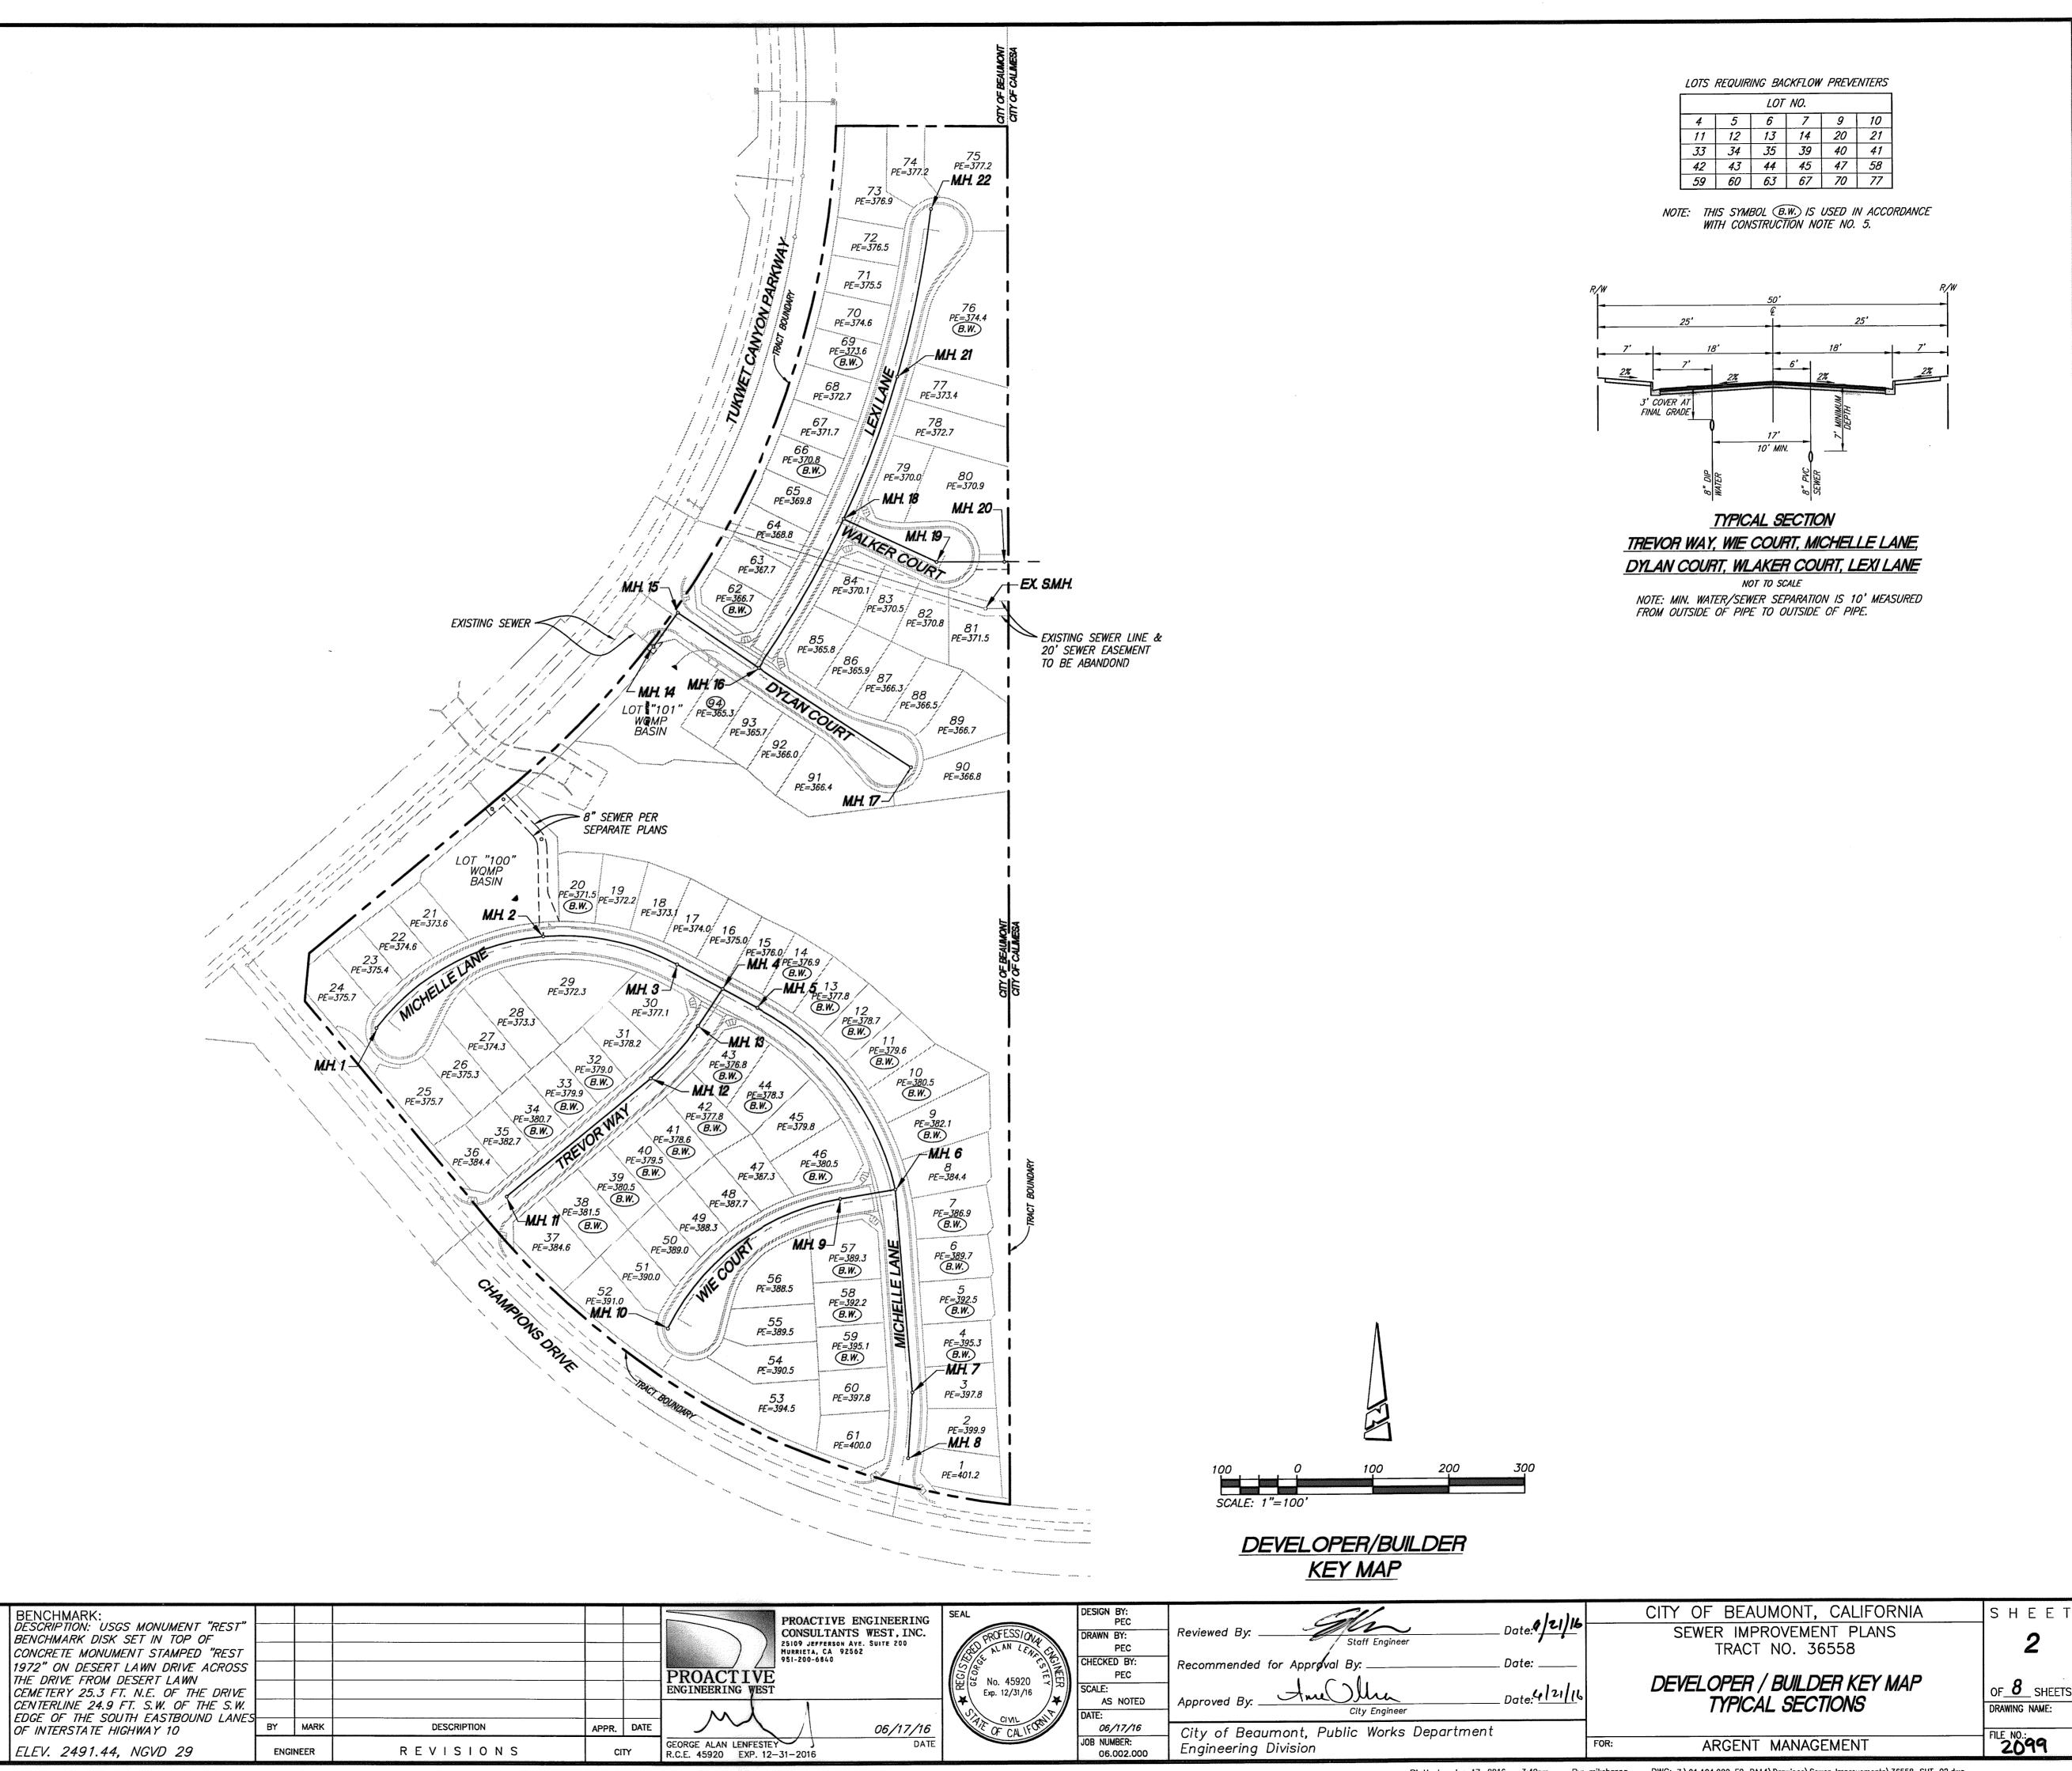

THE PRIVATE ENGINEER SIGNING THESE PLANS IS RESPONSIBLE FOR ASSURING THE ACCURACY AND ACCEPTABILITY OF THE

APPROVAL OR DURING CONSTRUCTION, THE

PRIVATE ENGINEER SHALL BE RESPONSIBLE FOR DETERMINING AN ACCEPTABLE SOLUTION AND REVISING THE PLANS FOR APPROVAL

WORK CONTAINED WITHIN THESE PLANS SHALL

AT LEAST TWO DAYS
BEFORE YOU DIG

UNDERGROUND SERVICE ALERT OF SOUTHERN CALIFORNIA | BEARING: N 27'39'52" E

BASIS OF BEARINGS:

THE BASIS OF COORDINATES FOR

CONTROL STATIONS "REST" AND

STATE PLANE COORDINATE SYSTEM,

1983, ZONE 6, BASED LOCALLY ON

THIS MAP IS THE CALIFORNIA

DESCRIPTION:

"RABBIT".


NOT COMMENCE UNTIL AN ENCROACHMENT PERMIT AND/OR A GRADING PERMIT HAS


DESIGN HEREON. IN THE EVENT OF DISCREPANCIES ARISING AFTER CITY

BY THE CITY.

BEEN ISSUÉD.

Plotted: Jun 17, 2016 - 3:40pm By: mikehanna DWG: Z:\01.104.000 FC-PA14\Drawings\Sewer Improvements\36558-SHT-02.dwg

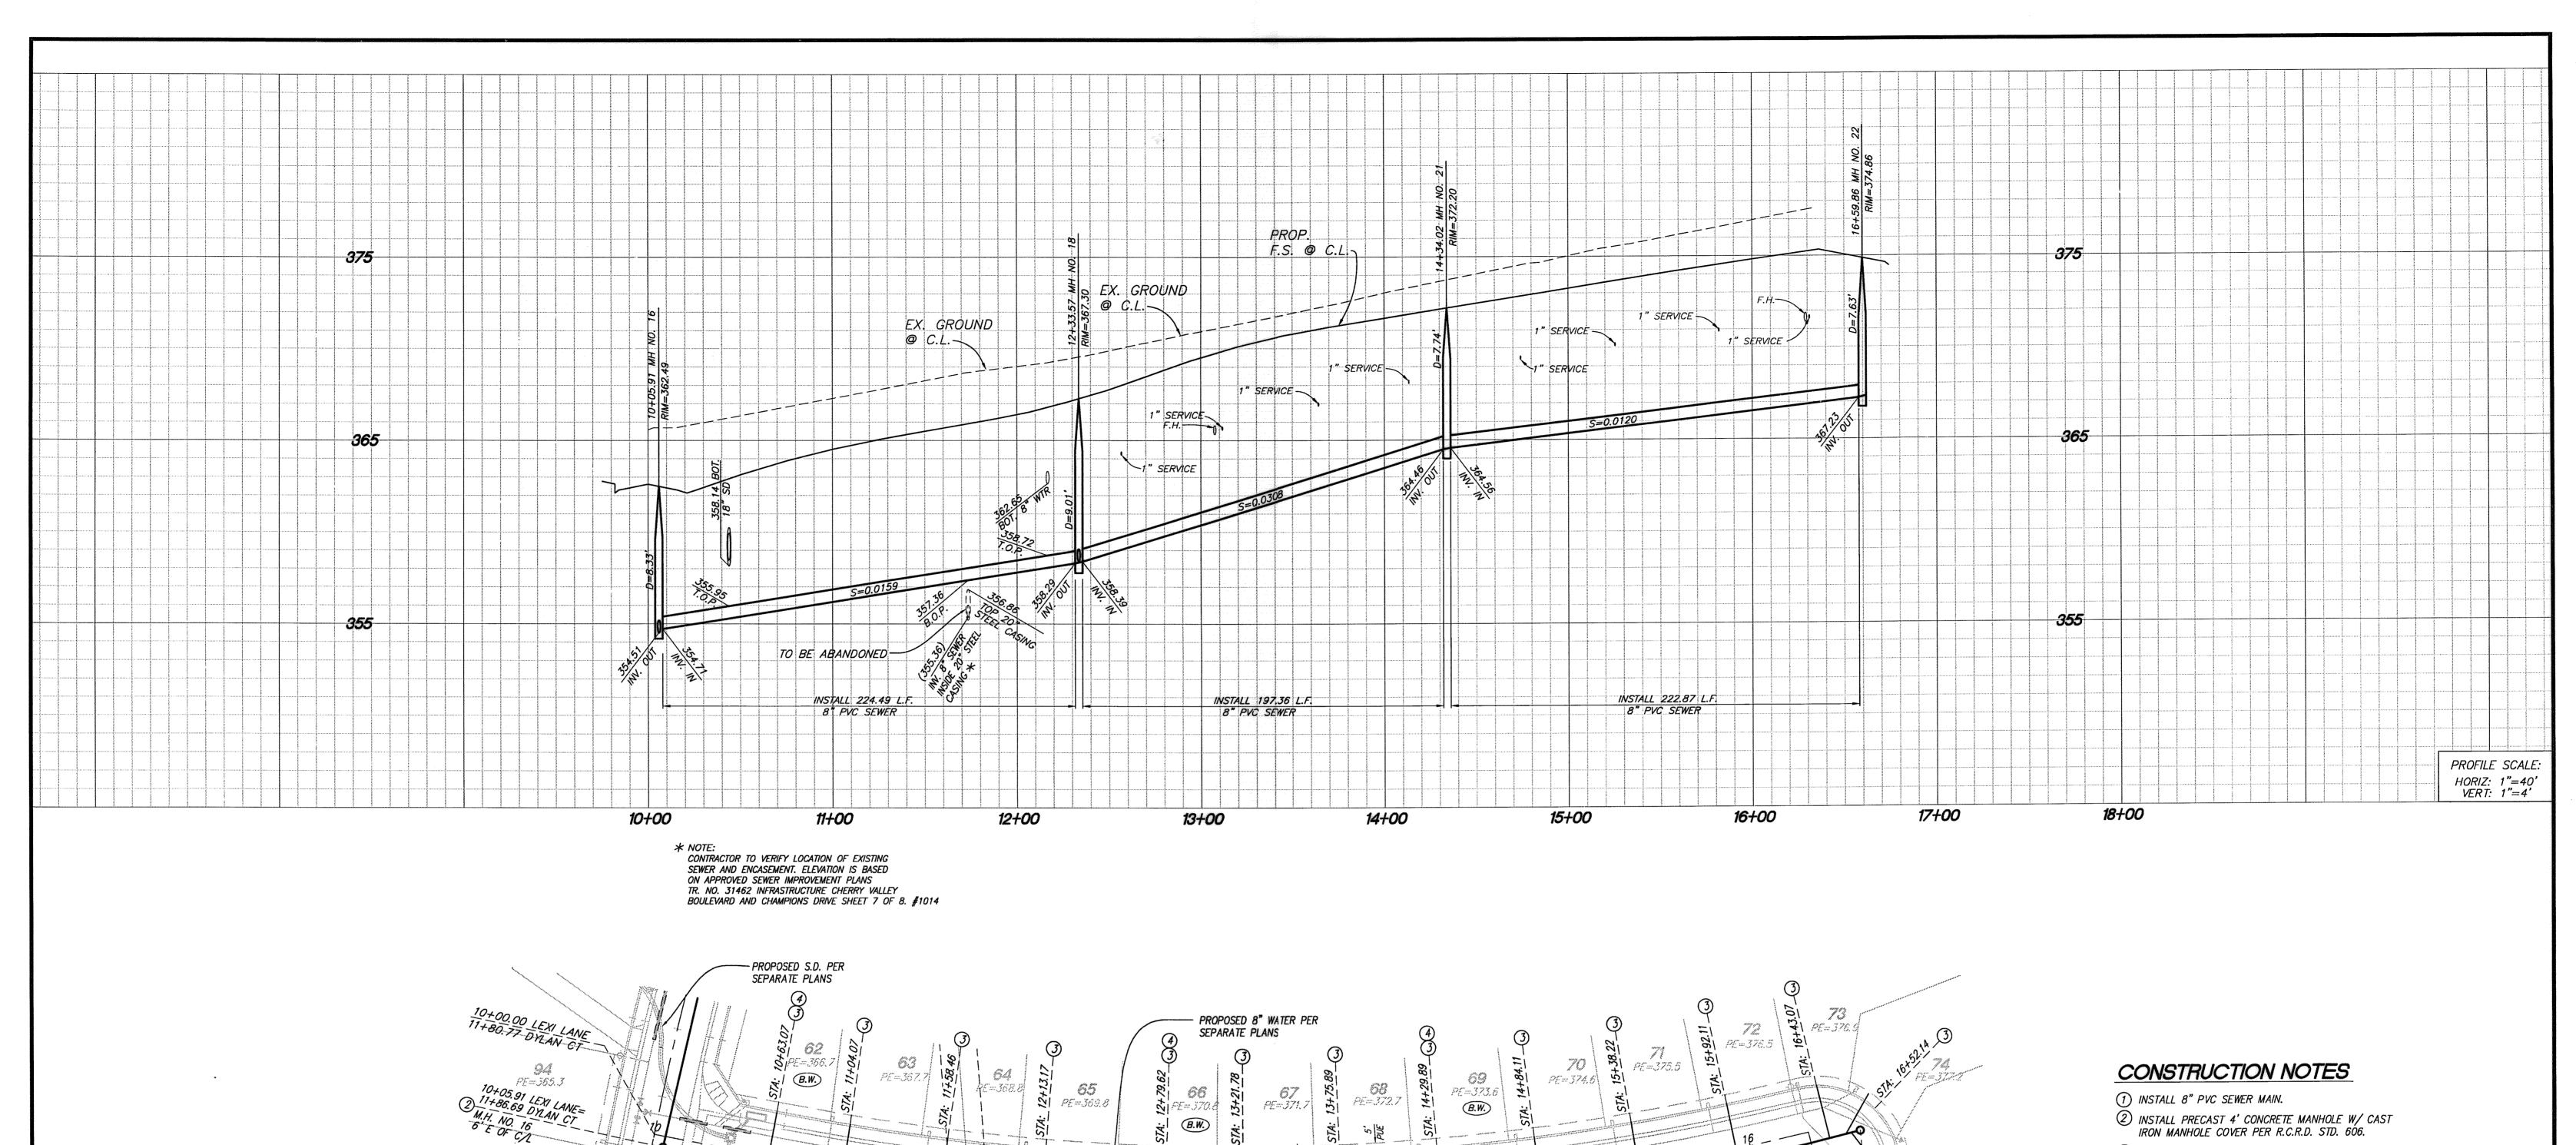


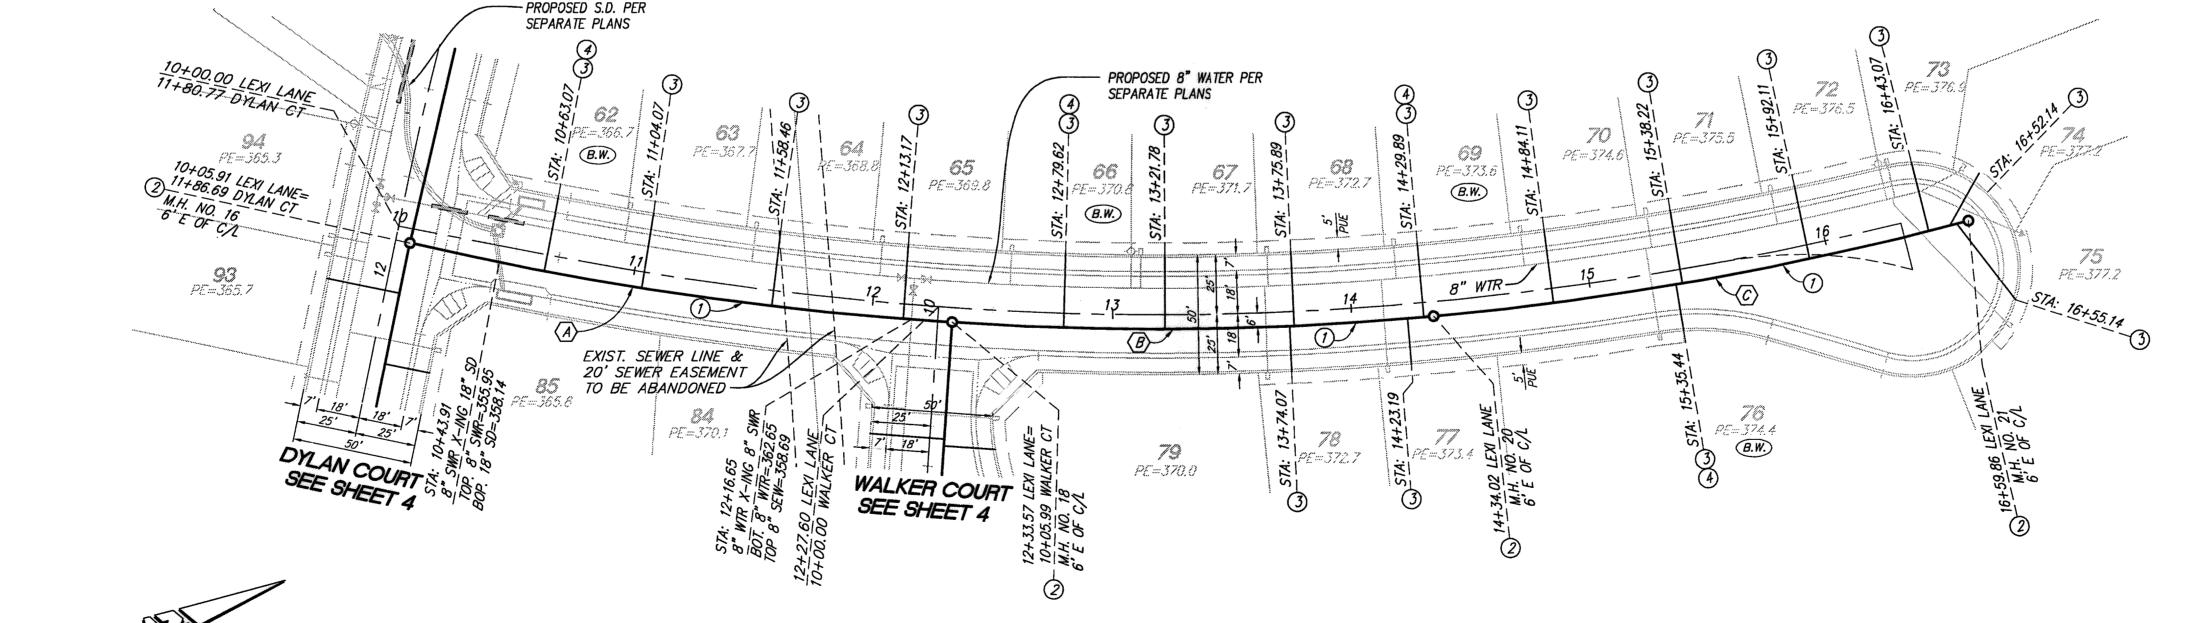

- (3) INSTALL 4" PVC SEWER LATERAL PER COUNTY OF RIVERSIDE SEWER HOUSE CONNECTION STD. NO. 600 (A=5')
- (4) INSTALL 4" BACKFLOW PREVENTION DEVICE AMERICAN FOUNDARY'S NH53-A OR EQUAL).


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NOTE:
WORK CONTAINED WITHIN THESE PLANS SHALL
NOT COMMENCE UNTIL AN ENCROACHMENT
PERMIT AND/OR A GRADING PERMIT HAS BEEN ISSUÉD.

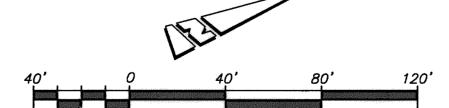

LEXI LANE

	<u>-</u>	PIPE DATA		
NO.	BEARING/DELTA	RADIUS	<i>LENGTH</i>	TANGENT
$\langle A \rangle$	9*52'49"	1325.00'	228.49'	114.53'
$\langle B \rangle$	8*42'26"	1325.00'	201.36	100.87*
$\langle \overline{c} \rangle$	9*48'38"	1325.00'	226.87'	113.71'

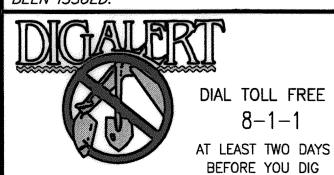


UNDERGROUND SERVICE ALERT OF SOUTHERN CALIFORNIA | BEARING: N 27°39'52" E

BASIS OF BEARINGS: DESCRIPTION: THE BASIS OF COORDINATES FOR THIS MAP IS THE CALIFORNIA STATE PLANE COORDINATE SYSTEM, 1983, ZONE 6, BASED LOCALLY ON CONTROL STATIONS "REST" AND "RABBIT".

BENCHMARK: DESCRIPTION: BENCHMARK D CONCRETE MOI 1972" ON DESI THE DRIVE FRO CEMETERY 25. CENTERLINE 2 EDGE OF THE OF INTERSTATE ELEV. 2491.

K: : USGS MONUMENT "REST" DISK SET IN TOP OF ONUMENT STAMPED "REST SERT LAWN DRIVE ACROSS ROM DESERT LAWN 5.3 FT. N.E. OF THE DRIVE						PROACTIVE ENGINEERING CONSULTANTS WEST, INC 25109 JEFFERSON AVE. SUITE 200 MURRIETA, CA 92562 951-200-6840 PROACTIVE ENGINEERING WEST
24.9 FT. S.W. OF THE S.W. E SOUTH EASTBOUND LANES-						
TE HIGHWAY 10	BY	MARK	DESCRIPTION	APPR.	DATE	06/17/1
1.44, NGVD 29	ENGI	NEER	REVISIONS	cr	ľΥ	GEORGE ALAN LENFESTEY DA R.C.E. 45920 EXP. 12-31-2016

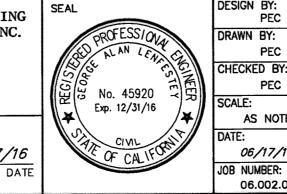

ESIGN BY: PEC	11/h	Date 4/21/11
RAWN BY: PEC	Reviewed By: Staff Engineer	. Date: L
HECKED BY: PEC	Recommended for Approval By:	Date:
CALE: AS NOTED	Approved By: Ima Illu	Date: 6/2/
ATE:	City Engineer	
06/17/16	City of Beaumont, Public Works Department	
OR MIMPER.		

Engineering Division

06.002.000

21/16	CITY	OF	В
61/12	S	EWE	-
: 			TR
12.111			i

BEAUMONT, CALIFORNIA IMPROVEMENT PLANS RACT NO. 36558


ARGENT MANAGEMENT


LEXI LANE STA: 10+05.91 TO STA: 16+59.86


OF______ SHEETS DRAWING NAME: 2099

SHEE

Plotted: Jun 17, 2016 - 3:42pm By: mikehanna DWG: Z:\01.104.000 FC-PA14\Drawings\Sewer Improvements\36558-SHT-03.dwg

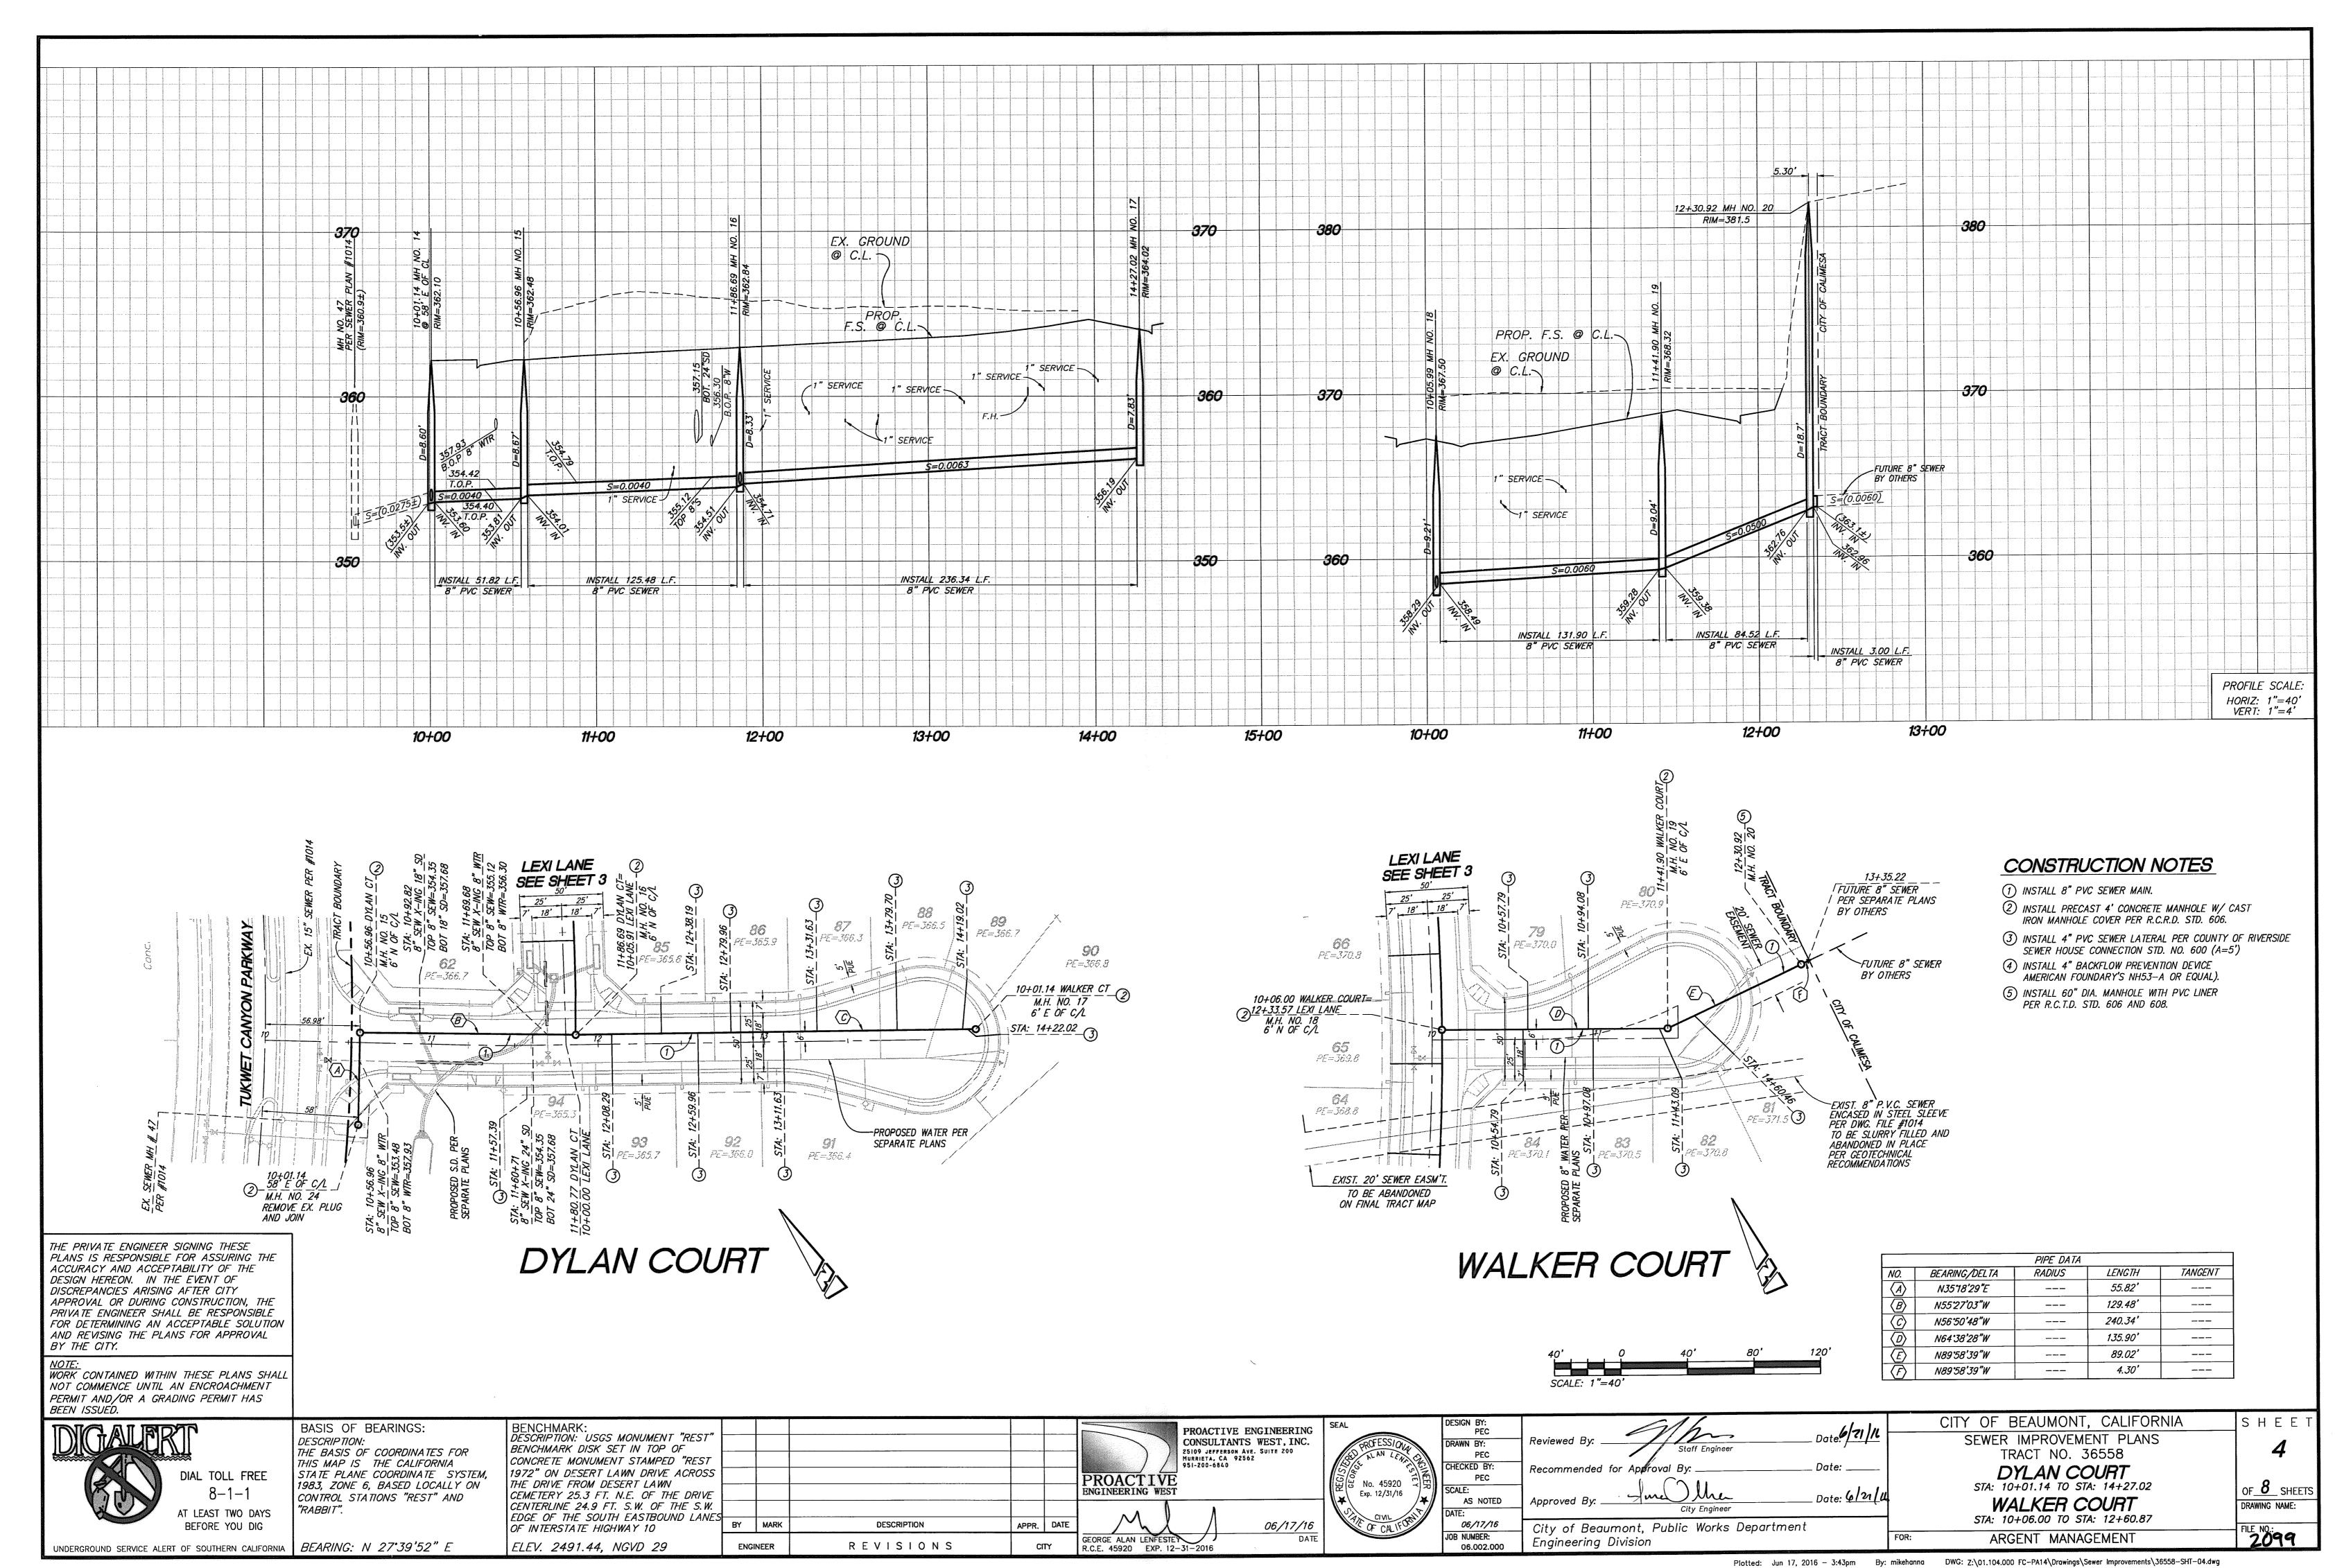

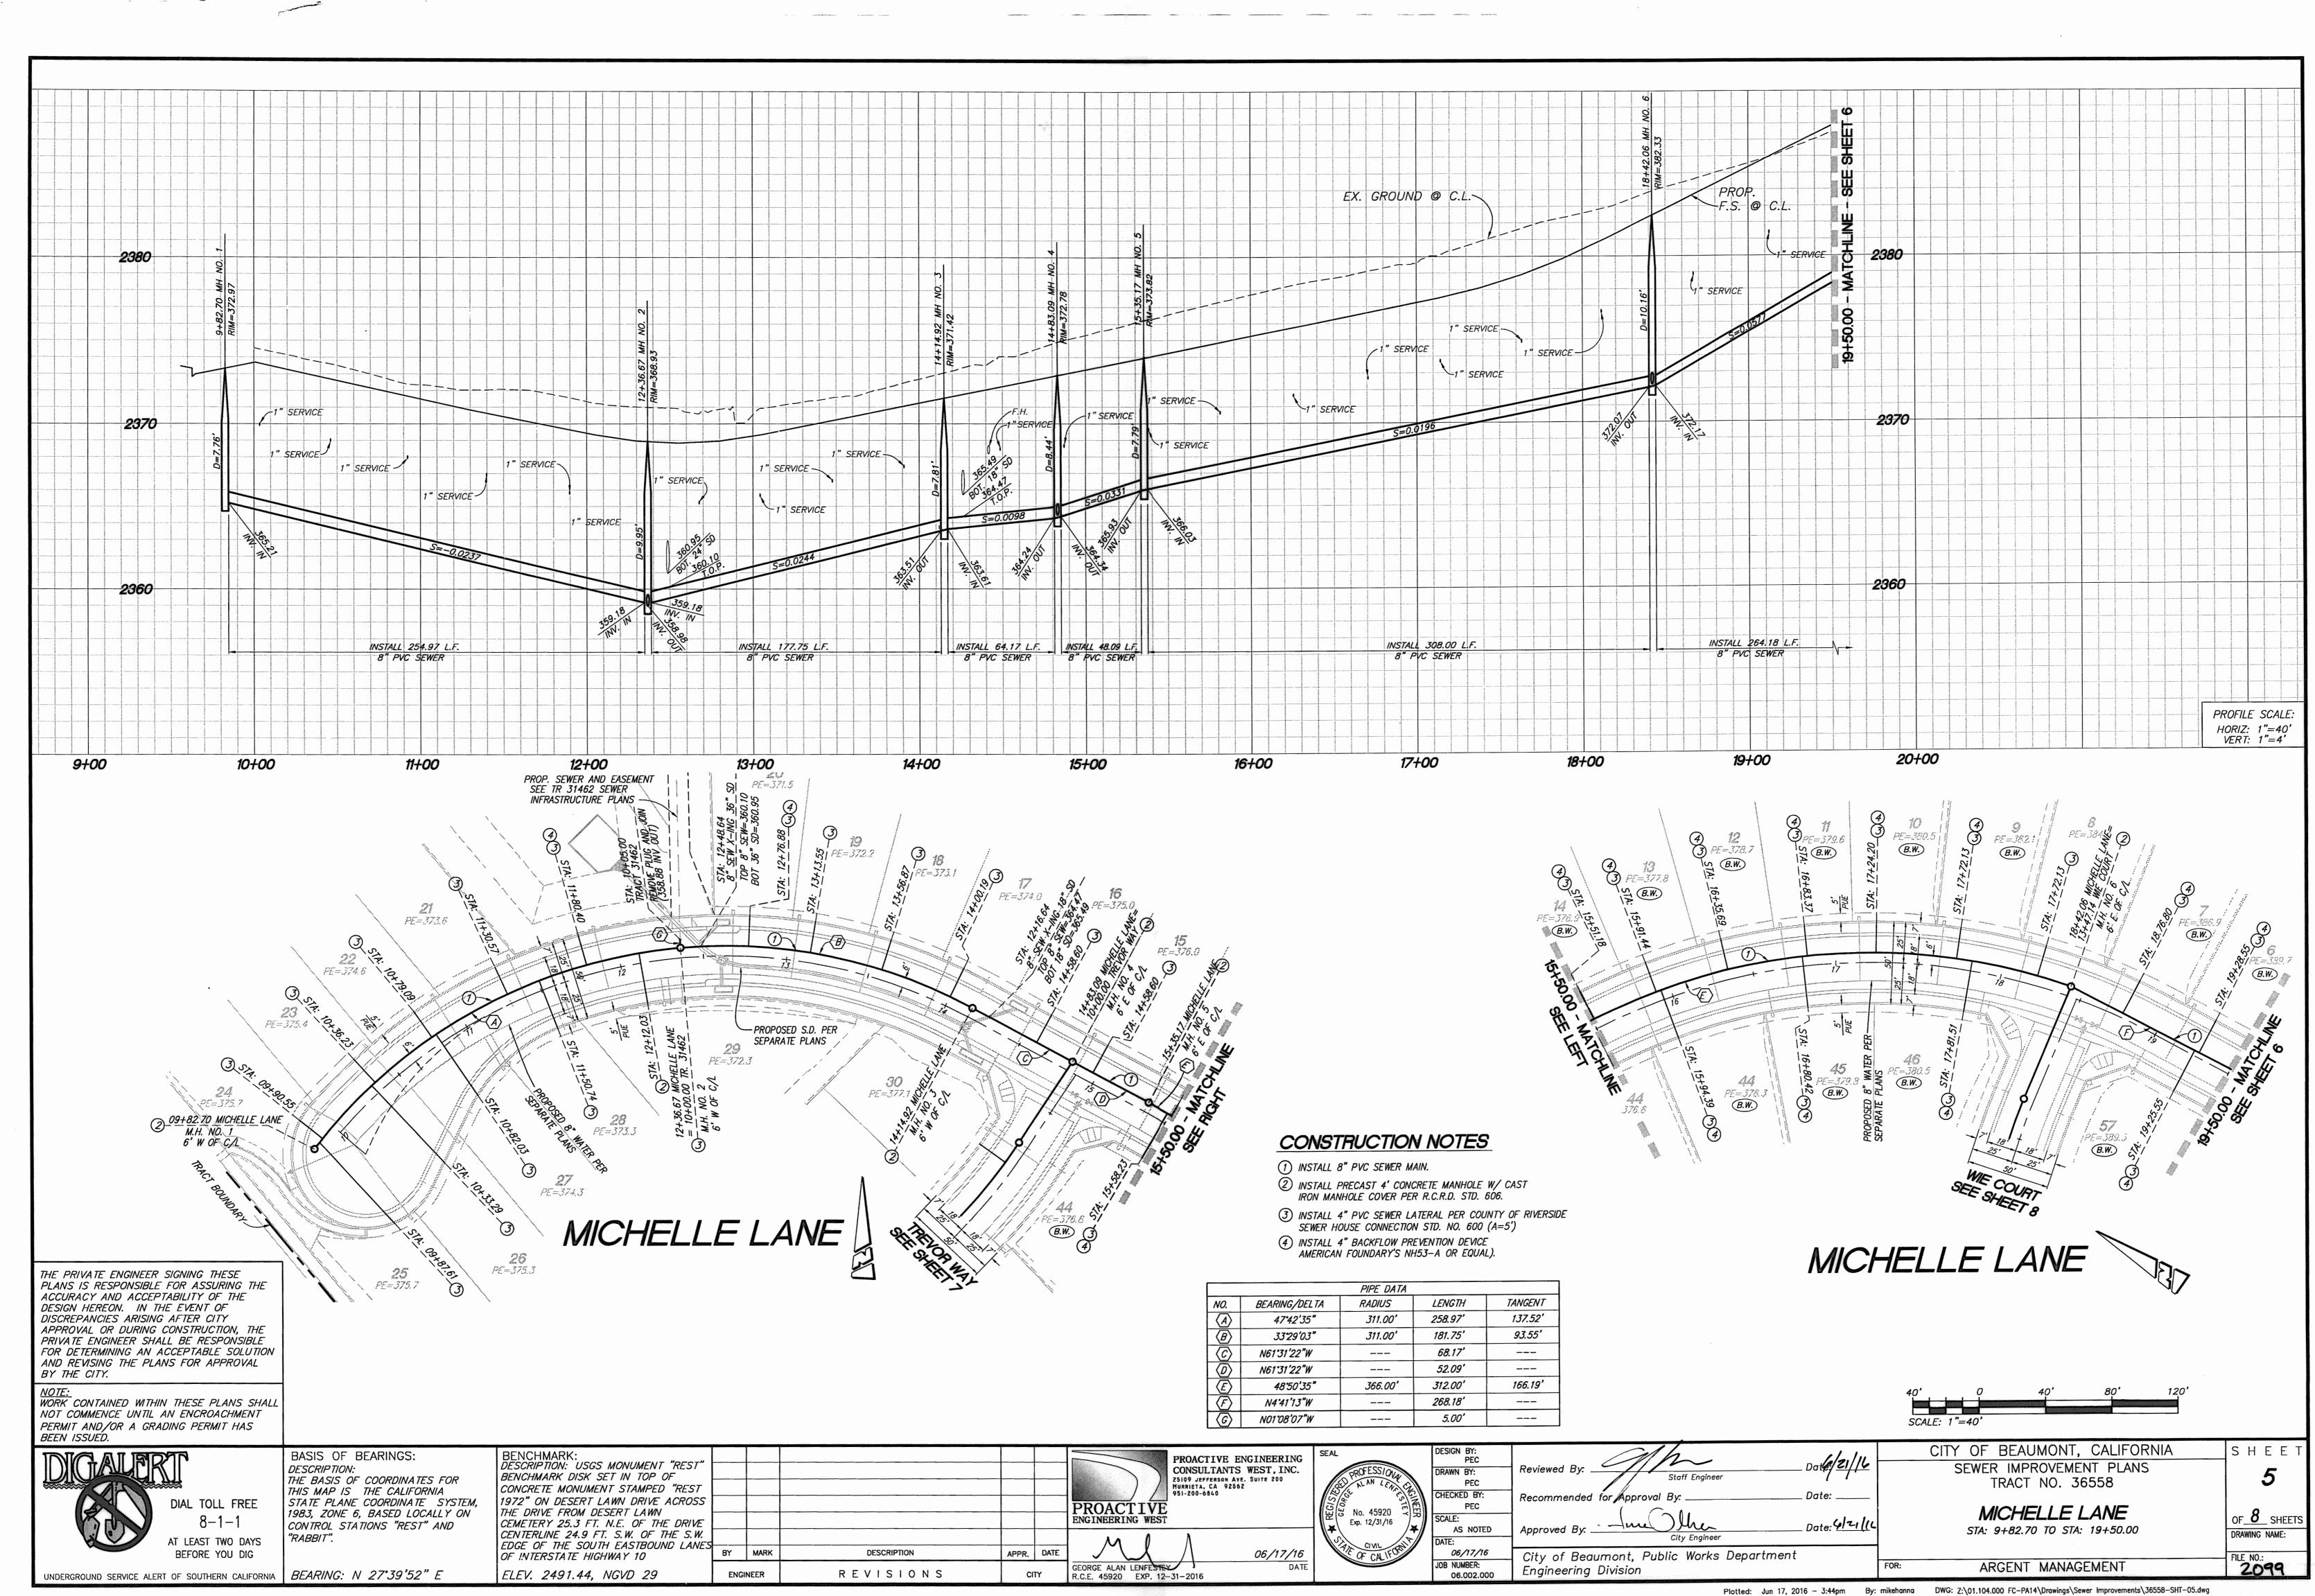

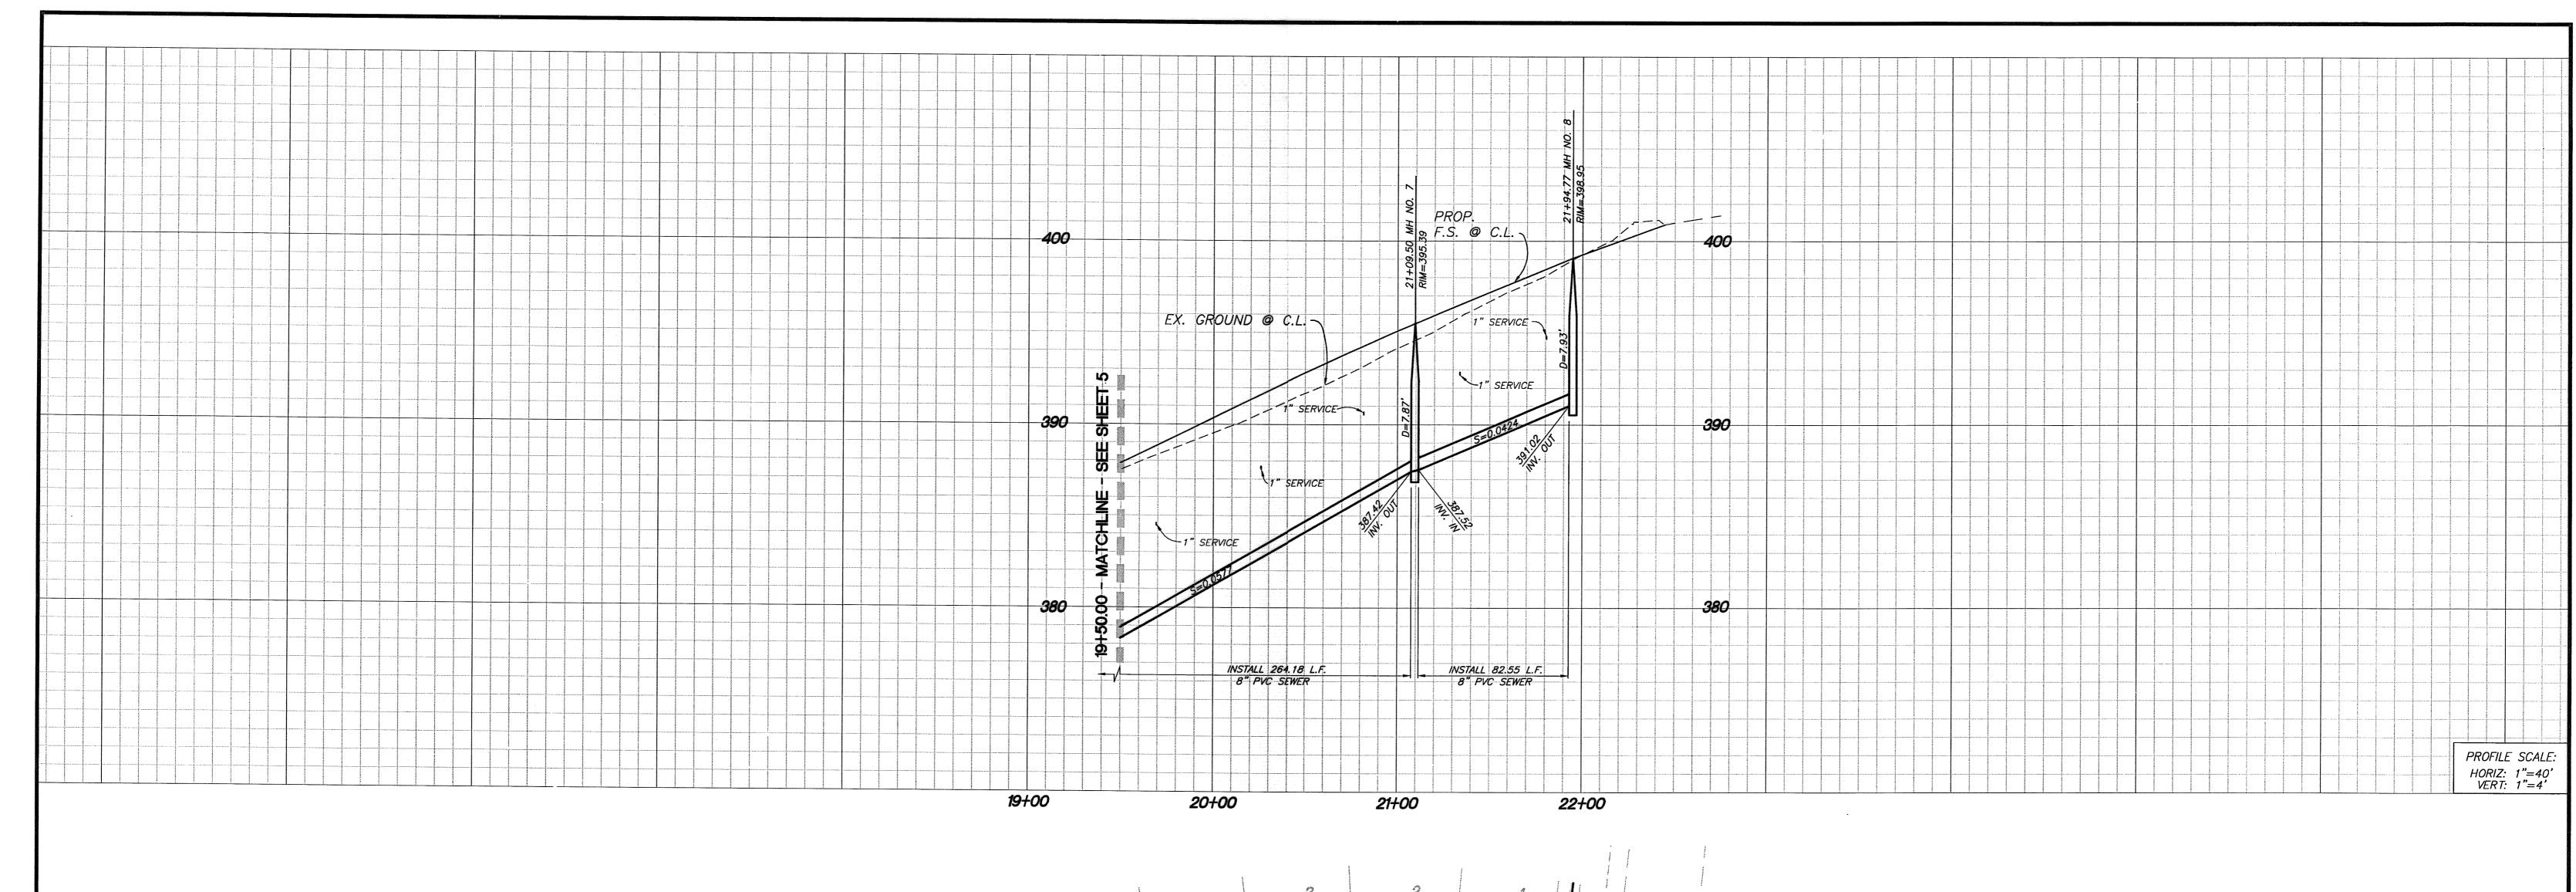

3 PE=399.9 **3**PE=401.2 4 5 3 FE=392.5 B.W. E B.W. MICHELLE LANE


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UNDERGROUND SERVICE ALERT OF SOUTHERN CALIFORNIA | BEARING: N 27°39'52" E

PIPE DATA BEARING/DELTA RADIUS LENGTH TANGENT N4*41'13"W 268.18' ___ ___ N3'46'12"E *86.55*′ ---~ + --

APPR. DATE




CONSTRUCTION NOTES

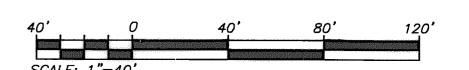(4) INSTALL 4" BACKFLOW PREVENTION DEVICE AMERICAN FOUNDARY'S NH53-A OR EQUAL).

② INSTALL PRECAST 4' CONCRETE MANHOLE W/ CAST IRON MANHOLE COVER PER R.C.R.D. STD. 606.

3) INSTALL 4" PVC SEWER LATERAL PER COUNTY OF RIVERSIDE SEWER HOUSE CONNECTION STD. NO. 600 (A=5')

1) INSTALL 8" PVC SEWER MAIN.

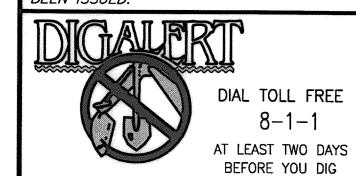



BASIS OF BEARINGS: DESCRIPTION: THE BASIS OF COORDINATES FOR THIS MAP IS THE CALIFORNIA STATE PLANE COORDINATE SYSTEM, 1983, ZONE 6, BASED LOCALLY ON CONTROL STATIONS "REST" AND "RABBIT".


ELEV. 2491.44, NG

BENCHMARK:	
DESCRIPTION: USGS MONUMENT "REST" BENCHMARK DISK SET IN TOP OF	
CONCRETE MONUMENT STAMPED "REST	
1972" ON DESERT LAWN DRIVE ACROSS	
THE DRIVE FROM DESERT LAWN	\vdash
CEMETERY 25.3 FT. N.E. OF THE DRIVE	
CENTERLINE 24.9 FT. S.W. OF THE S.W.	
EDGE OF THE SOUTH EASTBOUND LANES	⊢
OF INTERSTATE HIGHWAY 10	
FLFIL 2401 44 NOVO 20	

T IN TOP OF			
STAMPED "REST			
WN DRIVE ACROSS			
ERT LAWN			
I.E. OF THE DRIVE			
S.W. OF THE S.W.			
EASTBOUND LANES VAY 10	BY	MARK	DESCRIPTION
GVD 29	ENGI	NEER	REVISIONS

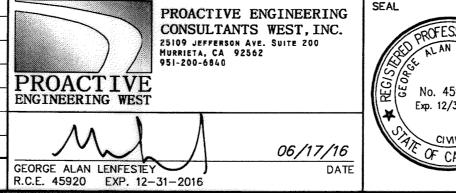

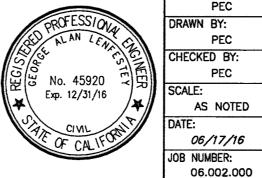

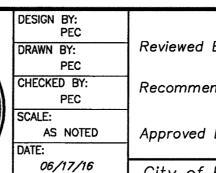

Engineering Division

	Date 4/21/14	
Reviewed By: Staff Engineer	. Date: Jelli	ĺ
Recommended for Approval By:	. Date:	
Approved By: City Engineer	Date: <u>६/२/१८</u>	
City of Beaumont, Public Works Department		Ļ

CITY OF BEAUMONT, CALIFORNIA	\
SEWER IMPROVEMENT PLANS	
TRACT NO. 36558	


MICHELLE LANE STA: 19+50.00 TO STA: 21+94.77 TUKWET CONNECTION STA: 10+00.00 TO STA: 12+20.74


7099 ARGENT MANAGEMENT

SHEE

OF_8 SHEETS

DRAWING NAME:

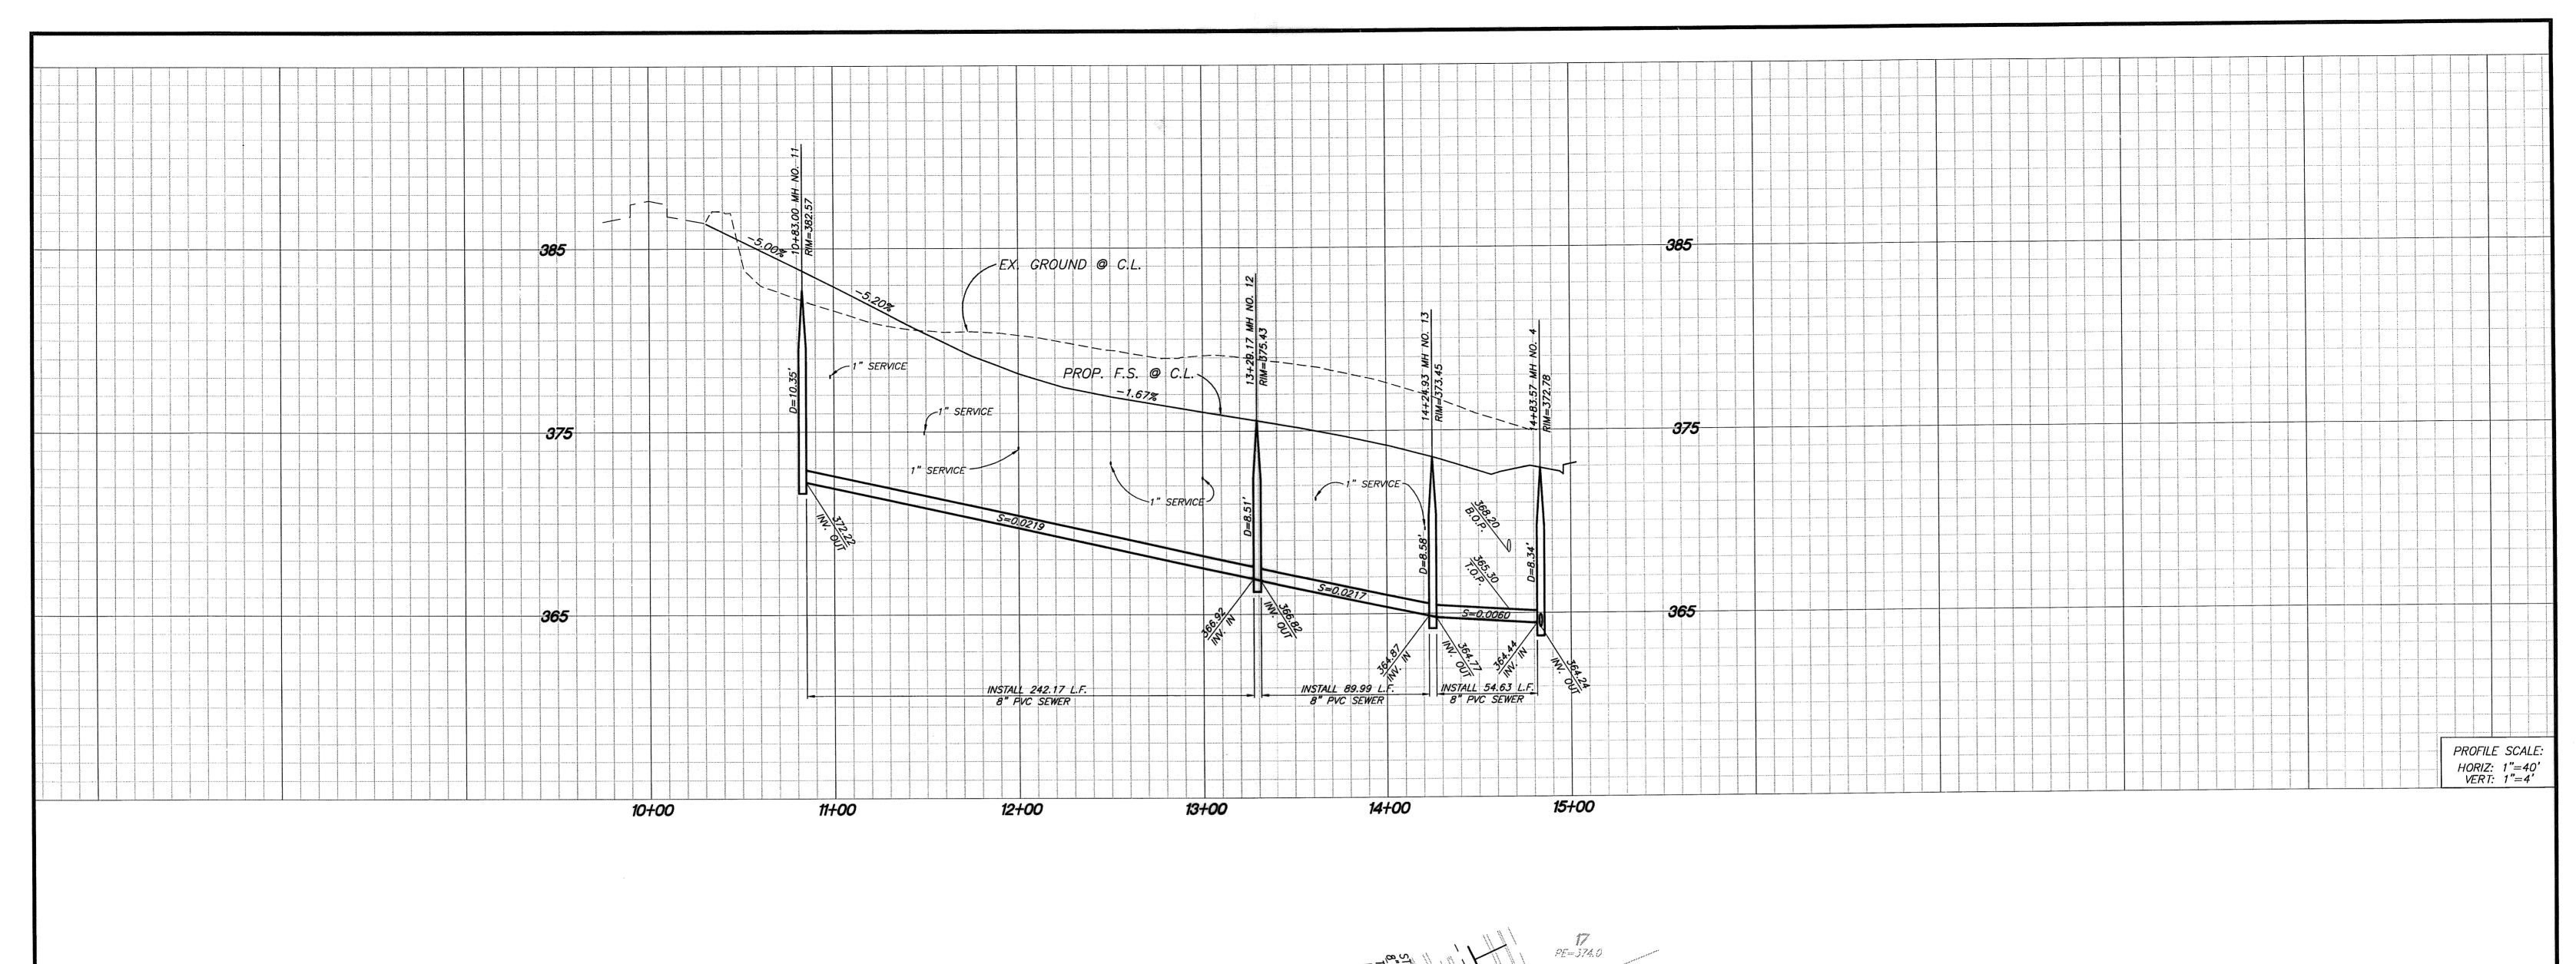

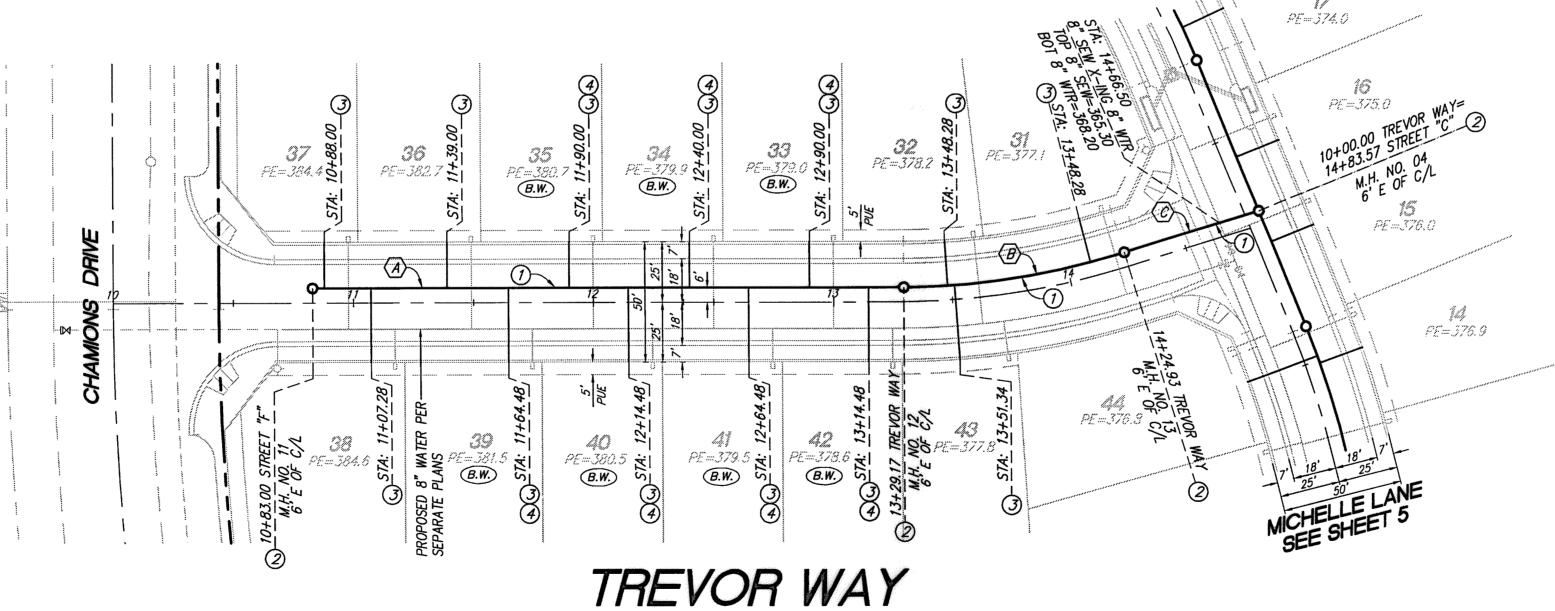

PROACTIVE ENGINEERING


06/17/16

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<u>NOTE:</u> WORK CONTAINED WITHIN THESE PLANS SHALL NOT COMMENCE UNTIL AN ENCROACHMENT PERMIT AND/OR A GRADING PERMIT HAS BEEN ISSUED.

BY THE CITY.

PIPE DATA TANGENT RADIUS *LENGTH* BEARING/DELTA 246.17° N50°21'35°E ___ 47.34 93.99 *319.00*′ 16*"52'57" 58.63* ' ___ N33°28'38"E ___

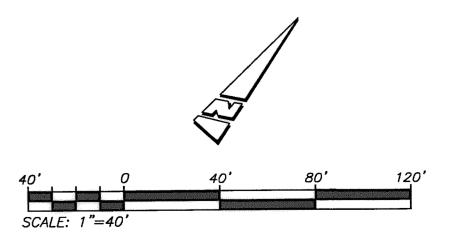

CONSTRUCTION NOTES

(4) INSTALL 4" BACKFLOW PREVENTION DEVICE AMERICAN FOUNDARY'S NH53—A OR EQUAL).

② INSTALL PRECAST 4' CONCRETE MANHOLE W/ CAST IRON MANHOLE COVER PER R.C.R.D. STD. 606.

(3) INSTALL 4" PVC SEWER LATERAL PER COUNTY OF RIVERSIDE SEWER HOUSE CONNECTION STD. NO. 600 (A=5')

1) INSTALL 8" PVC SEWER MAIN.

DESIGN BY:

TREVOR WAY STA: 10+83.00 TO STA: 14+83.57

ARGENT MANAGEMENT

CITY OF BEAUMONT, CALIFORNIA

SEWER IMPROVEMENT PLANS

TRACT NO. 36558

SHEE

OF_**8**_ SHEETS

FILE NO.: 2699

DRAWING NAME:


BEFORE YOU DIG

BASIS OF BEARINGS: DESCRIPTION: THE BASIS OF COORDINATES FOR THIS MAP IS THE CALIFORNIA STATE PLANE COORDINATE SYSTEM, 1983, ZONE 6, BASED LOCALLY ON CONTROL STATIONS "REST" AND "RABBIT".

UNDERGROUND SERVICE ALERT OF SOUTHERN CALIFORNIA | BEARING: N 27°39'52" E

NCHMARK: SCRIPTION: USGS MONUMENT "REST" NCHMARK DISK SET IN TOP OF NCRETE MONUMENT STAMPED "REST 72" ON DESERT LAWN DRIVE ACROSS TORIVE FROM DESERT LAWN METERY 25.3 FT. N.E. OF THE DRIVE						PROACTIVE ENGINEERING CONSULTANTS WEST, INC 25109 JEFFFRSON AVE. SUITE 200 MURRIETA, CA 92562 951-200-6840 PROACTIVE ENGINEERING WEST
ENTERLINE 24.9 FT. S.W. OF THE S.W. DGE OF THE SOUTH EASTBOUND LANES F INTERSTATE HIGHWAY 10	BY	MARK	DESCRIPTION	APPR.	DATE	06/17/1
TLEV. 2491.44, NGVD 29	ENGI	NEER	REVISIONS	Cl	ΤΥ	GEORGE ALAN LENFESTE DA R.C.E. 45920 EXP. 12-31-2016

PROFESSIONAL PROFE	DRAWN BY: PEC	Reviewed By: Staff Engineer	. Date:4/21//6	
3 No. 45920 EVEN		Recommended for Approval By:	. Date:	
Exp. 12/31/16	SCALE:	Approved By: City Engineer	Date: 4 21/1	-
OF CALIFORNIA	06/17/16 JOB NUMBER:	City of Beaumont, Public Works Department Engineering Division		_

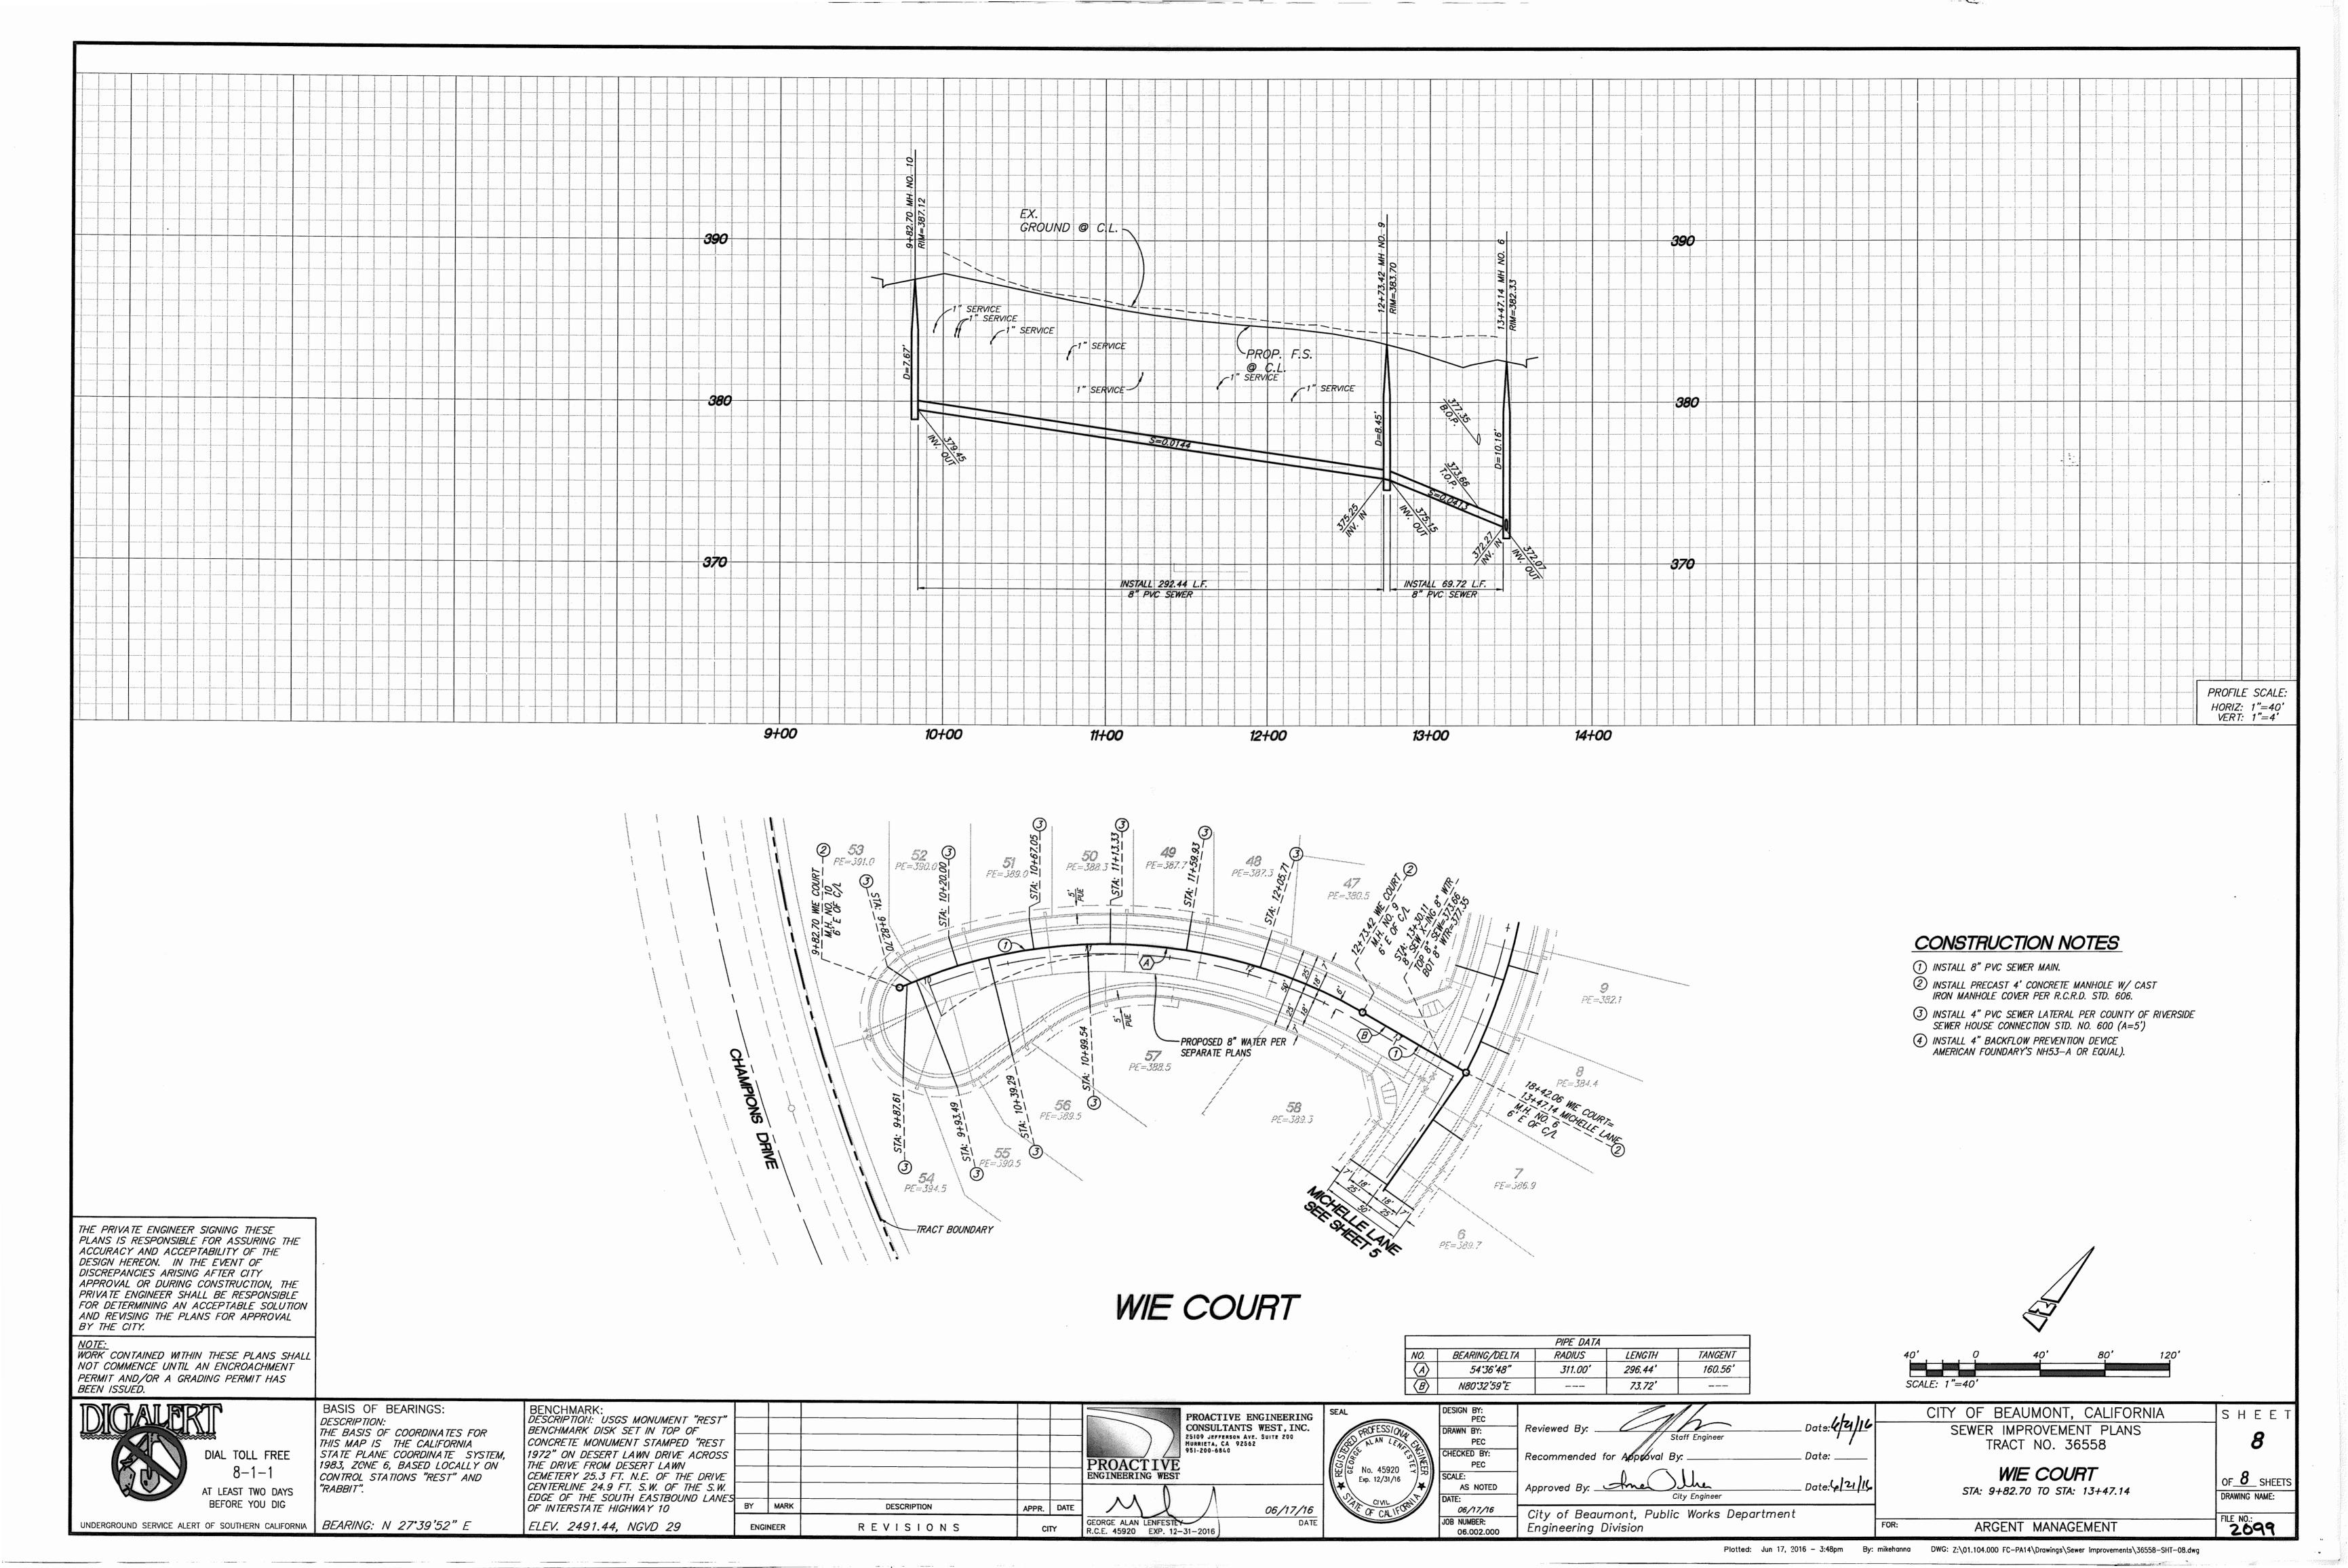


3570 9/02/L/6 153M034:45 SHEETS SCALE: 1"=40' 1"=4' FILE NO: 94 DRAWING NAME: INSTALL 4" PVC SEWER LATERAL PER COUNTY OF RIVERSIDE SEWER HOUSE CONNECTION STD. NO. 600 (A=5') ш φ SH PROFILE P HORIZ: VERT: INSTALL PRECAST 4' CONCRETE MANHOLE W/ CAST IRON MANHOLE COVER PER R.C.R.D. STD. 606. DWG: Z:\01.104.000 FC-PA14\Drawings\Sewer Improvements\36558-SHT-04.dwg **TANGENT** INSTALL 4" BACKFLOW PREVENTON DEVICE AMERICAN FOUNDARY'S NH53-A OR EQUAL). (5) INSTALL 60" DIA. MANHOLE WITH PVC LINER PER R.C.T.D. STD. 606 AND 608. CONSTRUCTION NOTES CALIFORNIA MENT PLANS 36558 WALKER COURT 10+06.00 TO STA: 12+60.87 DYLAN COURT 10+01.14 TO STA: 14+27.02 (1) INSTALL B" PVC SEWER MAIN.
(2) INSTALL PRECAST 4' CONCRE 4.30 LENGTH 129.48 240.34° 135.90° 89.02 55.82' ARGENT MANAGEMENT SEWER IMPROVEMENT TRACT NO. 3655 OF BEAUMONT, PIPE DAT **(4)** (0) STA: STA: W89:58'39"W W89:58'39"W BEARING/DELT N64.38,28"W N5527'03"W N56.50,48"W 960 是 0 LED AND 13+00 -FUTURE 8" SEWER BY OTHERS T3+35.22 FUTURE 8" SEWER PER SEPARATE PLA BY OTHERS FOR S -EXIST. 8" P. V.C.
ENCASED IN STEI PER DWG. FILE # TO BE SLURRY F ABANDONED IN F PER GEOTECHNIC RECOMMENDATION Date: 6/21/4 Dote 6/21/11 Date: Department 84 × 50 TRACT BOUNDARY. 20' SEWER EASEMENT 12+00 Plotted: PVC SEW Works Staff Engineer INSTALI 0 \bigcirc 2/2 30 3 .9

Jun 17, 2016


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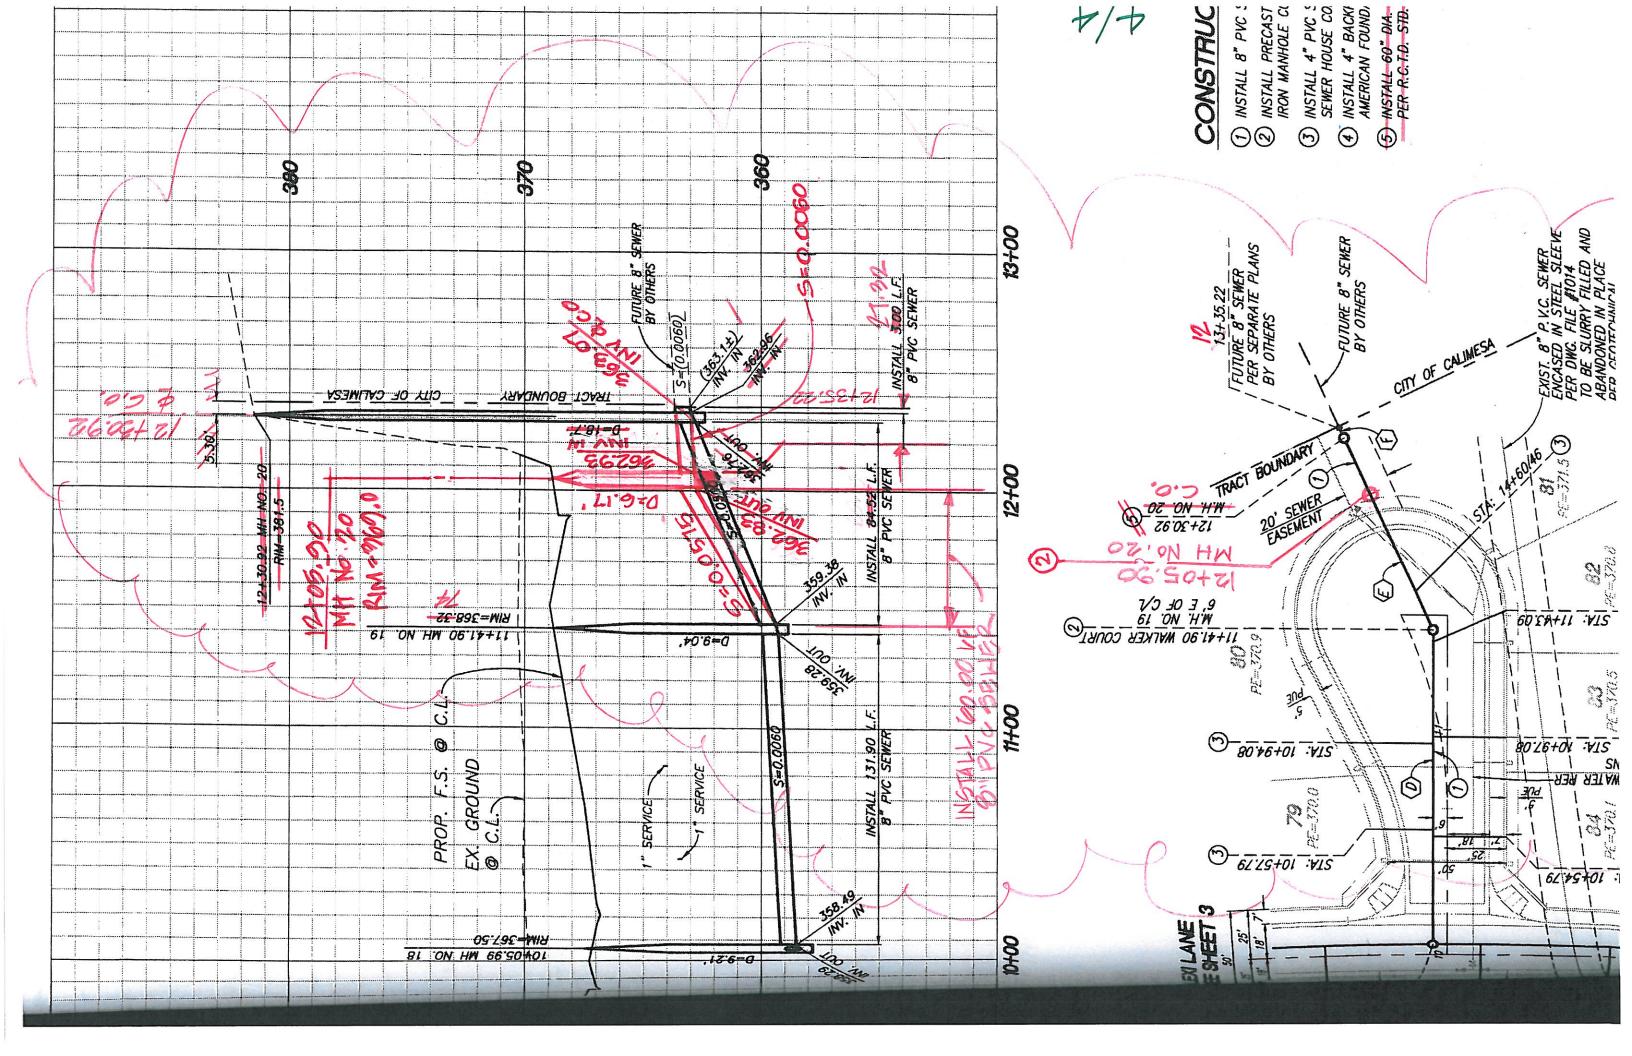
Θ.

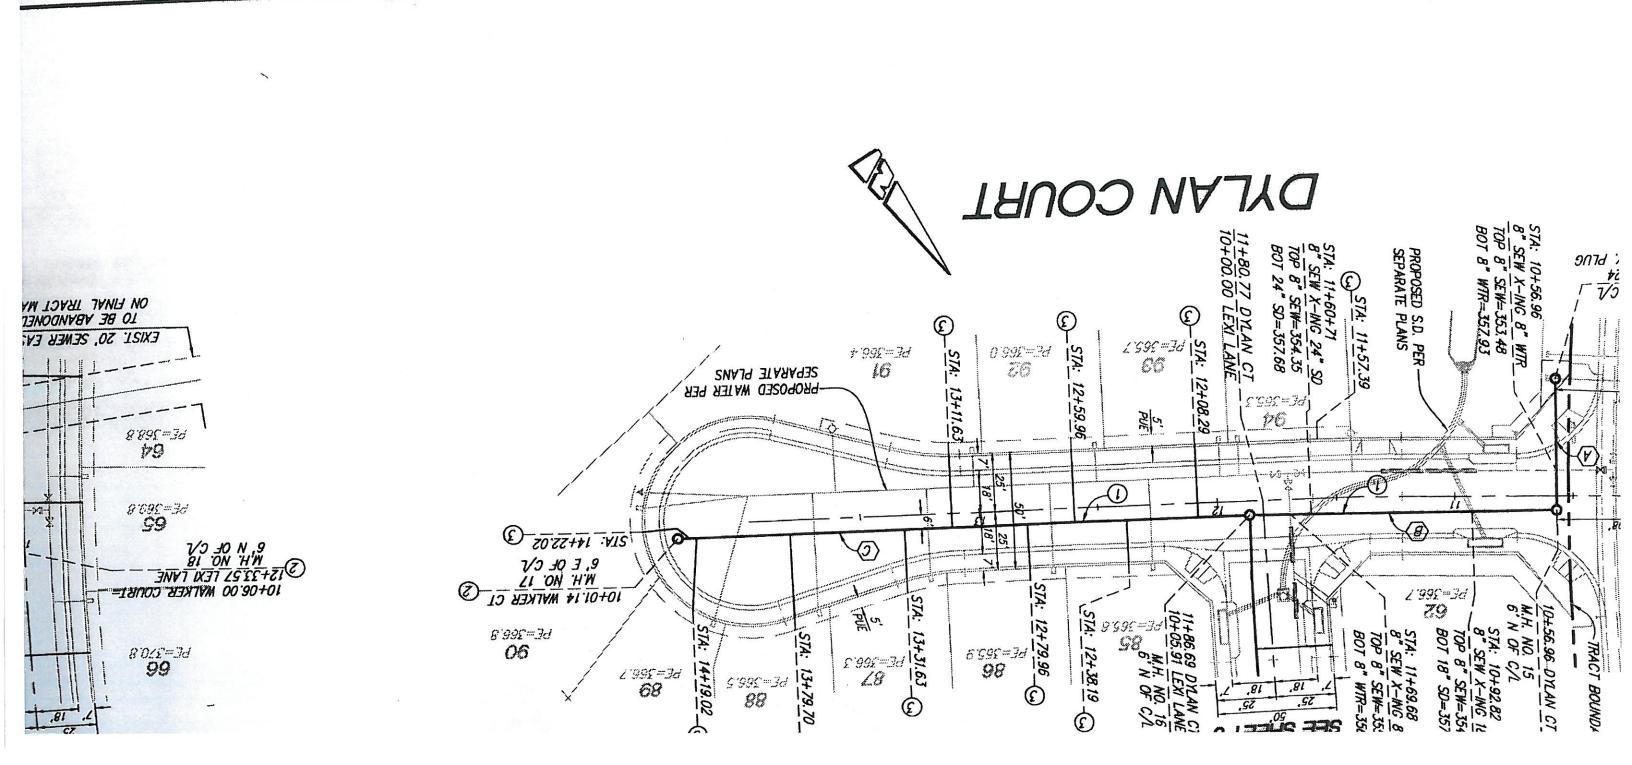

ETEN: 5491.44, NGVD 29 ENCINEER BENISIONS B.C.E. 45920 EXP. 12-31-2016 CILL OF INTERSTATE HIGHWAY 10 EDCE OF THE SOUTH EASTBOUND LANES **MARK** "TIBBAS DESCRIPTION .A99A DATE CENTERLINE 24.9 FT. S.W. OF THE S.W. 91/11/90 ONTROL STATIONS "REST" AND CEMETERY 25.3 FT. N.E. OF THE DRIVE 382' SONE & BASED LOCALLY ON THE DRIVE FROM DESERT LAWN TATE PLANE COORDINATE SYSTEM, ENCINEERING MEST PROPERTY OF THE PROPERTY OF T 1972" ON DESERT LAWN DRIVE ACROSS HIS WAP IS THE CALIFORNIA Exp. 12/21/16 CONCRETE MONUMENT STAMPED "REST HE BYZIZ OF COORDINATES FOR No. 45920 BENCHMARK DISK SET IN TOP OF BENCHMARK: ZGIOG JEFFERZON AVE. SUITE 200 HURRIETA, CA 92562 951-200-6840 ESCRIPTION: BEARINGS: CONSULTANTS WEST, INC. PROACTIVE ENGINEERING

BEYRING: N 51.33,25" E



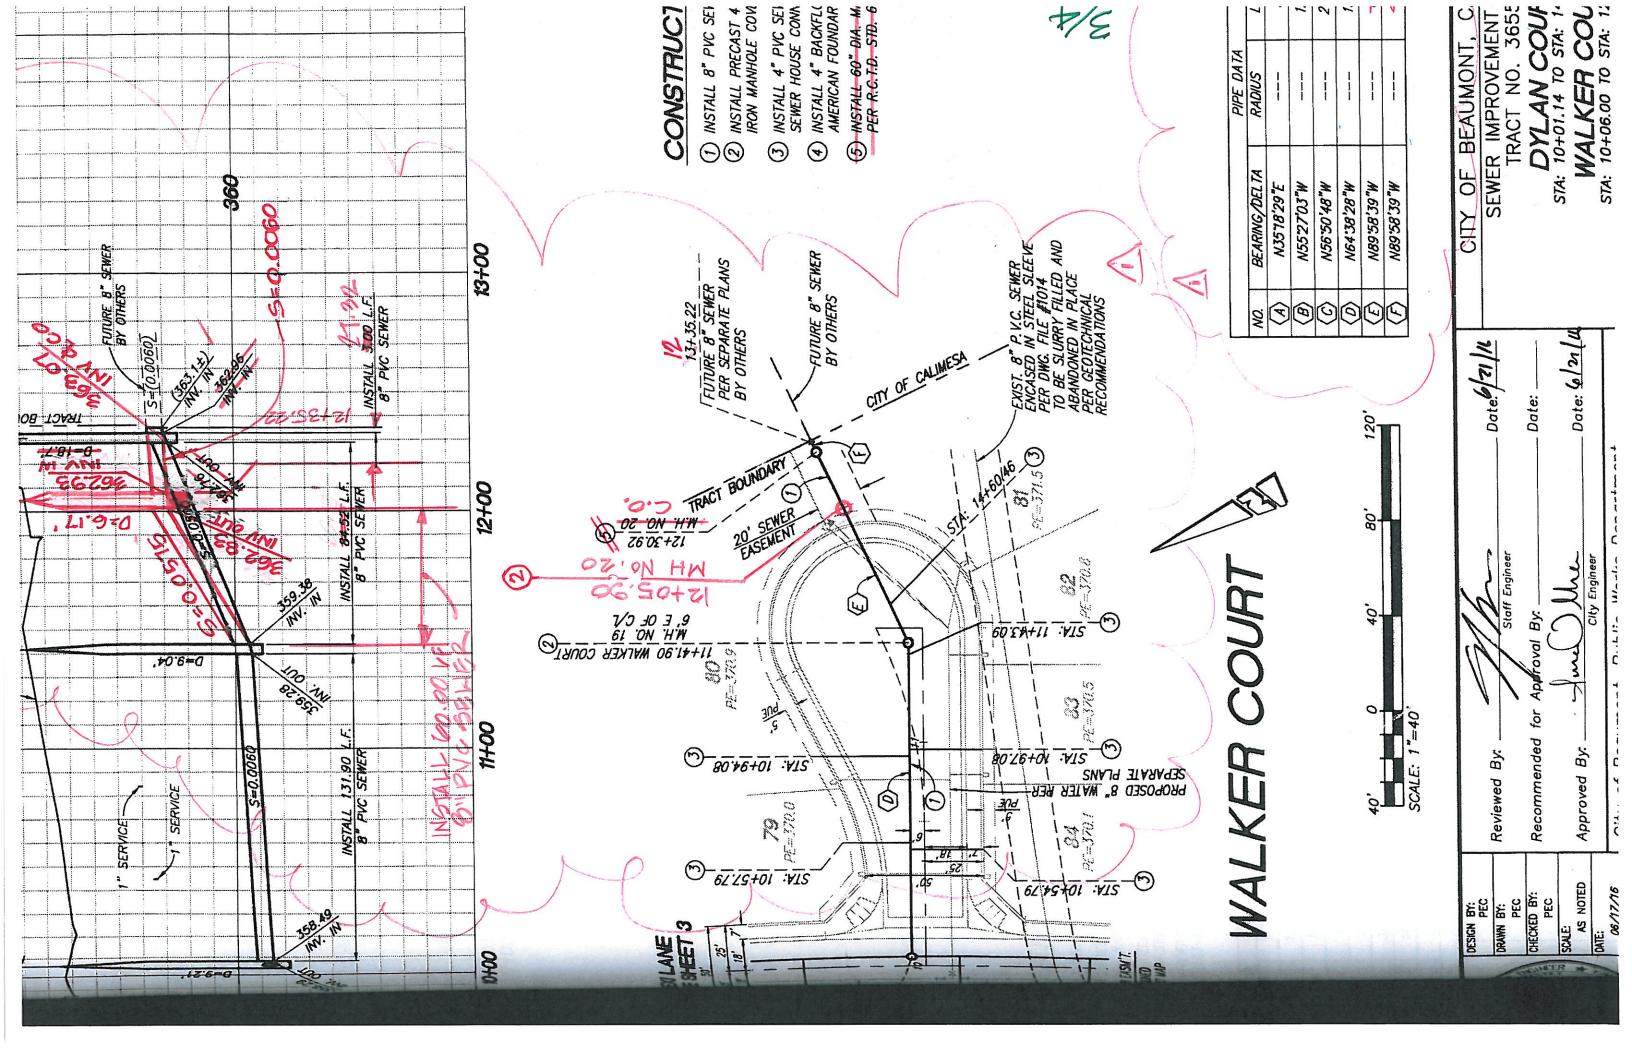



Punch List

Project Name: Street Improvements, Sewer Improvements

Project Number: Bond No.

1047933

Tract No. 36558

Pw2021-0741

Inspected By: Jason Craghead

Page: 1 of 1

Item No.	Description	Completed by Construction (Sign/Date)	Accepted by (Sign/Date)
1)	All streetlights missing inspection plates @ base of pole.		josn Cofel 6/9/22
2)	Verify all streetlights are functioning properly.		Gara Confel
: 3)	Crack seal all streets.		gur Cold
4)	Apply Asphaltic Emulsion (Fog Seal) in accordance with General Note 10 on Street Improvement Plans.		8/9/22 6/9/22
5)	Clean out all Trash Racks at Curb Inlet Catch Basins.		Jason Cold 5/31/22
6)	S/w, N/W Corner of Michelle Ln./Wie Ct. Repair, Replace Curb Ramp per Riverside County Std. No. 403 Case A		Jun Confel
7)	S/w Corner of Trevor/Michelle Ln. Repair, Replace Curb Ramp per Riverside County Std. No. 403 Case A		5/4/22
8)			
9)			
10)			
11)			