



EXISTING CONDITIONS AND DEMOLITION

SCALE: 1"=10'

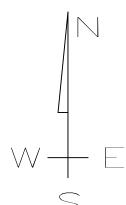

GRAPHIC SCALE

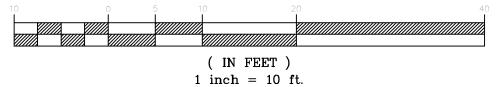



NEW MAG NAIL SET BY SURVEYOR IN ASPHALT OF N BEACH BLVD


BOUNDARY BASED ON SURVEY BY CROSBY SURVEYING; TOPOGRAPHIC INFORMATION BASED ON THE SAME SUBJECT PROPERTY LIES WITHIN "X 500" FLOOD ZONE PER FEMA PANEL 28045C0362D DATED OCTOBER 16, 2009.

LEGEND



REMOVE UTILITY

DENOTES REMOVAL OF ALL **EXISTING IMPROVEMENTS** AND FILL

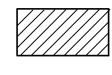

DENOTES LIMITS OF REMOVAL FOR A STRUCTURE AND ITS **APPURTENANCES**



TREE DEMO

DEMOLITION NOTES:

- 1. CONTRACTOR SHALL BE RESPONSIBLE FOR REMOVING ANY AND ALL EXISTING STRUCTURES DESIGNATED TO BE REMOVED WITHIN THE PROPERTY LIMITS, INCLUDING BUT NOT LIMITED TO STRUCTURES, FOUNDATIONS, ALL EXISTING PAVEMENTS AND DRIVEWAYS, EXISTING FENCES, UTILITIES, AND DEBRIS.
- 2. CONTRACTOR SHALL BE RESPONSIBLE FOR ANY AND ALL DAMAGES THAT MIGHT OCCUR TO IMPROVEMENTS SHOWN HEREON TO REMAIN.
- 3. CONTRACTOR SHALL REMOVE ALL DEBRIS FROM THE SITE THAT IS FOUND TO EXIST PRIOR TO HIS WORK OR THAT IS GENERATED AS A RESULT OF HIS WORK. DEBRIS SHALL CONSIST OF ANY MATERIAL OTHER THAN SOIL.
- 4. CONTRACTOR WILL NOT BE RESPONSIBLE FOR DEMOLISHING OR REMOVING ANY EXISTING ABOVE OR BELOW GROUND TELEPHONE OR POWER BUT SHALL BE RESPONSIBLE FOR COORDINATING NECESSARY WORK WITH LOCAL UTILITY COMPANIES.
- 5. CONTRACTOR SHALL CALL THE MISSISSIPPI DAMAGE PREVENTION NUMBER (1-800-227-6477) BY LAW TO LOCATE ALL EXISTING UTILITIES ON SITE PRIOR TO HIS WORK. CONTRACTOR SHALL BE RESPONSIBLE FOR PROTECTING UTILITIES NOT DESIGNATED TO BE REMOVED UNDER THIS CONTRACT AND BE RESPONSIBLE FOR ANY AND ALL DAMAGES TO EXISTING UTILITIES NOT DESIGNATED TO BE REMOVED THAT RESULT FROM CONTRACTOR'S WORK.
- 6. REMOVAL OF ALL POWER LINES, POLES, AND APPURTENANCES SHALL BE BY LOCAL UTILITY COMPANY.
- 7. LIMITS OF CLEARING AND GRUBBING SHALL BE PROPERTY LINES, UNLESS SPECIFICALLY DESIGNATED OTHERWISE.
- 8. CONTRACTOR SHALL OBTAIN AND PAY FOR ALL CONSTRUCTION PERMITS THAT ARE REQUIRED.



TERRY MORAN ENGINEERING

P.O. BOX 4075

BILOXI, MS 39535

PH 228.896.4733

TERRY MORAN, P.E., P.L.S

In Association With




Date <u>08-14-2025</u> Drawn By F.O.F. Check By T.J.M.

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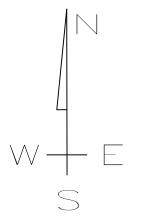
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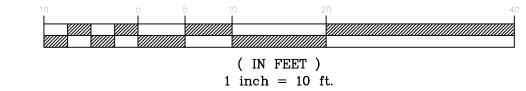


SITE PLAN

SCALE: 1"=10'

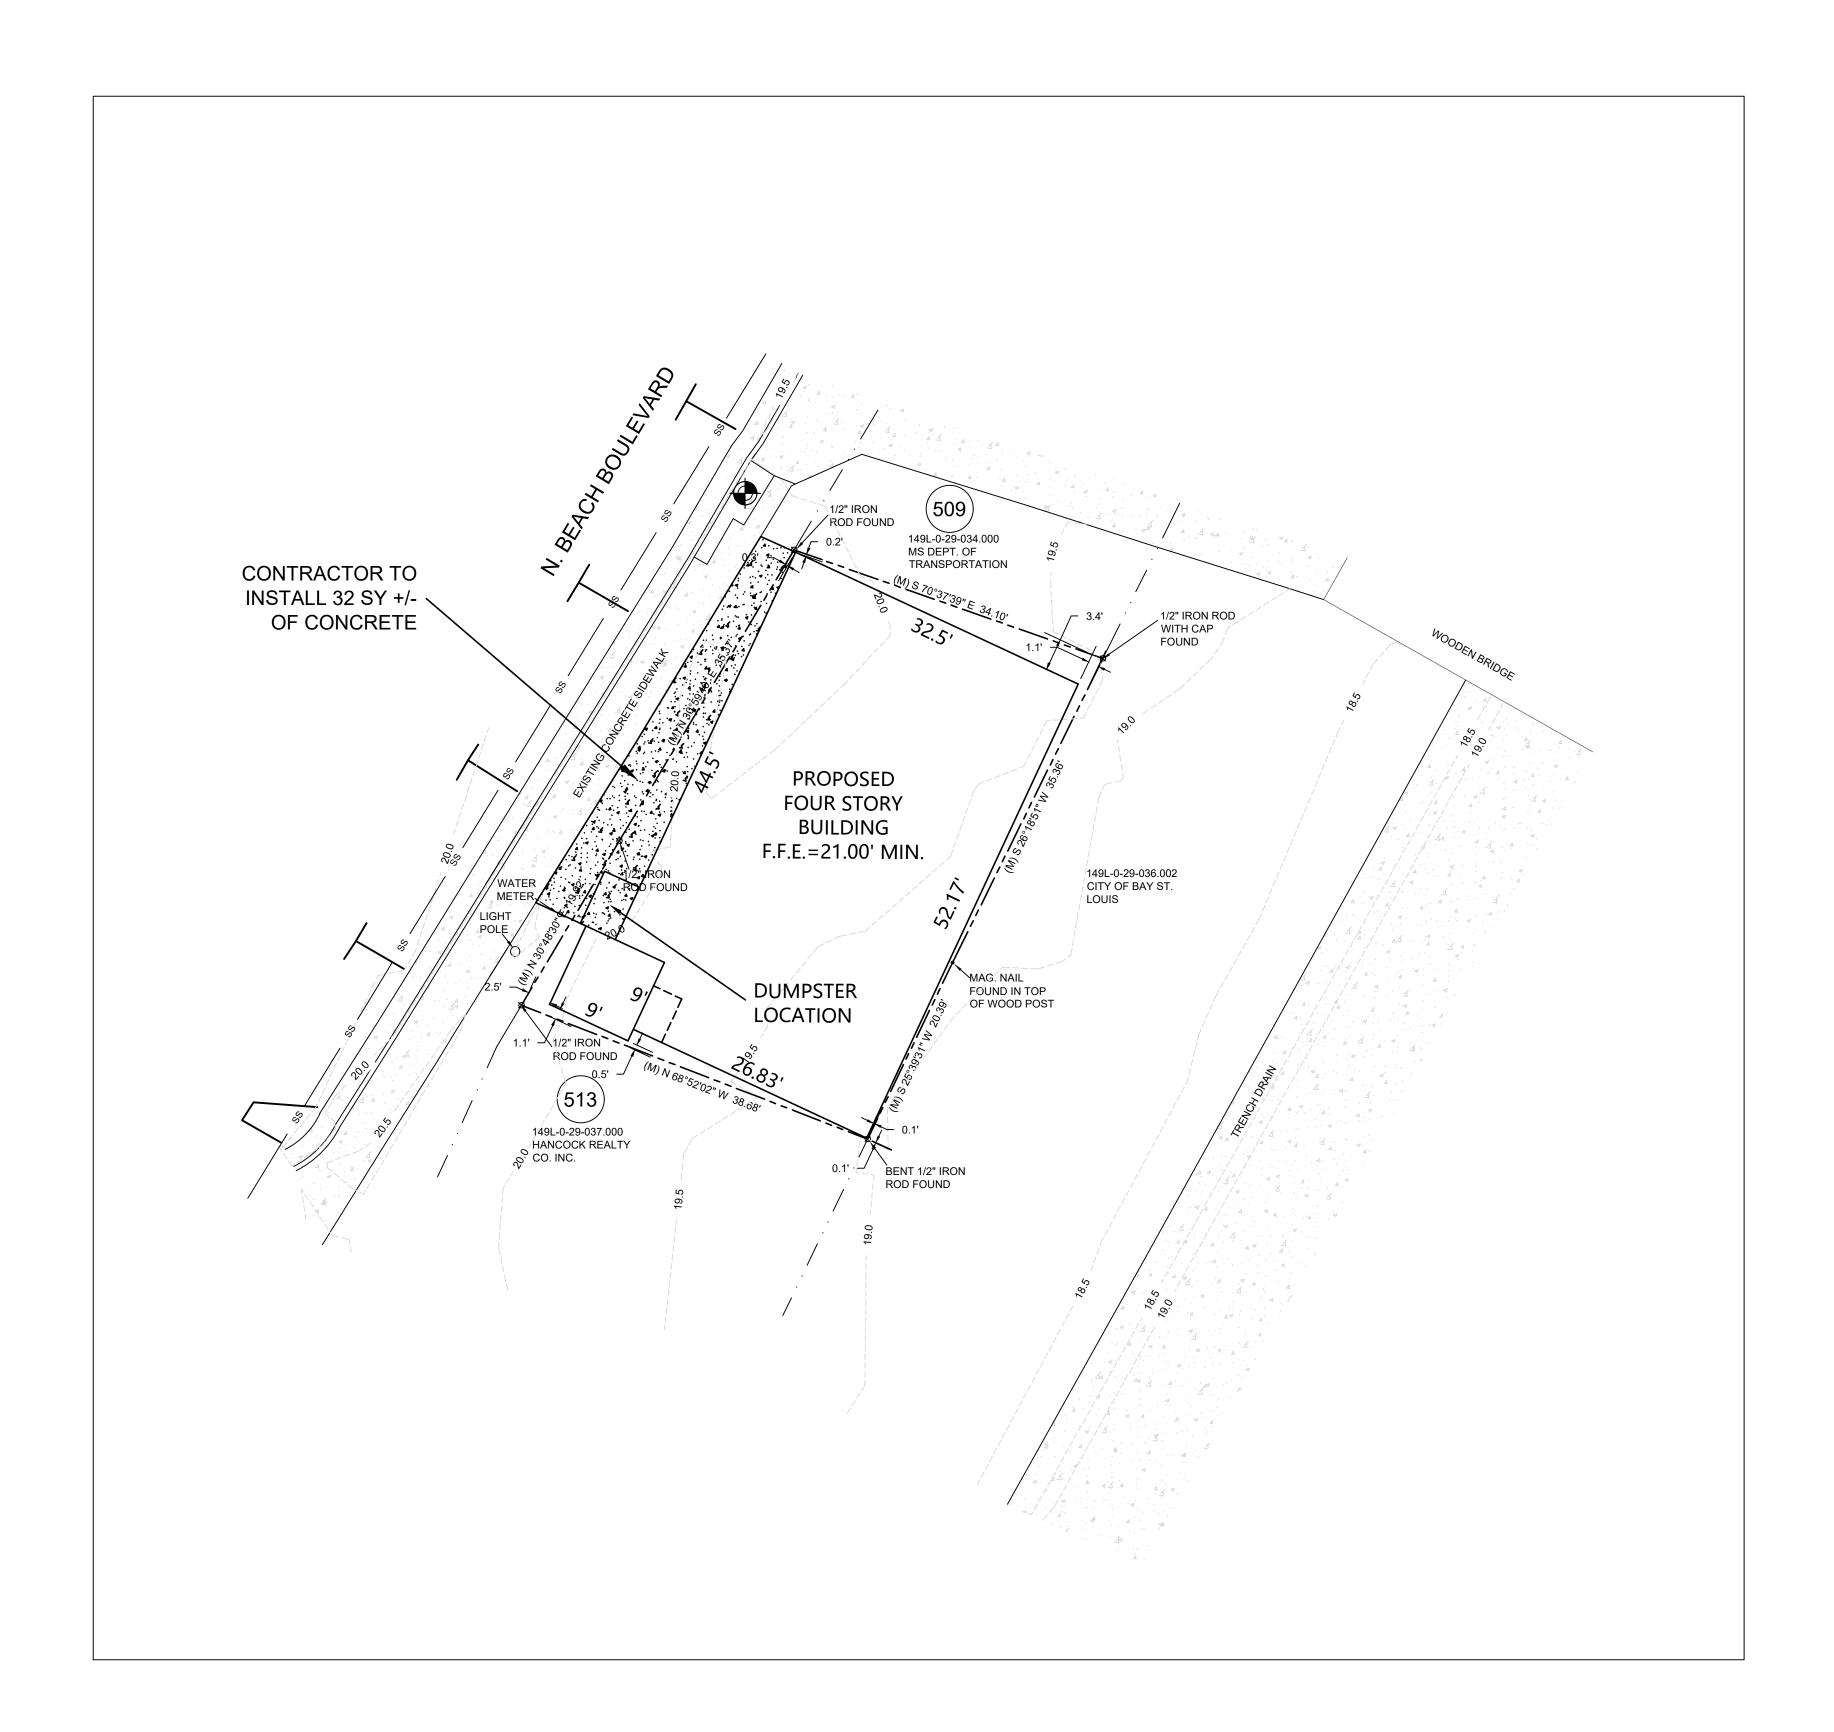

GRAPHIC SCALE



ELEV. = 20.07 CURB INLET TOP CORNER OF PRO N BEACH BLVD

CURB INLET TOP AT NORTHEAST
CORNER OF PROPERTY ALONG
N BEACH BLVD

BOUNDARY BASED ON SURVEY BY CROSBY SURVEYING; TOPOGRAPHIC INFORMATION BASED ON THE SAME SUBJECT PROPERTY LIES WITHIN "X 500" FLOOD ZONE PER FEMA PANEL 28045C0362D DATED OCTOBER 16, 2009.

SITE DATA TABLE


ACREAGE: 0.071 +/- AC

ZONING: C-1

SETBACKS:

FYSB - 0 FT SYSB - 0 FT RYSB - 0 FT

TOTAL SQUARE FOOTAGE - 6,932 SF (INCLUDING ELEVATOR SHAFT)

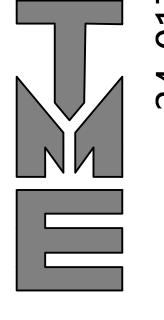

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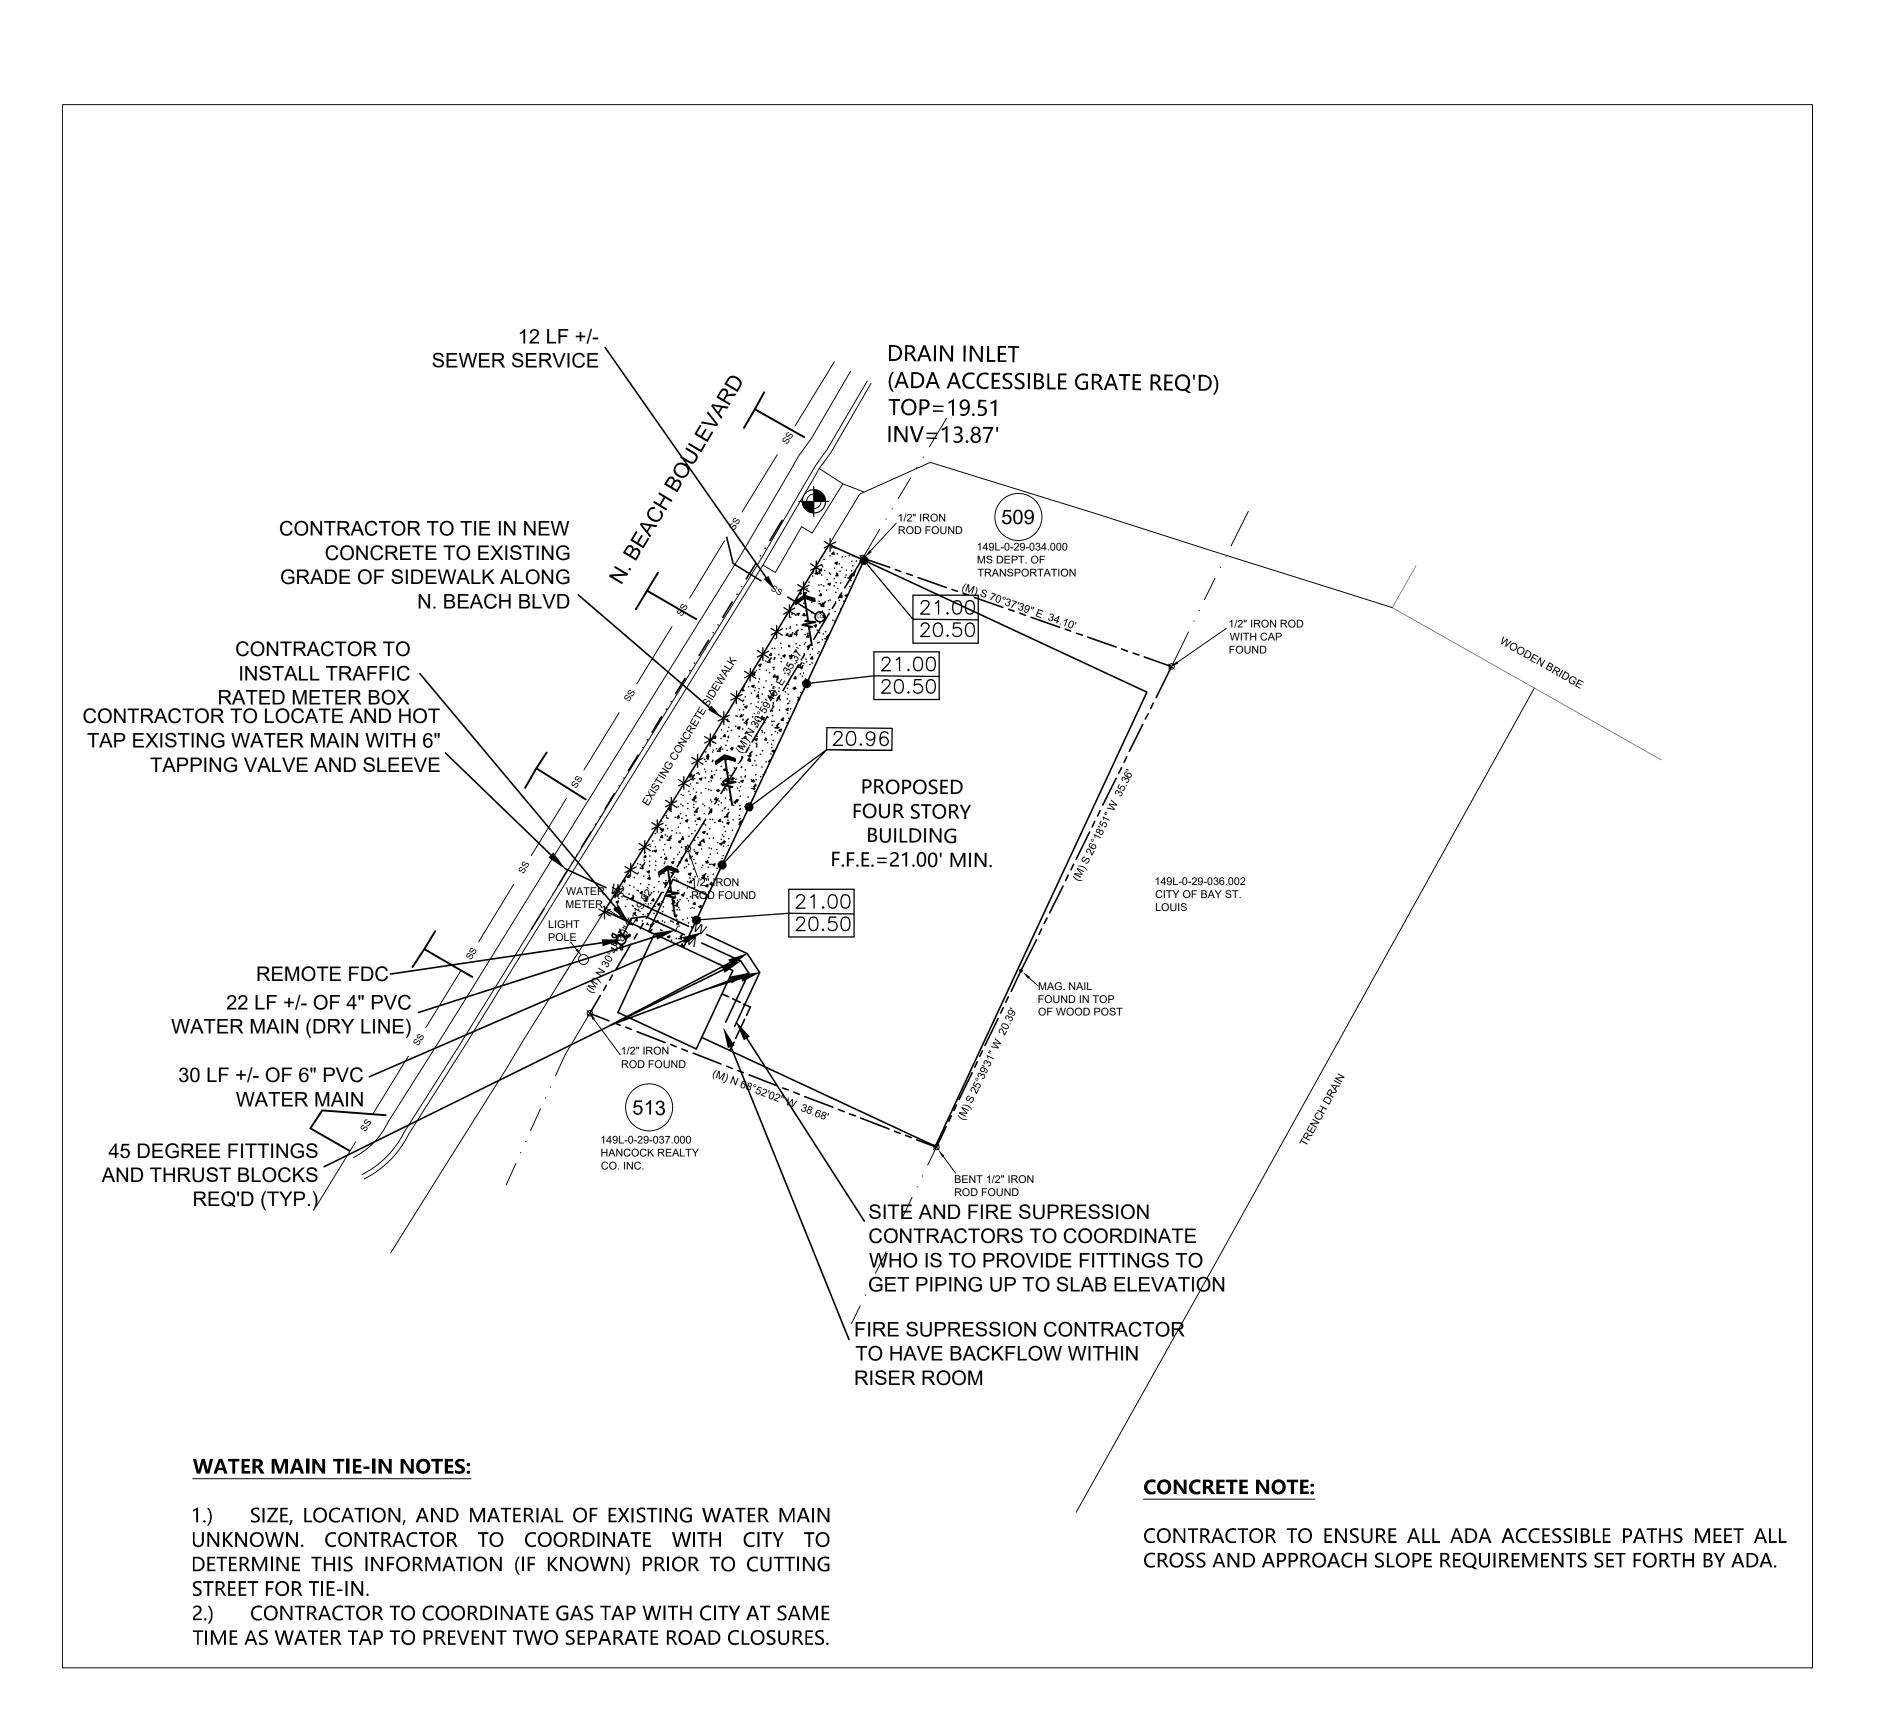
Date 08-14-2025
Drawn By F.O.F.
Check By T.J.M.
REV

PROPOSED BAR N BEACH BLVD AY ST LOUIS, MS

NOTE:
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C3





GRADING, DRAINAGE, & UTILITY PLAN

SCALE: 1"=10'



GRAPHIC SCALE

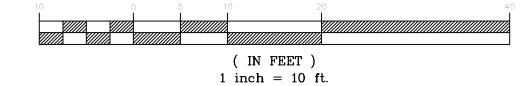

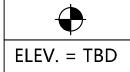

NEW MAG NAIL SET BY SURVEYOR IN ASPHALT OF N BEACH BLVD


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UTILITY LEGEND


PROPOSED		EXISTING
—— w——	WATER MAIN	———W——
—— s ——	SEWER LINE	——s—
—— G ——	GAS LINE	——- G——
	ROW/PROP	
	QTR SECTION	
	WIRE FENCE	
©	CLEAN-OUT	CO
<u></u>	MANHOLE	S
H	WATER VALVE	
**	FIRE HYDRANT	
W	WATER METER	W
21.5	PROP. SPOT EL.	
	EXIST. SPOT EL.	+. \\\^2
	TYP. SIGN	•
010	TYP. STOP BAR	N O L
	HEADER CURB	
	CURB & GUTTER	

GRADING & DRAINAGE LEGEND



NOTE:
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TERRY MORAN ENGINEERING

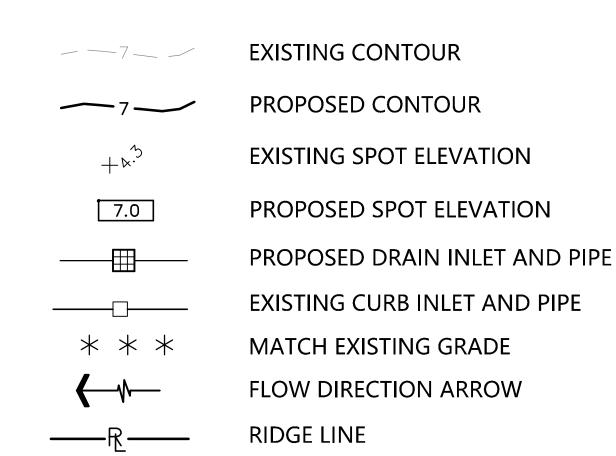P.O. BOX 4075 BILOXI, MS 39535

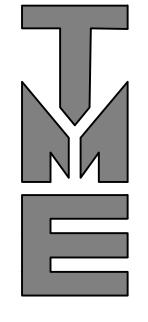P.E., P.L.S

LOXI, IVIS 39333

PH 228.896.4733
TERRY MORAN,


In Association With



Date <u>08-14-2025</u>
Drawn By <u>F.O.F.</u>
Check By <u>T.J.M.</u>
REV <u>08-27-2025</u>


PROPOSED BAR N BEACH BLVD

C4

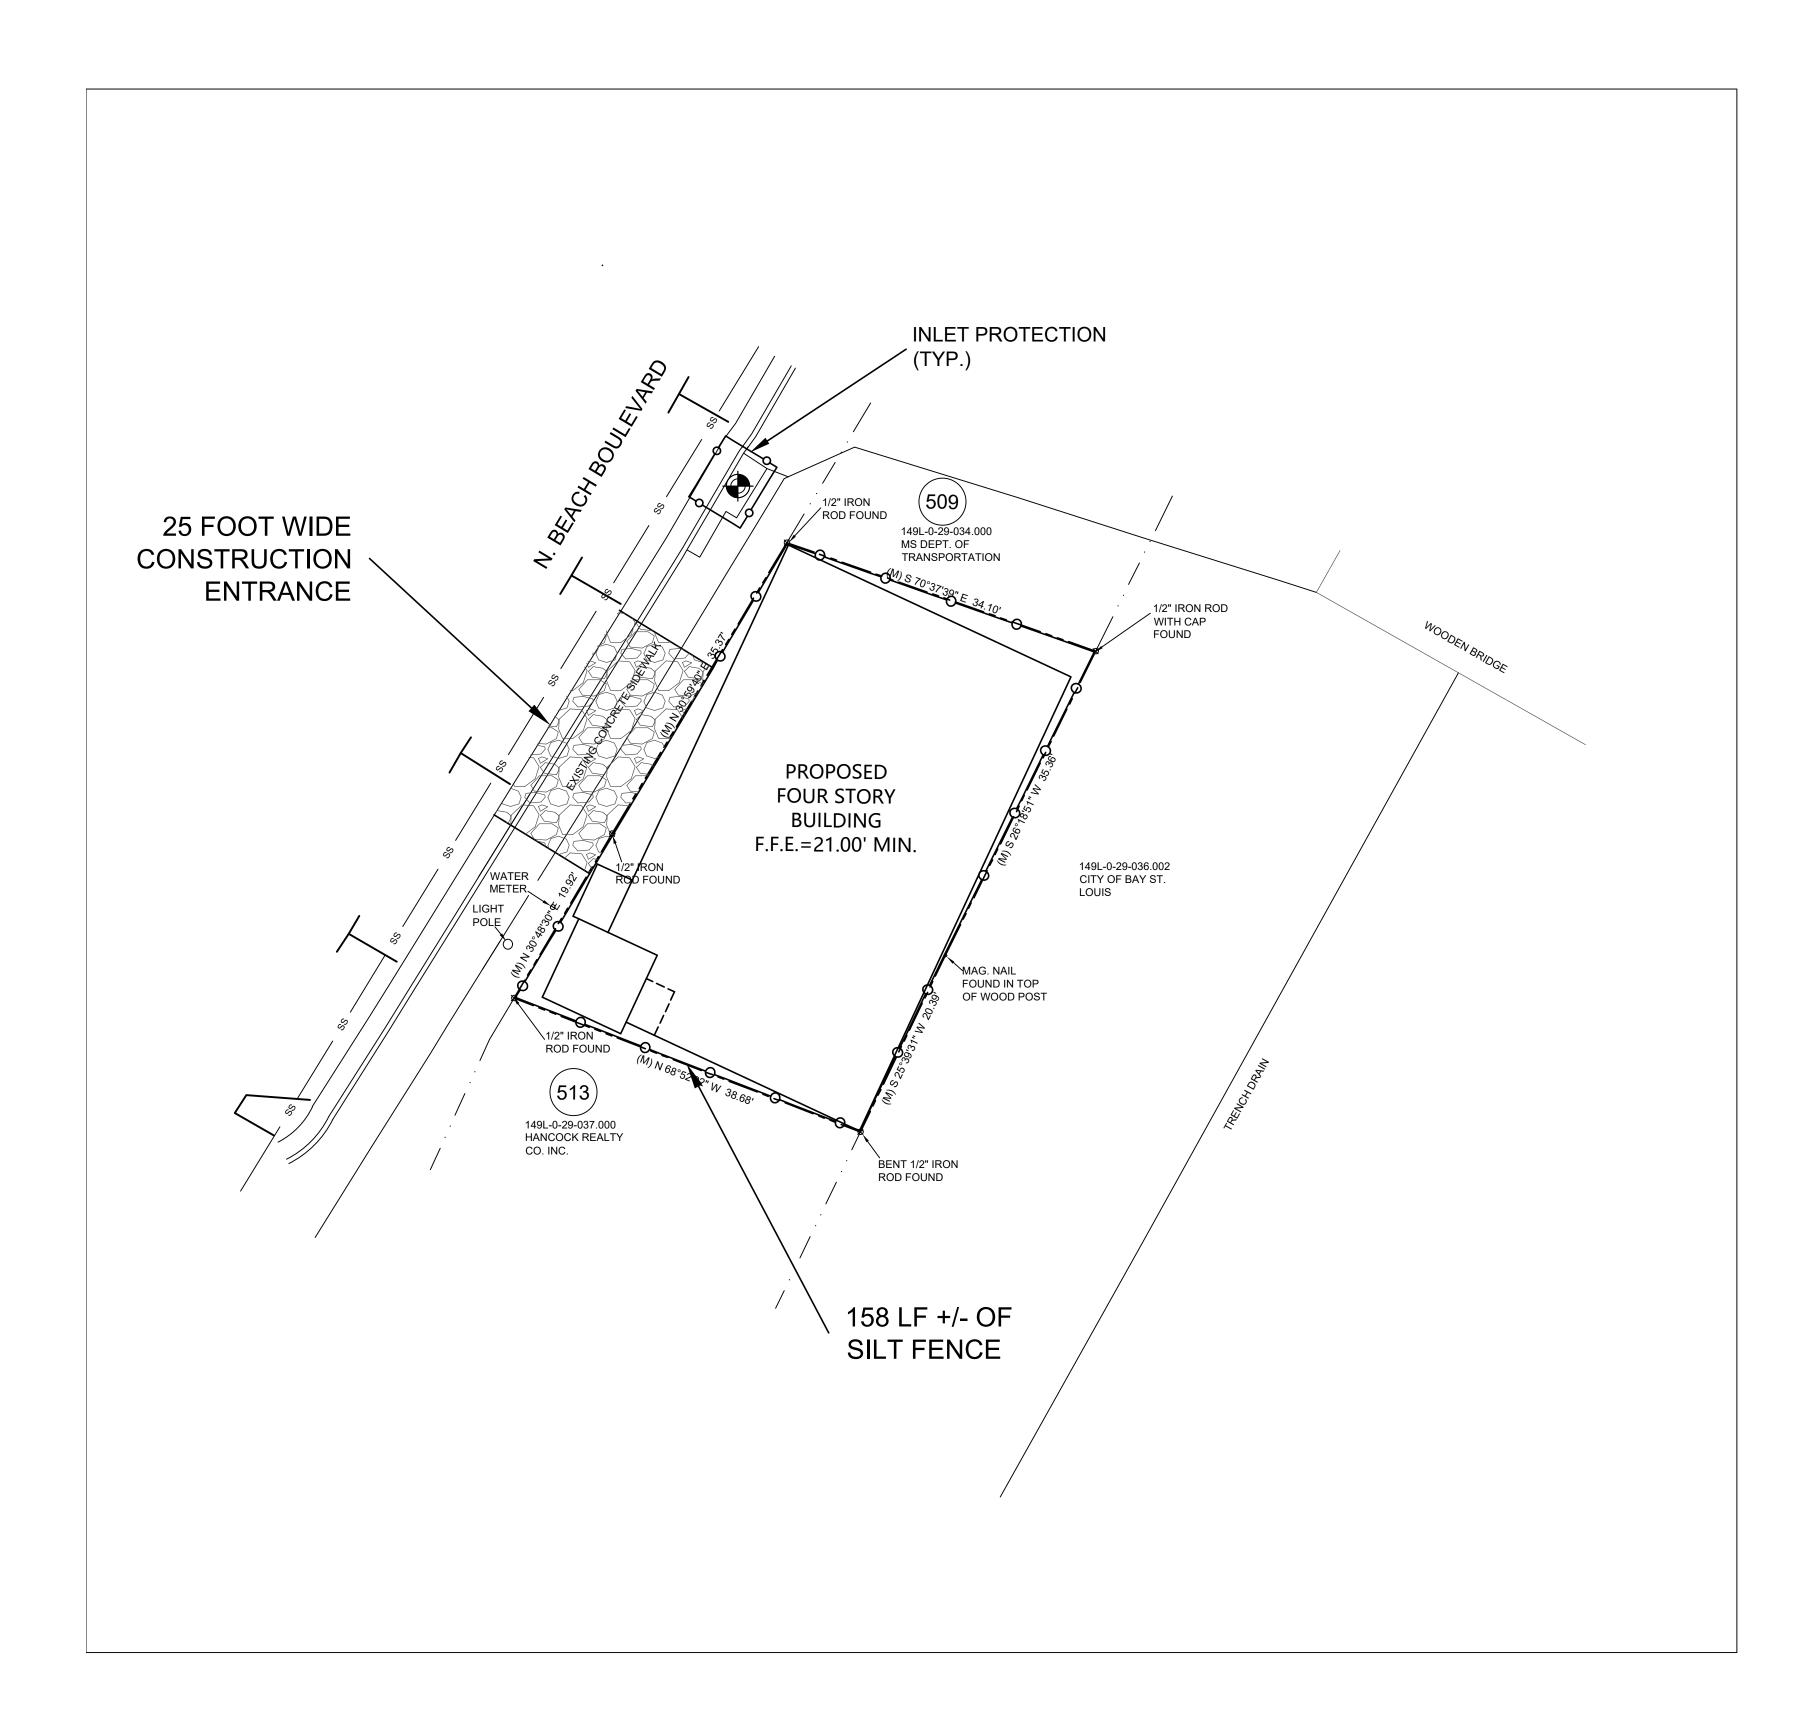


EROSION CONTROL PLAN


SCALE: 1"=10'

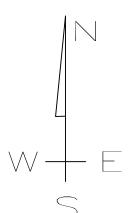

GRAPHIC SCALE

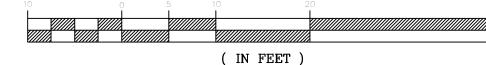

(IN FEET) 1 inch = 10 ft.

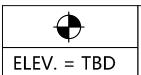


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LEGEND





TERRY MORAN ENGINEERING

P.O. BOX 4075

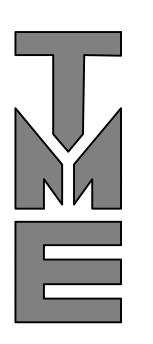BILOXI, MS 39535

PH 228.896.4733
TERRY MORAN,

P.E., P.L.S

In Association With




Date 08-14-2025
Drawn By F.O.F.
Check By T.J.M.
REV

ROPOSED BAR N BEACH BLVD NY ST LOUIS, MS


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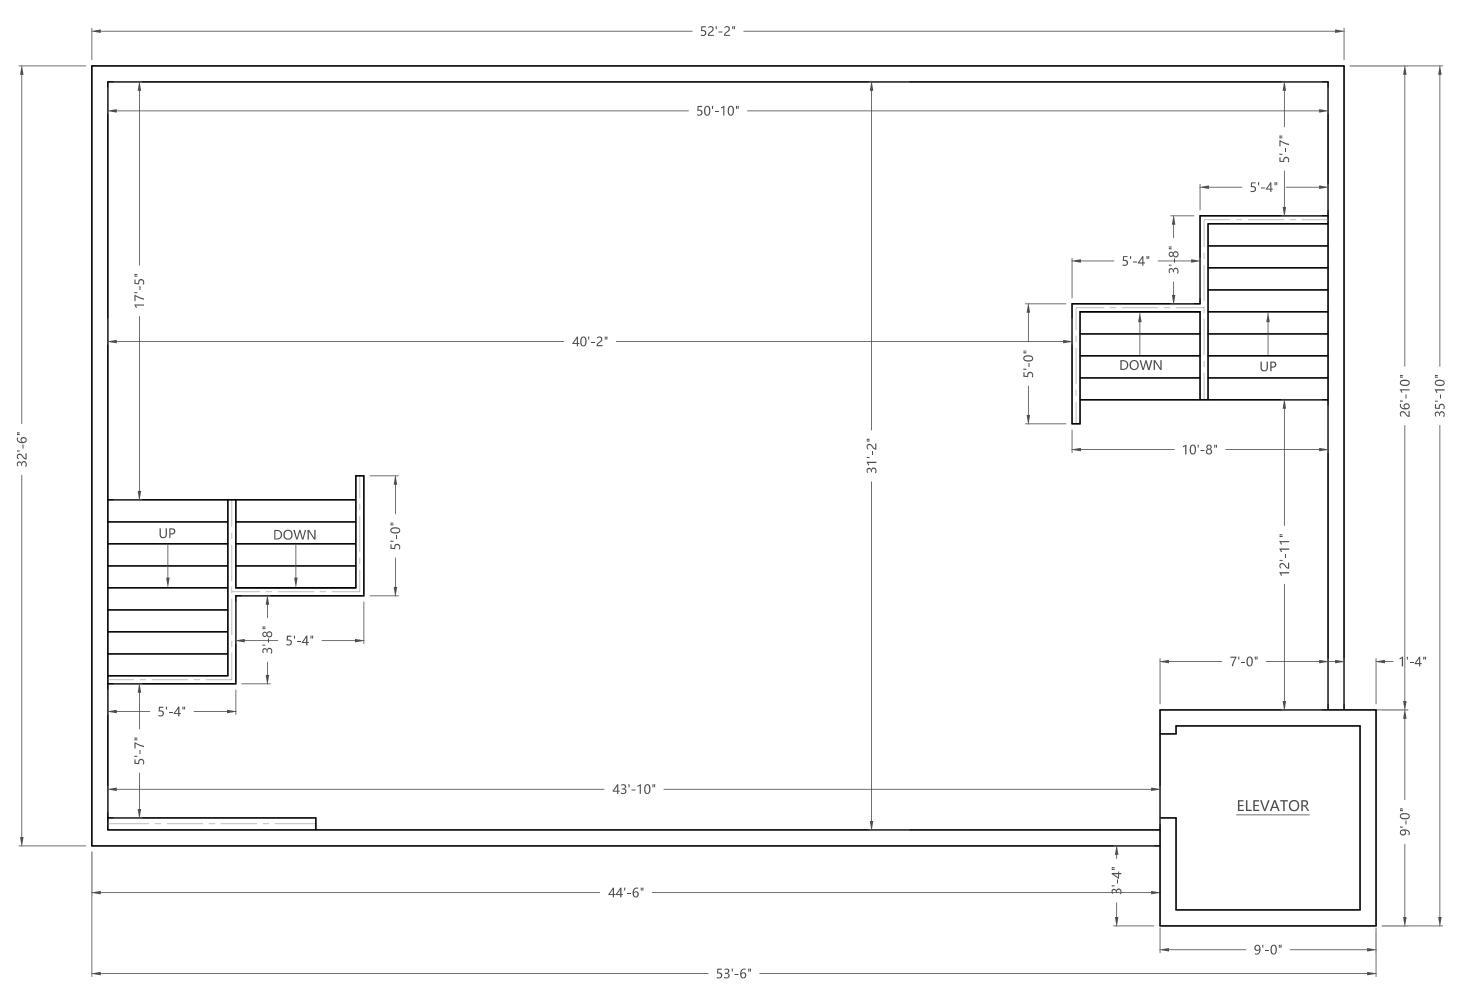
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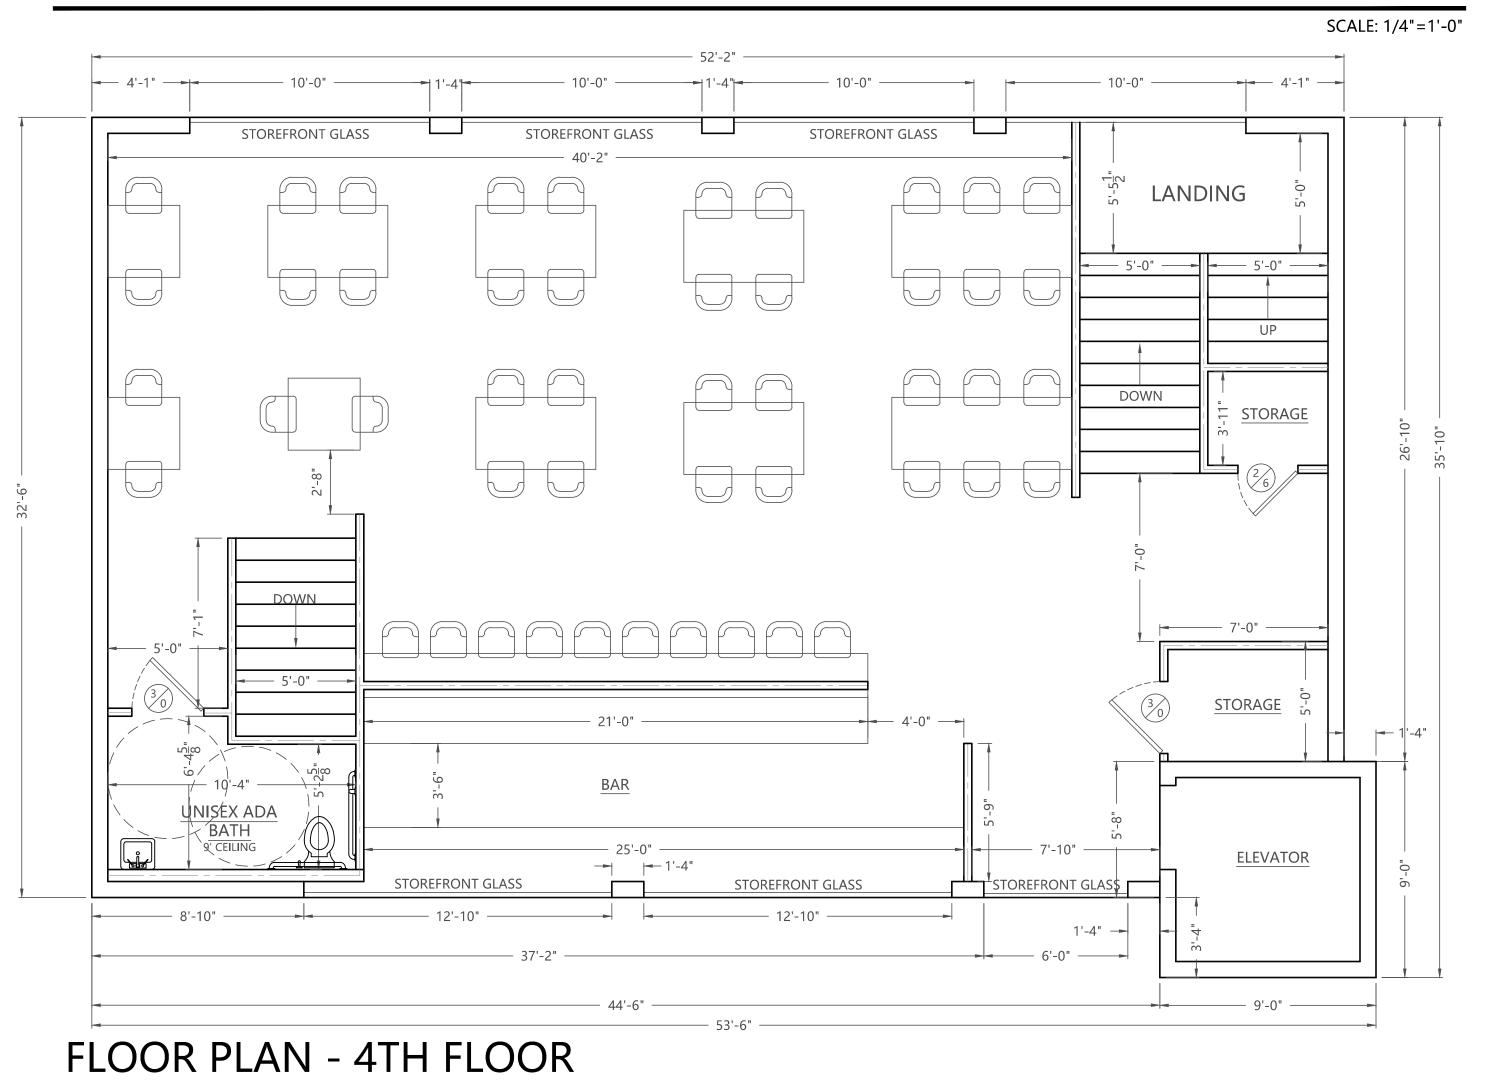





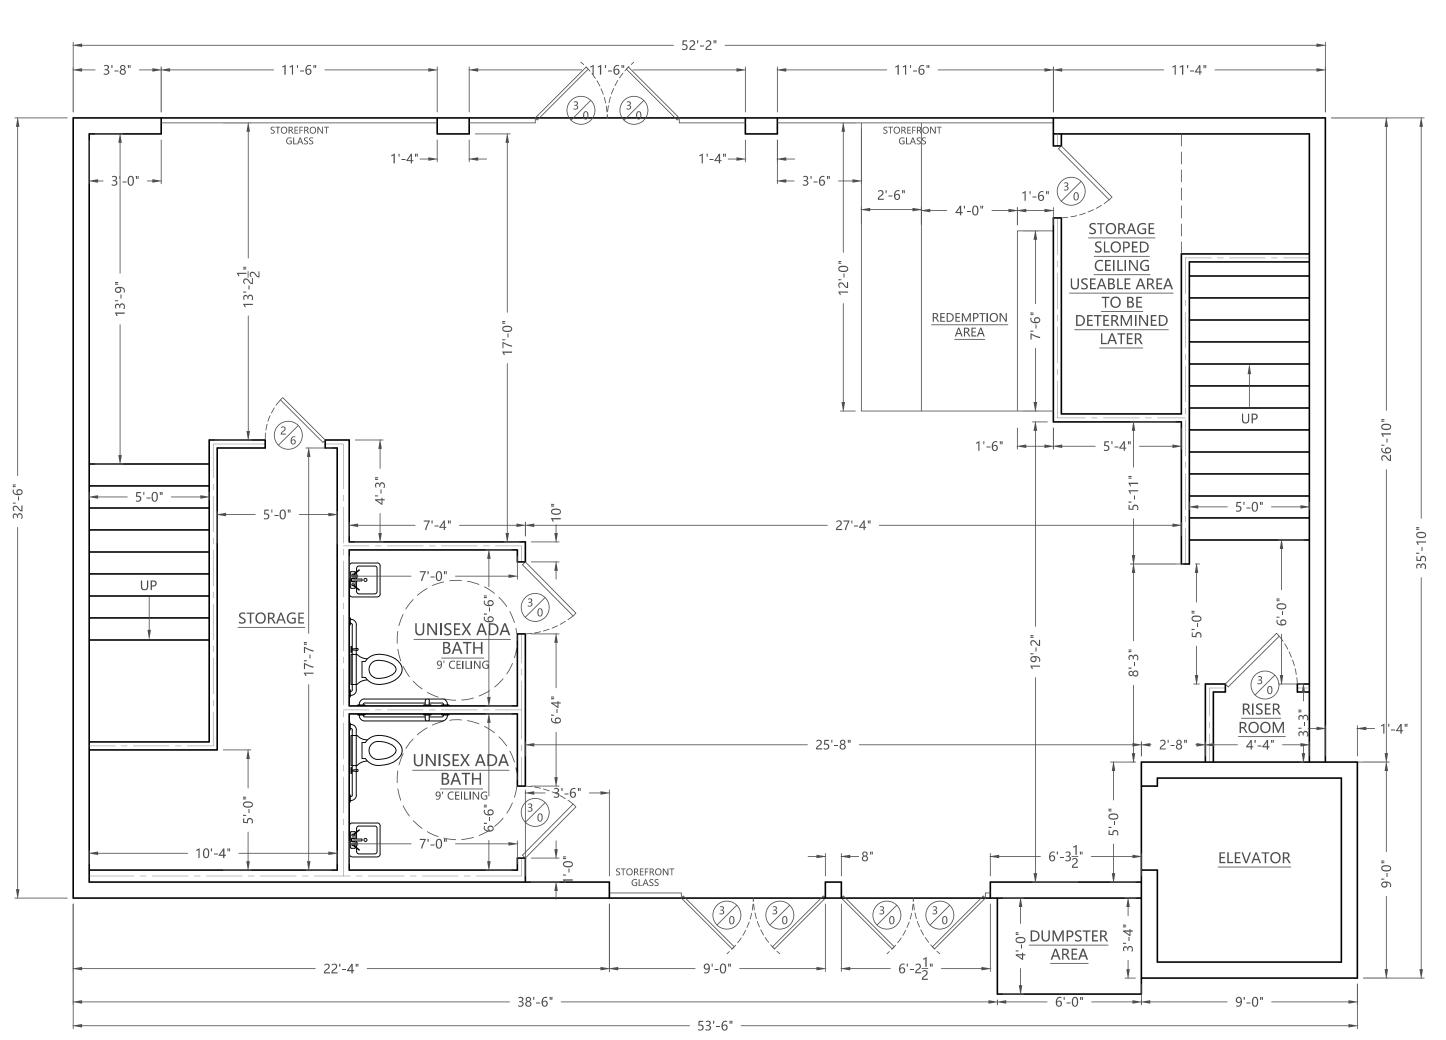

FLOOR PLAN - 2ND FLOOR

SCALE: 1/4"=1'-0"

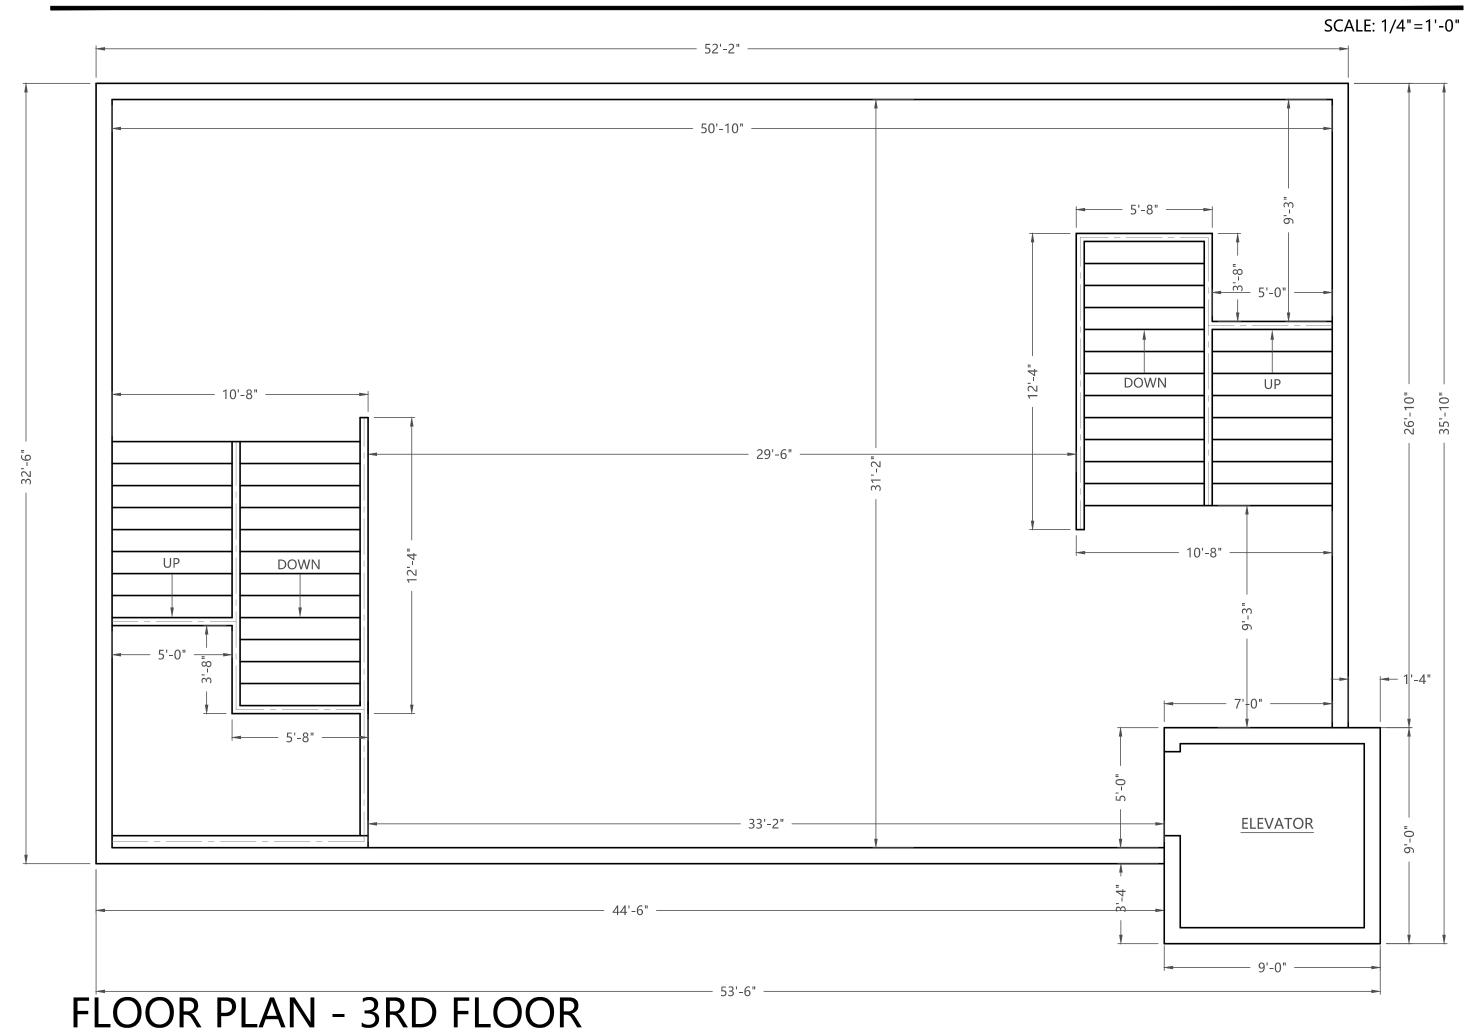

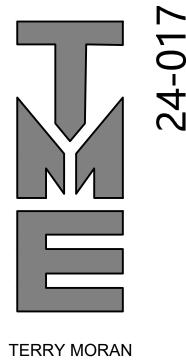

ERRY MORAN NGINEERING


P.O. BOX 4075 BILOXI, MS 39535 PH 228.896.4733 TERRY MORAN, P.E., P.L.S

In Association With

FOUNTAIN & ASSOCIATES
//L AND COMMERCIAL DESIGN
13334 Seaway Rd, Ste. 202
Gulfport, MS 39503

Date <u>08-14-2025</u>
Drawn By <u>F.O.F.</u>
Check By <u>T.J.M.</u>
REV <u>08-27-2025</u>

PROPOSED BAR N BEACH BLVD AY ST LOUIS, MS

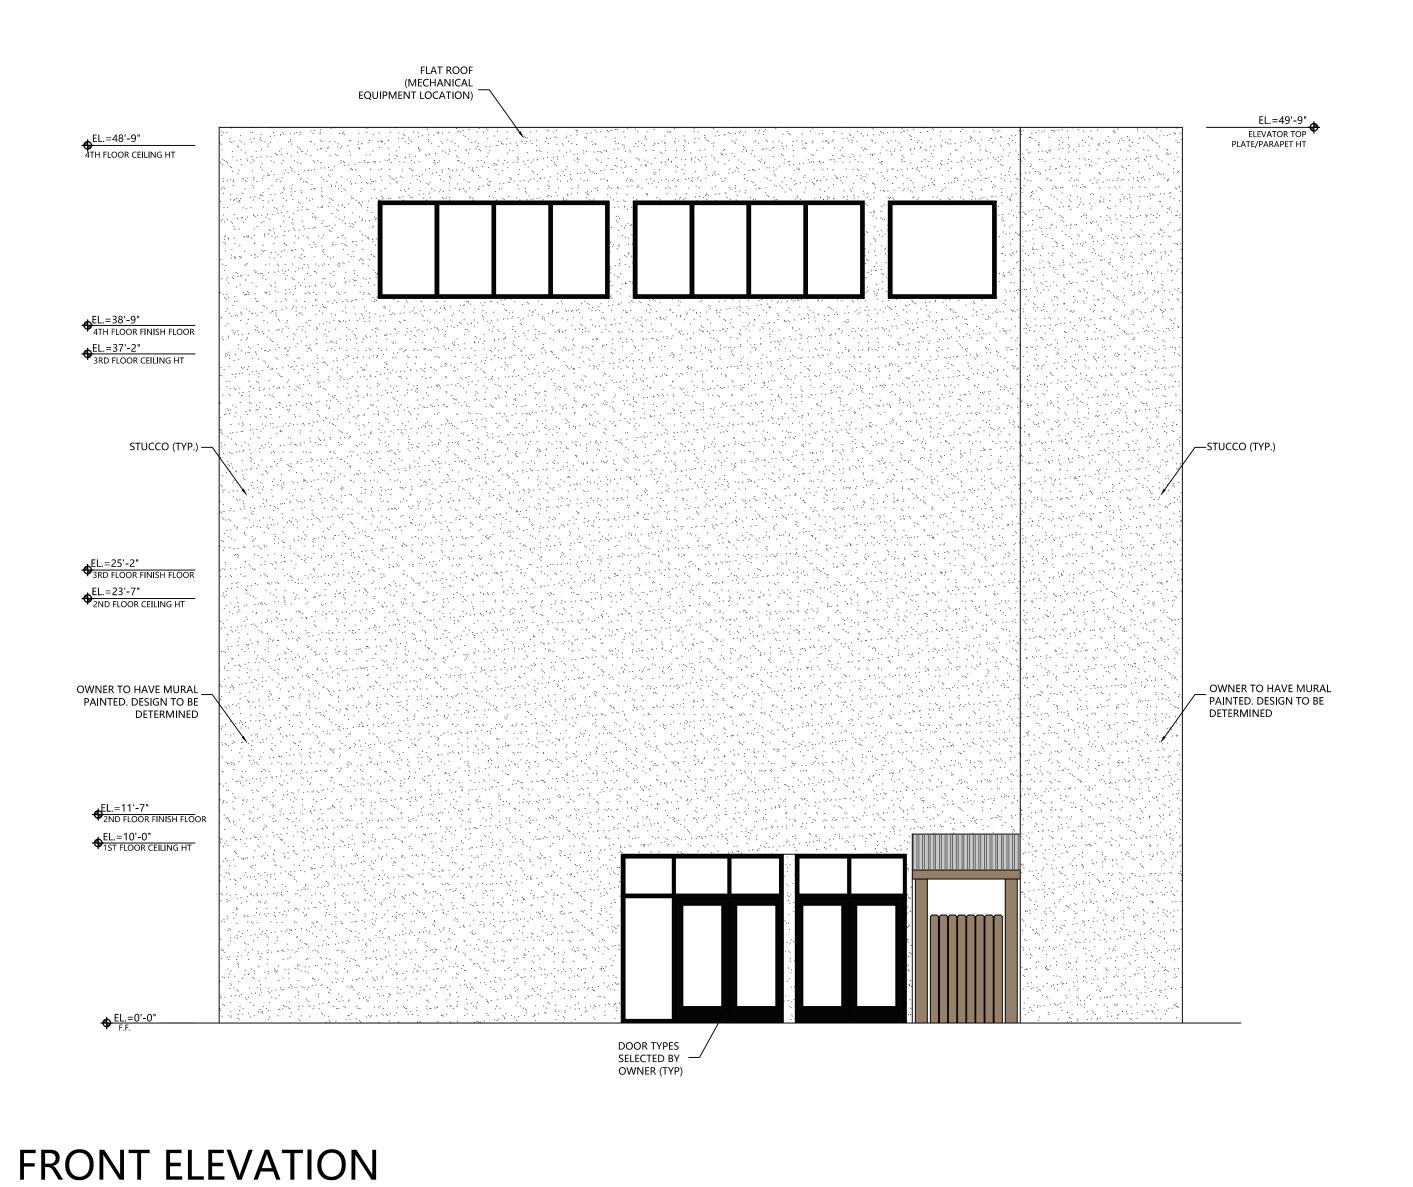

REAR ELEVATION

EL.=49'-9"

ELEVATOR TOP
PLATE/PARAPET HT

STUCCO (TYP.) —

WNER TO HAVE MURAL __ PAINTED. DESIGN TO BE DETERMINED

SCALE: 3/16"=1'-0"

DOOR TYPES
SELECTED BY
OWNER (TYP)

FLAT ROOF

(MECHANICAL

EQUIPMENT LOCATION)

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SCALE: 3/16"=1'-0"

EL.=48'-9"
4TH FLOOR CEILING HT

EL.=38'-9"
4TH FLOOR FINISH FLOOR

EL.=37'-2"

EL.=25'-2"

EL.=23'-7"
2ND FLOOR CEILING HT


OWNER TO HAVE MURAL
PAINTED. DESIGN TO BE
DETERMINED

EL.=11'-7"
2ND FLOOR FINISH FLOOR

EL.=10'-0"
1ST FLOOR CEILING HT


__STUCCO (TYP.)

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SOUTH SIDE ELEVATION

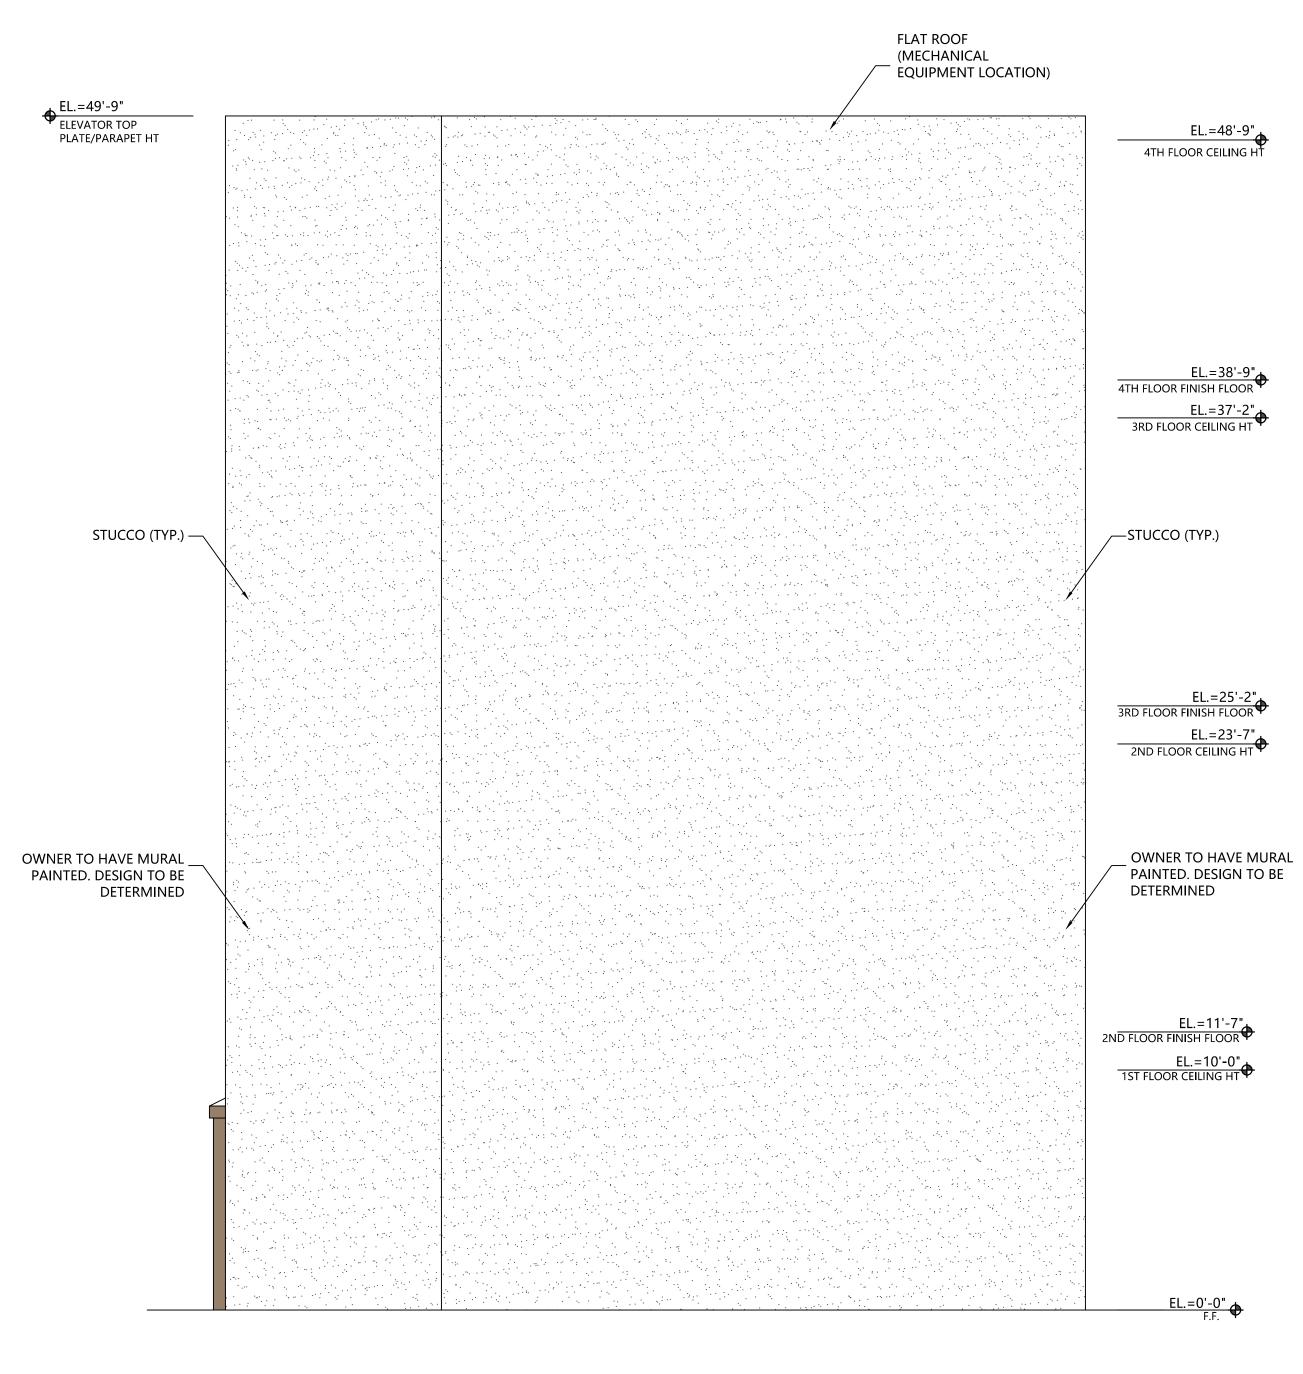SCALE: 1/4"=1'-0"



NORTH SIDE ELEVATION

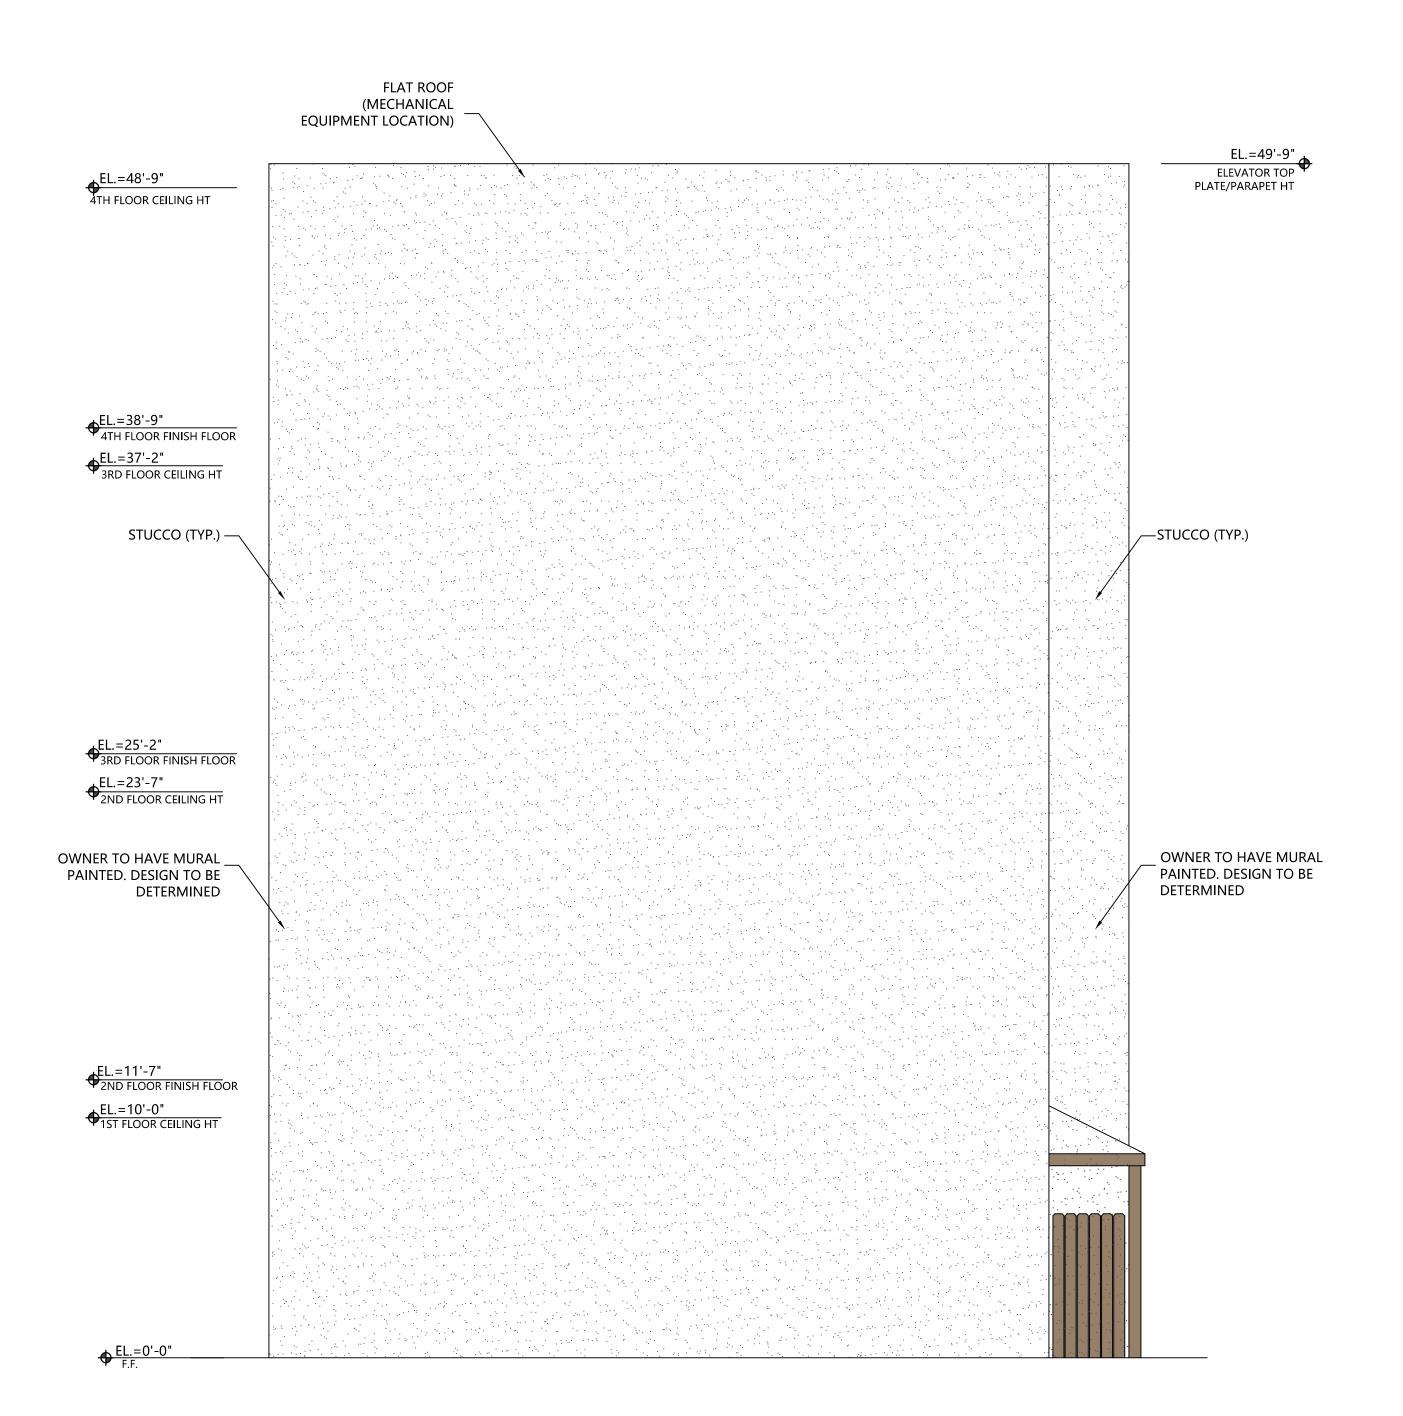SCALE: 1/4"=1'-0"

PROPOSED BAR N BEACH BLVD RAY ST LOUIS MS

Date 08-14-2025
Drawn By F.O.F.
Check By T.J.M.
REV

TERRY MORAN

ENGINEERING

P.O. BOX 4075 BILOXI, MS 39535

PH 228.896.4733

TERRY MORAN, P.E., P.L.S

In Association With

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