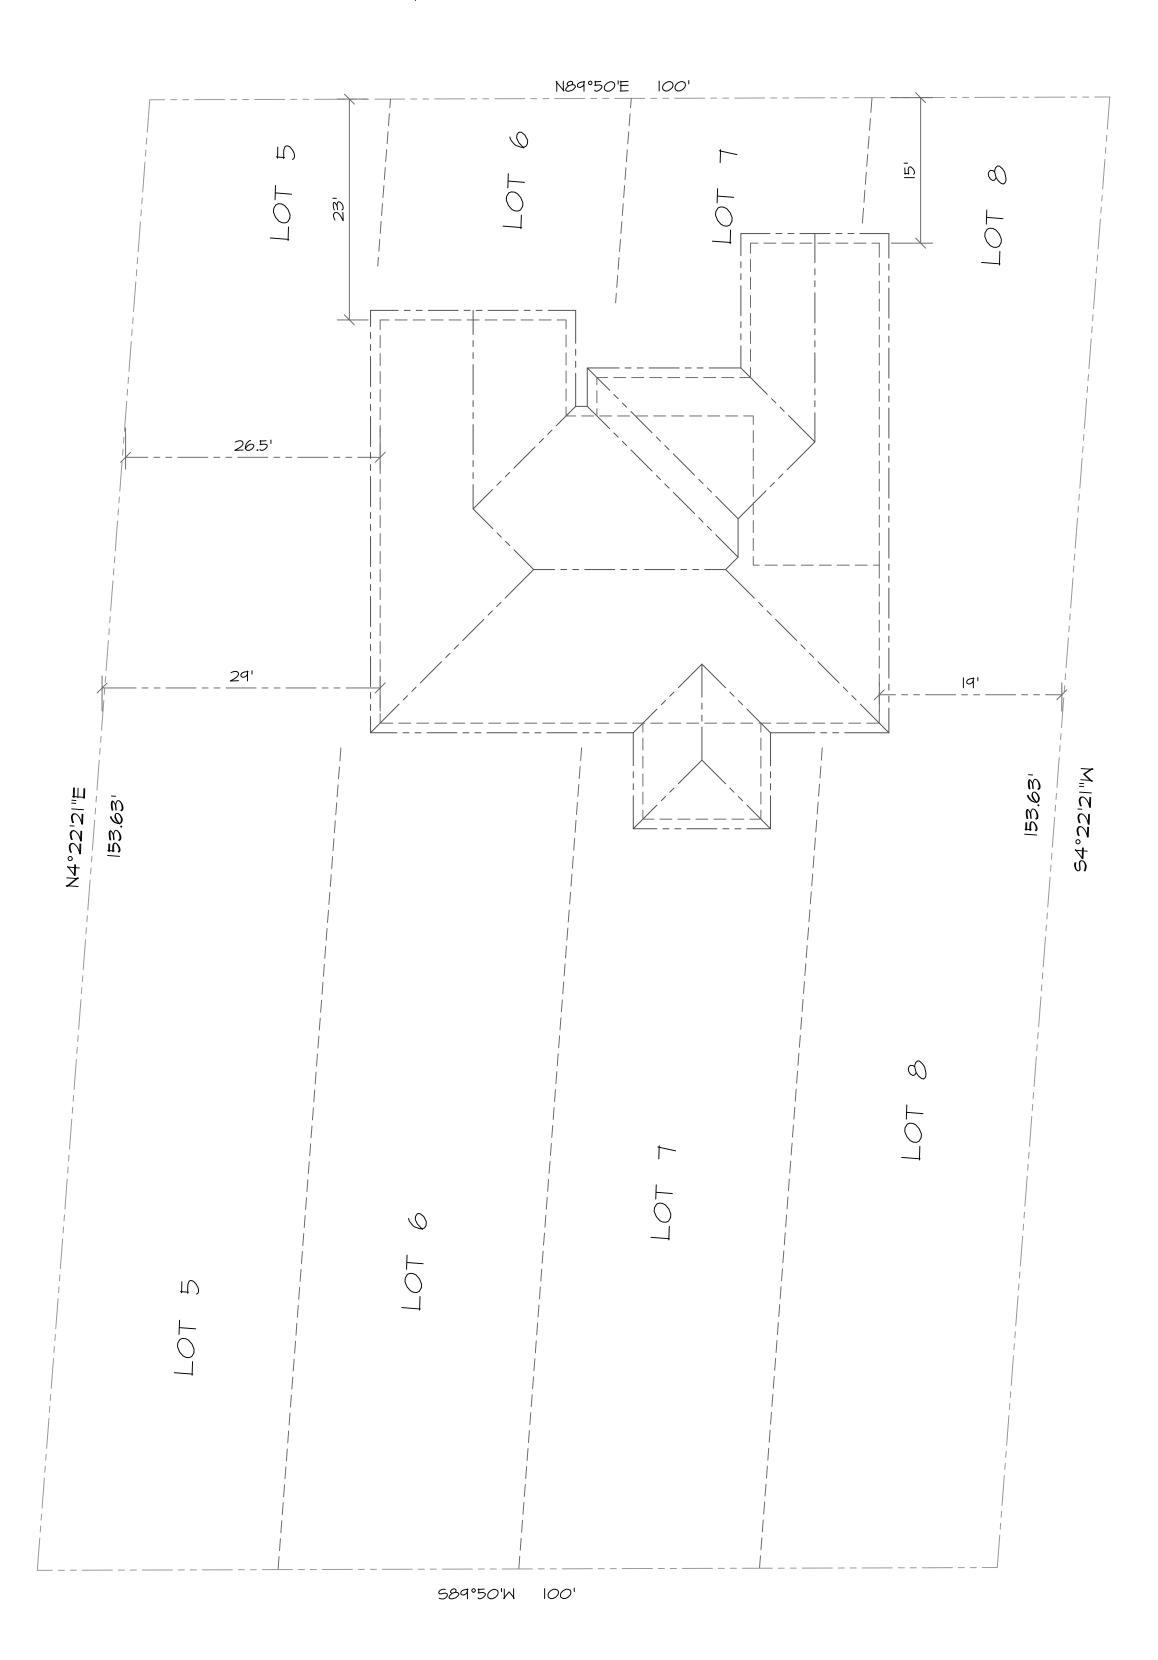


GLADSTONE STREET



SCALE: 1"=10'

GEN. NOTES:

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rafting Design

Residential/ Commercial Drafting,

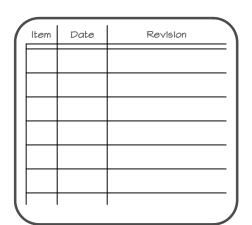
Consultations

Design

401 Pecan Park Dr. Bay St. Louis, MS 39520

Ph. 228-463-1362 Cl. 228-332-1568

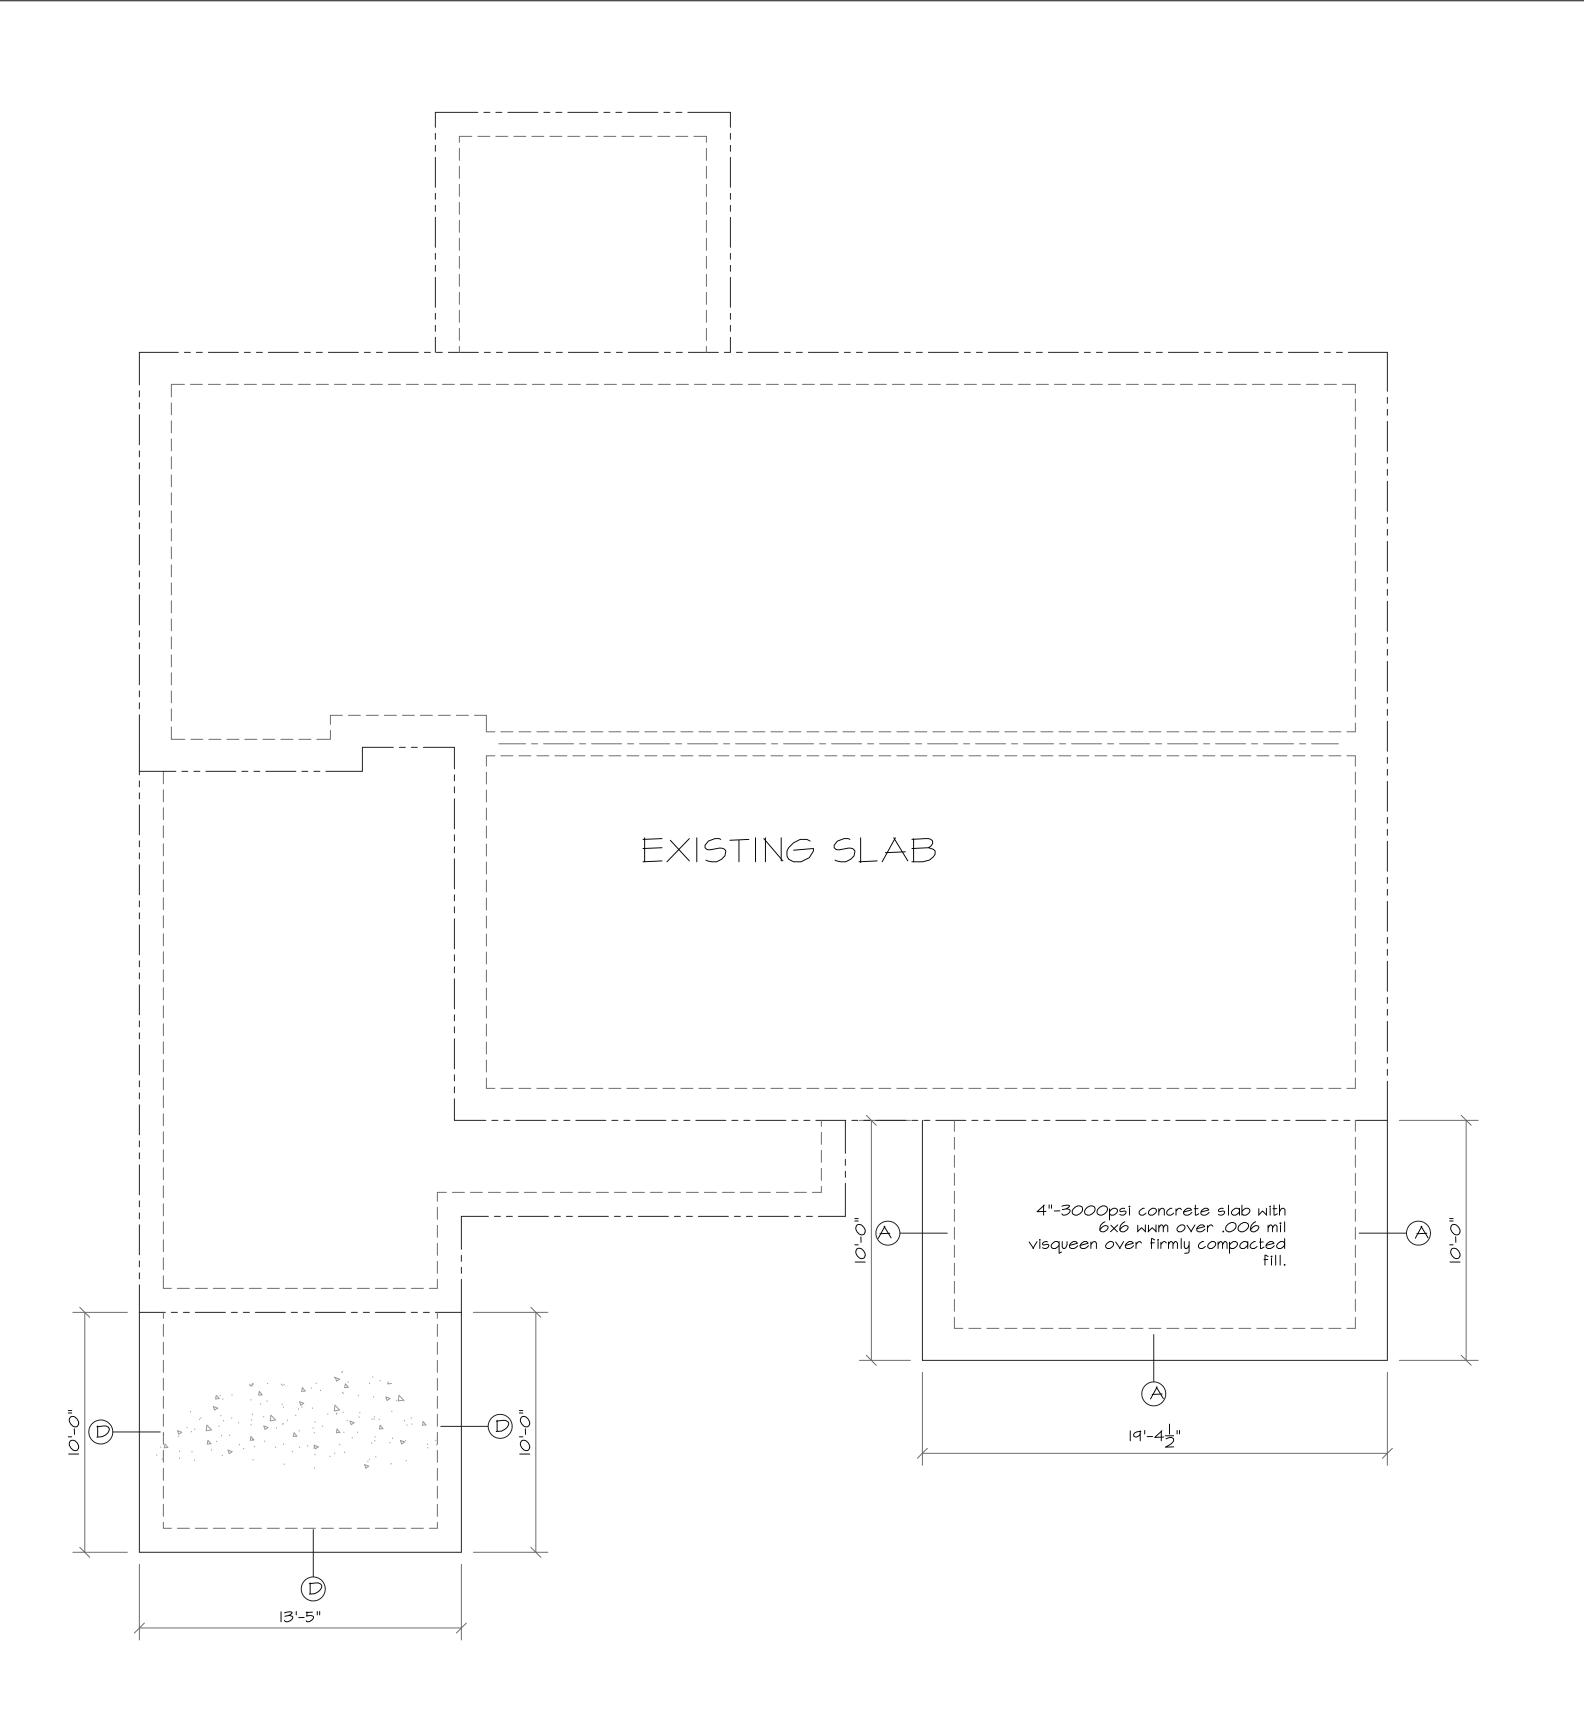
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ommy Higgins Sladstone Stree : Louis, MS 3952

PLOT PLAN

Job Number	151023
Scale:	"= 0"
Date:	23 Oct 2015
Dsgn. by:	RDL
Drawn by:	RDL
Chkd. by:	RDL
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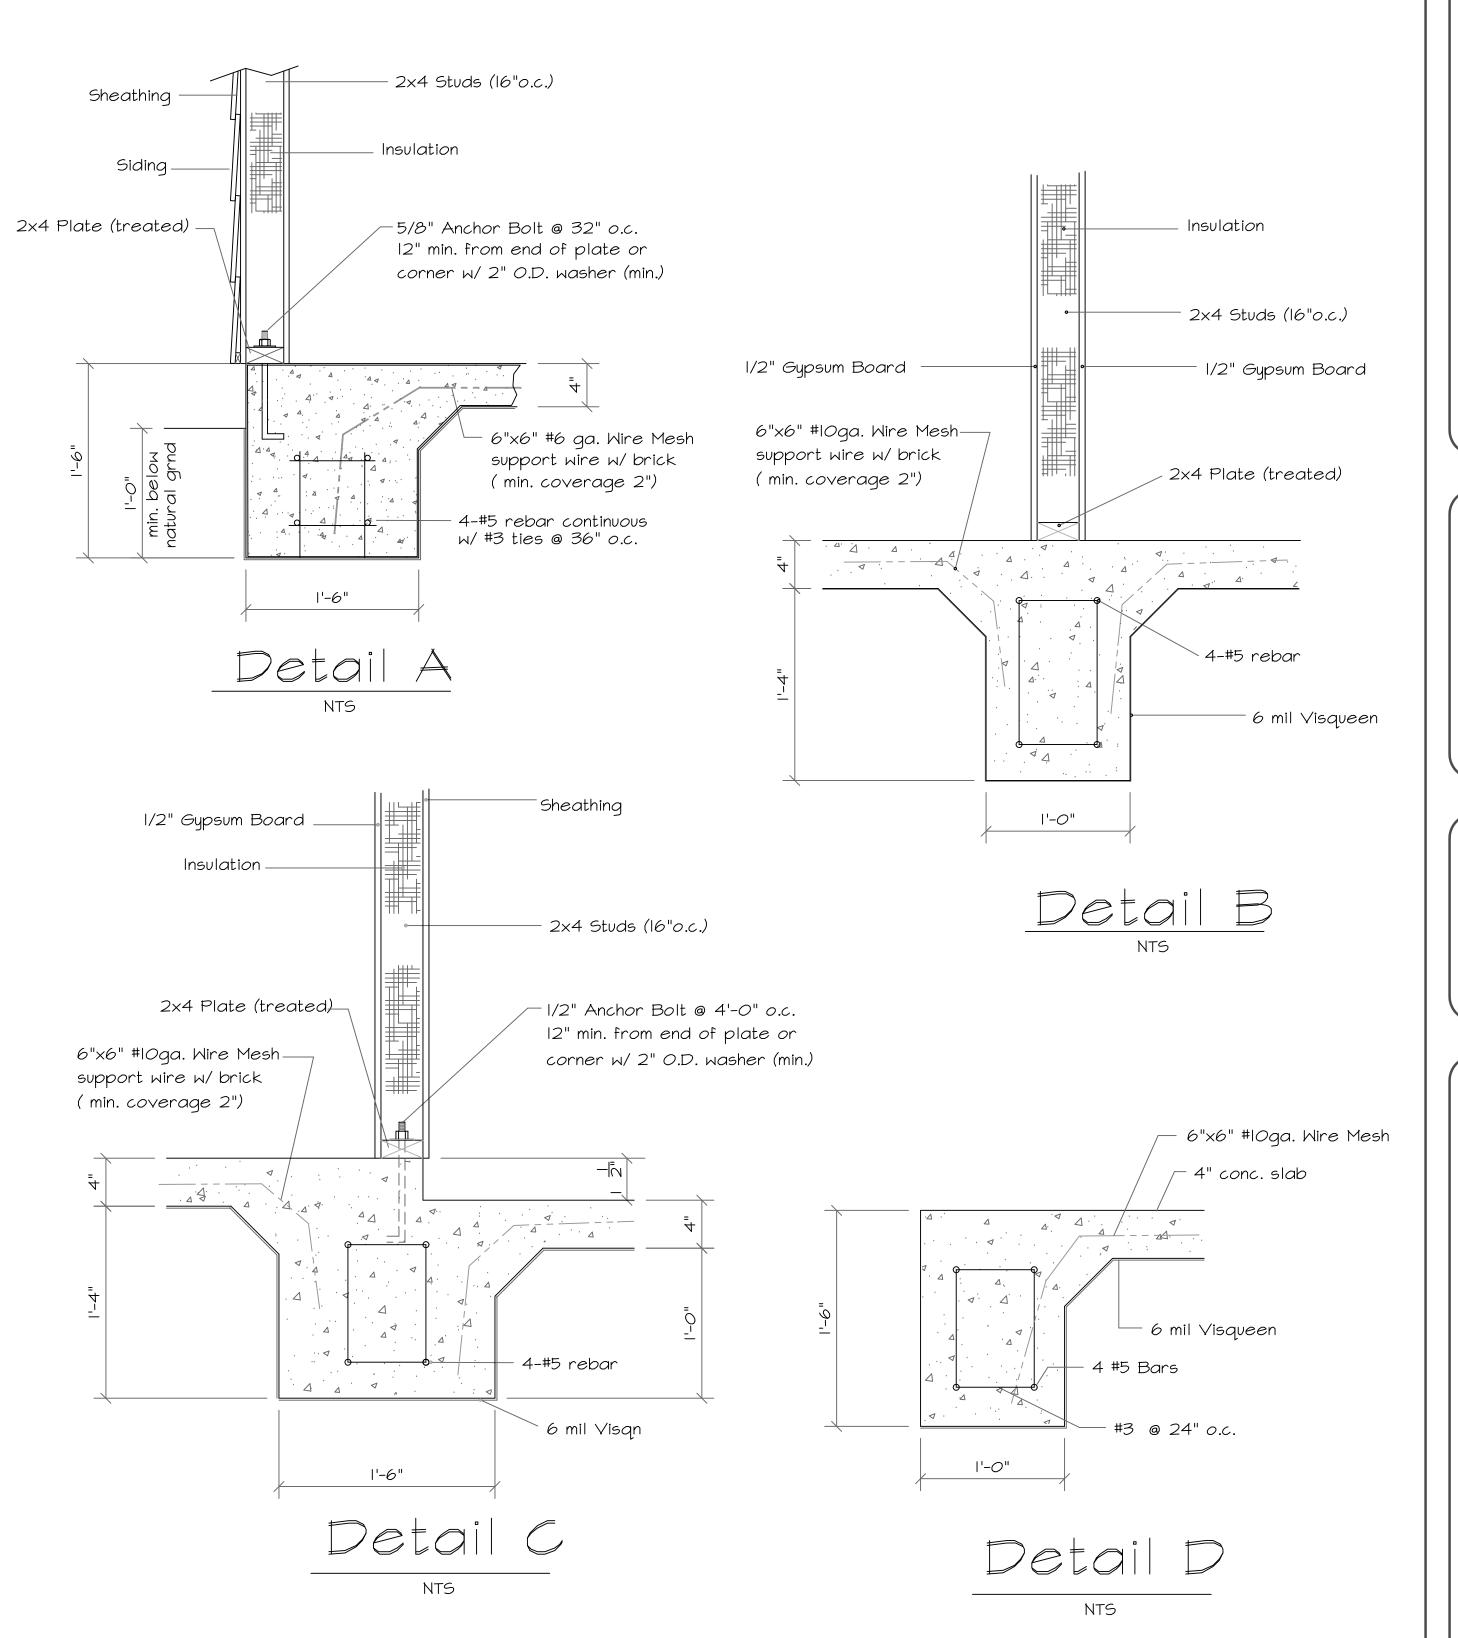
FOUNDATION PLAN

I. Anchor bolts shall be embedded at least 7" deep and spaced not further than 12" from plate ends or corners and not more than 24" on center. Bolts shall have washers with a minimum diameter of 3" and minimum 1/8" thick.

2. Footings must be 12" into natural soil.

NOTES:

3. Sleeve all copper lines under ground through out foundation.



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rafting esign tc.

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Consultations

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Ph. 228-463-1362 Cl. 228-332-1568

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Item	Date	Revision)

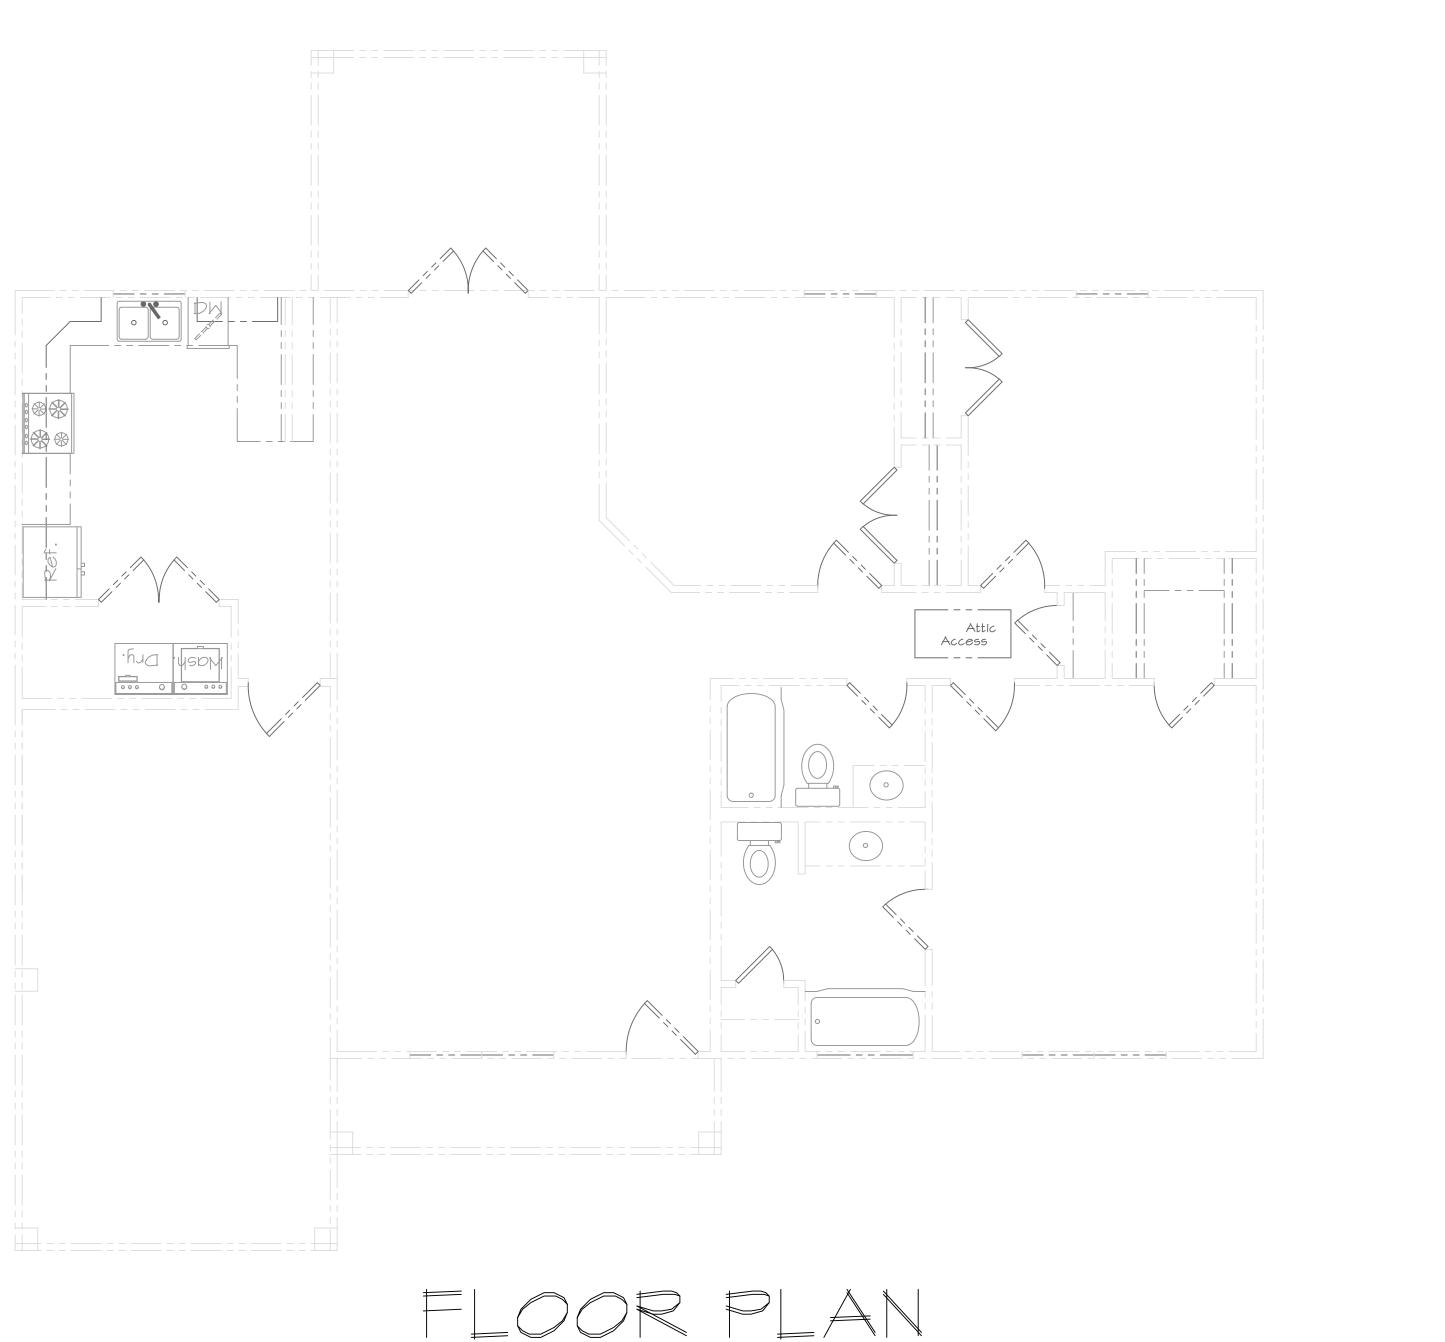
Tommy Higgins

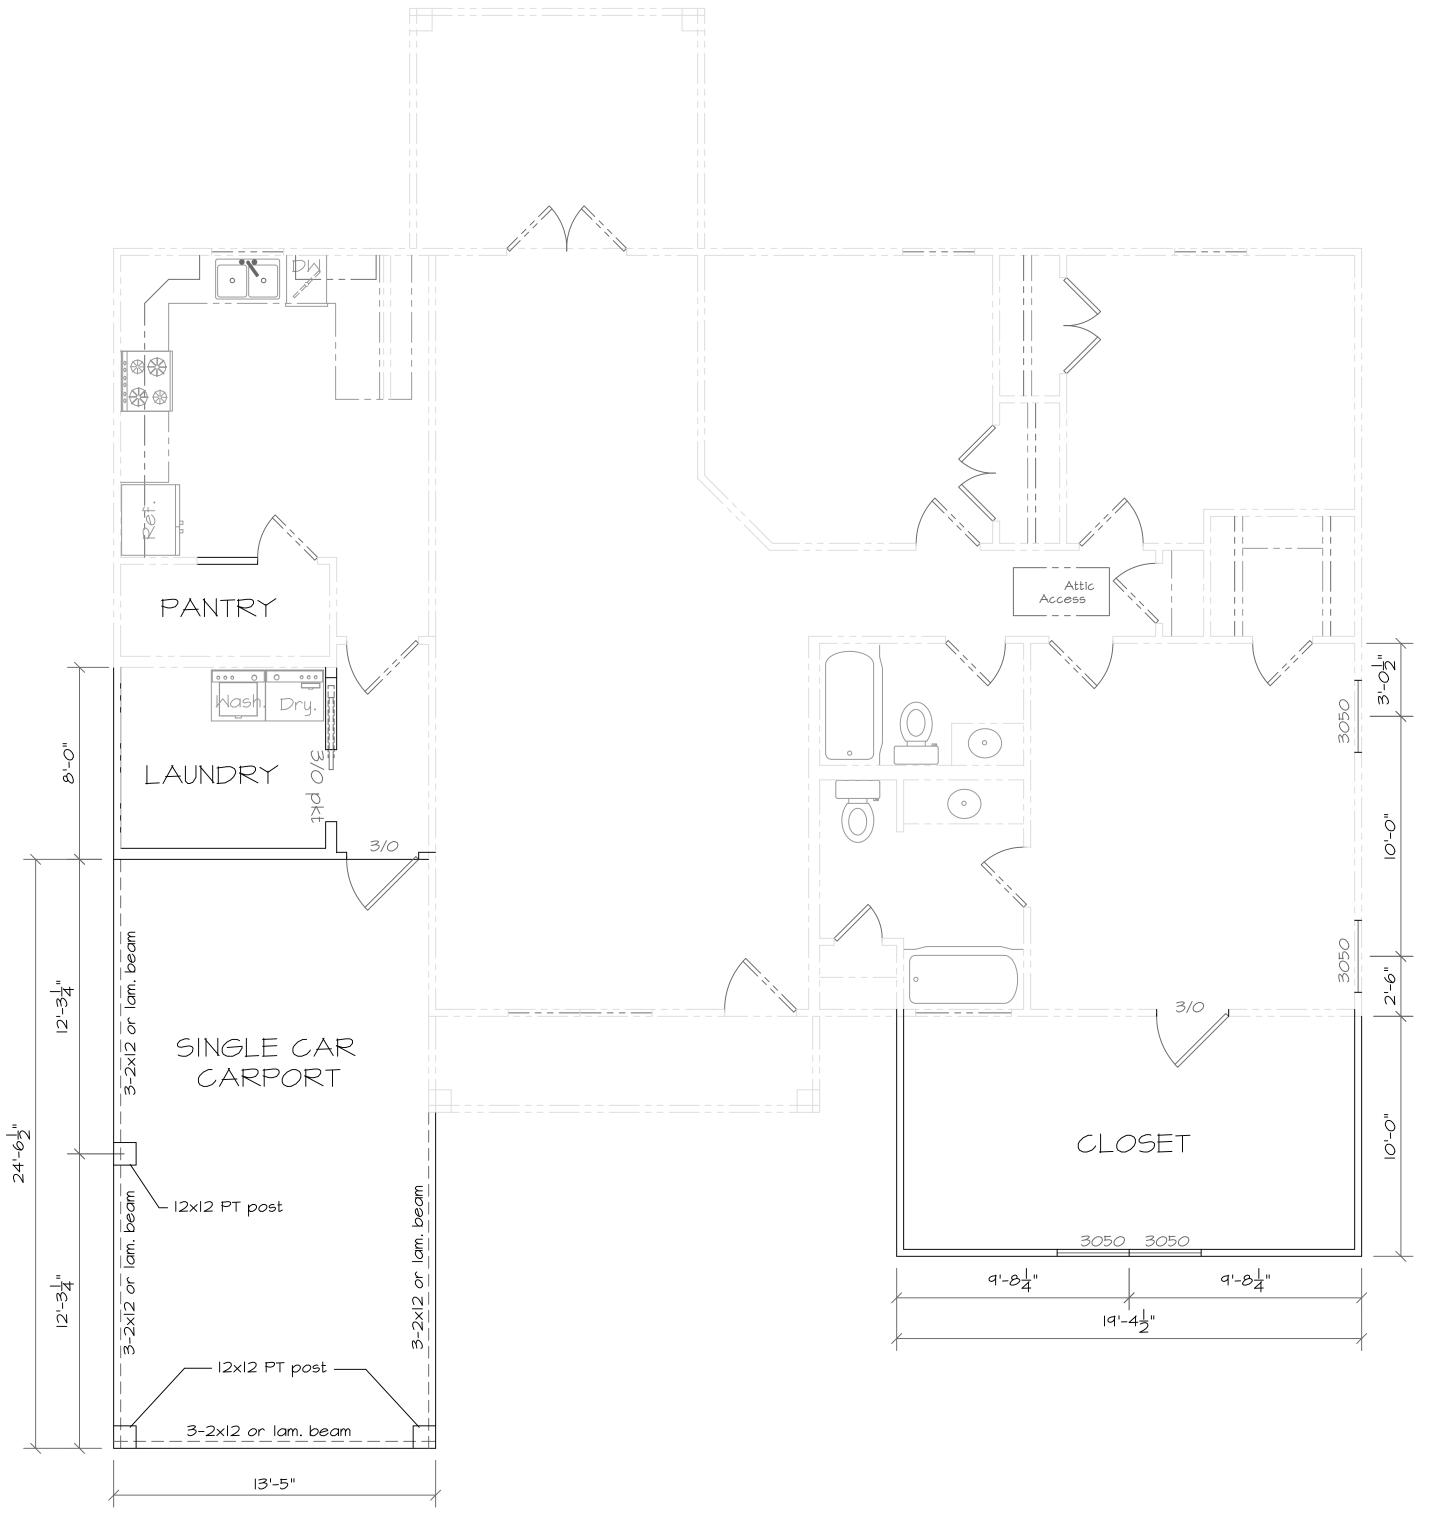
334 Gladstone Street

Bay St. Louis, MS 34520

FOUNDATION

Job Number	151023					
Scale:	/4"= '-0"					
Date:	23 Oct 2015					
Dsgn. by:	RDL					
Drawn by:	RDL					
Chkd. by:	RDL					
	Sheet					
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(EXISTING LAYOUT)

NOTES:

- I. All plumbing walls must be sized according to penetrations.
- 2. All plumbing fixtures shall have access to valves to any slip joints.
- 3. Rise on steps must not exceed 7 and 3/4 inches.
- 4. Attic acces's must be at least 22" by 30" rough opening.
- 5. Crawl space shall have minimum accéss of 18" by 24" cléar opening.
- 6. Equipment in attic must be within 20' of access.
- 7. Must have clear walkway of 24" wide and have 30" on the service of all equipment including hot water heater.
- 8. Bathrooms with mechanical means of ventilation must be vented to the exterior.
- 9. Motors to whirlpool tubs must be accessible.
- 10. Windows and doors must be minimum 27" from corners on an 8' wall and 34" on a 10' wall.
- II. Roof bracing must be done to a load bearing wall.
- 12. A copy of all truss engineering must be submitted to inspectors office, this includes installation instructions.

- 13. Guardrail required if more than 30" above grade.
- 14. Treated matérials are required below BFE.
- 15. Unless otherwise approved in advance, all garage door headers with a minimum span of 16' must be 3.5" by 11" laminated beam or its equivalent. Double 2" by 12" will not be accepted.
- 16. Interiór load bearing walls must be properly anchored.
- 17. Sleeve copper lines under ground through out foundation.
- 18. Window size requirements for emergency means of egress includes minimum 24" in héight and 21" in clear width when in the open position. Minimum 5 sq. ft.. at grade level and 5.7 sq. ft.. above grade.
- 19. 8% of each habitable room floor space for light and vent required.
- 20. Plywood roof sheathing must not be less than 2' in width.
- 21. Ridge vents shall not run within 4' of ridge end unless manufacturer states otherwise.
- 22. Connectors to meet galvanized requirement as per Code. (Z-max Or equivalent)

FLOOR PLAN

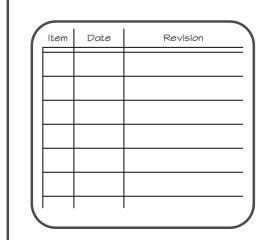
(NEW ADDITIONS)

Residential/ Commercial Drafting, Design

Consultations 401 Pecan Park Dr

Bay St. Louis, MS 39520

Ph. 228-463-1362 Cl. 228-332-1568



FLOOR PLAN

	Job Number:		15	1023	
	Scale:		1/4"=	= '-0'	
	Date:	23	Oct	2015	
	Dsgn. by:			RDL	
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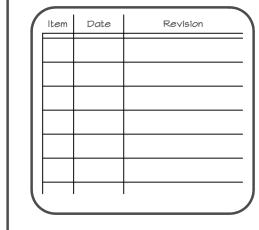
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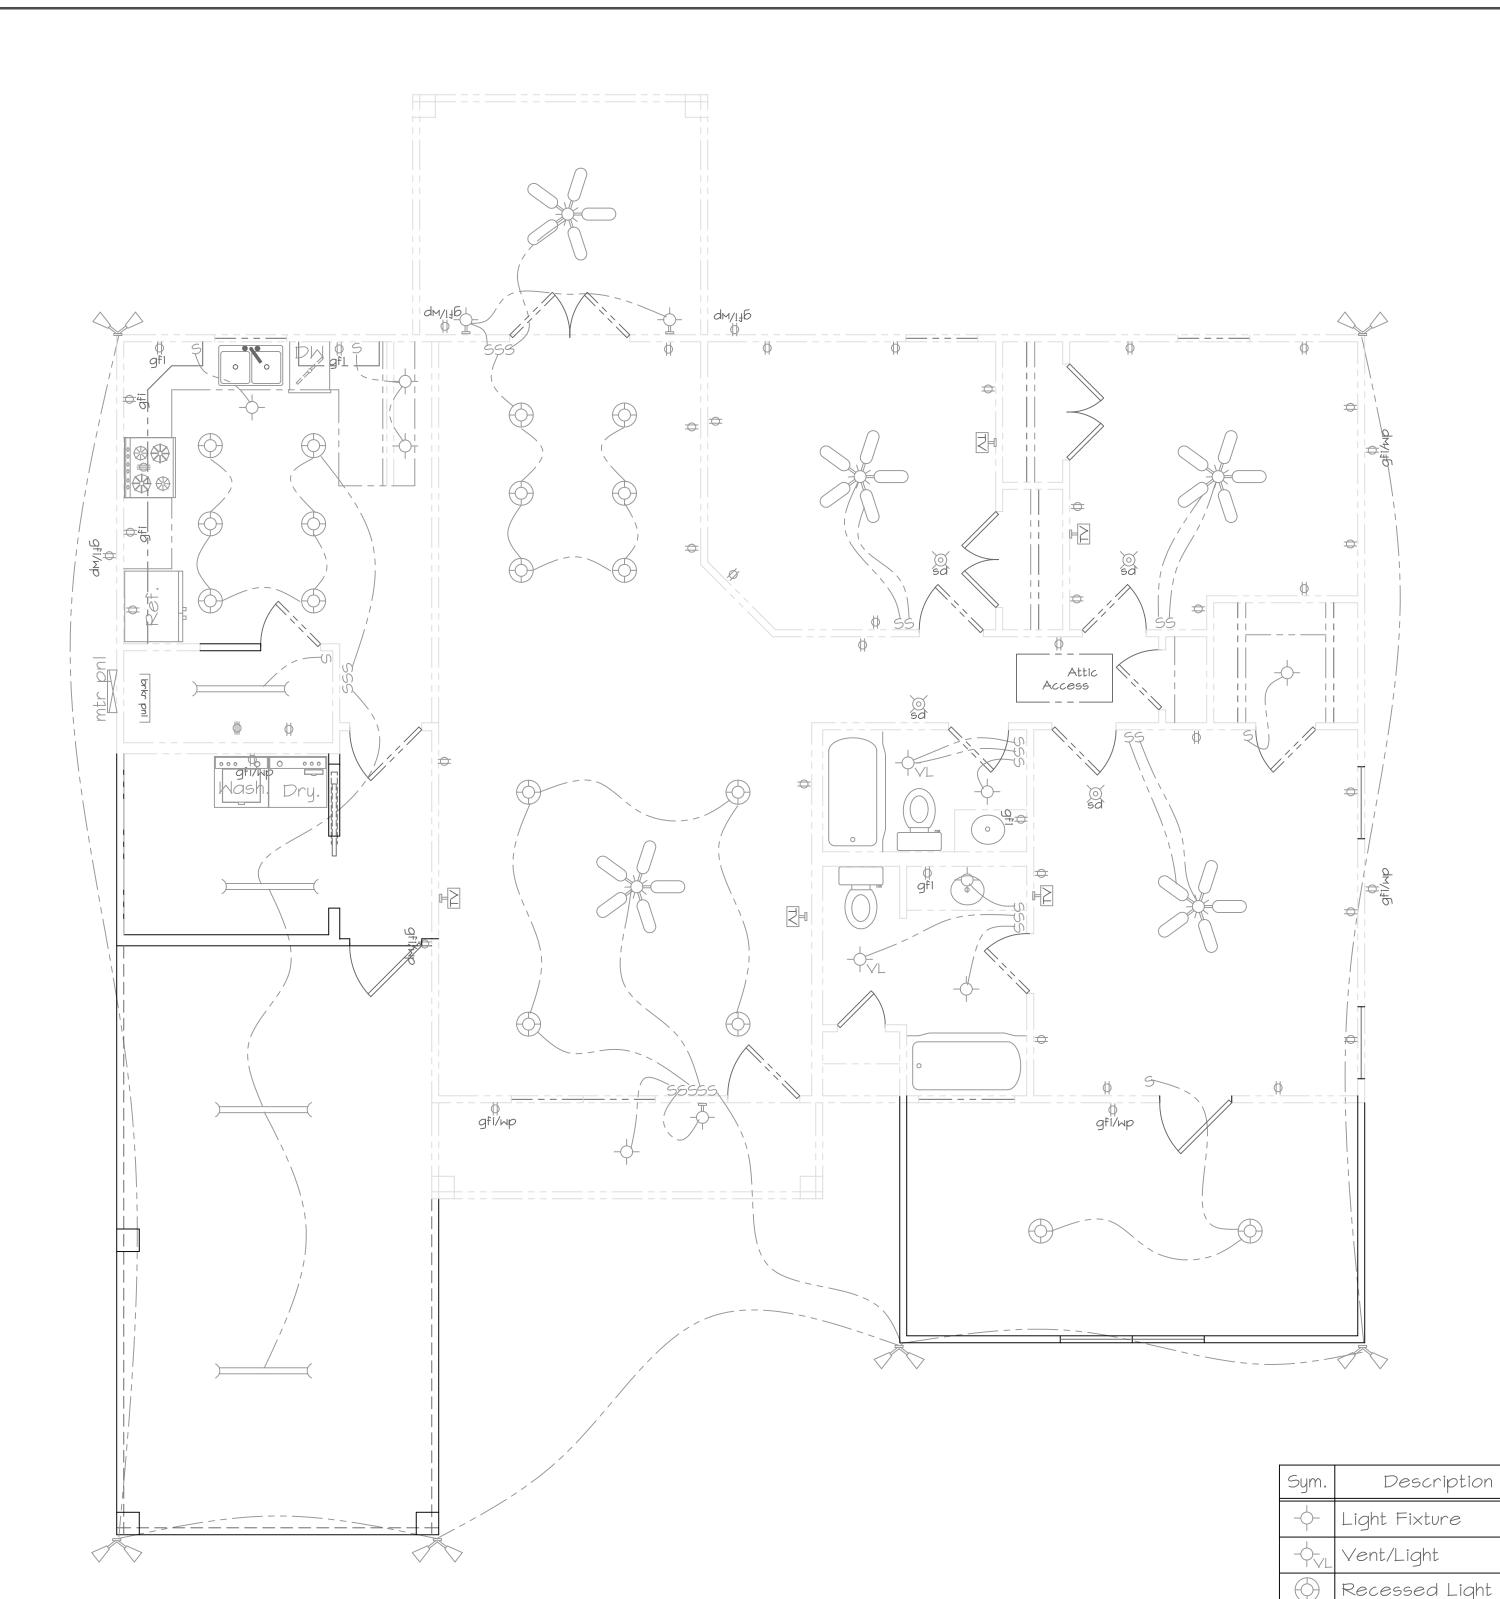
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334 Gladstone Street
ay St. Louis, MS 39520

ELEVATIONS

Job Number: 151023
Scale: 1/4"=1'-0"
Date: 23 Oct 2015
Degn. by: RDL
Drawn by: RDL
Chkd. by: RDL



ELECTRICAL PLAN

Wall Mount Light

Exterior Flood Light

IIO outlet

/ Wiring

Doorbell

Ceiling Fan

220 outlet

Flourescent Light

110 outlet/ground fault

gfi/wp 110 outlet/gfi/wtrproof

Smoke Detector

Television Outlet

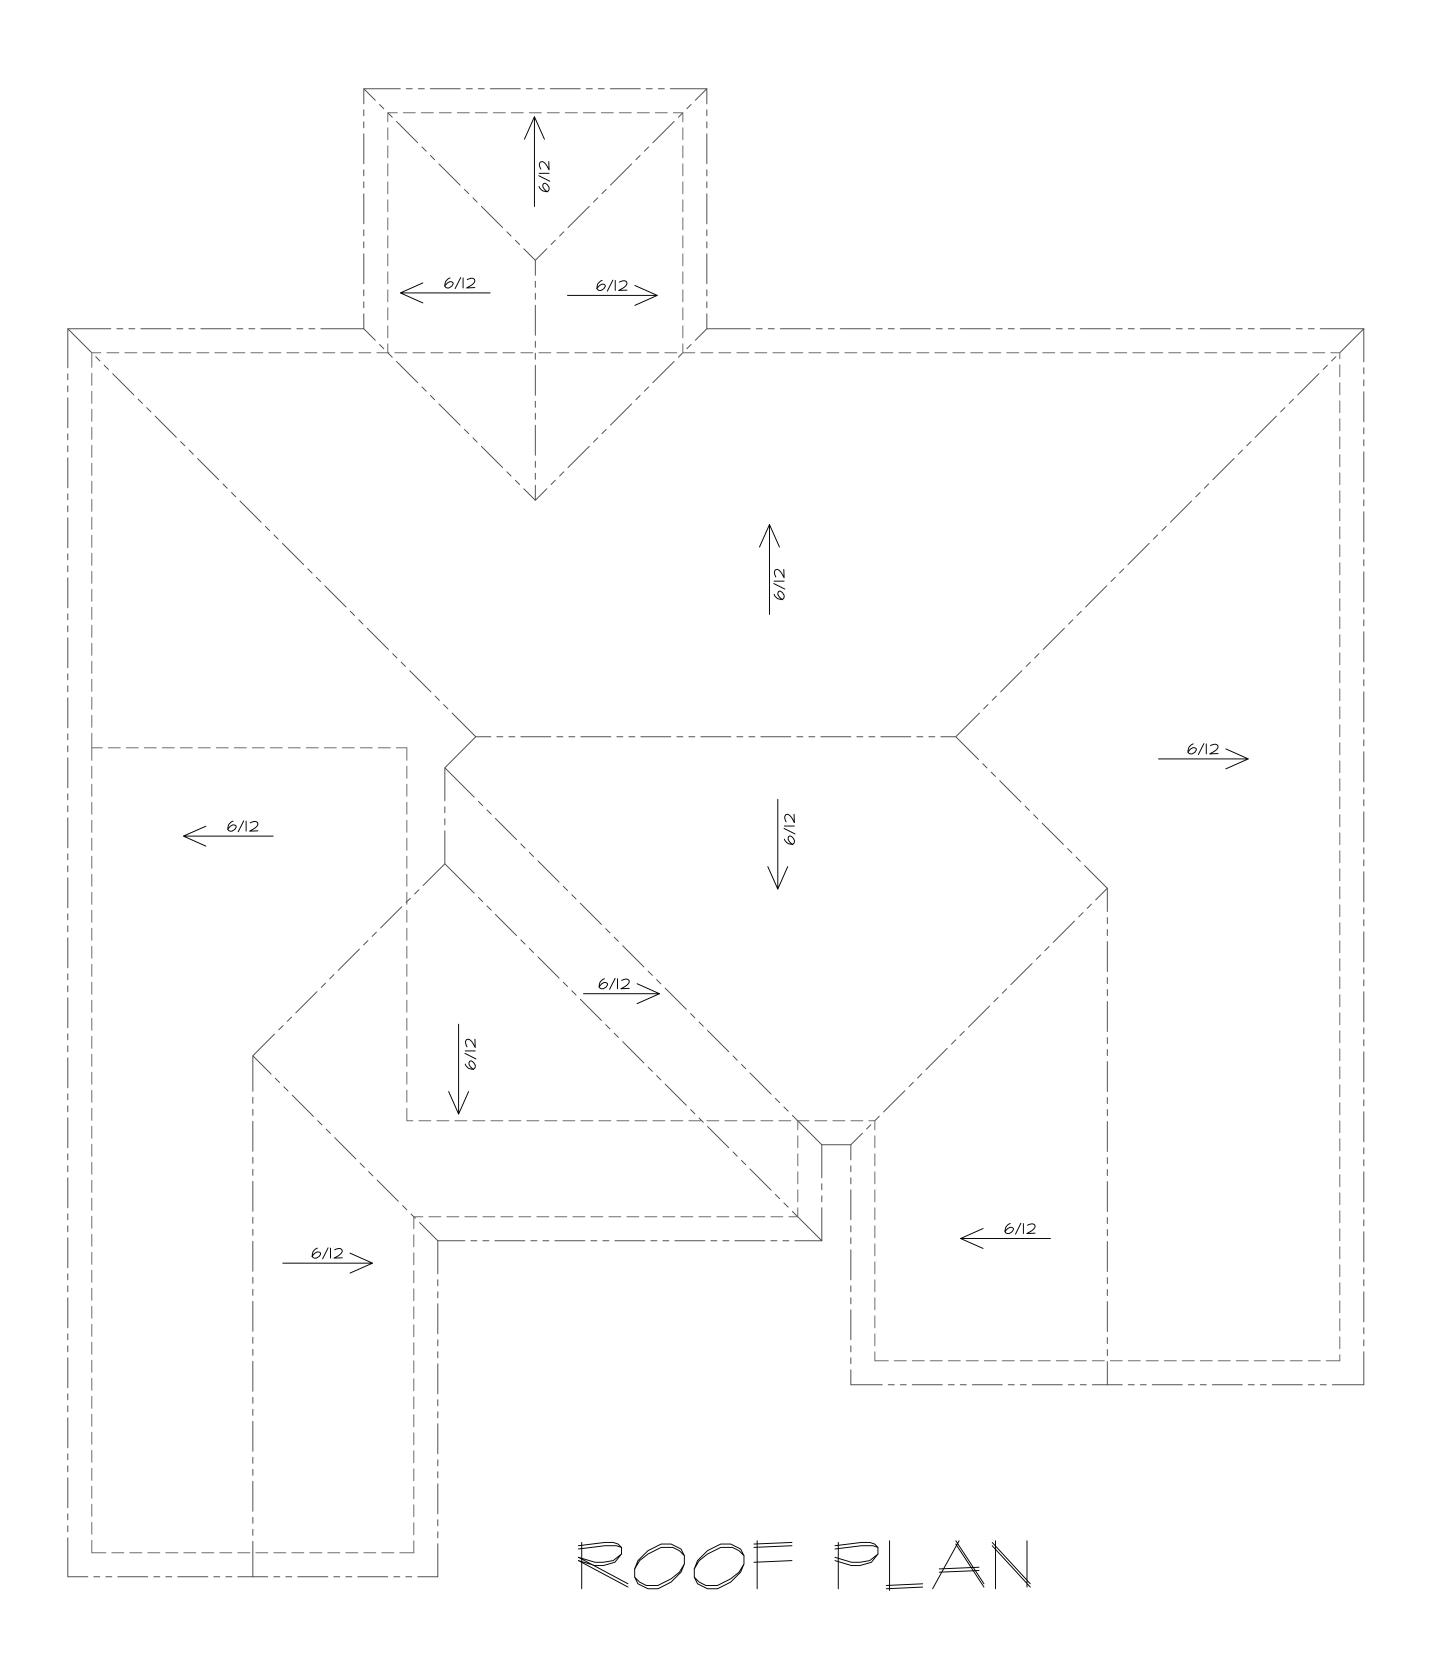
Telephone Outlet

NOTES:

- I. All receptacles serving kitchen counters must be GFI, and spaced according to Sec. 3802.6.
- 2. Island or peninsular counters shall have a GFI recpt. Sec 3801.4.3
 3. One and two family residences shall have a minimum of two outside
- GFI receptacles on the front and rear of house. Sec 3801.7
- 4. Smoke détectors are required in all residences as per Section 317. 5. Motors to whirlpool tubs must be accessible.
- 6. All bedroom outlets shall be arc-fault protected.
- 7. Any electrical below the BFE must be for a wet location.

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Residential/ Commercial Drafting, Design

401 Pecan Park Dr Bay St. Louis, MS

39520

Consultations

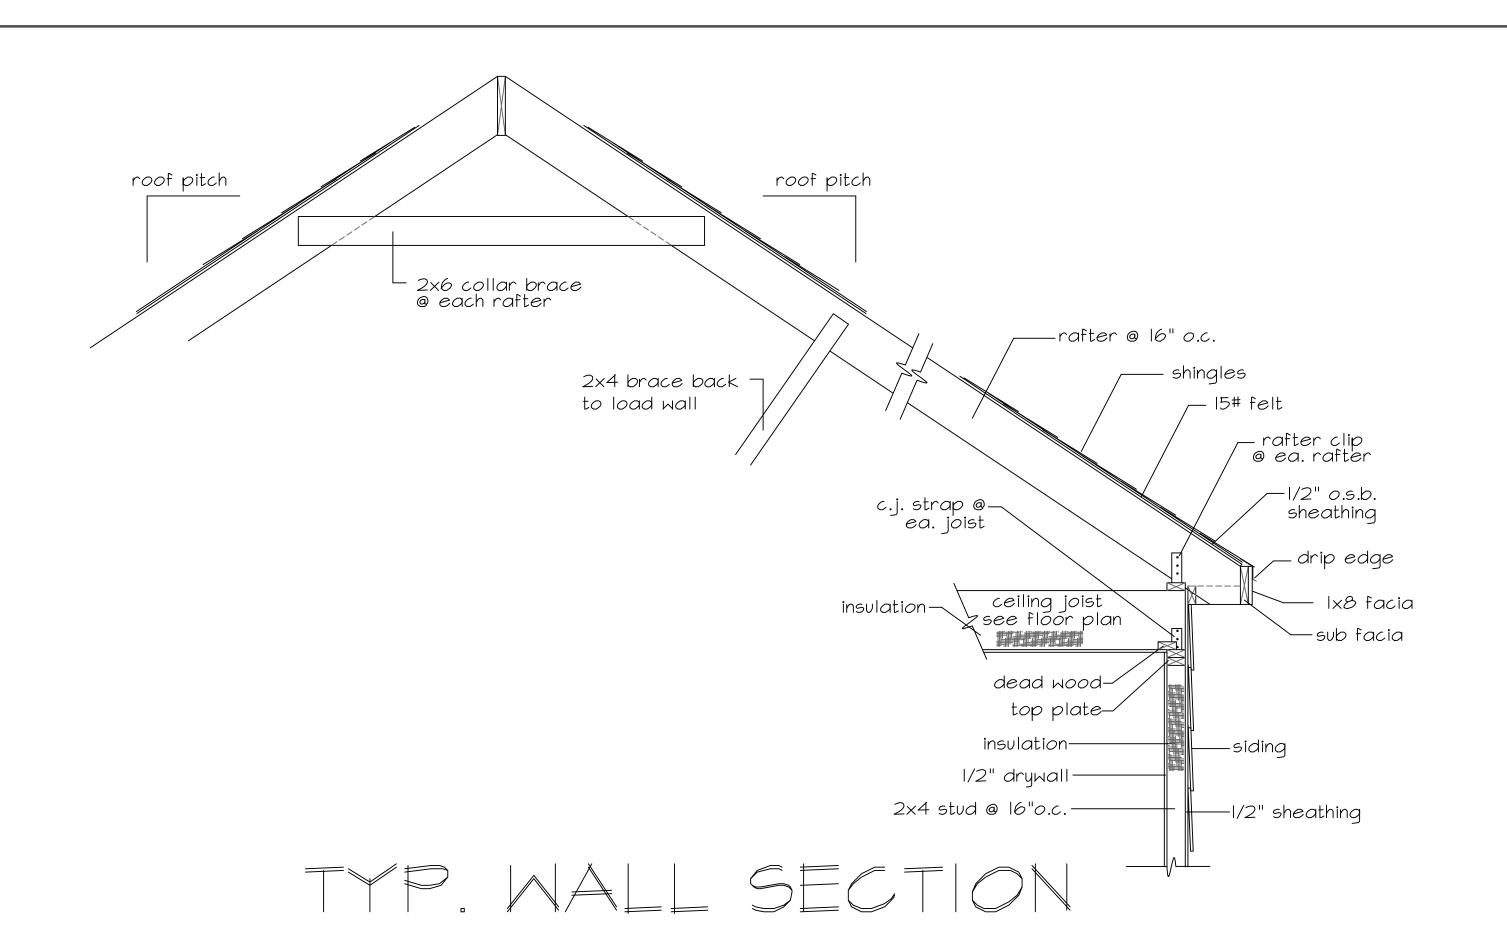
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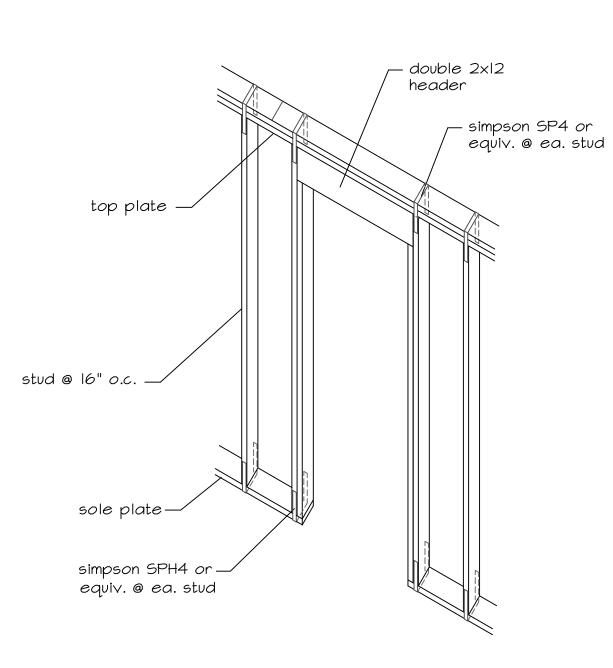
ELEC/ROOF

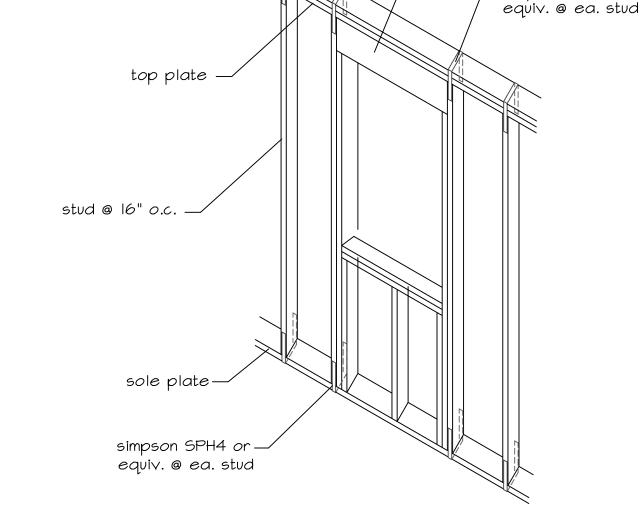
151023 |/4"=|'-0" 23 Oct 2015 Sheet



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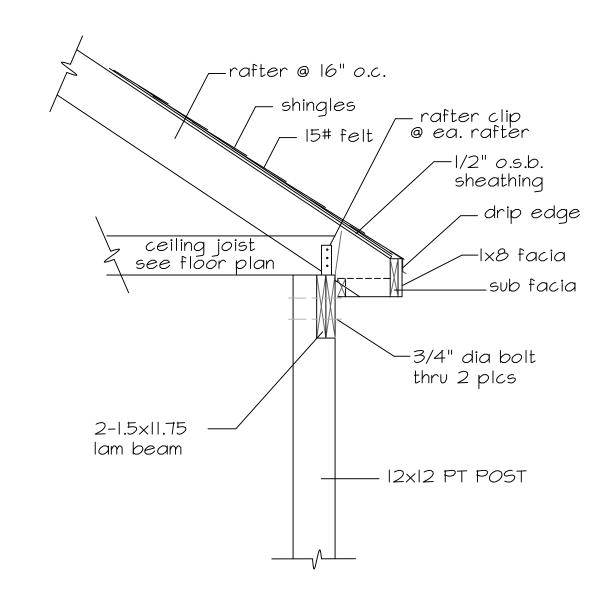
— double 2x12

— simpson SP4 or

header

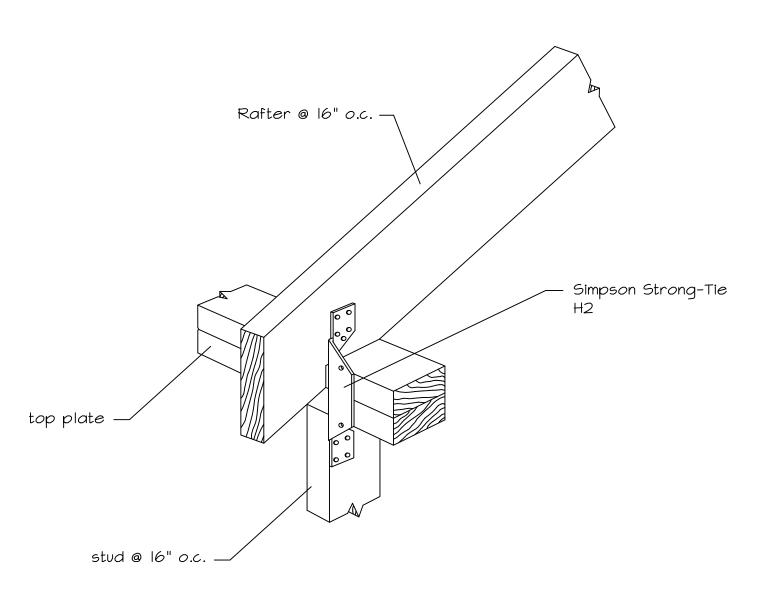
Door Opening Detail

Mindow Opening Detail

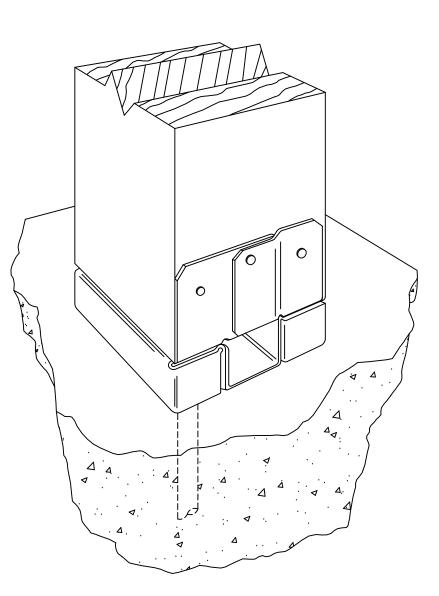


POST/BEAM CONNECTION

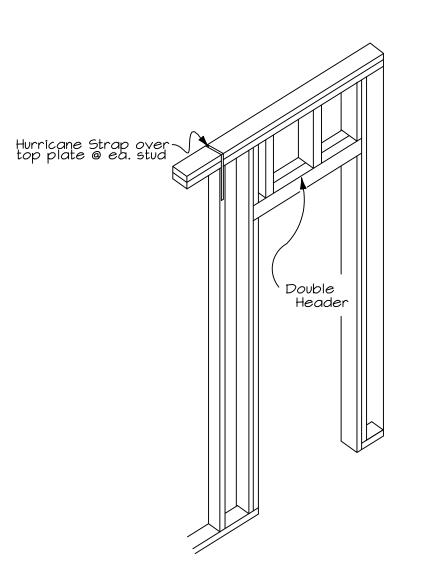
NTS



Rafter Connection Detail



Simpson Strong-Tie ABA44



Door Opening Detail (Interior)

NTS

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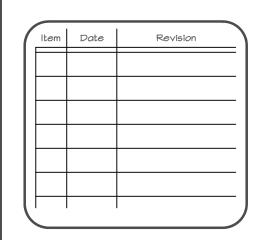
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DETAILS

Date: 23 Oct 2015
Dsgn. by: RDL
Drawn by: RDL
Chkd. by: RDL