PROJECT TIMBER WOLF

BAXTER, MN

100% CD

PROJECT LOCATION—

PROJECT CONTACTS

DEVELOPER RYAN A+E, INC. 533 SOUTH THIRD STREET, SUITE 100 MINNEAPOLIS, MN 55415 952-807-2120 eddy.wolf@ryancompanies.com

GENERAL CONTRACTOR RYAN COMPANIES US, INC. 533 SOUTH THIRD STREET, SUITE 100 MINNEAPOLIS, MN 55415 JORDAN DALLUGE

jordan.dalluge@ryancompanies.com

175 MONTROSE WEST AVE., SUITE 400 AKRON, OH 44321 JANINE NUNFIO janine.nunfio@cescoinc.com

STRUCTURAL WALLACE DESIGN COLLECTIVE 123 N MARTIN LUTHER KING JR BLVD

918-584-5858 matt.gebhardt@wallacedesign.com

RYAN A+E, INC. 533 SOUTH THIRD STREET, SUITE 100 MINNEAPOLIS, MN 55415 612-492-4447 jared.olson@ryancompanies.com

CIVIL ENGINEER

LANDSCAPE ARCHITECT RYAN A+E, INC. 533 SOUTH THIRD STREET, SUITE 100 MINNEAPOLIS, MN 55415 JUSTIN BAGGENSTOSS justin.baggenstoss@ryancompanies.com

SURVEYOR 12701 WHITEWATER DR, SUITE 300 MINNETONKA, MN 55343 chris.ambourn@westwoodps.com

MECHANICAL HP ENGINEERING 5504 W PINNACLE POINT DR, SUITE 200 bpeace@hpengineeringinc.com

Existing elevations and ground contours shown hereon are based on the NAVD88 vertical datum relative to Benchmark: WHIPPLE, which has an elevation of 1209.62 feet.

Bearings of property lines shown hereon are based on the Hennepin coordinate system, (NAD 83 - 11 Control Adjustment)

CITY OFFIC	IALS
MAYOR:	DARRELL OLSON
CITY COUNCIL:	MARK CROSS
	CONNIE LYSCIO
	ZACH TABATT
	JEFF PHILLIPS
UTILITIES COMMISION	ROCK YLINIEMI - CHAIR
	JACK CHRISTOFFERSON
	DOUGLAS STENBERG
	JOHN BRENNY
CITY ADMINISTRATOR	BRADLEY CHAPULIS
PUBLIC WORKS DIRECTOR / CITY ENGINEER	TREVOR WALTER
APPROVA	\LS
RECOMMENDED FOR APPROVAL CITY CONSULTING E	ENGINEER DATE
RECOMMENDED FOR APPROVAL	ECTOR / CITY ENGINEER DATE



VICINITY MAP NOT TO SCALE

SH	1EET	IN	DEX
		C001	COVER SHEET
		C100	SURVEY
		C101	EXISTING CONDITIONS & REMOVALS PLAN
		C102	EXISTING CONDITIONS & REMOVALS PLAN
		C200	EROSION CONTROL PLAN
		C201	EROSION CONTROL PLAN
		C300	SITE PLAN
		C301	SITE PLAN
		C400	GRADING PLAN
		C401	GRADING PLAN
		C402	PAVING PLAN
		C403	PAVING PLAN
		C404	PAVING PLAN
		C405	PAVING PLAN
		C500	UTILITY PLAN
		C501	UTILITY PLAN
		C600	DETAILS
		C601	DETAILS
		C602	DETAILS
		C603	DETAILS
		C604	DETAILS
		C605	DETAILS
		C606	DETAILS
		C607	DETAILS
		C608	DETAILS
		L001	LANDSCAPE TITLE SHEET
		L100	OVERALL SITE LANDSCAPE REFERENCE PLAN
		L200	SITE LANDSCAPE LAYOUT & SURFACING PLAN
		L400	OVERALL SITE LANDSCAPE TREE PLANTING PLAN
		L401	ENLARGED PLANTING PLAN DETAIL-NORTH
		L500	LANDSCAPE DETAILS
DRAV	VING INDEX	LEGEN	ND
	— FILLED CIRCLE INI — MOST RECENT RE MOST RECENT ISS	EVISION NUME	
 	X/XX/20XX	CX	SHEET TITLE

RYAN A+E, INC. 533 South Third Street, Suite 100 Minneapolis, MN 55415 612-492-4000 tel 612-492-3000 fax

WWW.RYANCOMPANIES.COM

OWNER

CONSULTANTS

PROJECT INFORMATION

PROJECT TIMBER WOLF

BAXTER, MN

I hereby certify that this plan, specification, or report was prepared by me or under my direct supervision and that I am a duly Licensed Professional Engineer under the laws of the State of Minnesota

JARED B. OLSON

REGISTRATION NO.

DRAWN BY

© 2022 RYAN A+E, INC.

ISSUE RECORD


CHECKED BY

06/18/2024

ISSUE #	DATE	DESCRIPTION
1	05/07/2024	90% CD SET
2	05/24/2024	100% CD SET
3	06/18/2024	CITY RESUBMITTAL

100% CD

COVER SHEET

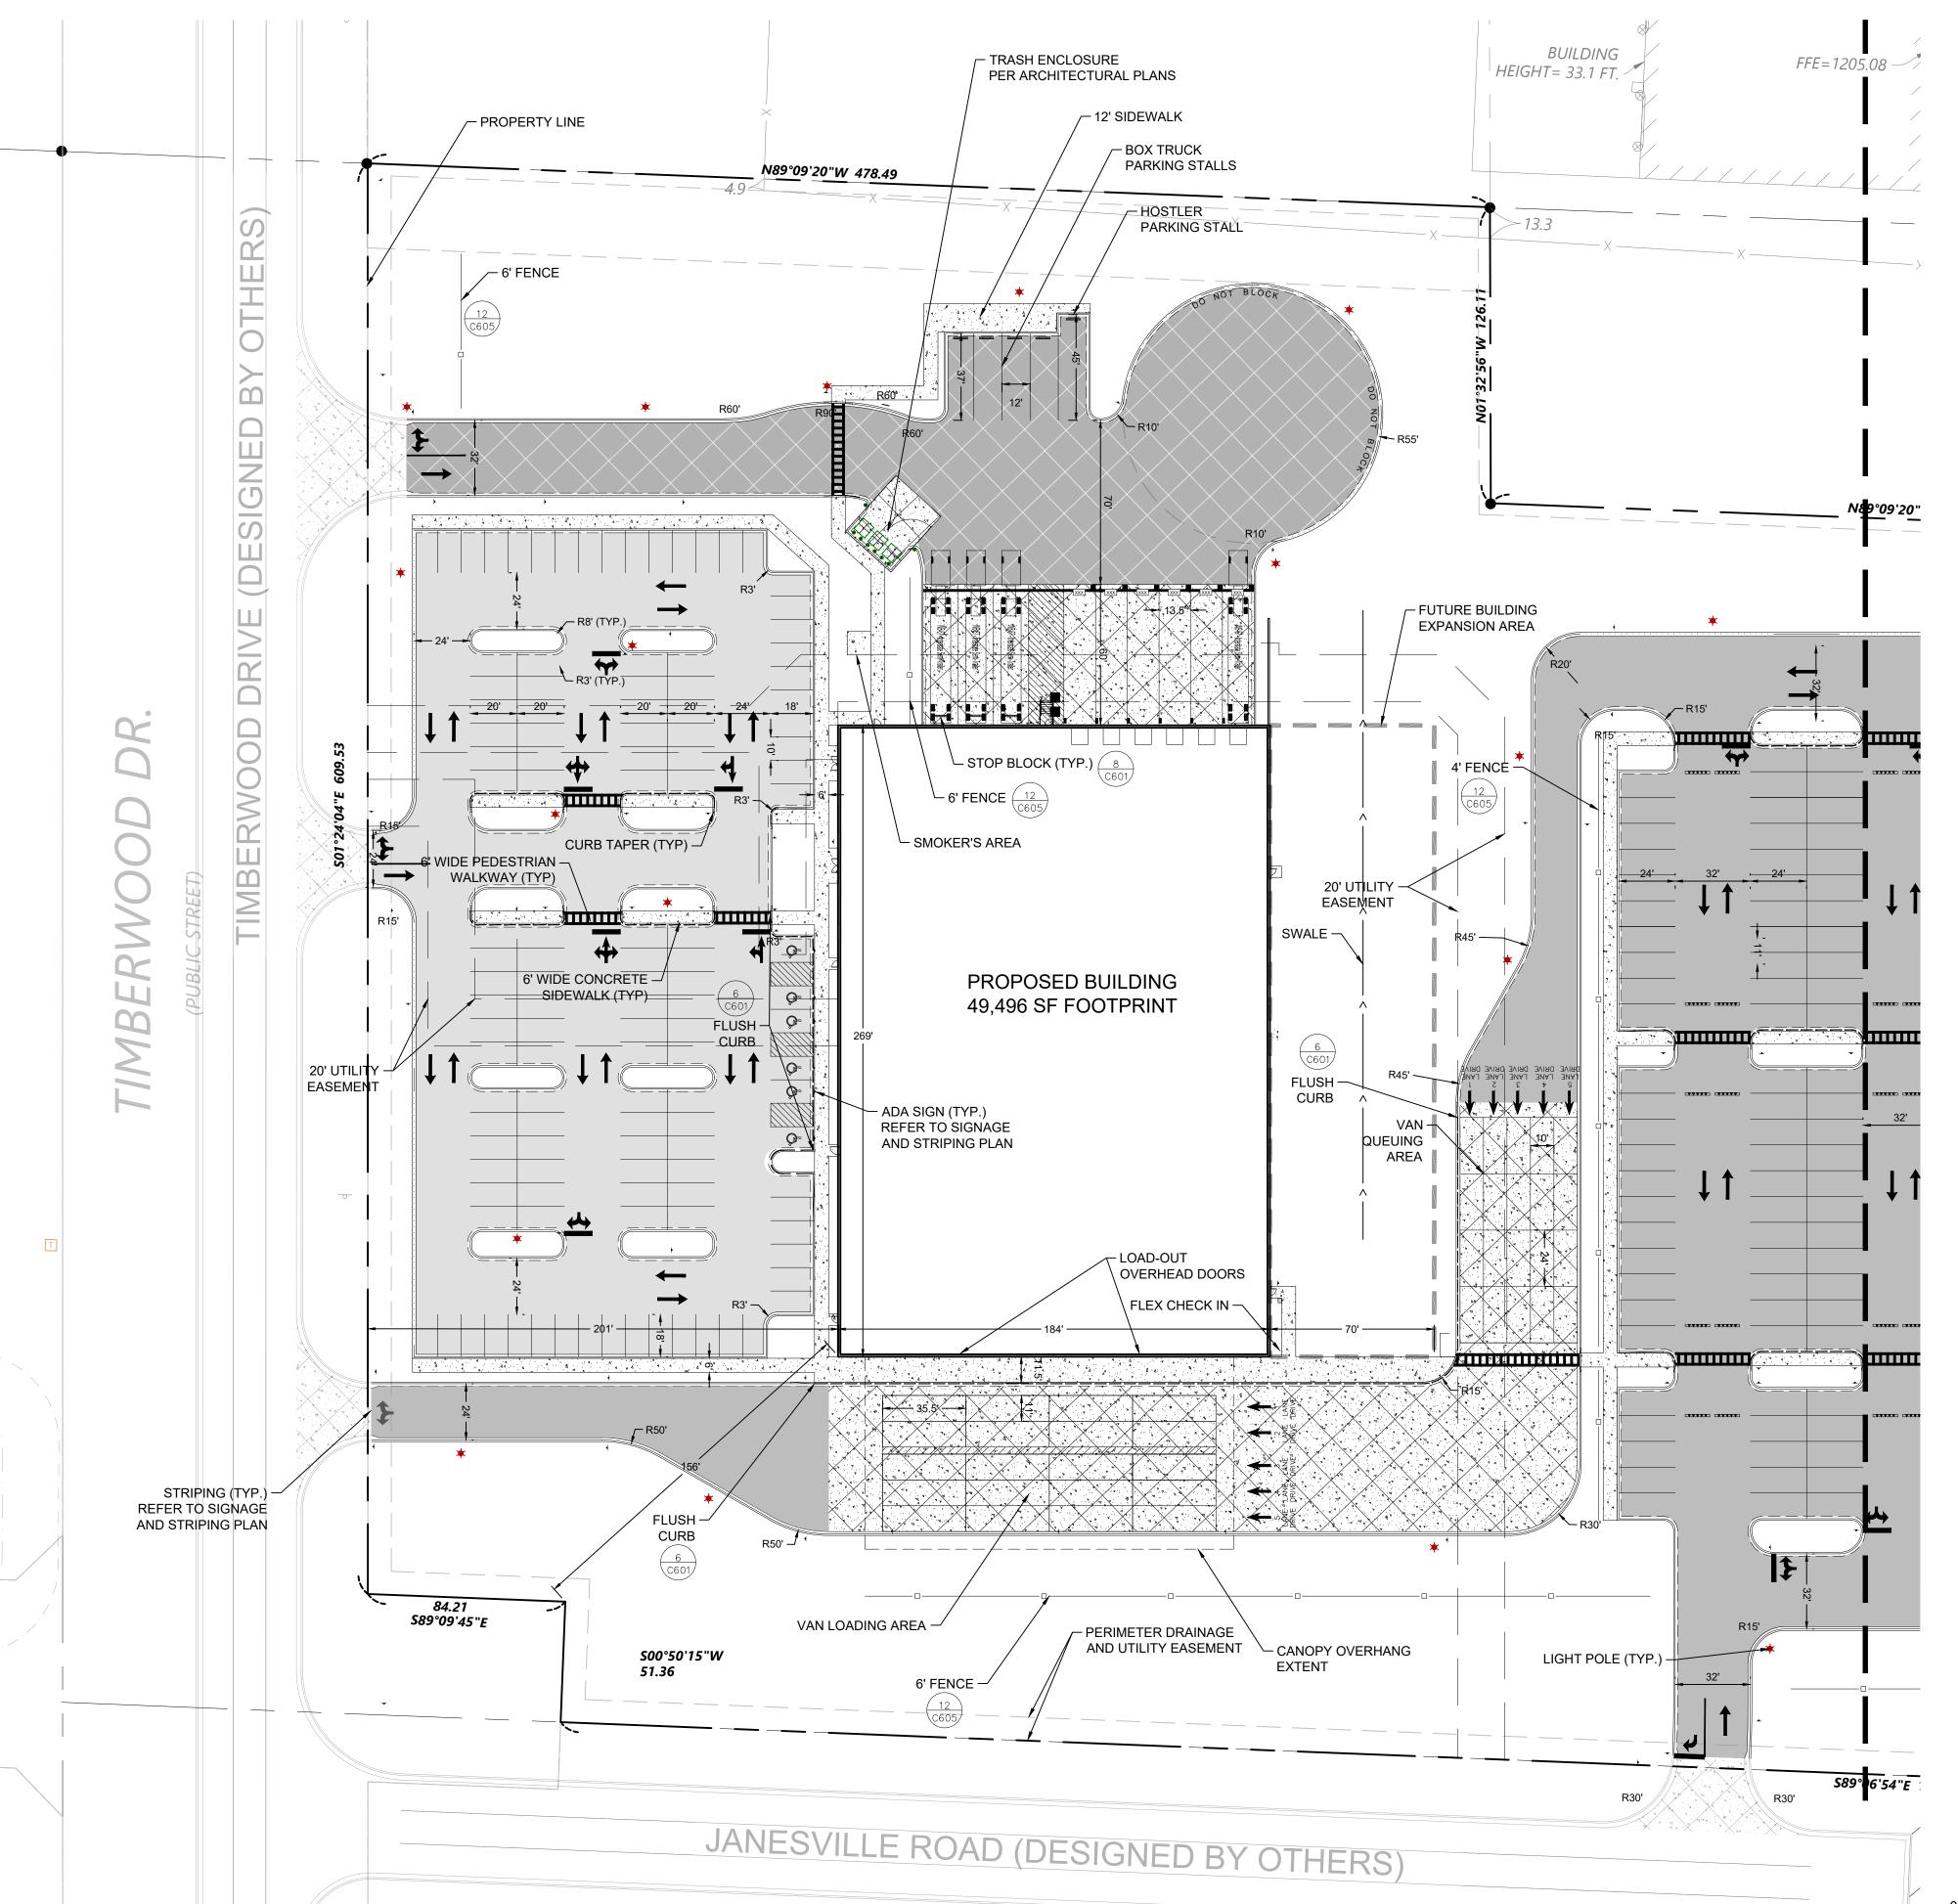

SITE NOTES

- CONTRACTOR SHALL FIELD VERIFY THE LOCATIONS AND ELEVATIONS OF EXISTING CONDITIONS. THIS WOULD INCLUDE ALL EXISTING UTILITIES AND TOPOGRAPHIC FEATURES. THE CONTRACTOR SHALL IMMEDIATELY NOTIFY THE ENGINEER OF ANY DISCREPANCIES OR VARIATIONS FROM THE PLANS.
- 2. ALL DIMENSIONS SHOWN ARE TO FACE OF CURB, FACE OF BUILDING, EDGE OF PAVEMENT, OR TO PROPERTY LINE, UNLESS OTHERWISE NOTED.
- 3. ALL PAVING, CONCRETE CURB, GUTTER AND SIDEWALK SHALL BE FURNISHED AND INSTALLED IN ACCORDANCE WITH THE DETAILS SHOWN PER THE CIVIL DETAILS AND STATE/LOCAL JURISDICTION REQUIREMENTS.
- 4. ACCESSIBLE PARKING AND ACCESSIBLE ROUTES SHALL BE PROVIDED PER CURRENT ADA STANDARDS AND LOCAL/STATE REQUIREMENTS.
- 5. TYPICAL FULL SIZED PARKING STALL IS 10.0' X 20.0' UNLESS OTHERWISE NOTED.
- 6. ALL RADII ARE TO GUTTER LINE OR PAVEMENT EDGE UNLESS OTHERWISE NOTED.
- 7. ALL CONCRETE CURB AND GUTTER RADII SHALL BE 5.0' UNLESS OTHERWISE NOTED
- 8. ALL CURB TERMINI TO HAVE A 3.0' TAPER UNLESS OTHERWISE NOTED.
- 9. BITUMINOUS IMPREGNATED FIBER BOARD TO BE PLACED AT FULL DEPTH OF CONCRETE ADJACENT TO EXISTING STRUCTURES AND BEHIND CURB ADJACENT TO DRIVEWAYS AND SIDEWALKS. BITUMINOUS IMPREGNATED FIBER BOARD SHALL NOT BE PLACED AT PEDESTRIAN RAMPS.
- 10. SEE ELECTRICAL PLANS FOR SITE LIGHTING DESIGN.
- 11. SIGNAGE AND STRIPING BY SEPARATE PLAN, DESIGNED BY OTHERS.

	EXISTING	PROPOSED
ZONING	INDUSTRY OFFICE	INDUSTRY OFFICE
PERVIOUS AREA	15.89 AC	7.73 AC
IMPERVIOUS AREA	0.0 AC	8.16 AC
PERCENT IMPERVIOUS	0%	51%
IMPERVIOUS EXPANSION BUILDING	N/A	0.43 AC

	BUILDING SETBACK	PARKING SETBACK
FRONT YARD	35	10
SIDE YARD	10	10
REAR YARD	30	10

MAXIMUM BUILDING HEIGHT = 45 FT

	EXISTING	PROPOSED
ASSOC. PARKING STALLS	33	110
ADA PARKING	N/A	6
VAN PARKING	N/A	150
TRAILER PARKING	N/A	3
BOX TRUCK PARKING	N/A	4

PROPOSED USE TYPE	WAREHOUSE/DISTRIBUTION
CODE REQUIRED PARKING MINIMUM	33 + 1 PER COMPANY VEHICLE

CODE REQUIREMENTS: OFFICE=1 PER 300 SF, WAREHOUSE=1 PER 2,000 SF



RYAN A+E, INC. 533 South Third Street, Suite 100 Minneapolis, MN 55415 612-492-4000 tel 612-492-3000 fax

WWW.RYANCOMPANIES.COM

OWNER

CONSULTANTS

PROJECT INFORMATION

PROJECT TIMBER WOLF

BAXTER, MN

I hereby certify that this plan, specification, or report was prepared by me or under my direct supervision and that I am a duly Licensed Professional Engineer under the laws of the State of Minnesota

JARED B. OLSON

DATE

06/18/2024

CHECKED BY

42340

REGISTRATION NO.

© 2022 RYAN A+E, INC.

DRAWN BY DCS


JOB NO. DATE 701676 06/18/2024

	ISSUE R	ECORD
ISSUE #	DATE	DESCRIPTION
1	05/07/2024	90% CD SET
2	05/24/2024	100% CD SET
3	06/18/2024	CITY RESUBMITTAL
		_

100% CD


SITE PLAN

C300

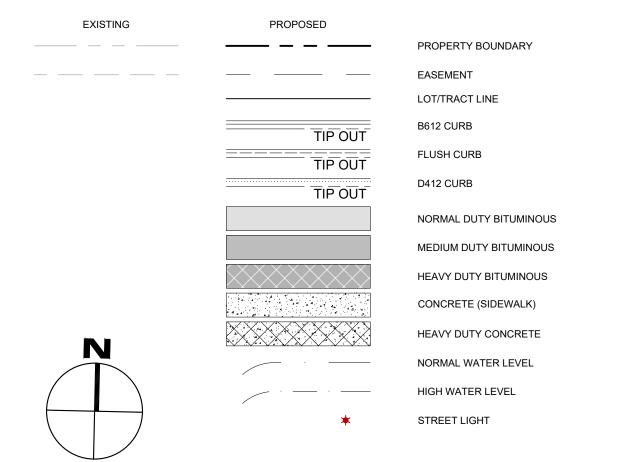

LEGEND:

IN

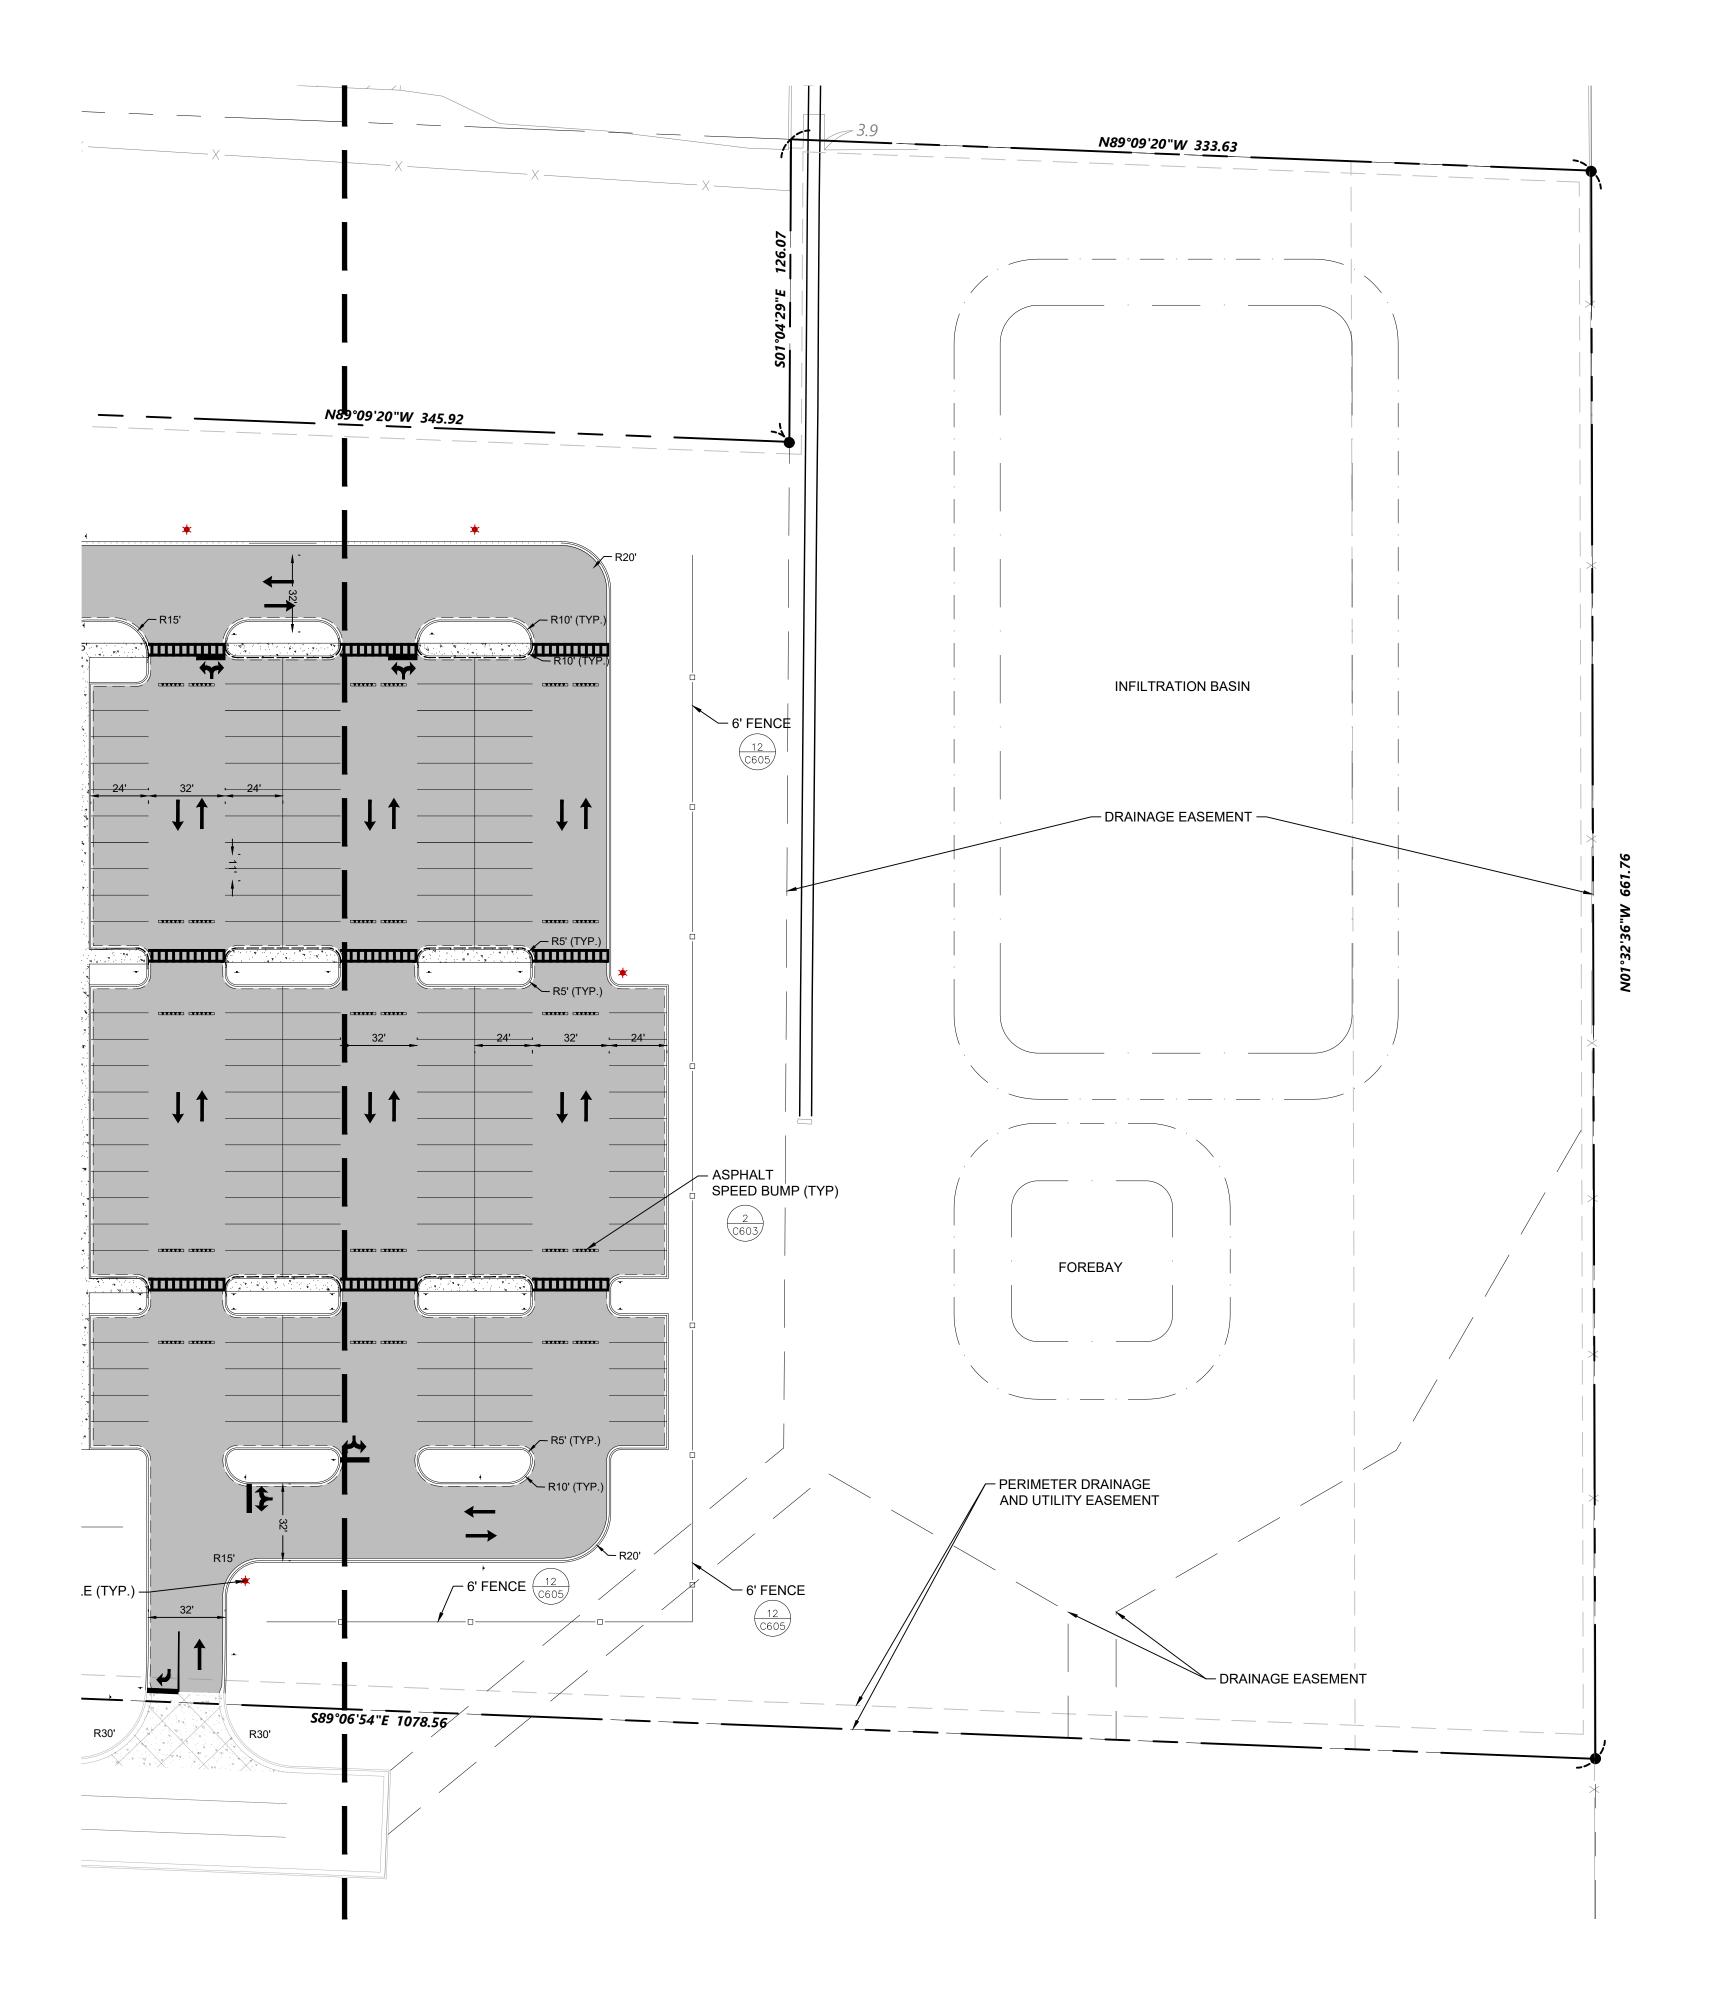

SITE NOTES

- 1. CONTRACTOR SHALL FIELD VERIFY THE LOCATIONS AND ELEVATIONS OF EXISTING CONDITIONS. THIS WOULD INCLUDE ALL EXISTING UTILITIES AND TOPOGRAPHIC FEATURES. THE CONTRACTOR SHALL IMMEDIATELY NOTIFY THE ENGINEER OF ANY DISCREPANCIES OR VARIATIONS FROM THE
- 2. ALL DIMENSIONS SHOWN ARE TO FACE OF CURB, FACE OF BUILDING, EDGE OF PAVEMENT, OR TO PROPERTY LINE, UNLESS OTHERWISE NOTED.
- 3. ALL PAVING, CONCRETE CURB, GUTTER AND SIDEWALK SHALL BE FURNISHED AND INSTALLED IN ACCORDANCE WITH THE DETAILS SHOWN PER THE CIVIL DETAILS AND STATE/LOCAL JURISDICTION REQUIREMENTS.
- 4. ACCESSIBLE PARKING AND ACCESSIBLE ROUTES SHALL BE PROVIDED PER CURRENT ADA STANDARDS AND LOCAL/STATE REQUIREMENTS.
- 5. TYPICAL FULL SIZED PARKING STALL IS 10.0' X 20.0' UNLESS OTHERWISE NOTED.
- 6. ALL RADII ARE TO GUTTER LINE OR PAVEMENT EDGE UNLESS OTHERWISE NOTED.
- 7. ALL CONCRETE CURB AND GUTTER RADII SHALL BE 5.0' UNLESS OTHERWISE NOTED
- 8. ALL CURB TERMINI TO HAVE A 3.0' TAPER UNLESS OTHERWISE NOTED.
- 9. BITUMINOUS IMPREGNATED FIBER BOARD TO BE PLACED AT FULL DEPTH OF CONCRETE ADJACENT TO EXISTING STRUCTURES AND BEHIND CURB ADJACENT TO DRIVEWAYS AND SIDEWALKS. BITUMINOUS IMPREGNATED FIBER BOARD SHALL NOT BE PLACED AT PEDESTRIAN RAMPS.
- 10. SEE ELECTRICAL PLANS FOR SITE LIGHTING DESIGN.
- 11. SIGNAGE AND STRIPING BY SEPARATE PLAN, DESIGNED BY OTHERS.



RYAN A+E, INC. 533 South Third Street, Suite 100 Minneapolis, MN 55415 612-492-4000 tel 612-492-3000 fax

WWW.RYANCOMPANIES.COM

OWNER

CONSULTANTS

PROJECT INFORMATION

PROJECT TIMBER WOLF

BAXTER, MN

I hereby certify that this plan, specification, or report was prepared by me or under my direct supervision and that I am a duly Licensed Professional Engineer under the laws of the State of Minnesota

JARED B. OLSON

REGISTRATION NO.

42340 06/18/2024

DATE

CHECKED BY

© 2022 RYAN A+E, INC.


DRAWN BY DCS

JOB NO. 701676 06/18/2024

	ISSUE R	ECORD
ISSUE#	DATE	DESCRIPTION
1	05/07/2024	90% CD SET
2	05/24/2024	100% CD SET
3	06/18/2024	CITY RESUBMITTAL

100% CD

SITE PLAN

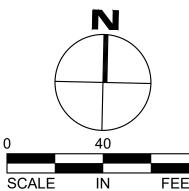

PROPERTY BOUNDARY **EASEMENT** LOT/TRACT LINE

PROPOSED


LEGEND:

EXISTING

B612 CURB FLUSH CURB TIP OUT

D412 CURB NORMAL DUTY BITUMINOUS MEDIUM DUTY BITUMINOUS HEAVY DUTY BITUMINOUS CONCRETE (SIDEWALK) HEAVY DUTY CONCRETE

NORMAL WATER LEVEL HIGH WATER LEVEL STREET LIGHT

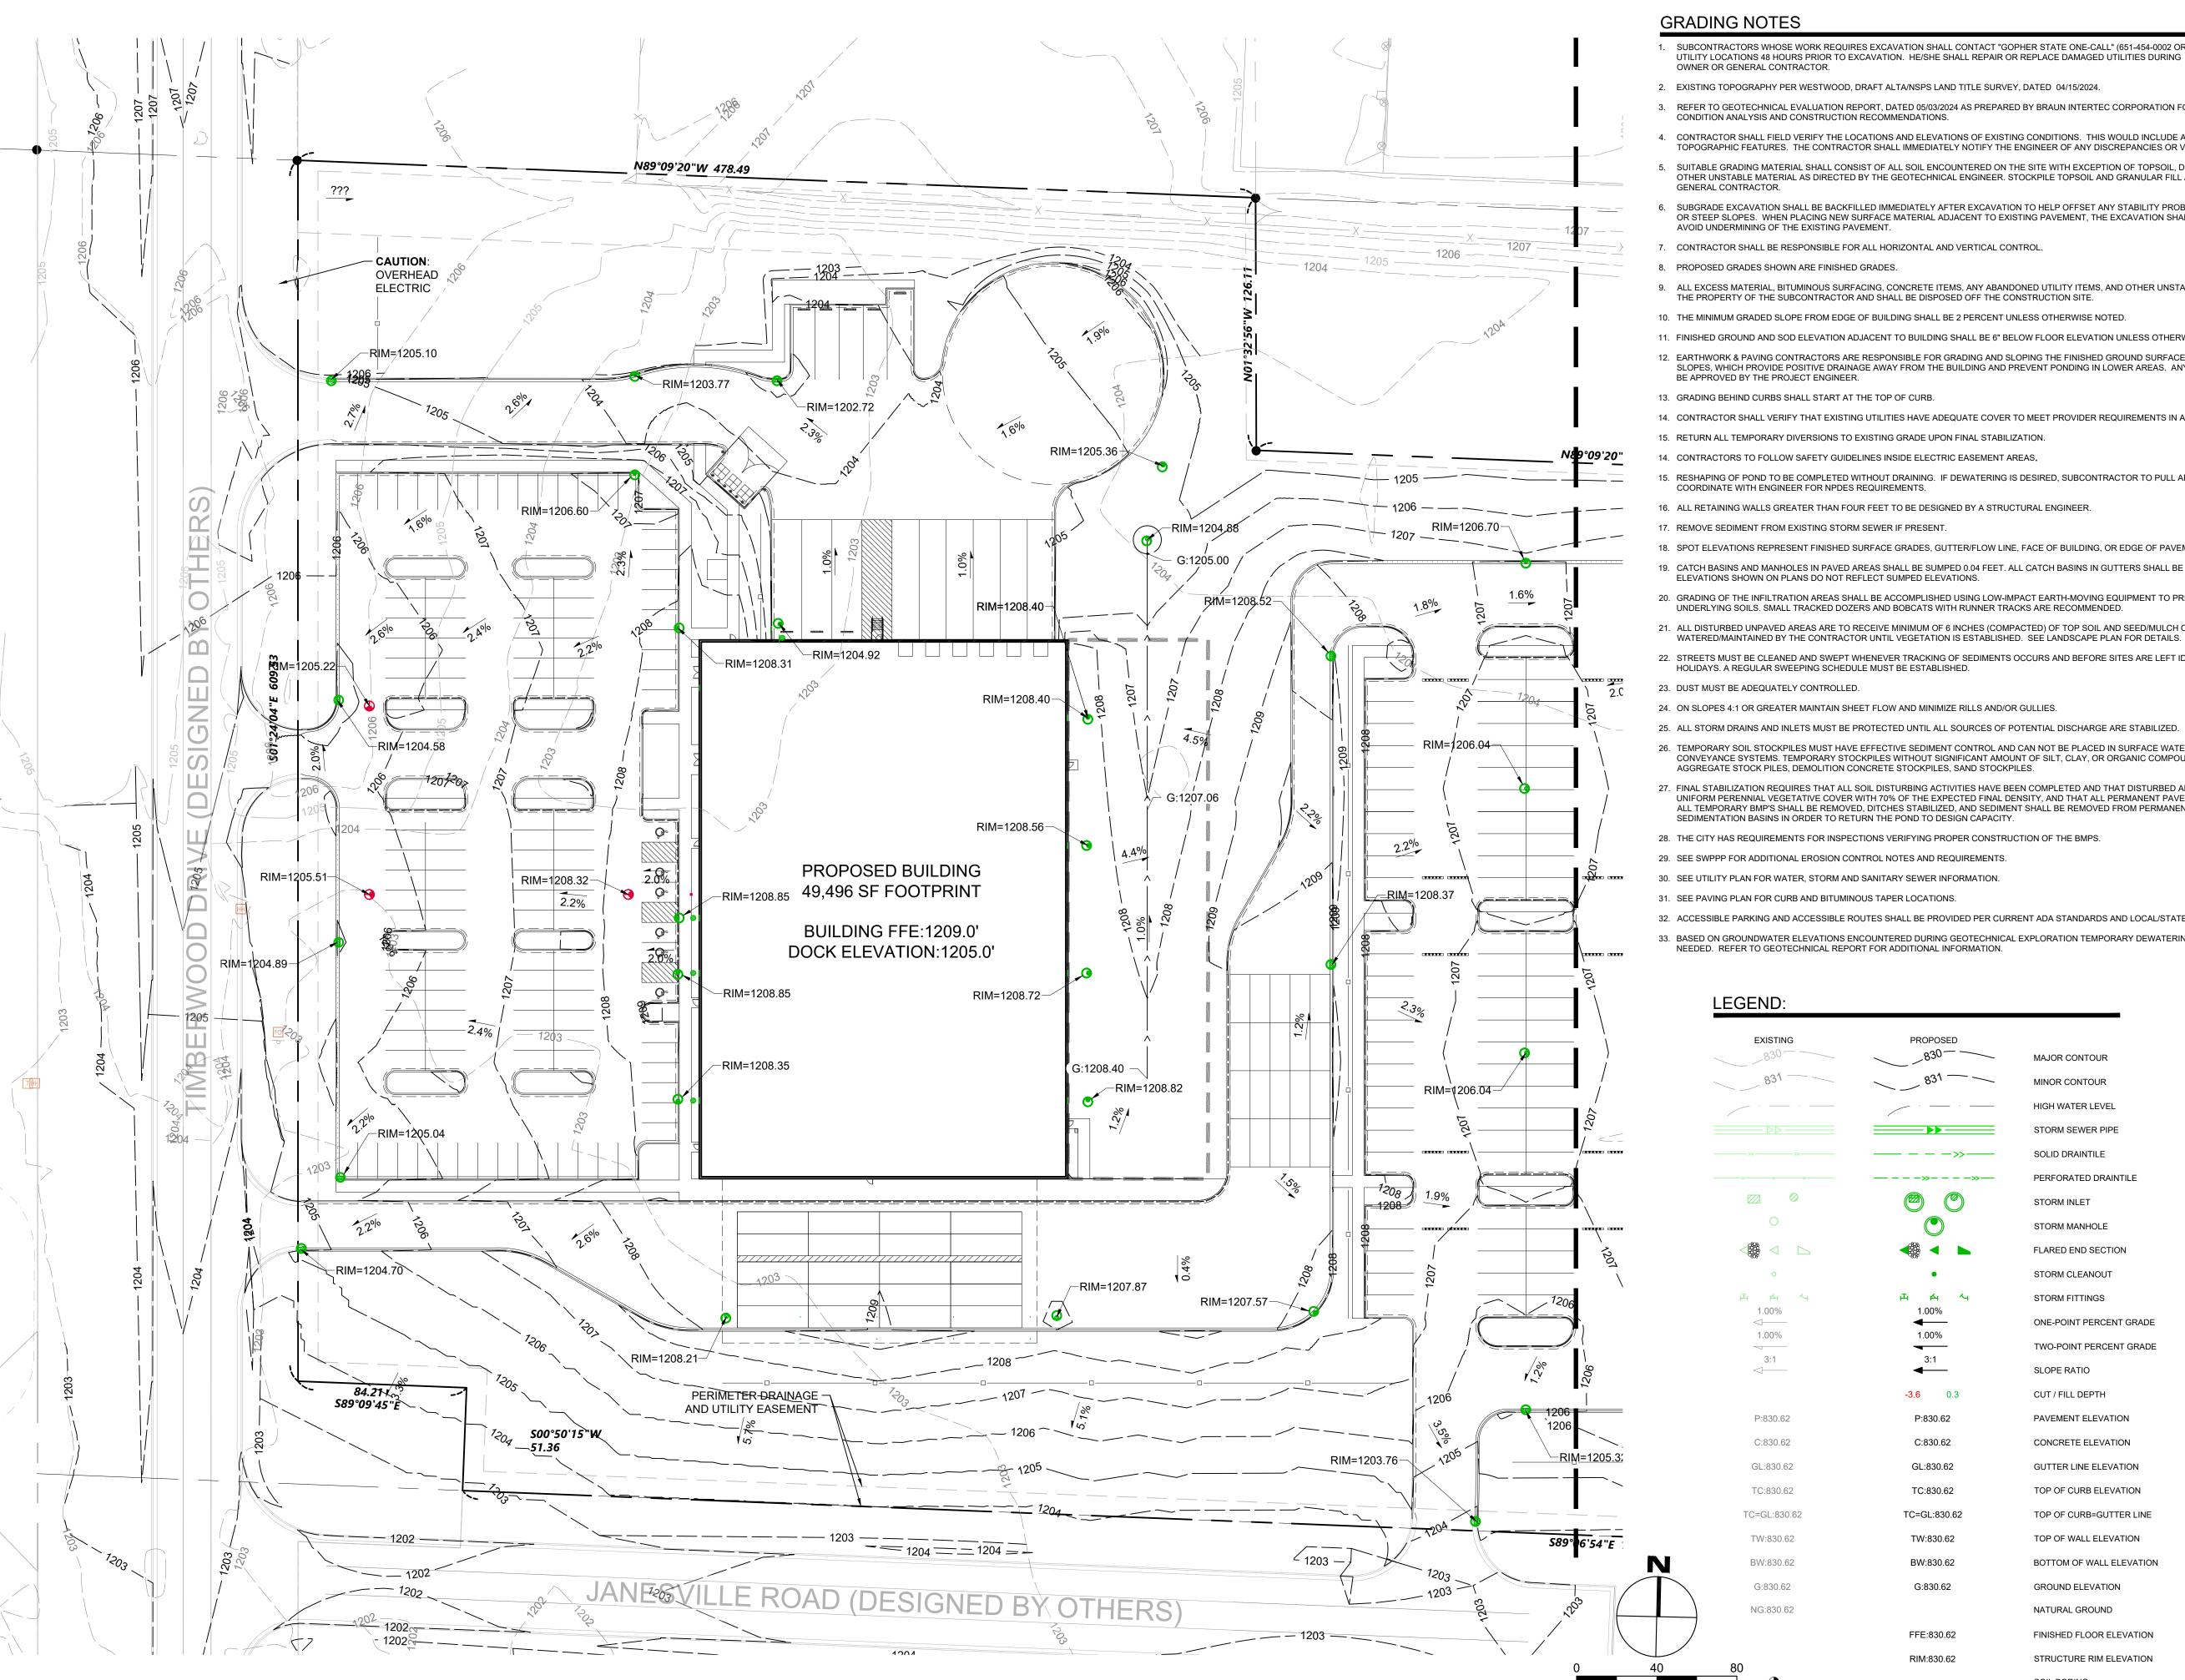

GRADING NOTES

SUBCONTRACTORS WHOSE WORK REQUIRES EXCAVATION SHALL CONTACT "GOPHER STATE ONE-CALL" (651-454-0002 OR 1-800-252-1166 OR 811) FOR UTILITY LOCATIONS 48 HOURS PRIOR TO EXCAVATION. HE/SHE SHALL REPAIR OR REPLACE DAMAGED UTILITIES DURING CONSTRUCTION AT NO COST TO OWNER OR GENERAL CONTRACTOR.

2. EXISTING TOPOGRAPHY PER WESTWOOD, DRAFT ALTA/NSPS LAND TITLE SURVEY, DATED 04/15/2024.

REFER TO GEOTECHNICAL EVALUATION REPORT, DATED 05/03/2024 AS PREPARED BY BRAUN INTERTEC CORPORATION FOR AN EXISTING SUBSURFACE SITE AND A+E, INC.

4. CONTRACTOR SHALL FIELD VERIFY THE LOCATIONS AND ELEVATIONS OF EXISTING CONDITIONS. THIS WOULD INCLUDE ALL EXISTING UTILITIES AND TOPOGRAPHIC FEATURES. THE CONTRACTOR SHALL IMMEDIATELY NOTIFY THE ENGINEER OF ANY DISCREPANCIES OR VARIATIONS FROM THE PLANS.

SUITABLE GRADING MATERIAL SHALL CONSIST OF ALL SOIL ENCOUNTERED ON THE SITE WITH EXCEPTION OF TOPSOIL, DEBRIS, ORGANIC MATERIAL AND 612-492-4000 tel OTHER UNSTABLE MATERIAL AS DIRECTED BY THE GEOTECHNICAL ENGINEER. STOCKPILE TOPSOIL AND GRANULAR FILL AT LOCATIONS DIRECTED BY

612-492-3000 fax

SUBGRADE EXCAVATION SHALL BE BACKFILLED IMMEDIATELY AFTER EXCAVATION TO HELP OFFSET ANY STABILITY PROBLEMS DUE TO WATER SEEPAGE

OR STEEP SLOPES. WHEN PLACING NEW SURFACE MATERIAL ADJACENT TO EXISTING PAVEMENT, THE EXCAVATION SHALL BE BACKFILLED PROMPTLY TO WWW.RYANCOMPANIES.COM AVOID UNDERMINING OF THE EXISTING PAVEMENT.

CONTRACTOR SHALL BE RESPONSIBLE FOR ALL HORIZONTAL AND VERTICAL CONTROL.

PROPOSED GRADES SHOWN ARE FINISHED GRADES.

9. ALL EXCESS MATERIAL, BITUMINOUS SURFACING, CONCRETE ITEMS, ANY ABANDONED UTILITY ITEMS, AND OTHER UNSTABLE MATERIALS SHALL BECOME THE PROPERTY OF THE SUBCONTRACTOR AND SHALL BE DISPOSED OFF THE CONSTRUCTION SITE.

10. THE MINIMUM GRADED SLOPE FROM EDGE OF BUILDING SHALL BE 2 PERCENT UNLESS OTHERWISE NOTED.

11. FINISHED GROUND AND SOD ELEVATION ADJACENT TO BUILDING SHALL BE 6" BELOW FLOOR ELEVATION UNLESS OTHERWISE NOTED.

12. EARTHWORK & PAVING CONTRACTORS ARE RESPONSIBLE FOR GRADING AND SLOPING THE FINISHED GROUND SURFACE TO PROVIDE SMOOTH & UNIFORM SLOPES, WHICH PROVIDE POSITIVE DRAINAGE AWAY FROM THE BUILDING AND PREVENT PONDING IN LOWER AREAS. ANY DERIVATION FROM PLANS SHALL BE APPROVED BY THE PROJECT ENGINEER.

13. GRADING BEHIND CURBS SHALL START AT THE TOP OF CURB.

14. CONTRACTOR SHALL VERIFY THAT EXISTING UTILITIES HAVE ADEQUATE COVER TO MEET PROVIDER REQUIREMENTS IN AREAS OF GRADE REVISIONS.

15. RETURN ALL TEMPORARY DIVERSIONS TO EXISTING GRADE UPON FINAL STABILIZATION.

14. CONTRACTORS TO FOLLOW SAFETY GUIDELINES INSIDE ELECTRIC EASEMENT AREAS.

15. RESHAPING OF POND TO BE COMPLETED WITHOUT DRAINING. IF DEWATERING IS DESIRED, SUBCONTRACTOR TO PULL APPROPRIATE PERMITS AND COORDINATE WITH ENGINEER FOR NPDES REQUIREMENTS.

16. ALL RETAINING WALLS GREATER THAN FOUR FEET TO BE DESIGNED BY A STRUCTURAL ENGINEER.

17. REMOVE SEDIMENT FROM EXISTING STORM SEWER IF PRESENT.

18. SPOT ELEVATIONS REPRESENT FINISHED SURFACE GRADES, GUTTER/FLOW LINE, FACE OF BUILDING, OR EDGE OF PAVEMENT UNLESS OTHERWISE NOTED.

19. CATCH BASINS AND MANHOLES IN PAVED AREAS SHALL BE SUMPED 0.04 FEET. ALL CATCH BASINS IN GUTTERS SHALL BE SUMPED 0.16 FEET. RIM FLEVATIONS SHOWN ON PLANS DO NOT REFLECT SUMPED ELEVATIONS

20. GRADING OF THE INFILTRATION AREAS SHALL BE ACCOMPLISHED USING LOW-IMPACT EARTH-MOVING EQUIPMENT TO PREVENT COMPACTION OF THE

21. ALL DISTURBED UNPAVED AREAS ARE TO RECEIVE MINIMUM OF 6 INCHES (COMPACTED) OF TOP SOIL AND SEED/MULCH OR SOD. THESE AREAS SHALL BE

22. STREETS MUST BE CLEANED AND SWEPT WHENEVER TRACKING OF SEDIMENTS OCCURS AND BEFORE SITES ARE LEFT IDLE FOR WEEKENDS AND

HOLIDAYS. A REGULAR SWEEPING SCHEDULE MUST BE ESTABLISHED.

23. DUST MUST BE ADEQUATELY CONTROLLED.

25. ALL STORM DRAINS AND INLETS MUST BE PROTECTED UNTIL ALL SOURCES OF POTENTIAL DISCHARGE ARE STABILIZED.

26. TEMPORARY SOIL STOCKPILES MUST HAVE EFFECTIVE SEDIMENT CONTROL AND CAN NOT BE PLACED IN SURFACE WATERS OR STORM WATER CONVEYANCE SYSTEMS. TEMPORARY STOCKPILES WITHOUT SIGNIFICANT AMOUNT OF SILT, CLAY, OR ORGANIC COMPOUNDS ARE EXEMPT EX: CLEAN AGGREGATE STOCK PILES, DEMOLITION CONCRETE STOCKPILES, SAND STOCKPILES.

27. FINAL STABILIZATION REQUIRES THAT ALL SOIL DISTURBING ACTIVITIES HAVE BEEN COMPLETED AND THAT DISTURBED AREAS ARE STABILIZED BY A UNIFORM PERENNIAL VEGETATIVE COVER WITH 70% OF THE EXPECTED FINAL DENSITY, AND THAT ALL PERMANENT PAVEMENTS HAVE BEEN INSTALLED. ALL TEMPORARY BMP'S SHALL BE REMOVED, DITCHES STABILIZED, AND SEDIMENT SHALL BE REMOVED FROM PERMANENT CONVEYANCES AND SEDIMENTATION BASINS IN ORDER TO RETURN THE POND TO DESIGN CAPACITY

28. THE CITY HAS REQUIREMENTS FOR INSPECTIONS VERIFYING PROPER CONSTRUCTION OF THE BMPS

29. SEE SWPPP FOR ADDITIONAL EROSION CONTROL NOTES AND REQUIREMENTS.

30. SEE UTILITY PLAN FOR WATER, STORM AND SANITARY SEWER INFORMATION.

31. SEE PAVING PLAN FOR CURB AND BITUMINOUS TAPER LOCATIONS.

32. ACCESSIBLE PARKING AND ACCESSIBLE ROUTES SHALL BE PROVIDED PER CURRENT ADA STANDARDS AND LOCAL/STATE REQUIREMENTS.


33. BASED ON GROUNDWATER ELEVATIONS ENCOUNTERED DURING GEOTECHNICAL EXPLORATION TEMPORARY DEWATERING OF EXCAVATIONS MAY BE NEEDED. REFER TO GEOTECHNICAL REPORT FOR ADDITIONAL INFORMATION.

LEGEND:

SCALE

IN

FEET

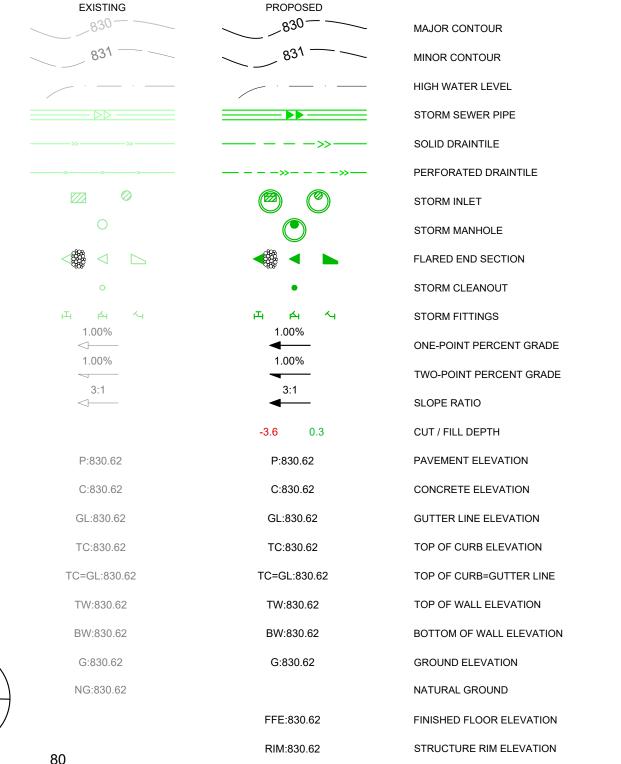

SOIL BORING

BENCHMARK



533 South Third Street, Suite 100 Minneapolis, MN 55415

OWNER

CONSULTANTS

PROJECT INFORMATION

PROJECT TIMBER

BAXTER, MN

I hereby certify that this plan, specification, or report was prepared by me or under my direct supervision and that I am a duly Licensed Professional Engineer under the laws of the State of Minnesota

JARED B. OLSON

REGISTRATION NO. 42340

© 2022 RYAN A+E, INC.

DRAWN BY

DCS

DATE

06/18/2024


CHECKED BY

JOB NO. DATE 701676 06/18/2024

	ISSUE R	ECORD
ISSUE#	DATE	DESCRIPTION
1	05/07/2024	90% CD SET
2	05/24/2024	100% CD SET
3	06/18/2024	CITY RESUBMITTAL

100% CD

GRADING PLAN

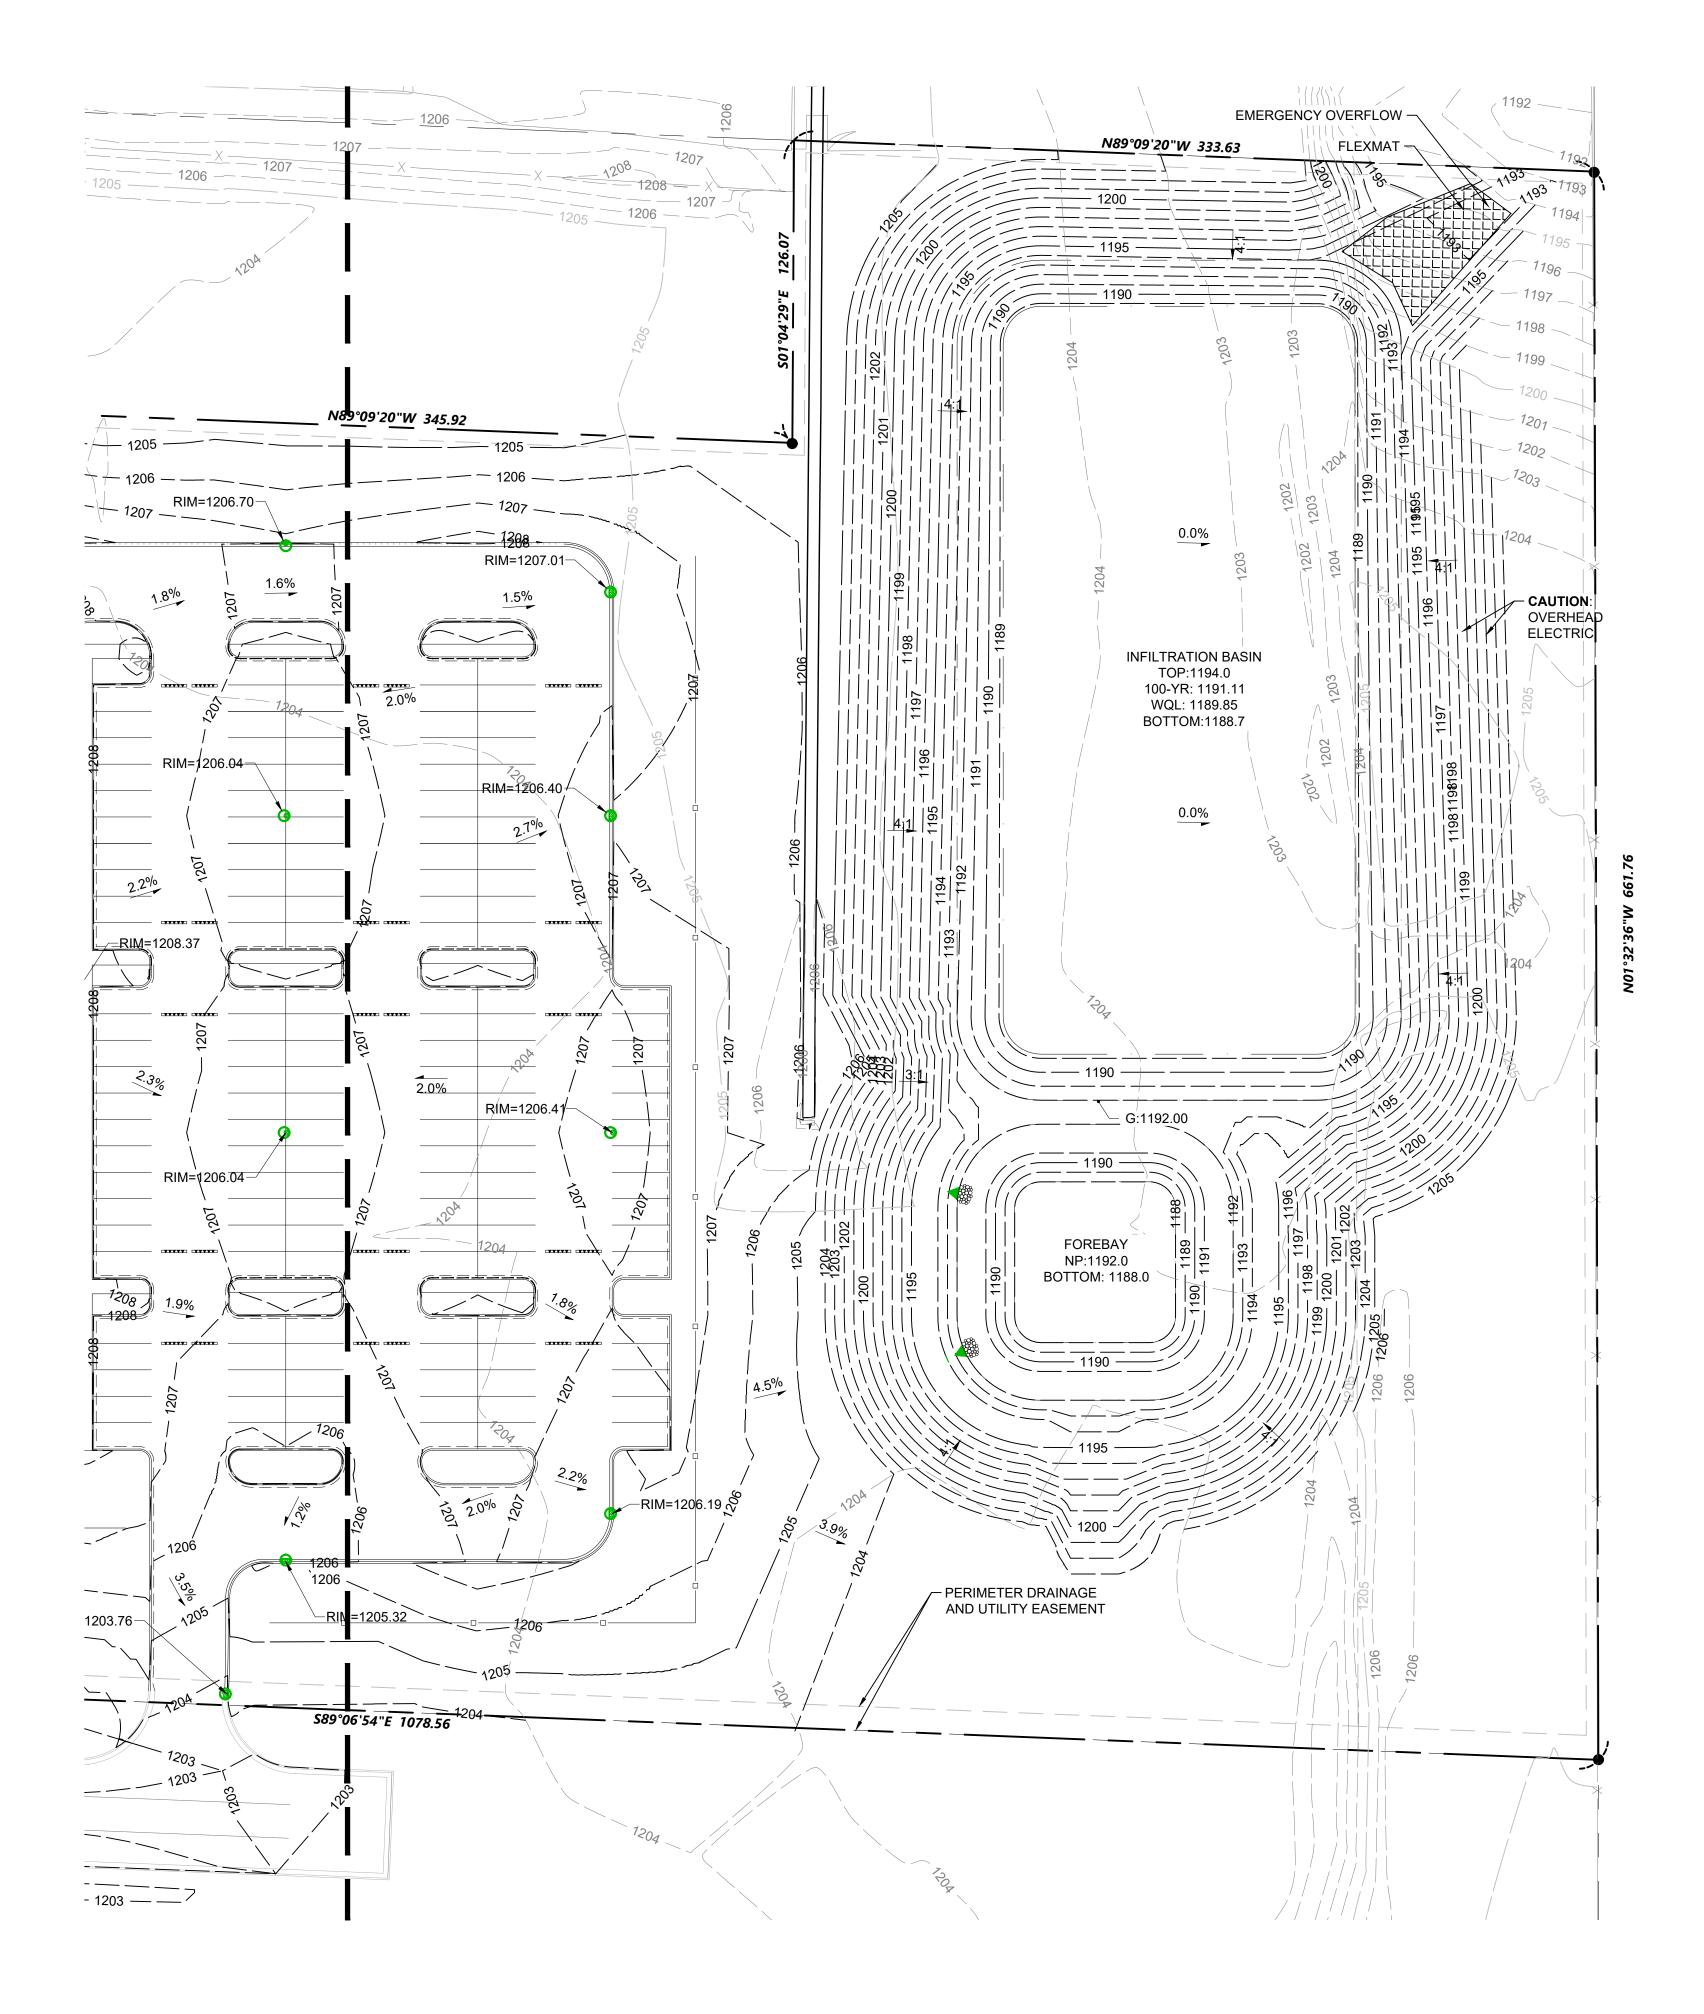


GRADING NOTES

SUBCONTRACTORS WHOSE WORK REQUIRES EXCAVATION SHALL CONTACT "GOPHER STATE ONE-CALL" (651-454-0002 OR 1-800-252-1166 OR 811) FOR UTILITY LOCATIONS 48 HOURS PRIOR TO EXCAVATION. HE/SHE SHALL REPAIR OR REPLACE DAMAGED UTILITIES DURING CONSTRUCTION AT NO COST TO OWNER OR GENERAL CONTRACTOR.

- 2. EXISTING TOPOGRAPHY PER WESTWOOD, DRAFT ALTA/NSPS LAND TITLE SURVEY, DATED 04/15/2024.
- REFER TO GEOTECHNICAL EVALUATION REPORT, DATED 05/03/2024 AS PREPARED BY BRAUN INTERTEC CORPORATION FOR AN EXISTING SUBSURFACE SITE AND A+E, INC.
- 4. CONTRACTOR SHALL FIELD VERIFY THE LOCATIONS AND ELEVATIONS OF EXISTING CONDITIONS. THIS WOULD INCLUDE ALL EXISTING UTILITIES AND TOPOGRAPHIC FEATURES. THE CONTRACTOR SHALL IMMEDIATELY NOTIFY THE ENGINEER OF ANY DISCREPANCIES OR VARIATIONS FROM THE PLANS.
- SUITABLE GRADING MATERIAL SHALL CONSIST OF ALL SOIL ENCOUNTERED ON THE SITE WITH EXCEPTION OF TOPSOIL, DEBRIS, ORGANIC MATERIAL AND 612-492-4000 tel OTHER UNSTABLE MATERIAL AS DIRECTED BY THE GEOTECHNICAL ENGINEER. STOCKPILE TOPSOIL AND GRANULAR FILL AT LOCATIONS DIRECTED BY

 612-492-3000 fax
- 6. SUBGRADE EXCAVATION SHALL BE BACKFILLED IMMEDIATELY AFTER EXCAVATION TO HELP OFFSET ANY STABILITY PROBLEMS DUE TO WATER SEEPAGE OR STEEP SLOPES. WHEN PLACING NEW SURFACE MATERIAL ADJACENT TO EXISTING PAVEMENT, THE EXCAVATION SHALL BE BACKFILLED PROMPTLY TO WWW.RYANCOMPANIES.COM AVOID UNDERMINING OF THE EXISTING PAVEMENT.
- 7. CONTRACTOR SHALL BE RESPONSIBLE FOR ALL HORIZONTAL AND VERTICAL CONTROL.
- 8. PROPOSED GRADES SHOWN ARE FINISHED GRADES.
- 9. ALL EXCESS MATERIAL, BITUMINOUS SURFACING, CONCRETE ITEMS, ANY ABANDONED UTILITY ITEMS, AND OTHER UNSTABLE MATERIALS SHALL BECOME THE PROPERTY OF THE SUBCONTRACTOR AND SHALL BE DISPOSED OFF THE CONSTRUCTION SITE.
- 10. THE MINIMUM GRADED SLOPE FROM EDGE OF BUILDING SHALL BE 2 PERCENT UNLESS OTHERWISE NOTED.
- 11. FINISHED GROUND AND SOD ELEVATION ADJACENT TO BUILDING SHALL BE 6" BELOW FLOOR ELEVATION UNLESS OTHERWISE NOTED.
- 12. EARTHWORK & PAVING CONTRACTORS ARE RESPONSIBLE FOR GRADING AND SLOPING THE FINISHED GROUND SURFACE TO PROVIDE SMOOTH & UNIFORM SLOPES, WHICH PROVIDE POSITIVE DRAINAGE AWAY FROM THE BUILDING AND PREVENT PONDING IN LOWER AREAS. ANY DERIVATION FROM PLANS SHALL BE APPROVED BY THE PROJECT ENGINEER.
- 13. GRADING BEHIND CURBS SHALL START AT THE TOP OF CURB.
- 14. CONTRACTOR SHALL VERIFY THAT EXISTING UTILITIES HAVE ADEQUATE COVER TO MEET PROVIDER REQUIREMENTS IN AREAS OF GRADE REVISIONS.
- 15. RETURN ALL TEMPORARY DIVERSIONS TO EXISTING GRADE UPON FINAL STABILIZATION.
- 14. CONTRACTORS TO FOLLOW SAFETY GUIDELINES INSIDE ELECTRIC EASEMENT AREAS.
- 15. RESHAPING OF POND TO BE COMPLETED WITHOUT DRAINING. IF DEWATERING IS DESIRED, SUBCONTRACTOR TO PULL APPROPRIATE PERMITS AND COORDINATE WITH ENGINEER FOR NPDES REQUIREMENTS
- 16. ALL RETAINING WALLS GREATER THAN FOUR FEET TO BE DESIGNED BY A STRUCTURAL ENGINEER.
- 17. REMOVE SEDIMENT FROM EXISTING STORM SEWER IF PRESENT.
- 18. SPOT ELEVATIONS REPRESENT FINISHED SURFACE GRADES, GUTTER/FLOW LINE, FACE OF BUILDING, OR EDGE OF PAVEMENT UNLESS OTHERWISE NOTED.
- 19. CATCH BASINS AND MANHOLES IN PAVED AREAS SHALL BE SUMPED 0.04 FEET. ALL CATCH BASINS IN GUTTERS SHALL BE SUMPED 0.16 FEET. RIM ELEVATIONS SHOWN ON PLANS DO NOT REFLECT SUMPED ELEVATIONS.
- 20. GRADING OF THE INFILTRATION AREAS SHALL BE ACCOMPLISHED USING LOW-IMPACT EARTH-MOVING EQUIPMENT TO PREVENT COMPACTION OF THE UNDERLYING SOILS, SMALL TRACKED DOZERS AND BOBCATS WITH RUNNER TRACKS ARE RECOMMENDED.
- 21. ALL DISTURBED UNPAVED AREAS ARE TO RECEIVE MINIMUM OF 6 INCHES (COMPACTED) OF TOP SOIL AND SEED/MULCH OR SOD. THESE AREAS SHALL BE WATERED/MAINTAINED BY THE CONTRACTOR UNTIL VEGETATION IS ESTABLISHED. SEE LANDSCAPE PLAN FOR DETAILS.
- 22. STREETS MUST BE CLEANED AND SWEPT WHENEVER TRACKING OF SEDIMENTS OCCURS AND BEFORE SITES ARE LEFT IDLE FOR WEEKENDS AND HOLIDAYS. A REGULAR SWEEPING SCHEDULE MUST BE ESTABLISHED.
- 23. DUST MUST BE ADEQUATELY CONTROLLED.
- 24. ON SLOPES 4:1 OR GREATER MAINTAIN SHEET FLOW AND MINIMIZE RILLS AND/OR GULLIES.
- 25. ALL STORM DRAINS AND INLETS MUST BE PROTECTED UNTIL ALL SOURCES OF POTENTIAL DISCHARGE ARE STABILIZED.
- 26. TEMPORARY SOIL STOCKPILES MUST HAVE EFFECTIVE SEDIMENT CONTROL AND CAN NOT BE PLACED IN SURFACE WATERS OR STORM WATER CONVEYANCE SYSTEMS. TEMPORARY STOCKPILES WITHOUT SIGNIFICANT AMOUNT OF SILT, CLAY, OR ORGANIC COMPOUNDS ARE EXEMPT EX: CLEAN AGGREGATE STOCK PILES, DEMOLITION CONCRETE STOCKPILES, SAND STOCKPILES.
- 27. FINAL STABILIZATION REQUIRES THAT ALL SOIL DISTURBING ACTIVITIES HAVE BEEN COMPLETED AND THAT DISTURBED AREAS ARE STABILIZED BY A UNIFORM PERENNIAL VEGETATIVE COVER WITH 70% OF THE EXPECTED FINAL DENSITY, AND THAT ALL PERMANENT PAVEMENTS HAVE BEEN INSTALLED. ALL TEMPORARY BMP'S SHALL BE REMOVED, DITCHES STABILIZED, AND SEDIMENT SHALL BE REMOVED FROM PERMANENT CONVEYANCES AND SEDIMENTATION BASINS IN ORDER TO RETURN THE POND TO DESIGN CAPACITY.
- 28. THE CITY HAS REQUIREMENTS FOR INSPECTIONS VERIFYING PROPER CONSTRUCTION OF THE BMPS.
- 29. SEE SWPPP FOR ADDITIONAL EROSION CONTROL NOTES AND REQUIREMENTS.
- 30. SEE UTILITY PLAN FOR WATER, STORM AND SANITARY SEWER INFORMATION.
- 31. SEE PAVING PLAN FOR CURB AND BITUMINOUS TAPER LOCATIONS.
- 32. ACCESSIBLE PARKING AND ACCESSIBLE ROUTES SHALL BE PROVIDED PER CURRENT ADA STANDARDS AND LOCAL/STATE REQUIREMENTS.
- 33. BASED ON GROUNDWATER ELEVATIONS ENCOUNTERED DURING GEOTECHNICAL EXPLORATION TEMPORARY DEWATERING OF EXCAVATIONS MAY BE NEEDED. REFER TO GEOTECHNICAL REPORT FOR ADDITIONAL INFORMATION.

LEGEND:

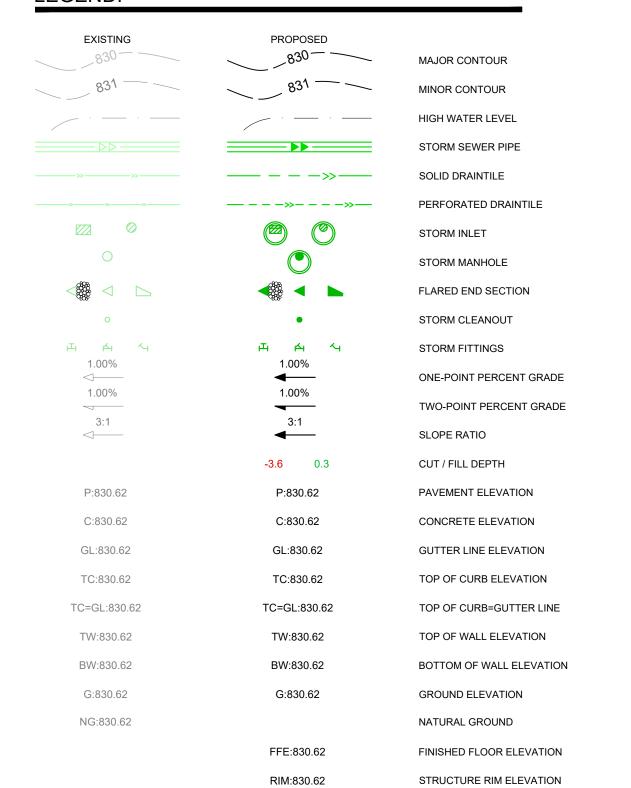

SOIL BORING

BENCHMARK



533 South Third Street, Suite 100 Minneapolis, MN 55415

OWNER

CONSULTANTS

PROJECT INFORMATION

PROJECT TIMBER

I hereby certify that this plan, specification, or report was prepared by me or under my direct supervision and that I am a duly Licensed Professional Engineer under the laws of the State of Minnesota

REGISTRATION NO.

JARED B. OLSON

DATE 42340 06/18/2024

© 2022 RYAN A+E, INC.

JOB NO.

701676

DRAWN BY CHECKED BY DCS ---


	ISSUE R	ECORD
ISSUE#	DATE	DESCRIPTION
1	05/07/2024	90% CD SET
2	05/24/2024	100% CD SET
3	06/18/2024	CITY RESUBMITTAL

DATE

06/18/2024

100% CD

GRADING PLAN

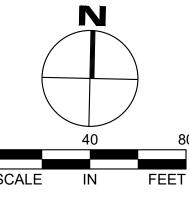



RYAN A+E, INC.
533 South Third Street, Suite 100
Minneapolis, MN 55415
612-492-4000 tel
612-492-3000 fax

WWW.RYANCOMPANIES.COM

OWNER


SHEET INDEX

| SHEET NAME | SHEET | SHE

SURFACE TREATMENT LEGEND

SURFACE TYPE	GRAPHIC ID
Concrete Drive Aprons	4-7-8
Concrete Pavement	
Lawn-Low Maintenance Mix-Seeded-Hydromulch-MN DOT #25-131 2	
Native Prairie Seed Mix-MNDOT #35-241	
Native Seed-Wet Mix-MNDOT #33-261	
Planting Areas	
Rock Mulch #1	

——PLANTING LEGEND

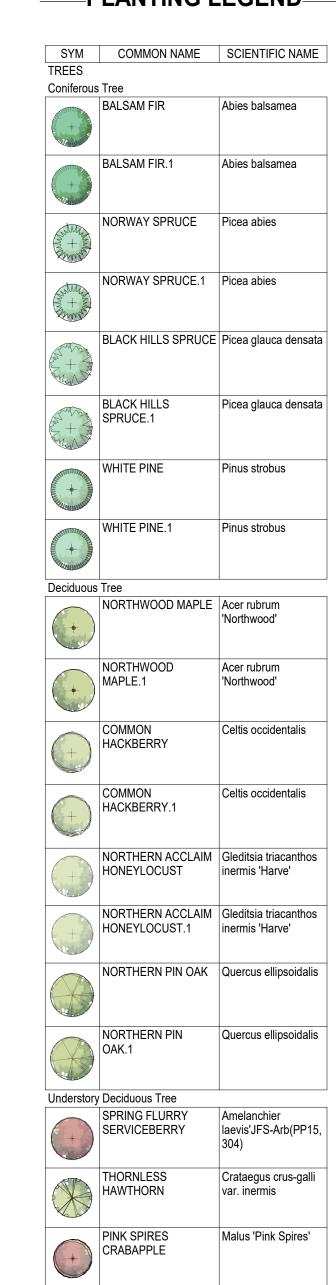

CONSULTANTS

KEY PLAN



PROJECT INFORMATION
PROJECT TIMBER
WOLF

Baxter, MN

I hereby certify that this plan, specification or report was prepared by me or under my direct supervision and that I am a duly Licensed Landscape Architect under the laws of the state of Minnesota



JUSTIN C. BAGGENSTOSS

REGISTRATION NO. DATE

© 2024 RYAN A&E, INC.

PROJ. NO. 701676

ISSUE RECORD


ISSUE # DATE DESCRIPTION

06/18/2024 CITY RESUBMITTAL

CITY RESUBMITTAL

06/18/2024

LANDSCAPE TITLE SHEET

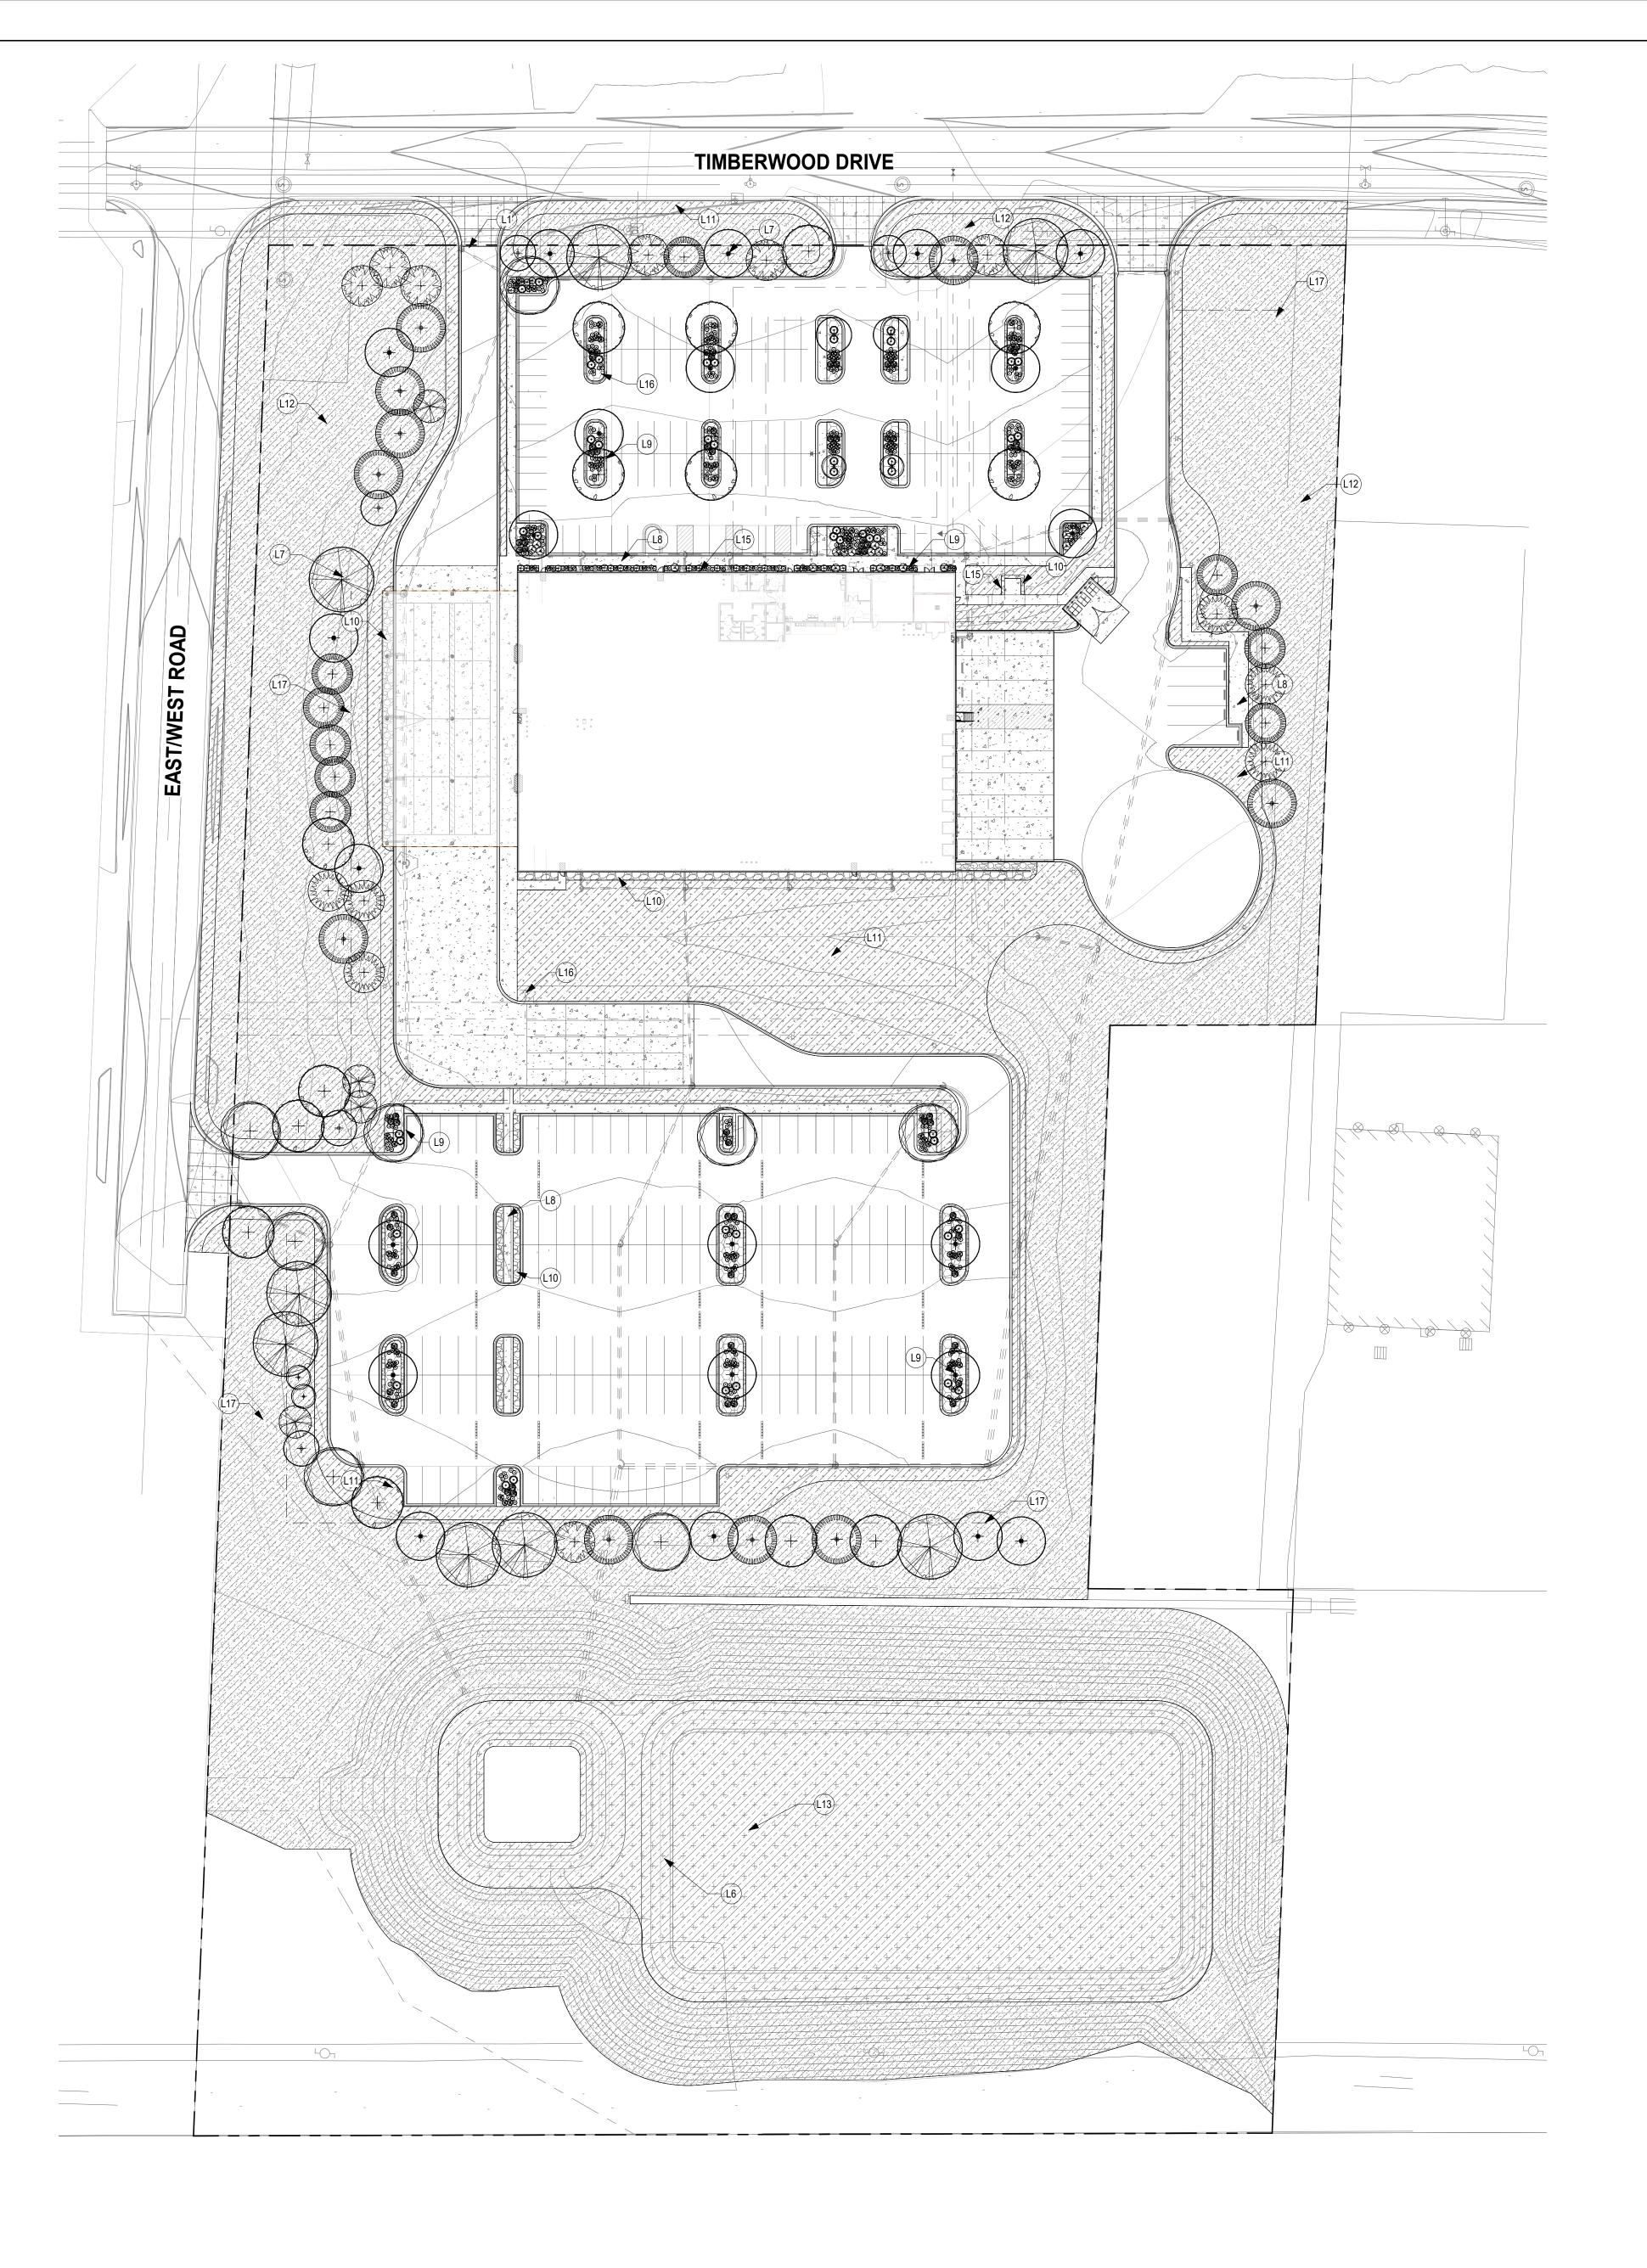

EXECUTE EXECUTE EXECUTE

L1 MAIN ENTRY DRIVE;

Concrete Pavement

Lawn-Low Maintenance

#25-131 2

Planting Areas

Rock Mulch #1

Mix-Seeded-Hydromulch-MNDOT

Native Prairie Seed Mix-MNDOT

Native Seed-Wet Mix-MNDOT #33-261

- L1 MAIN ENTRY DRIVE;
 L6 STORMWATER MANAGEMENT; (SEE ELEC.);
- PROPOSED TREES; PROVIDE MULCH RINGS AT ALL TREES NOT LOCATED IN PLANTING AREAS;
 SURFACE TREATMENT; CONCRETE, TYP.; JOINTING PER PLANS
- L9 SURFACE TREATMENT; PLANTING AREAS; SHREDDED HARDWOOD MULCH; 3" DEPTH; DRIP
- L10 SURFACE TREATMENT; ROCK MULCH; BASIS OF DESIGN: 2-6" FIELD STONE W/FABRIC
- L11 SURFACE TREATMENT; LOW MAINTENANCE TURFGRASS; HYDROSEEDED-MNDOT MIX 25-131; IRRIGATED;
- L12 SURFACE TREATMENT; NATIVE PRAIRIE MIX; SEEDED-MODIFIED MNDOT MIX #35-241;
 L13 SURFACE TREATMENT; WET/POND MIX; SEEDED-MODIFIED MNDOT MIX #33-261;

SURFACE TREATMENT SCHEDULE

KEYNOTE ID (SEE KEYNOTE LEGEND/LAYOUT

- L15 COMMERCIAL EDGING; STEEL; 4"H X 1x8"; COLOR 'BLACK';
- L16 SITE LIGHTING; (SEE ELEC.); L17 FENCING;

CONSULTANTS

RYAN A+E, INC.


612-492-3000 fax

Minneapolis, MN 55415 612-492-4000 tel

533 South Third Street, Suite 100

WWW.RYANCOMPANIES.COM

KEY PLAN

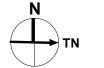

PROJECT TIMBER
WOLF

Baxter, MN

I hereby certify that this plan, specification or report was prepared by me or under my direct supervision and that I am a duly Licensed Landscape Architect under the laws of the state of Minnesota



JUSTIN C. BAGGENSTOSS

REGISTRATION NO. DATE

© 2024 RYAN A&E, INC.

PROJ. NO.

ISSUE RECORD

ISSUE # DATE DESCRIPTION

06/18/2024 CITY RESUBMITTAL


CITY RESUBMITTAL

06/18/2024

OVERALL SITE LANDSCAPE REFERENCE PLAN

L100

1 OVERALL SITE LANDSCAPE REFERENCE PLAN 1" = 50'-0"

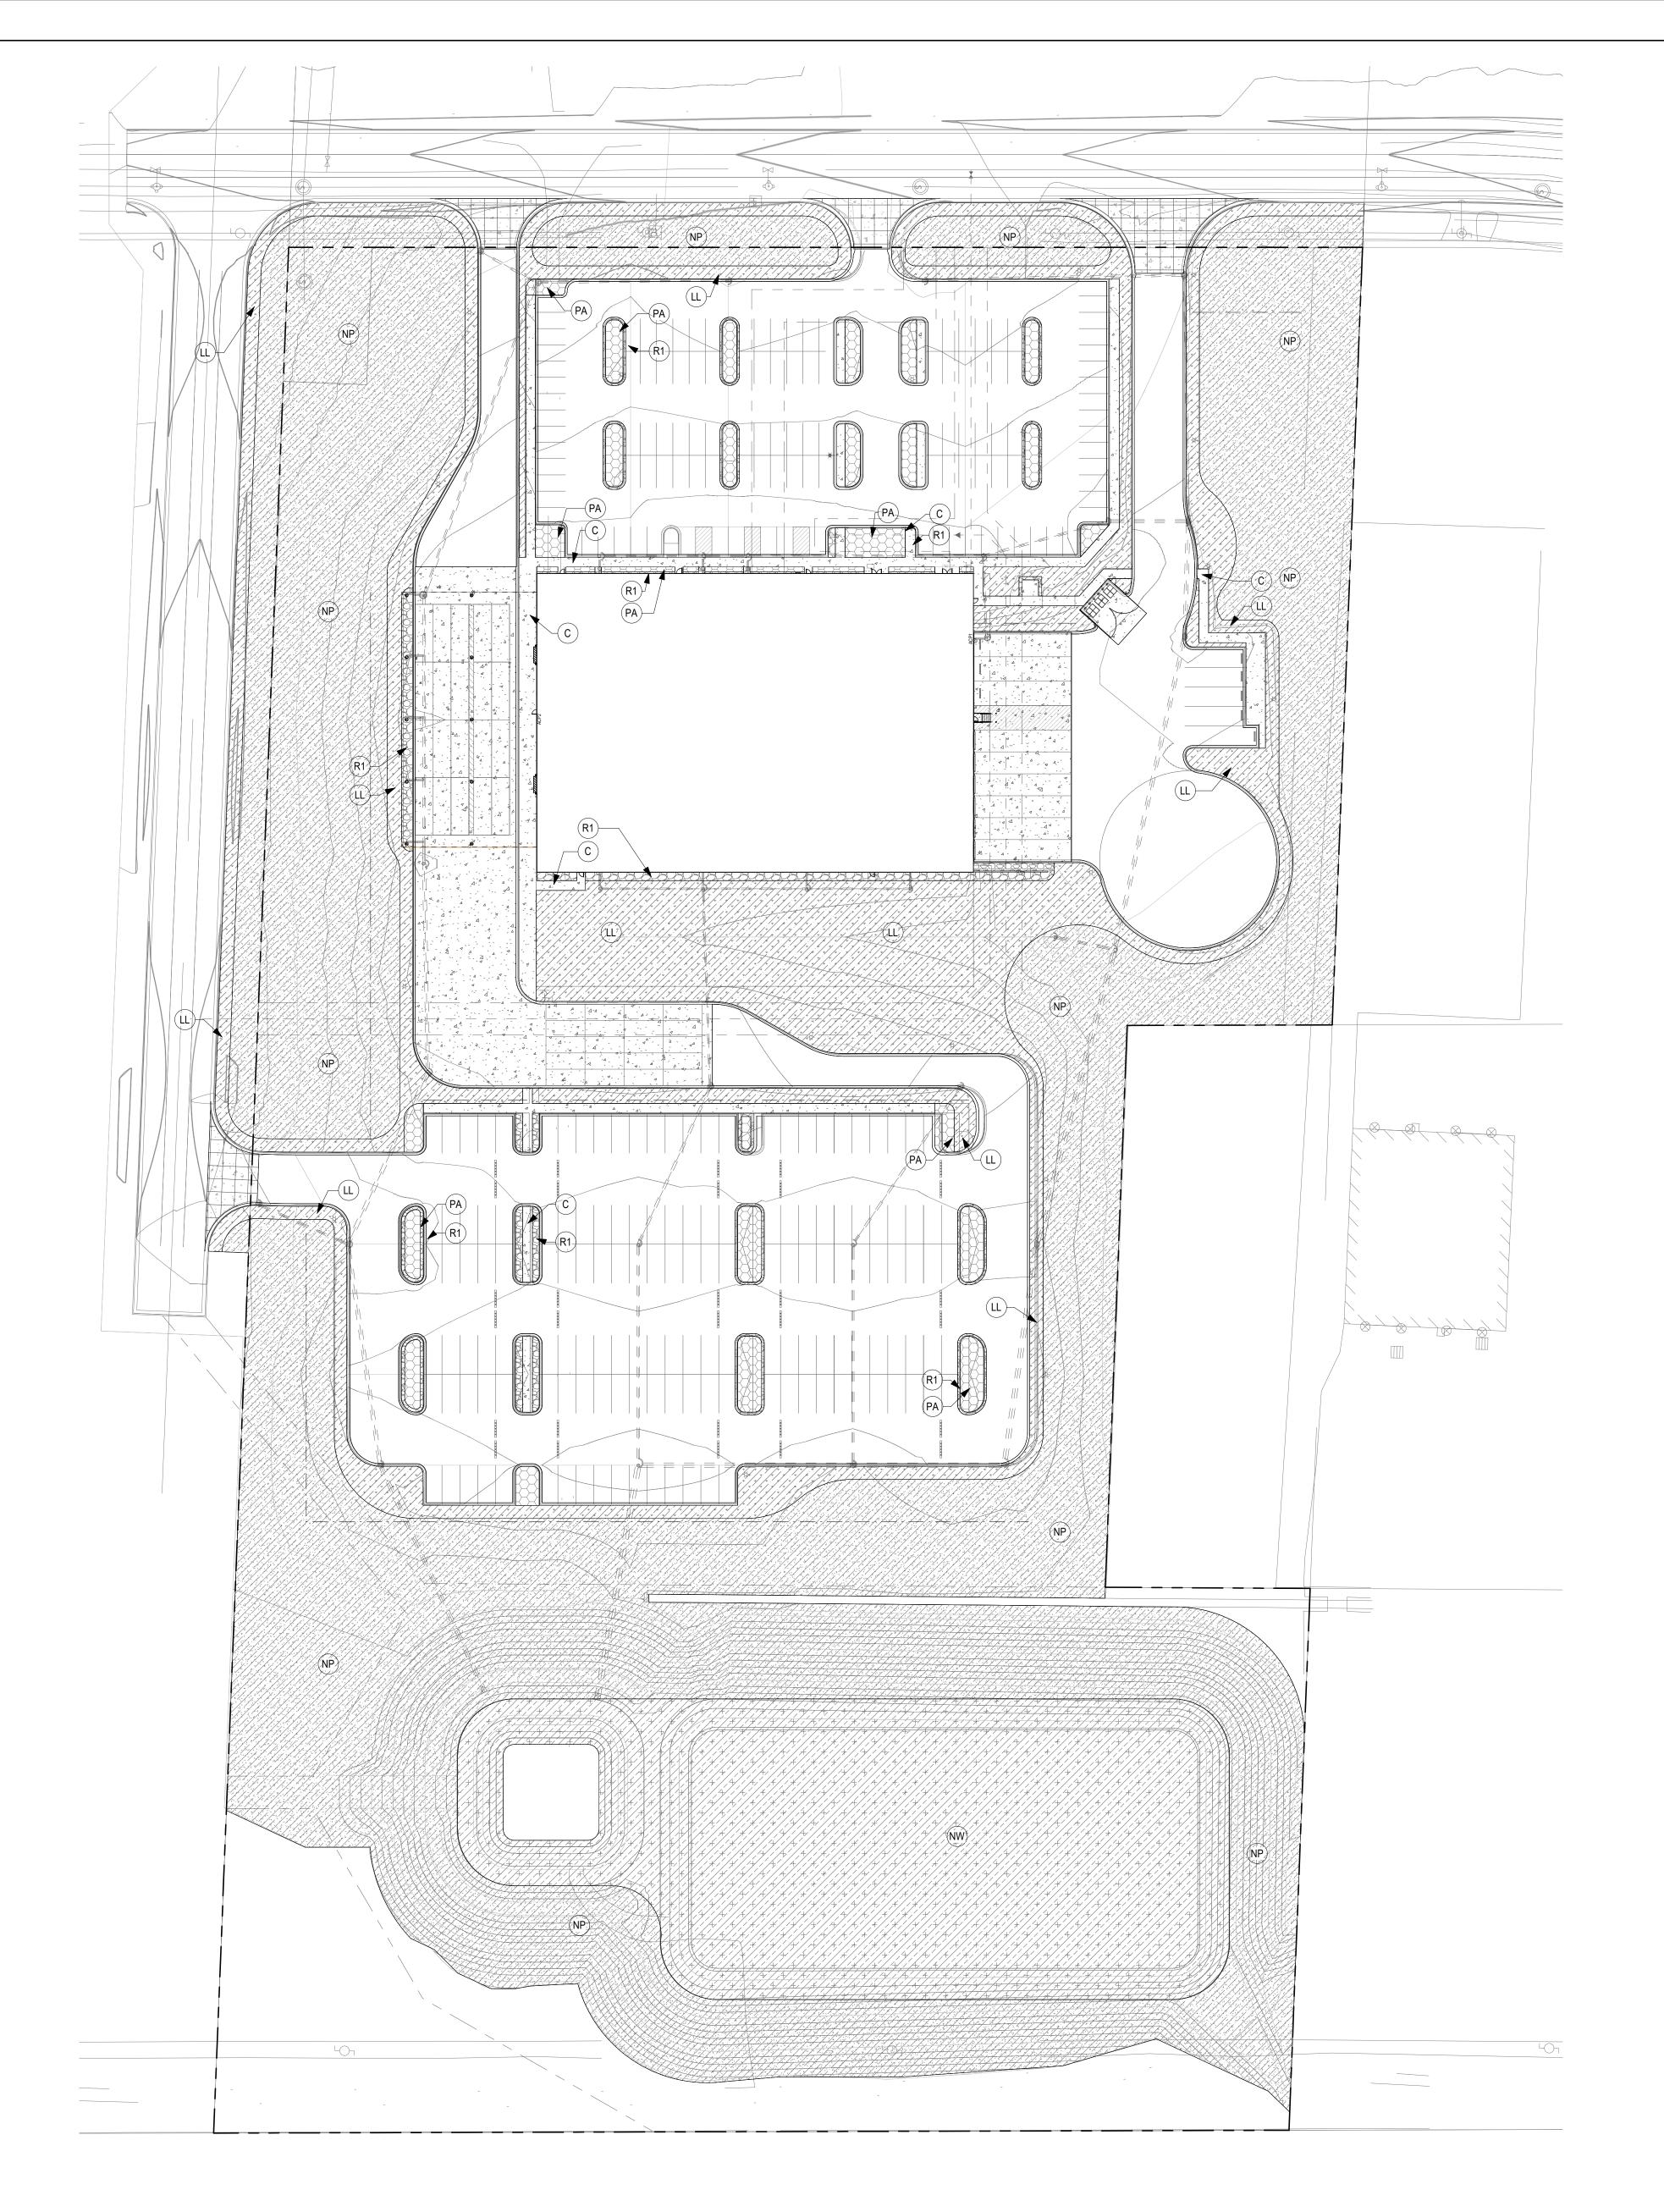

Minneapolis, MN 55415
612-492-4000 tel
612-492-3000 fax


WWW.RYANCOMPANIES.COM

RYAN A+E, INC. 533 South Third Street, Suite 100

CONSULTANTS

SURFACE TREATMENT SCHEDULE SURFACE TYPE GRAPHIC ID KEYNOTE ID AREA Concrete Drive Aprons 5820 SF 48105 SF Concrete Pavement 70799 SF Lawn-Low Maintenance Mix-Seeded-Hydromulch-MNDOT #25-131 2 Native Prairie Seed 257569 SF Mix-MNDOT #35-241 Native Seed-Wet Mix-MNDOT #33-261 78895 SF Planting Areas 477741 SF

KEY PLAN

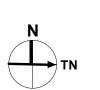

PROJECT INFORMATION
PROJECT TIMBER

Baxter, MN

WOLF

I hereby certify that this plan, specification or report was prepared by me or under my direct supervision and that I am a duly Licensed Landscape Architect under the laws of the state of Minnesota

ne CR

JUSTIN C. BAGGENSTOSS

REGISTRATION NO. DATE

2753 06/18/2024

© 2024 RYAN A&E, INC.

PROJ. NO. 701676

ISSUE RECORD


ISSUE # DATE DESCRIPTION

06/18/2024 CITY RESUBMITTAL

CITY RESUBMITTAL

06/18/2024

SITE LANDSCAPE LAYOUT & SURFACING PLAN

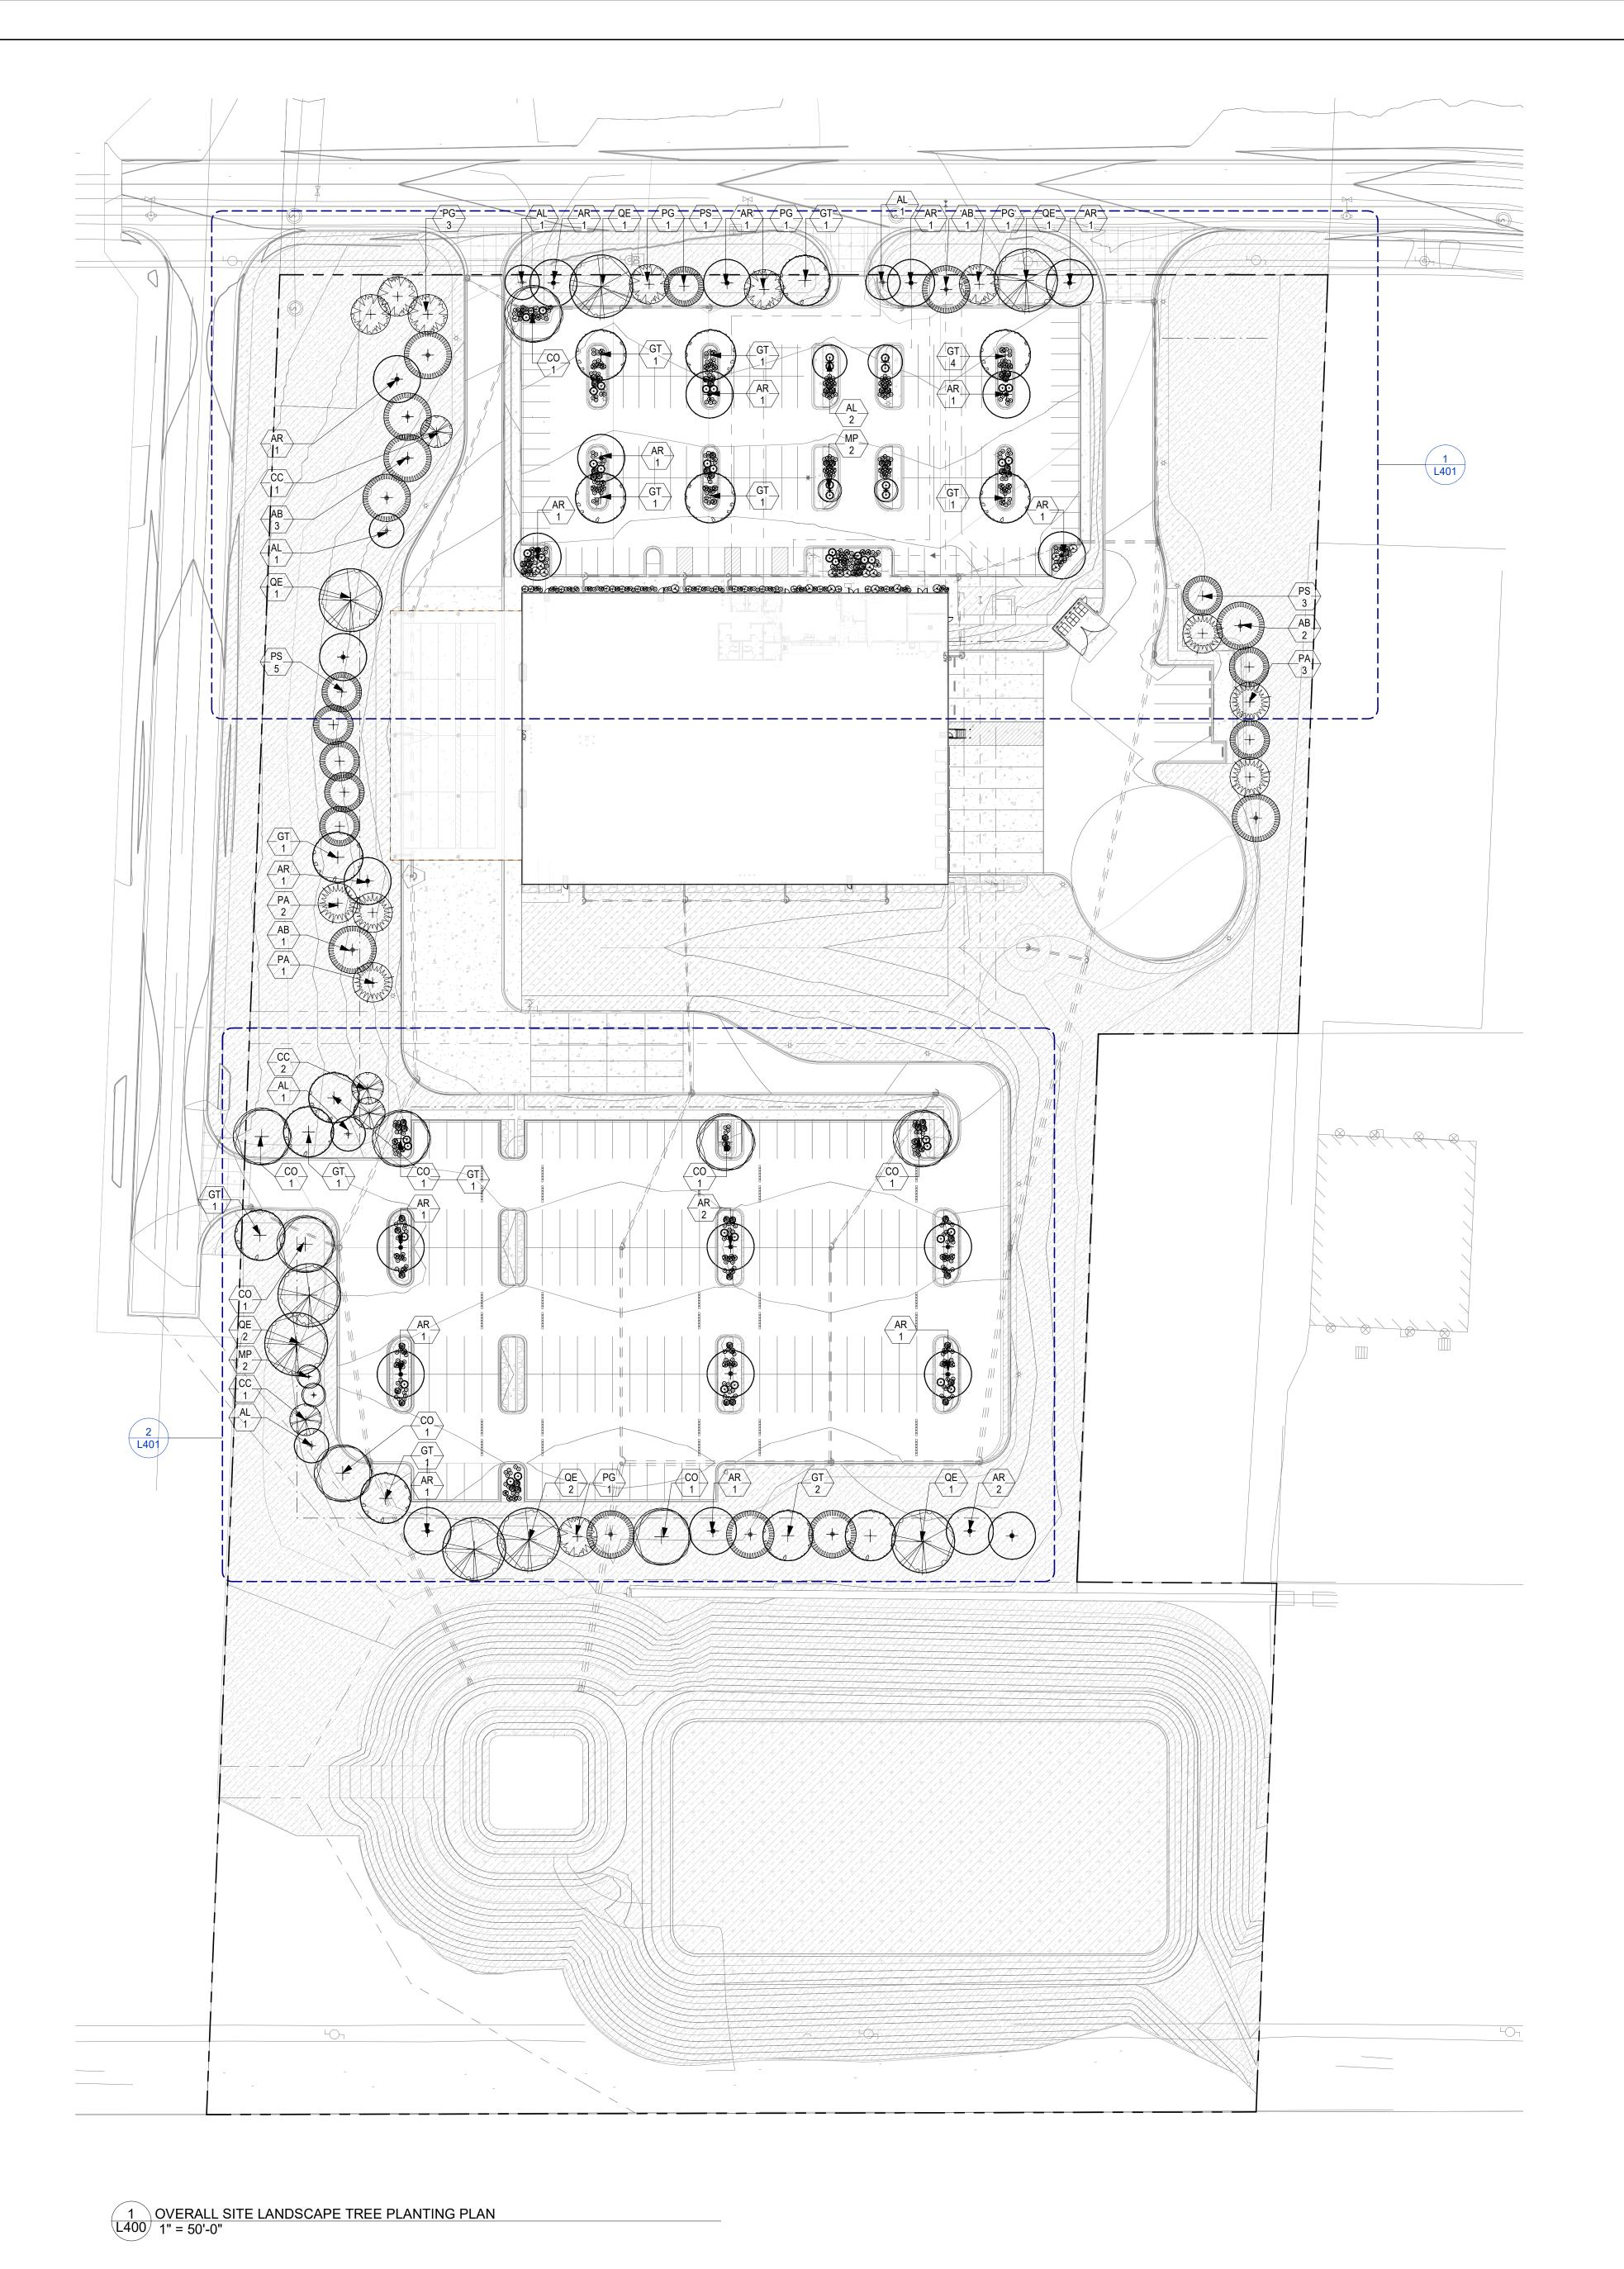

SEE SHEET L401 FOR ADDITIONAL AND SUPPLEMENTAL PLANTING IDENTIFICATION 2. ONLY TREES ARE IDENTIFIED ON THIS PLAN FOR GRAPHIC CLARITY

PLANTING NOTES

- 1. REFER TO CIVIL GRADING PLAN FOR PROPOSED GRADING AND EROSION CONTROL INFORMATION.
- REFER TO CIVIL EXISTING CONDITIONS AND REMOVALS PLAN SHEET C101 & C102 FOR EXISTING TREE REMOVAL AND PRESERVATION INFORMATION.
- 3. REFER TO L-500 FOR LANDSCAPE NOTES AND DETAILS.
- SUBCONTRACTOR. THE LANDSCAPE SUBCONTRACTOR IS RESPONSIBLE FOR VERIFYING THE PLANT COUNTS ON PLAN.
- 5. THIS PLAN ILLUSTRATES THE MINIMUM PLANTINGS TO BE PROVIDED FOR CITY APPROVAL. THE OWNER RETAINS THE RIGHT TO INCREASE PLANT SIZES / QUANTITIES.

4. THE LANDSCAPE PLANT SCHEDULE IS FOR THE CONVENIENCE TO THE LANDSCAPE

- 6. ALL TREES AND SHRUBS SHALL RECEIVE 4" OF SHREDDED HARDWOOD MULCH.
- ALL OPEN SPACE AREAS SHALL RECEIVE PLANT MATERIALS AND IRRIGATION. EXCLUDED FROM IRRIGATION AREAS IS THE BUILDING FOOTPRINT, HARDSCAPE AREAS, ROCK MULCH MAINTENANCE STRIPS AND AREAS BELOW THE NORMAL WATER LEVEL IN STOMWATER BMPS. AREAS RECEIVING NATIVE SEED SHALL BE ON A DEDICATED IRRIGATION ZONE.

——LANDSCAPE CALCULATIONS

CODE REQUIRED TREE CALCULATIONS

OVERSTORY TREES

By SF of Total Building Floor Area

1 tree per 1,500 SF Total Building Area: 49,496/1,500= 33 Trees

By Frontage Along All Roadways

1 tree per 75 LF Frontage: 1,823.66/75= **24 Trees**

By Interior Parking Lot Landscaping

1 tree per Parking Island: 10 Total Parking Island= 10 Trees

TOTAL TREES: 69 OVERSTORY TREES

OVERSTORY TREE EQUIVALENCY Up to fifty percent (50%) of the required number of overstory trees on a site may be substituted with an

equivalent number of understory trees, smaller trees, or shrubs. In such cases, two (2) ornamental trees, two (2) 4-foot coniferous trees, two (2) 1.5-inch diameter overstory trees, or ten (10) shrubs shall be equivalent

100% OVERSTORY TREES: 67 Trees

50% OVERSTORY TREES: 11 Evergreen Trees (6 ft) 23 Deciduous Trees (2.5 Cal/Inch)

50% EQUIVALENCY TREES: 22 Evergreen Trees (4 ft)

44 Deciduous Trees (Ornamental trees or 1.5 Cal/Inch Overstory)

SHRUBS
By SF of Total Building Floor Area
1 tree per 450 SF Total Building Area: 49,496/450= 110 Shrubs

100 - <u>Between Overstory Trees and Ornamental Trees</u> 100 - <u>Between Overstory Trees and Ornamental Trees</u> TOTAL REQUIRED TREES: **TOTAL PORPOSED TREES:**

TOTAL REQUIRED SHRUBS: **TOTAL PROPOSED SHRUBS:** TOTAL PROPOSED PERENNIALS:

Notes:

33% of the proposed trees on site are coniferous trees.

PLANT SCHEDULE


	PL/	AN	T SCHED	ULE			
SYM TREES Coniferous	QTY	ID	COMMON NAME	SCIENTIFIC NAME	PLANTING SIZE	MATURE HEIGHT/WIDTH	COMMEN
Connerous + + + + + + + + + + + + + + + + + + +	5	AB	BALSAM FIR	Abies balsamea	6' B&B	50'/30'	PLANT PE PLAN
+	6	AB	BALSAM FIR.1	Abies balsamea	4" B&B	50'/30'	PLANT PE PLAN
Summer of the second	1	PA	NORWAY SPRUCE	Picea abies	6' B&B	60'/25'	PLANT PE PLAN
THE STATE OF THE S	5	PA	NORWAY SPRUCE.1	Picea abies	4" B&B	60'/25'	PLANT PE PLAN
E+ 3	1	PG	BLACK HILLS SPRUCE	Picea glauca densata	6' B&B	35'/22'	PLANT PE PLAN
+ 3	6	PG	BLACK HILLS SPRUCE.1	Picea glauca densata	4" B&B	35'/22'	PLANT PE PLAN
+	4	PS	WHITE PINE	Pinus strobus	6' B&B	50'/30'	PLANT PE PLAN
+	5	PS	WHITE PINE.1	Pinus strobus	4" B&B	50'/30'	PLANT PE PLAN
Deciduous +	Tree 12	AR	NORTHWOOD MAPLE	Acer rubrum 'Northwood'	3" B&B	50'/35'	PLANT PE PLAN
+	10	AR	NORTHWOOD MAPLE.1	Acer rubrum 'Northwood'	2" B&B	50'/35'	PLANT PE PLAN
+	4	СО	COMMON HACKBERRY	Celtis occidentalis	3" B&B	55'/40'	PLANT PE PLAN
+	4	СО	COMMON HACKBERRY.1	Celtis occidentalis	2" B&B	55'/40'	PLANT PE PLAN
+	6	GT	NORTHERN ACCLAIM HONEYLOCUST	Gleditsia triacanthos inermis 'Harve'	2.5" B&B	40'/30'	PLANT PE PLAN
+	8	GT	NORTHERN ACCLAIM HONEYLOCUST.1	Gleditsia triacanthos inermis 'Harve'	2" B&B	40'/30'	PLANT PE PLAN
	1	QE	NORTHERN PIN OAK	Quercus ellipsoidalis	2.5" B&B	50'/40'	PLANT PE PLAN
	7	QE	NORTHERN PIN OAK.1	Quercus ellipsoidalis	2" B&B	50'/40'	PLANT PE PLAN
Understory	/ Decid	luous 7	ree	1	I	<u> </u>	<u>I</u>
+	7	AL	SPRING FLURRY SERVICEBERRY	Amelanchier laevis'JFS-Arb(PP15,30 4)	2" B&B	30'/20'	PLANT PE PLAN
	4	CC	THORNLESS HAWTHORN	Crataegus crus-galli var. inermis	2" B&B	20'/20'	PLANT PE PLAN
	4	MP	PINK SPIRES	Malus 'Pink Spires'	2" B&B	15'/12'	PLANT PE

RYAN A+E, INC. 533 South Third Street, Suite 100 Minneapolis, MN 55415 612-492-4000 tel 612-492-3000 fax

WWW.RYANCOMPANIES.COM

CONSULTANTS

KEY PLAN

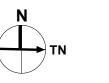

PROJECT INFORMATION

PROJECT TIMBER WOLF

Baxter, MN

I hereby certify that this plan, specification or report was prepared by me or under my direct supervision and that I am a duly Licensed Landscape Architect under the laws of the state of Minnesota



REGISTRATION NO. DATE

© 2024 RYAN A&E, INC. PROJ. NO.


ISSUE RECORD ISSUE # DATE DESCRIPTION

06/18/2024 CITY RESUBMITTAL


CITY RESUBMITTAL

06/18/2024

OVERALL SITE LANDSCAPE TREE PLANTING PLAN

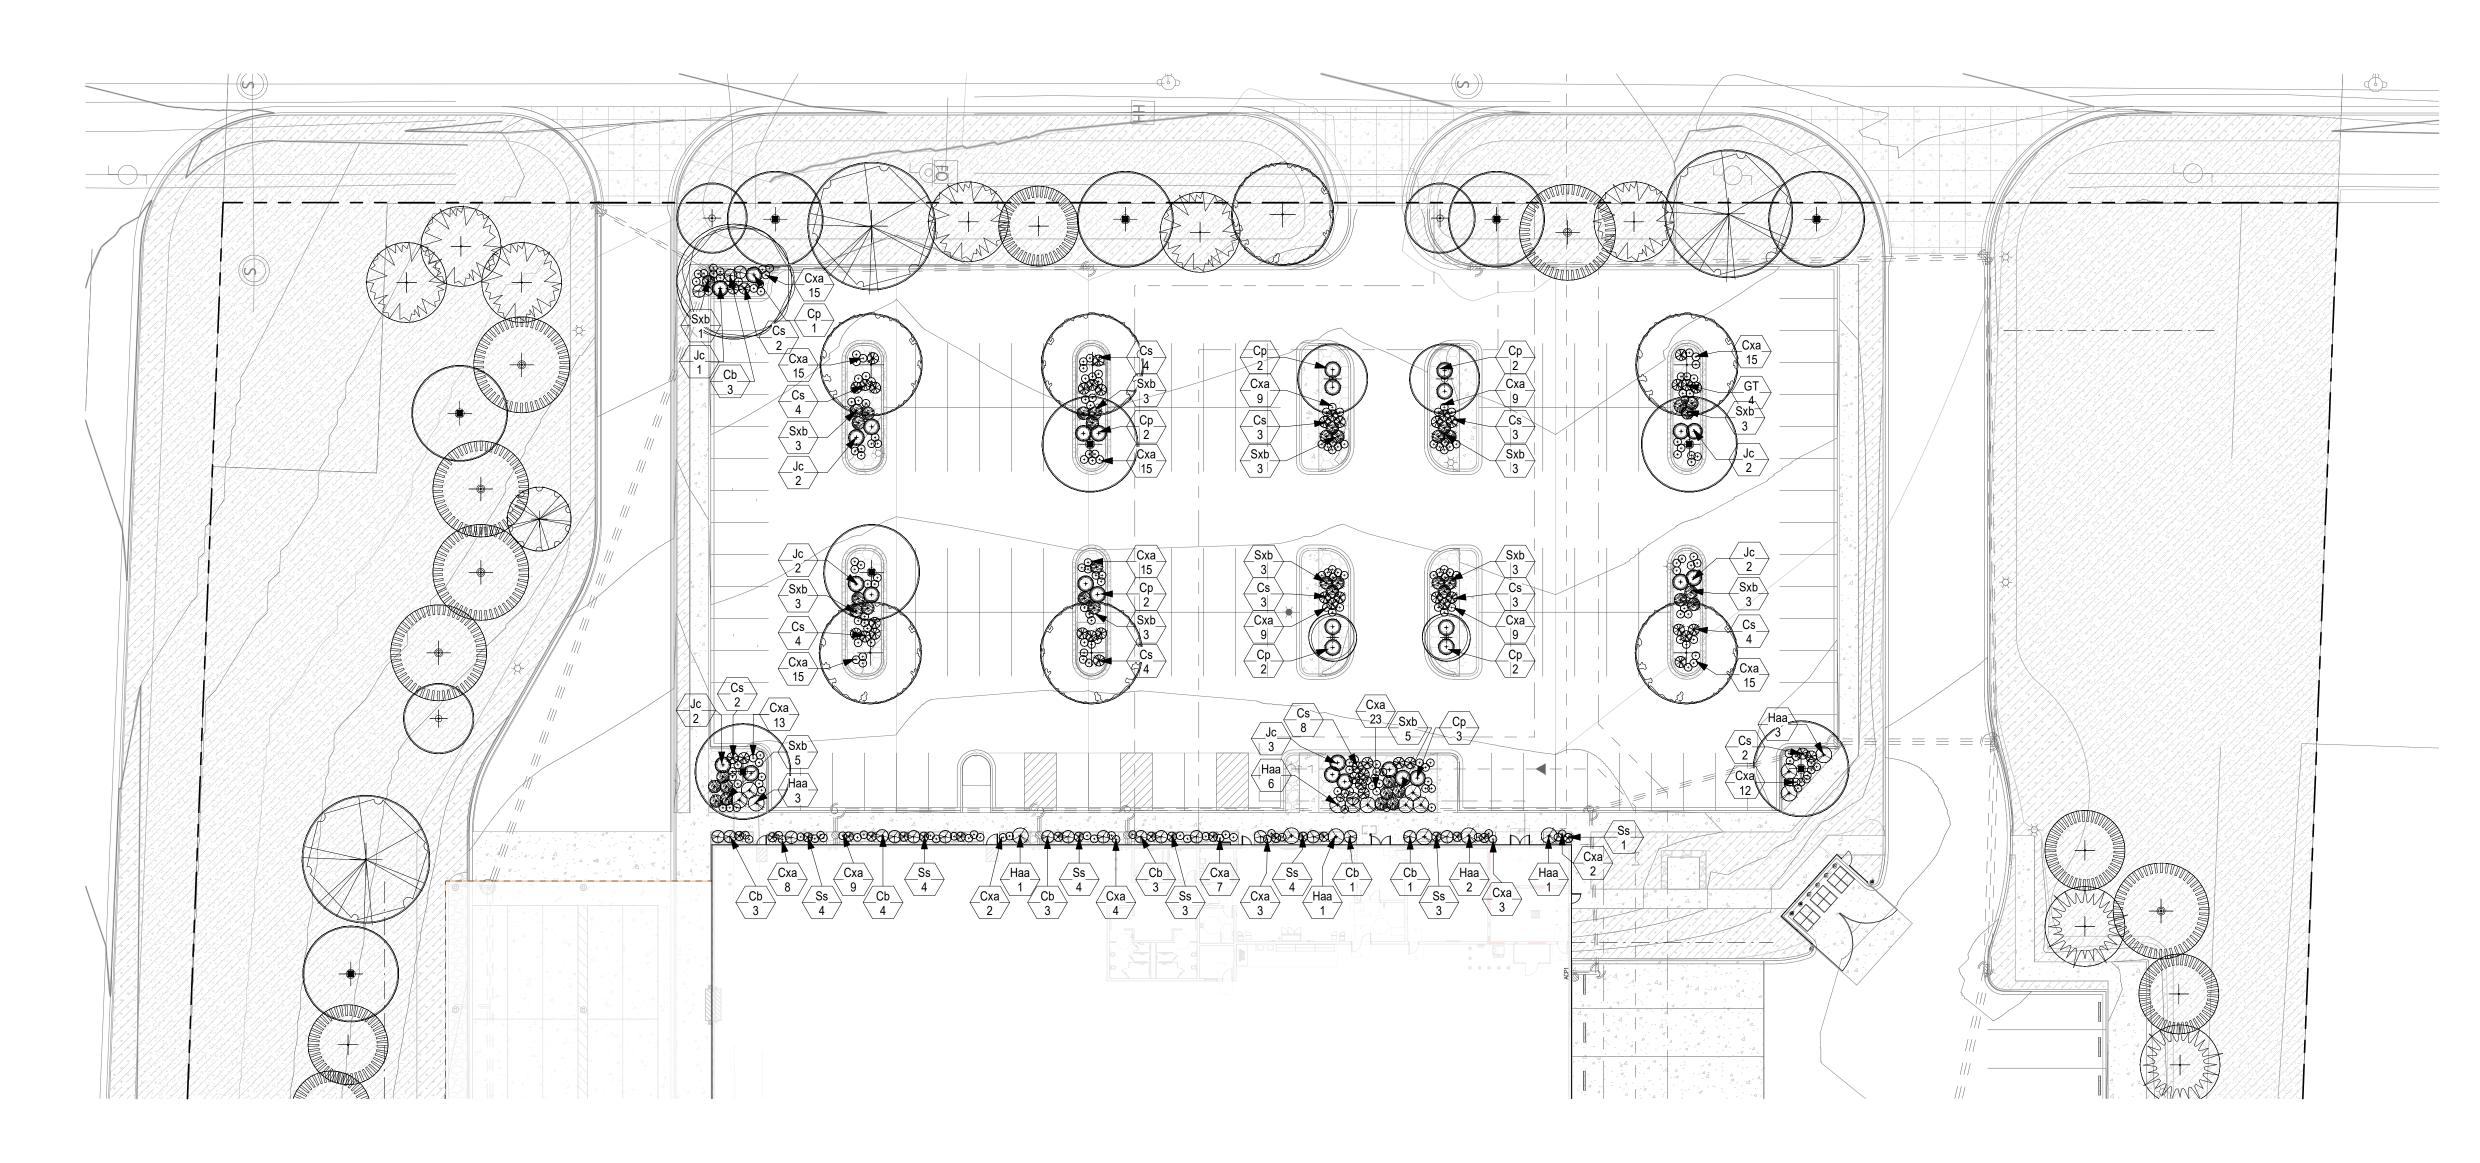

1 ENLARGED PLANTING PLAN DETAIL-NORTH
L401 1" = 30'-0"

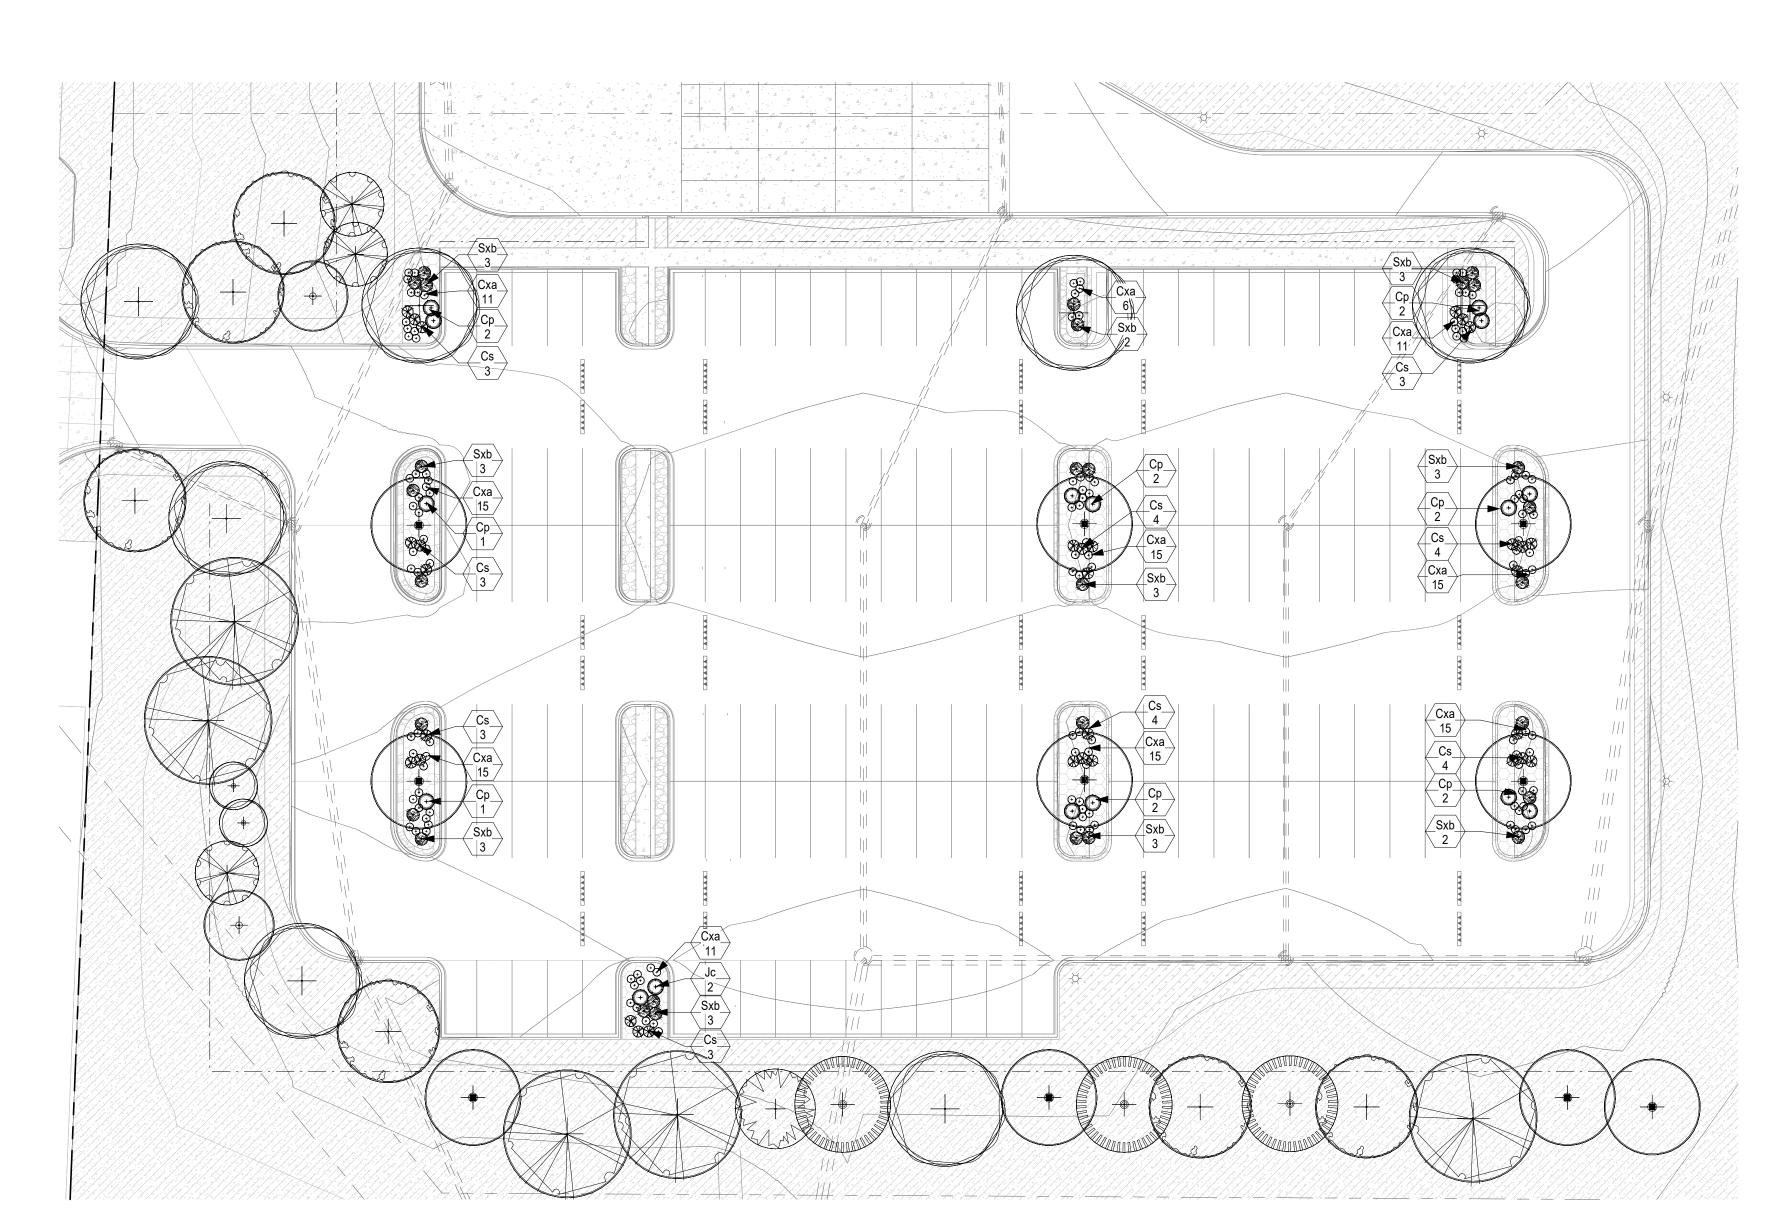

2 ENLARGED PLANTING PLAN DETAIL-SOUTH 1" = 30'-0"

GENERAL NOTES

——PLANTING NOTES

3. REFER TO L-500 FOR LANDSCAPE NOTES AND DETAILS.

INFORMATION.

SEE SHEET L400 FOR ADDITIONAL AND SUPPLEMENTAL PLANTING IDENTIFICATION
 ONLY SHRUBS/PERENNIALS ARE IDENTIFIED ON THIS PLAN FOR GRAPHIC CLARITY

1. REFER TO CIVIL GRADING PLAN FOR PROPOSED GRADING AND EROSION CONTROL

REFER TO CIVIL EXISTING CONDITIONS AND REMOVALS PLAN SHEET C101 & C102 FOR EXISTING TREE REMOVAL AND PRESERVATION INFORMATION.

4. THE LANDSCAPE PLANT SCHEDULE IS FOR THE CONVENIENCE TO THE LANDSCAPE

6. ALL TREES AND SHRUBS SHALL RECEIVE 4" OF SHREDDED HARDWOOD MULCH.

5. THIS PLAN ILLUSTRATES THE MINIMUM PLANTINGS TO BE PROVIDED FOR CITY APPROVAL. THE OWNER RETAINS THE RIGHT TO INCREASE PLANT SIZES / QUANTITIES.

SUBCONTRACTOR. THE LANDSCAPE SUBCONTRACTOR IS RESPONSIBLE FOR VERIFYING THE PLANT COUNTS ON PLAN.

ALL OPEN SPACE AREAS SHALL RECEIVE PLANT MATERIALS AND IRRIGATION. EXCLUDED FROM IRRIGATION AREAS IS THE BUILDING FOOTPRINT, HARDSCAPE AREAS, ROCK MULCH MAINTENANCE STRIPS AND AREAS BELOW THE NORMAL WATER LEVEL IN STOMWATER BMPS. AREAS RECEIVING NATIVE SEED SHALL BE ON A DEDICATED IRRIGATION ZONE.

Minneapolis, MN 55415 612-492-4000 tel 612-492-3000 fax

RYAN A+E, INC. 533 South Third Street, Suite 100

WWW.RYANCOMPANIES.COM

CONSULTANTS

——PLANT SCHEDULE— **KEY PLAN** SYM QTY ID COMMON NAME | SCIENTIFIC NAME | PLANTING SIZE | HEIGHT/WIDTH | COMMENTS BALSAM FIR PLANT PER Abies balsamea PLANT PER AB BALSAM FIR.1 Abies balsamea PA NORWAY PLANT PER Picea abies SPRUCE PLAN PLANT PER PA NORWAY Picea abies PROJECT INFORMATION SPRUCE.1 PROJECT TIMBER 1 PG BLACK HILLS Picea glauca densata 6' B&B 35'/22' PLANT PER WOLF 6 PG BLACK HILLS Picea glauca densata 4" B&B PLANT PER PLANT PER PS WHITE PINE Pinus strobus

-entities.							
+	5	PS	WHITE PINE.1	Pinus strobus	4" B&B	50'/30'	PLANT PER PLAN
Deciduous	33 Tree						-
+	12	AR	NORTHWOOD MAPLE	Acer rubrum 'Northwood'	3" B&B	50'/35'	PLANT PER PLAN
+	10	AR	NORTHWOOD MAPLE.1	Acer rubrum 'Northwood'	2" B&B	50'/35'	PLANT PER PLAN
+	4	СО	COMMON HACKBERRY	Celtis occidentalis	3" B&B	55'/40'	PLANT PER PLAN
+	4	СО	COMMON HACKBERRY.1	Celtis occidentalis	2" B&B	55'/40'	PLANT PER PLAN
+	6	GT	NORTHERN ACCLAIM HONEYLOCUST	Gleditsia triacanthos inermis 'Harve'	2.5" B&B	40'/30'	PLANT PER PLAN
+	8	GT	NORTHERN ACCLAIM HONEYLOCUST.1	Gleditsia triacanthos inermis 'Harve'	2" B&B	40'/30'	PLANT PER PLAN
	1	QE	NORTHERN PIN OAK	Quercus ellipsoidalis	2.5" B&B	50'/40'	PLANT PER PLAN
	7	QE	NORTHERN PIN OAK.1	Quercus ellipsoidalis	2" B&B	50'/40'	PLANT PER PLAN
Understor	52 v Dooi:	duous	Troo	1	1	1	-1
Unidersion	y Decid	AL	SPRING FLURRY	Amelanchier	2" B&B	30'/20'	PLANT PER

	52						
erstor	y Decid	duous	Tree				
+	7	AL	SPRING FLURRY SERVICEBERRY	Amelanchier laevis'JFS-Arb(PP15,30 4)	2" B&B	30'/20'	PLANT PER PLAN
	4	CC	THORNLESS HAWTHORN	Crataegus crus-galli var. inermis	2" B&B	20'/20'	PLANT PER PLAN
	4	MP	PINK SPIRES CRABAPPLE	Malus 'Pink Spires'	2" B&B	15'/12'	PLANT PER PLAN
	15						_
RUBS							
iferous	s Shrub)					

+	27	Ср	KINGS GOLD FALSE CYPRESS	Chamaecyparis pisifera 'Kings Gold'	#5 CONT.	4'/4'
+	19	Jc	SEA GREEN JUNIPER	Juniperus chinensis 'Sea Green'	#5 CONT.	5'/5'
Deciduou	46 Is Shru	ıb				
	22	Cb	NEON BURST DOGWOOD	Cornus alba 'ByBoughen'(PP27,956)	#5 CONT.	5'/4'
*	81	Cs	ARTIC FIRE DOGWOOD	Cornus stolonifera 'Farrow'(PP18,523)	#5 CONT.	5'/4'
	18	Наа	ANABELLE SMOOTH HYDRANGEA	Hydrangea arborescens `Annabelle`	#3 CONT.	5'/5'
	20	Ss	SEM FALSESPIREA	Sorbaria sorbifolia 'Sem'(PP16,336)	#5 CONT.	3'/3'
	70	Sxb	ANTHONY WATERER SPIRAEA	Spiraea x bumalda 'Anthony Waterer'	#5 CONT.	3'/4'

357 Cxa KARL FOERSTER Calamagrostis x acutiflora 'Karl Foerster' #5 CONT. 48"/30"

Baxter, MN I hereby certify that this plan, specification or report was prepared by me or under my direct supervision and that I am a duly Licensed Landscape Architect under the laws of the state of Minnesota JUSTIN C. BAGGENSTOSS

© 2024 RYAN A&E, INC.

REGISTRATION NO. DATE

PROJ. NO. ISSUE RECORD

ISSUE # DATE DESCRIPTION 06/18/2024 CITY RESUBMITTAL

CITY RESUBMITTAL

06/18/2024

ENLARGED PLANTING PLAN **DETAIL-NORTH**