

DO NOT BEGIN SITE UTILITY WORK UNTIL DRAWINGS HAVE BEEN RECEIVED FROM UTILITY COMPANY.

NO SITE LIGHTING IN THIS AREA

ALL SITE CIRCUITING IS DIAGRAMMATIC ONLY. DOES NOT INDICATE CONDUIT ROUTING. **ELECTRICAL CONTRACTOR IS TO DETERMINE** ALL FINAL CONDUIT ROUTING, COORDINATED WITH ALL SITE UTILITIES AND SITE CONDITIONS. REFERENCE CIVIL AND LANDSCAPE PLANS FOR ADDITIONAL INFORMATION.

Key Notes - Site

THESE NOTES APPLY TO THIS SHEET ONLY

- UNDERGROUND ELECTRIC CONDUIT, PULL BOXES, ETC. REFERENCE RISER DIAGRAM. ALL UTILITIES PER LATEST UTILITY COMPANY REQUIREMENTS. UNDERGROUND ELECTRIC SECONDARY. REFERENCE RISER DIAGRAM.
- COORDINATE FINAL CONNECTION POINT AND REQUIREMENTS WITH UTILITY PROVIDER ACCROSS FAYETTE STREET.
- COORDINATE FINAL POLE LIGHT LOCATIONS WITH CIVIL AND LANDSCAPE CONSULTANTS PRIOR TO DRILLING PIERS. REFERENCE STRUCTURAL ENGINEER FOR STRUCTURAL POLE BASE DETAILS.
- POWER AND FUSED DISCONNECT FOR SITE SIGN. PROVIDE 3 KW, 480 TO 277 OR 120 VOLT TRANSFORMER AS REQUIRED FOR SUPPLIED SIGN. PROVIDE 1" CONDUIT BACK TO MDF ROOM IN AREA 'C' FOR COMMUNICATION SIGN.
- NO FLAGPOLE LIGHTING AT FLAGPOLES
- ROUTE CIRCUIT THROUGH LIGHTING CONTACTOR SERVING SITE.
- EXISTING SERVICE TO BE REMOVED.




1905 Aldrich St Austin, Texas 78723 Tel: (512) 328-0011 • www.stantec.com

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Permit/Seal

FOR BIDDING AND CONSTRUCTION - 2022.03.21 Client/Project Logo

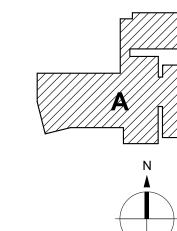

Client/Project **BASTROP ISD**

MINA ES ADDITIONS AND RENOVATIONS

Bastrop, TX 78602

SITE PLAN - ELECTRICAL

Scale As indicated Drawing No. **ES100**

HCE job no.: 21-047

THE SEAL APPEARING ON THIS DOCUMENT WAS AUTHORIZED BY B.J. HENDRIX, P.E. NO: 94813 ON: 03/21/2022


REFERENCE GENERAL NOTES ON SHEETS M101, P101, AND E101 FOR ADDITIONAL INFORMATION MEP/ENERGY CONSULTANTS

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ORIGINAL SHEET - ARCH E1

0 1 SITE PLAN - ELECTRICAL SCALE: 1" = 20'-0"



ORIGINAL SHEET - ARCH E1

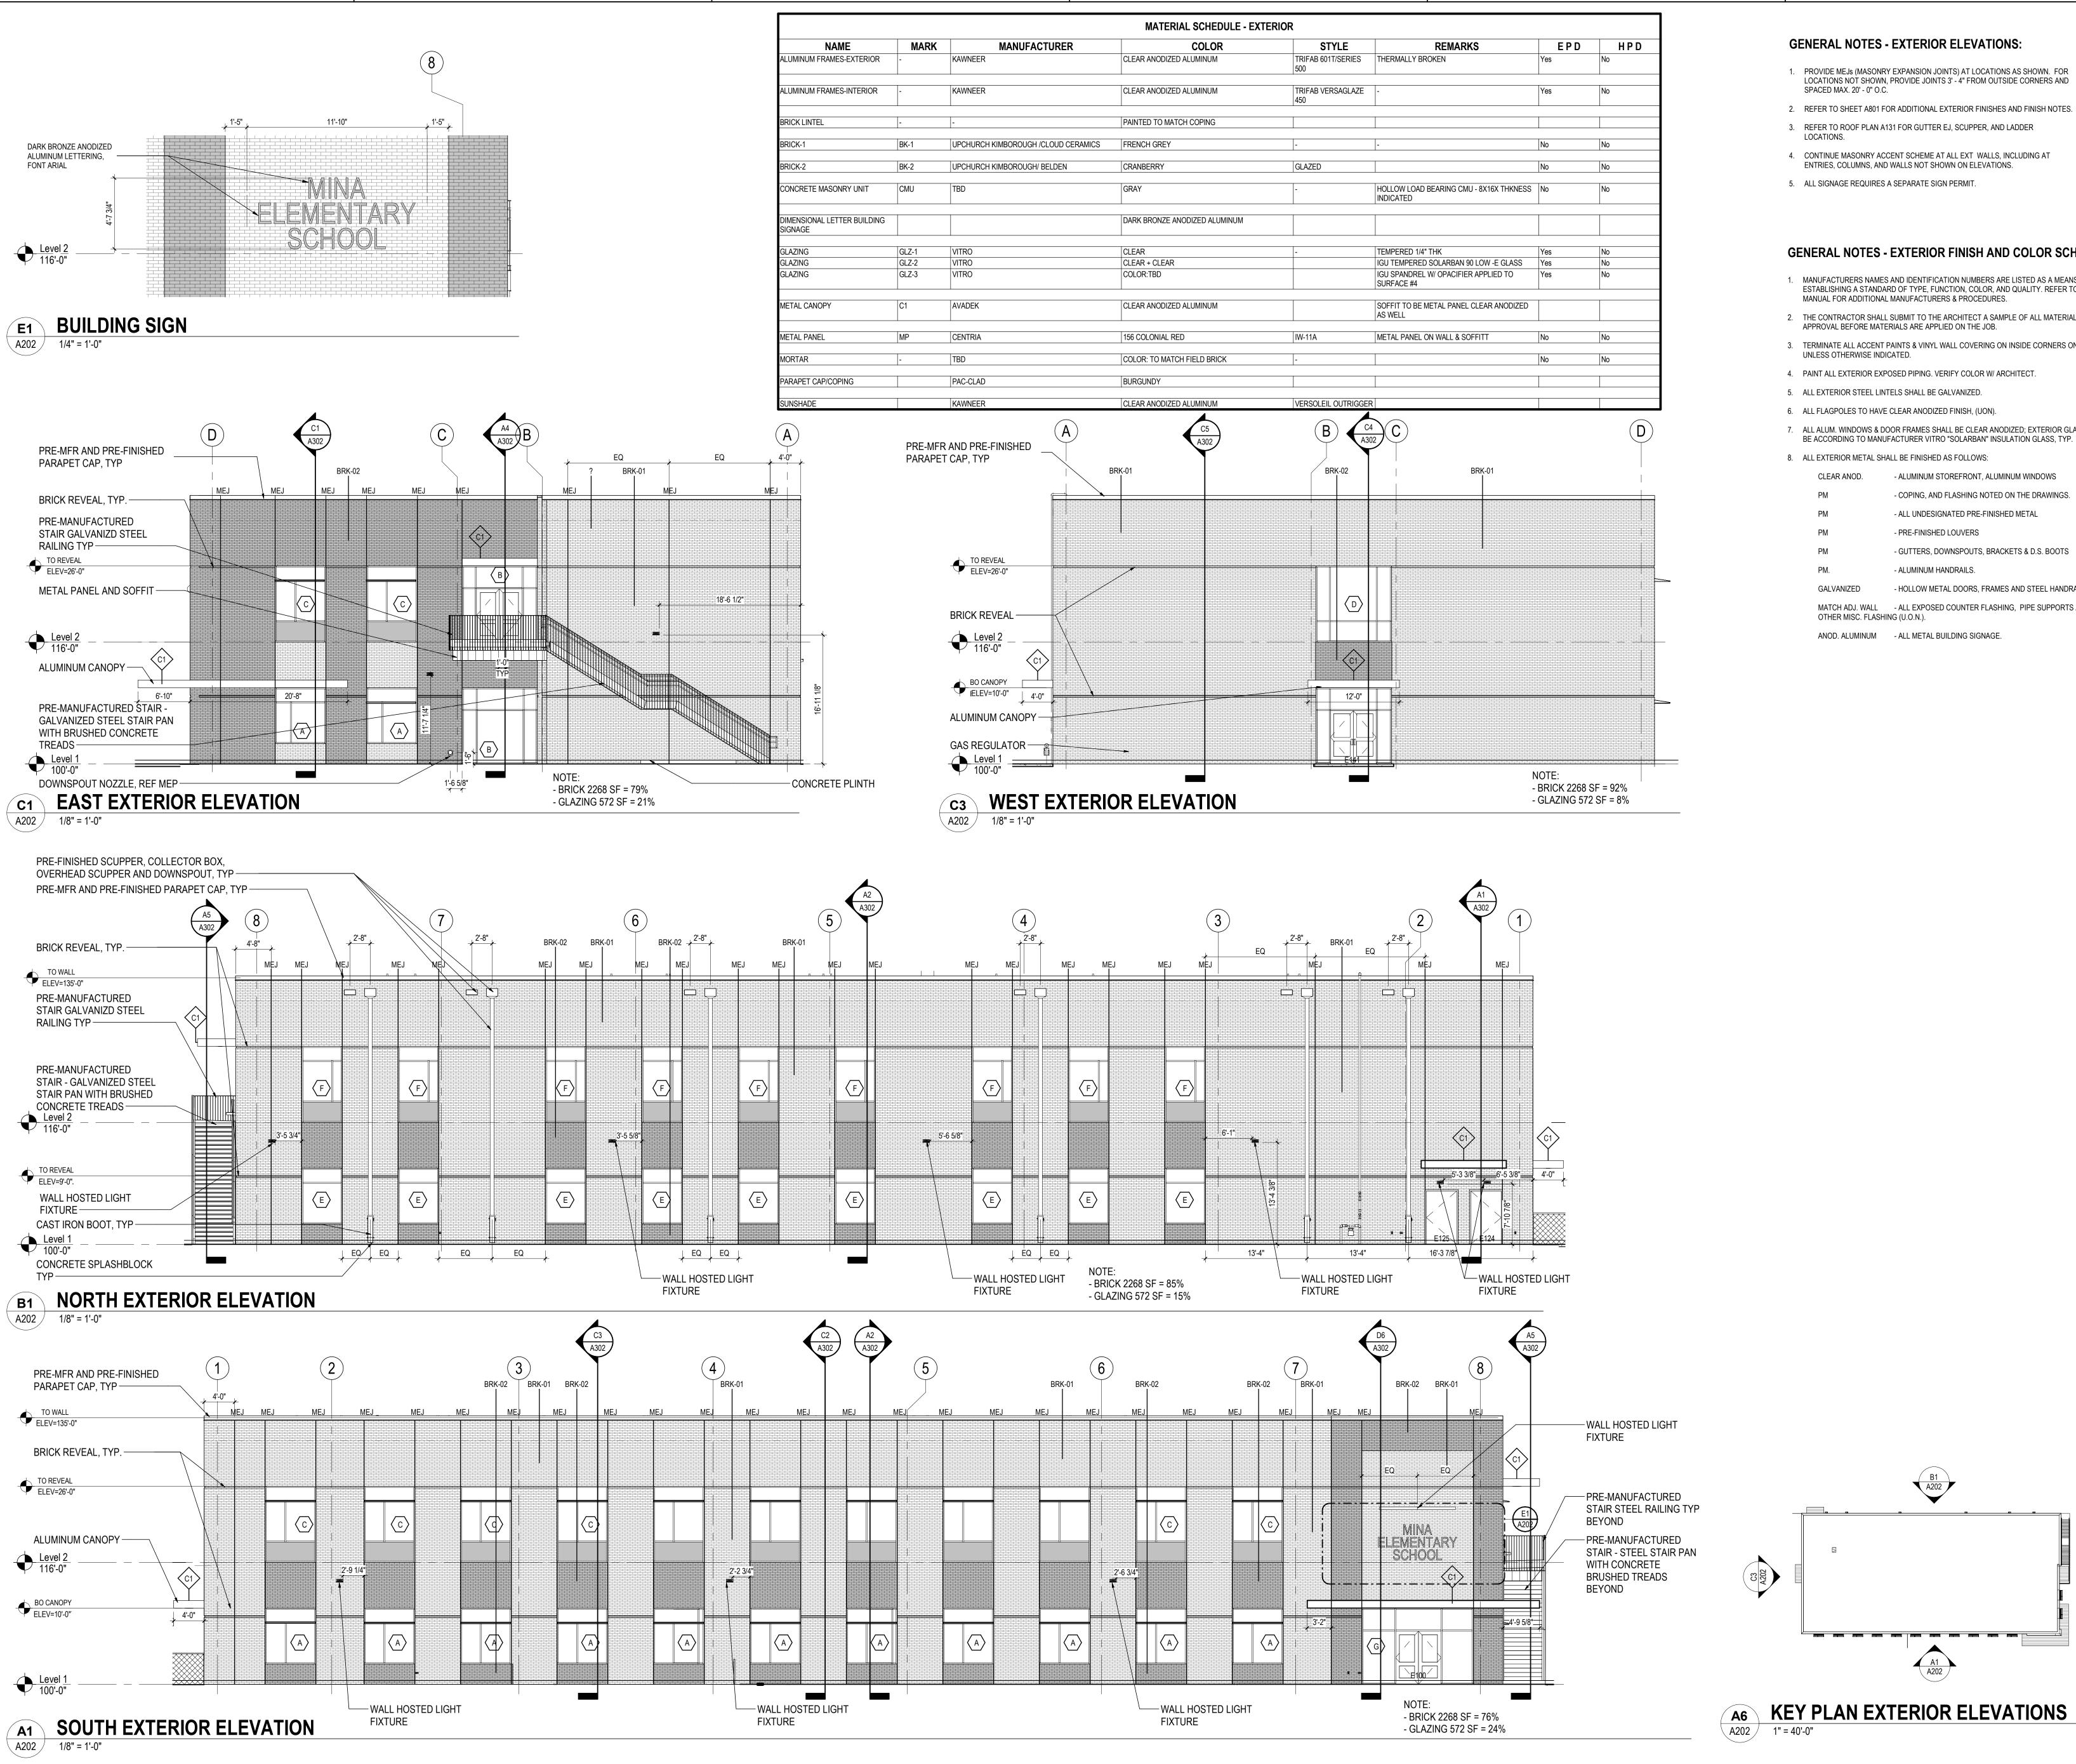

- 1. PROVIDE MEJS (MASONRY EXPANSION JOINTS) AT LOCATIONS AS SHOWN. FOR LOCATIONS NOT SHOWN, PROVIDE JOINTS 3' - 4" FROM OUTSIDE CORNERS AND SPACED MAX. 20' - 0" O.C.
- 2. REFER TO SHEET A801 FOR ADDITIONAL EXTERIOR FINISHES AND FINISH NOTES.
- 3. REFER TO ROOF PLAN A131 FOR GUTTER EJ, SCUPPER, AND LADDER
- 4. CONTINUE MASONRY ACCENT SCHEME AT ALL EXT WALLS, INCLUDING AT ENTRIES, COLUMNS, AND WALLS NOT SHOWN ON ELEVATIONS.
- 5. ALL SIGNAGE REQUIRES A SEPARATE SIGN PERMIT.

GENERAL NOTES - EXTERIOR FINISH AND COLOR SCHEDULE:

- 1. MANUFACTURERS NAMES AND IDENTIFICATION NUMBERS ARE LISTED AS A MEANS OF ESTABLISHING A STANDARD OF TYPE, FUNCTION, COLOR, AND QUALITY. REFER TO PROJECT MANUAL FOR ADDITIONAL MANUFACTURERS & PROCEDURES.
- 2. THE CONTRACTOR SHALL SUBMIT TO THE ARCHITECT A SAMPLE OF ALL MATERIALS FOR
- 3. TERMINATE ALL ACCENT PAINTS & VINYL WALL COVERING ON INSIDE CORNERS ONLY UNLESS OTHERWISE INDICATED.
- 4. PAINT ALL EXTERIOR EXPOSED PIPING, VERIFY COLOR W/ ARCHITECT.
- 5. ALL EXTERIOR STEEL LINTELS SHALL BE GALVANIZED.

APPROVAL BEFORE MATERIALS ARE APPLIED ON THE JOB.

- 6. ALL FLAGPOLES TO HAVE CLEAR ANODIZED FINISH, (UON).
- 7. ALL ALUM. WINDOWS & DOOR FRAMES SHALL BE CLEAR ANODIZED; EXTERIOR GLAZING TO
- BE ACCORDING TO MANUFACTURER VITRO "SOLARBAN" INSULATION GLASS, TYP.
- 8. ALL EXTERIOR METAL SHALL BE FINISHED AS FOLLOWS:

CLEAR ANOD. - ALUMINUM STOREFRONT, ALUMINUM WINDOWS - COPING, AND FLASHING NOTED ON THE DRAWINGS. - ALL UNDESIGNATED PRE-FINISHED METAL

- PRE-FINISHED LOUVERS

- GUTTERS, DOWNSPOUTS, BRACKETS & D.S. BOOTS

- ALUMINUM HANDRAILS. - HOLLOW METAL DOORS, FRAMES AND STEEL HANDRAILS.

A1 A202

MATCH ADJ. WALL - ALL EXPOSED COUNTER FLASHING, PIPE SUPPORTS AND OTHER MISC. FLASHING (U.O.N.).

ANOD. ALUMINUM - ALL METAL BUILDING SIGNAGE.

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Client/Project BASTROP ISD

(C1 A202

MINA ELEMENTARY SCHOOL

1203 Hill St Bastrop, TX 78602


EXTERIOR ELEVATIONS

Project No. 214000955 Revision

As indicated Drawing No.

Scale

A202

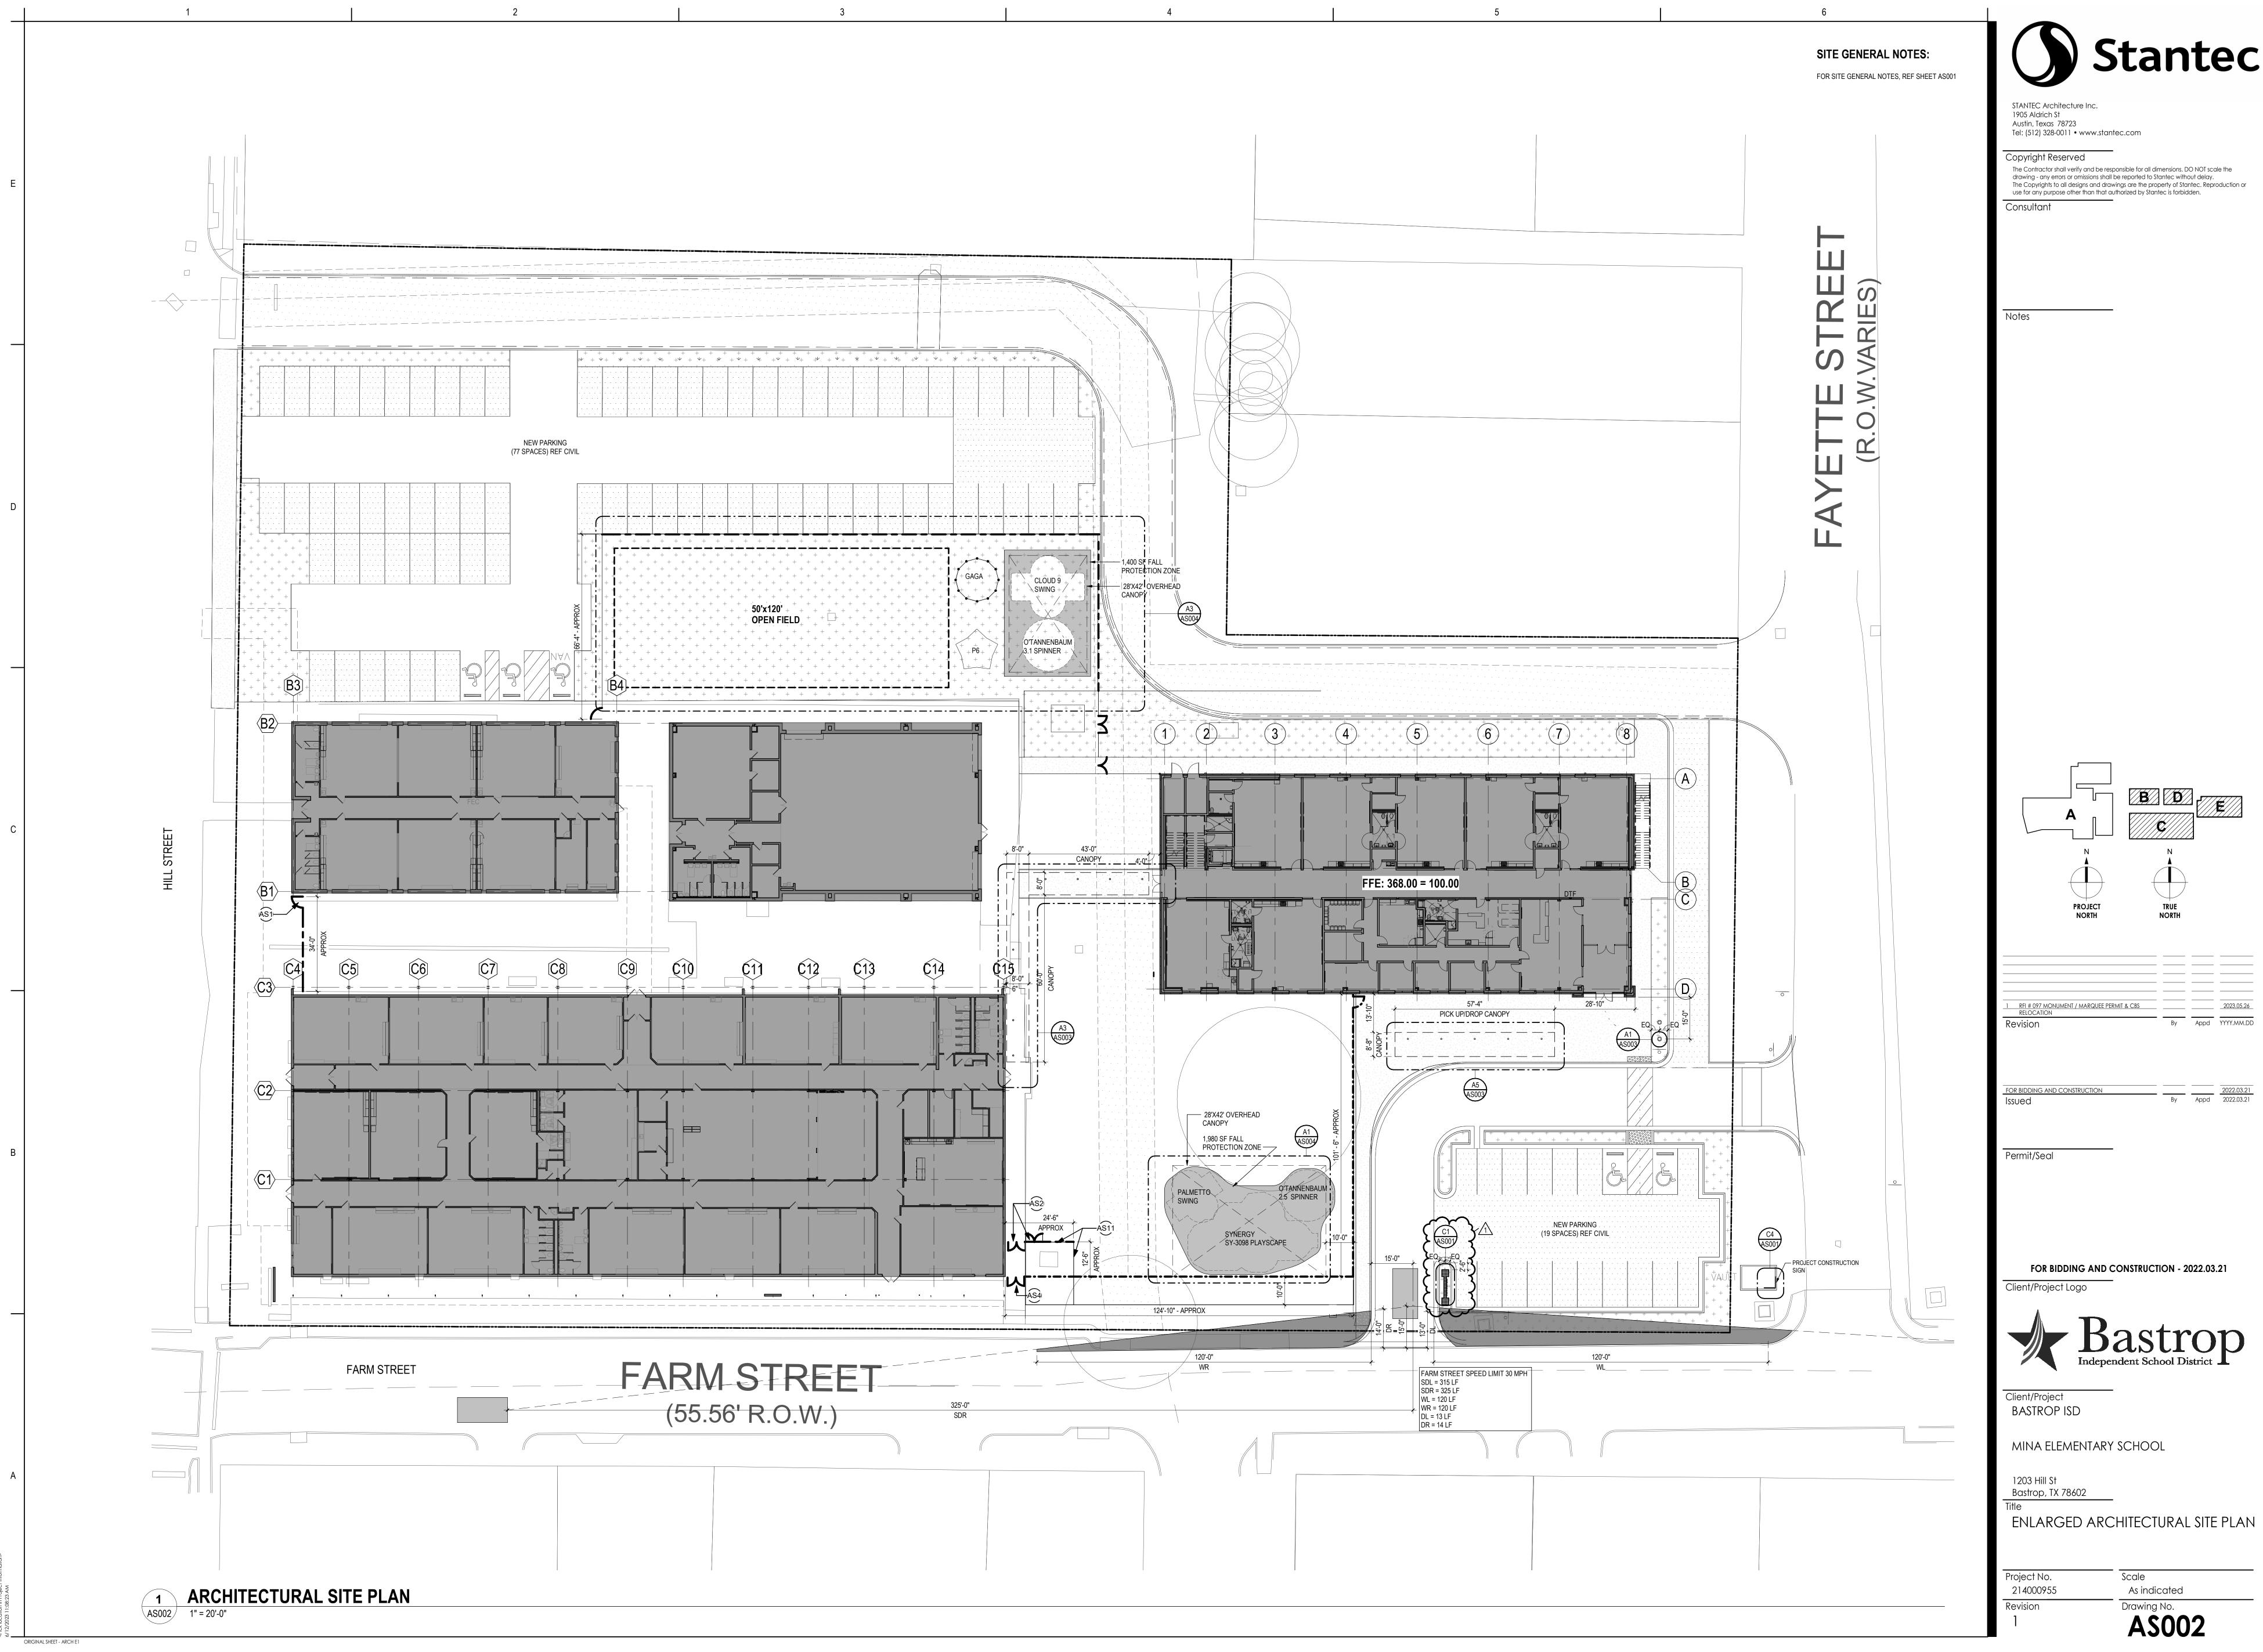

Stantec

Stantec Architecture Inc.

910 Louisiana Street, Suite 2600 Houston TX 77002-4916

March 6, 2023

Project/File: 214000955

City of Bastrop - Planning Department 1311 Chestnut Street Bastrop, TX 78602

To whom this may concern,

Reference: Monument Permit - Mina Elementary School Additions and Renovations

Please accept this letter and accompanying exhibits as our application for a Sign Variance for the Mina Elementary School building addition/renovation project.

The project includes a monument sign (marquee sign) which overall dimensions are, 7'-0" HT, 2'-6" depth and 12'-8" long, the sign will be built with a reinforced CMU on top of concrete foundation, the finish is with two brick tones matching the main building, and cover with a precast concrete cap. In the middle the sign will have a 4'-0" x 8'-0" sign box and on top of the sign box will be the school logo.

This sign has already been constructed and just needs approval for an interior LED bulb to be used to illuminate the sign.

The checklist and all required exhibits for the Monument Permit can be found in the attachments of this submittal. Should you have any questions or concerns regarding this Monument Permit submittal, please do not hesitate to contact our office.

Regards,

STANTEC ARCHITECTURE INC.

Amber O'Donnell Credentials

Principal

Phone: (512) 867-6012 aodonnell@stantec.com

Attachment: [AS001 - Architectural Site plan]