



Reed Ranch **Property Location Map**

90 180

Date: 8/11//2023

The accuracy and precision of this cartographic data is limited and should be used for information /planning purposes only. This data does not replace surveys conducted by registered Texas land surveyors nor does it constitute an "official" verification of zoning, land use classification, or other classification set forth in local, state, or federal regulatory processes. The City of Bastrop, nor any of its employees, do not make any warranty of merchantability and fitness for particular purpose, or assumes any legal liability or responsibility for the accuracy, completeness or usefullness of any such information, nor does it represent that its use would not infringe upon privately owned rights.

OWNER

ROSANKY, CHARLES G FAMILY TRUST 615 HWY 71 W BASTROP, TX 78602

DEVELOPER

HOLT LUNSFORD HOLDINGS 5950 BERKSHIRE LANE, SUITE 900 DALLAS, TX 75225

ARCHITECT

ARCHON CORPORATION 210 N. PARK BLVD, SUITE 100 GRAPEVINE, TX 76051

ENGINEER

Westwood Professional Services, Inc.

HOLLIS SCHEFFLER, P.E. 8701 N. MOPAC EXPY, SUITE 320 AUSTIN, TEXAS 78759 PHONE: (512) 485-0831

SURVEYOR

Westwood Professional Services, Inc.

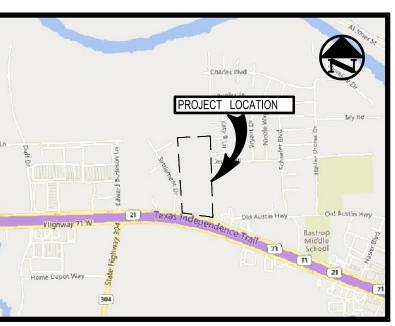
MICHAEL JACK NEEDHAM 8701 N. MOPAC EXPY, SUITE 320 AUSTIN, TEXAS 78759 PHONE: (512) 485-0831

LEGAL DESCRIPTION:

A98 BLAKEY, NANCY, ACRES 23.0400

ZONING CONCEPT PLANS FOR

REED RANCH 615 SH 71 W BASTROP TX, 78602



VICINITY MAP

PROJECT ZONING: P-2

PROJECT ADDRESS:
615 SH 71 W

SUBMITTAL DATE: JULY 10, 2032

SI	heet List Table
Sheet Number	Sheet Title
1	COVER
2	PEDESTRIAN SHED
3	PD SITE PLAN
4	LOT AND BLOCK LAYOUT
5	EXISTING DRAINAGE AREA MAP
6	PROPOSED DRAINAGE AREA MAF
7	UTILITY PLAN 1 OF 2
8	UTILITY PLAN 2 OF 2
<u> </u>	

DATE DESCRIPTION BY
DATE
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615 SH 71 W
BASTROP TX, 7860

PRELIMINARY

NOT FOR CONSTRUCTION

IIS DOCUMENT IS ISSUED FOR THE IRPOSE OF SCHEMATIC REVIEW ONLY
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ANS PREPARED UNDER THE DIRECT PERWISION OF HOLLIS ANN SCHEFLER, P.E. TEXAS ICEISTRATION NO. 136049.

DESIGN DRAWN
JDW CAH

SHEET NO.

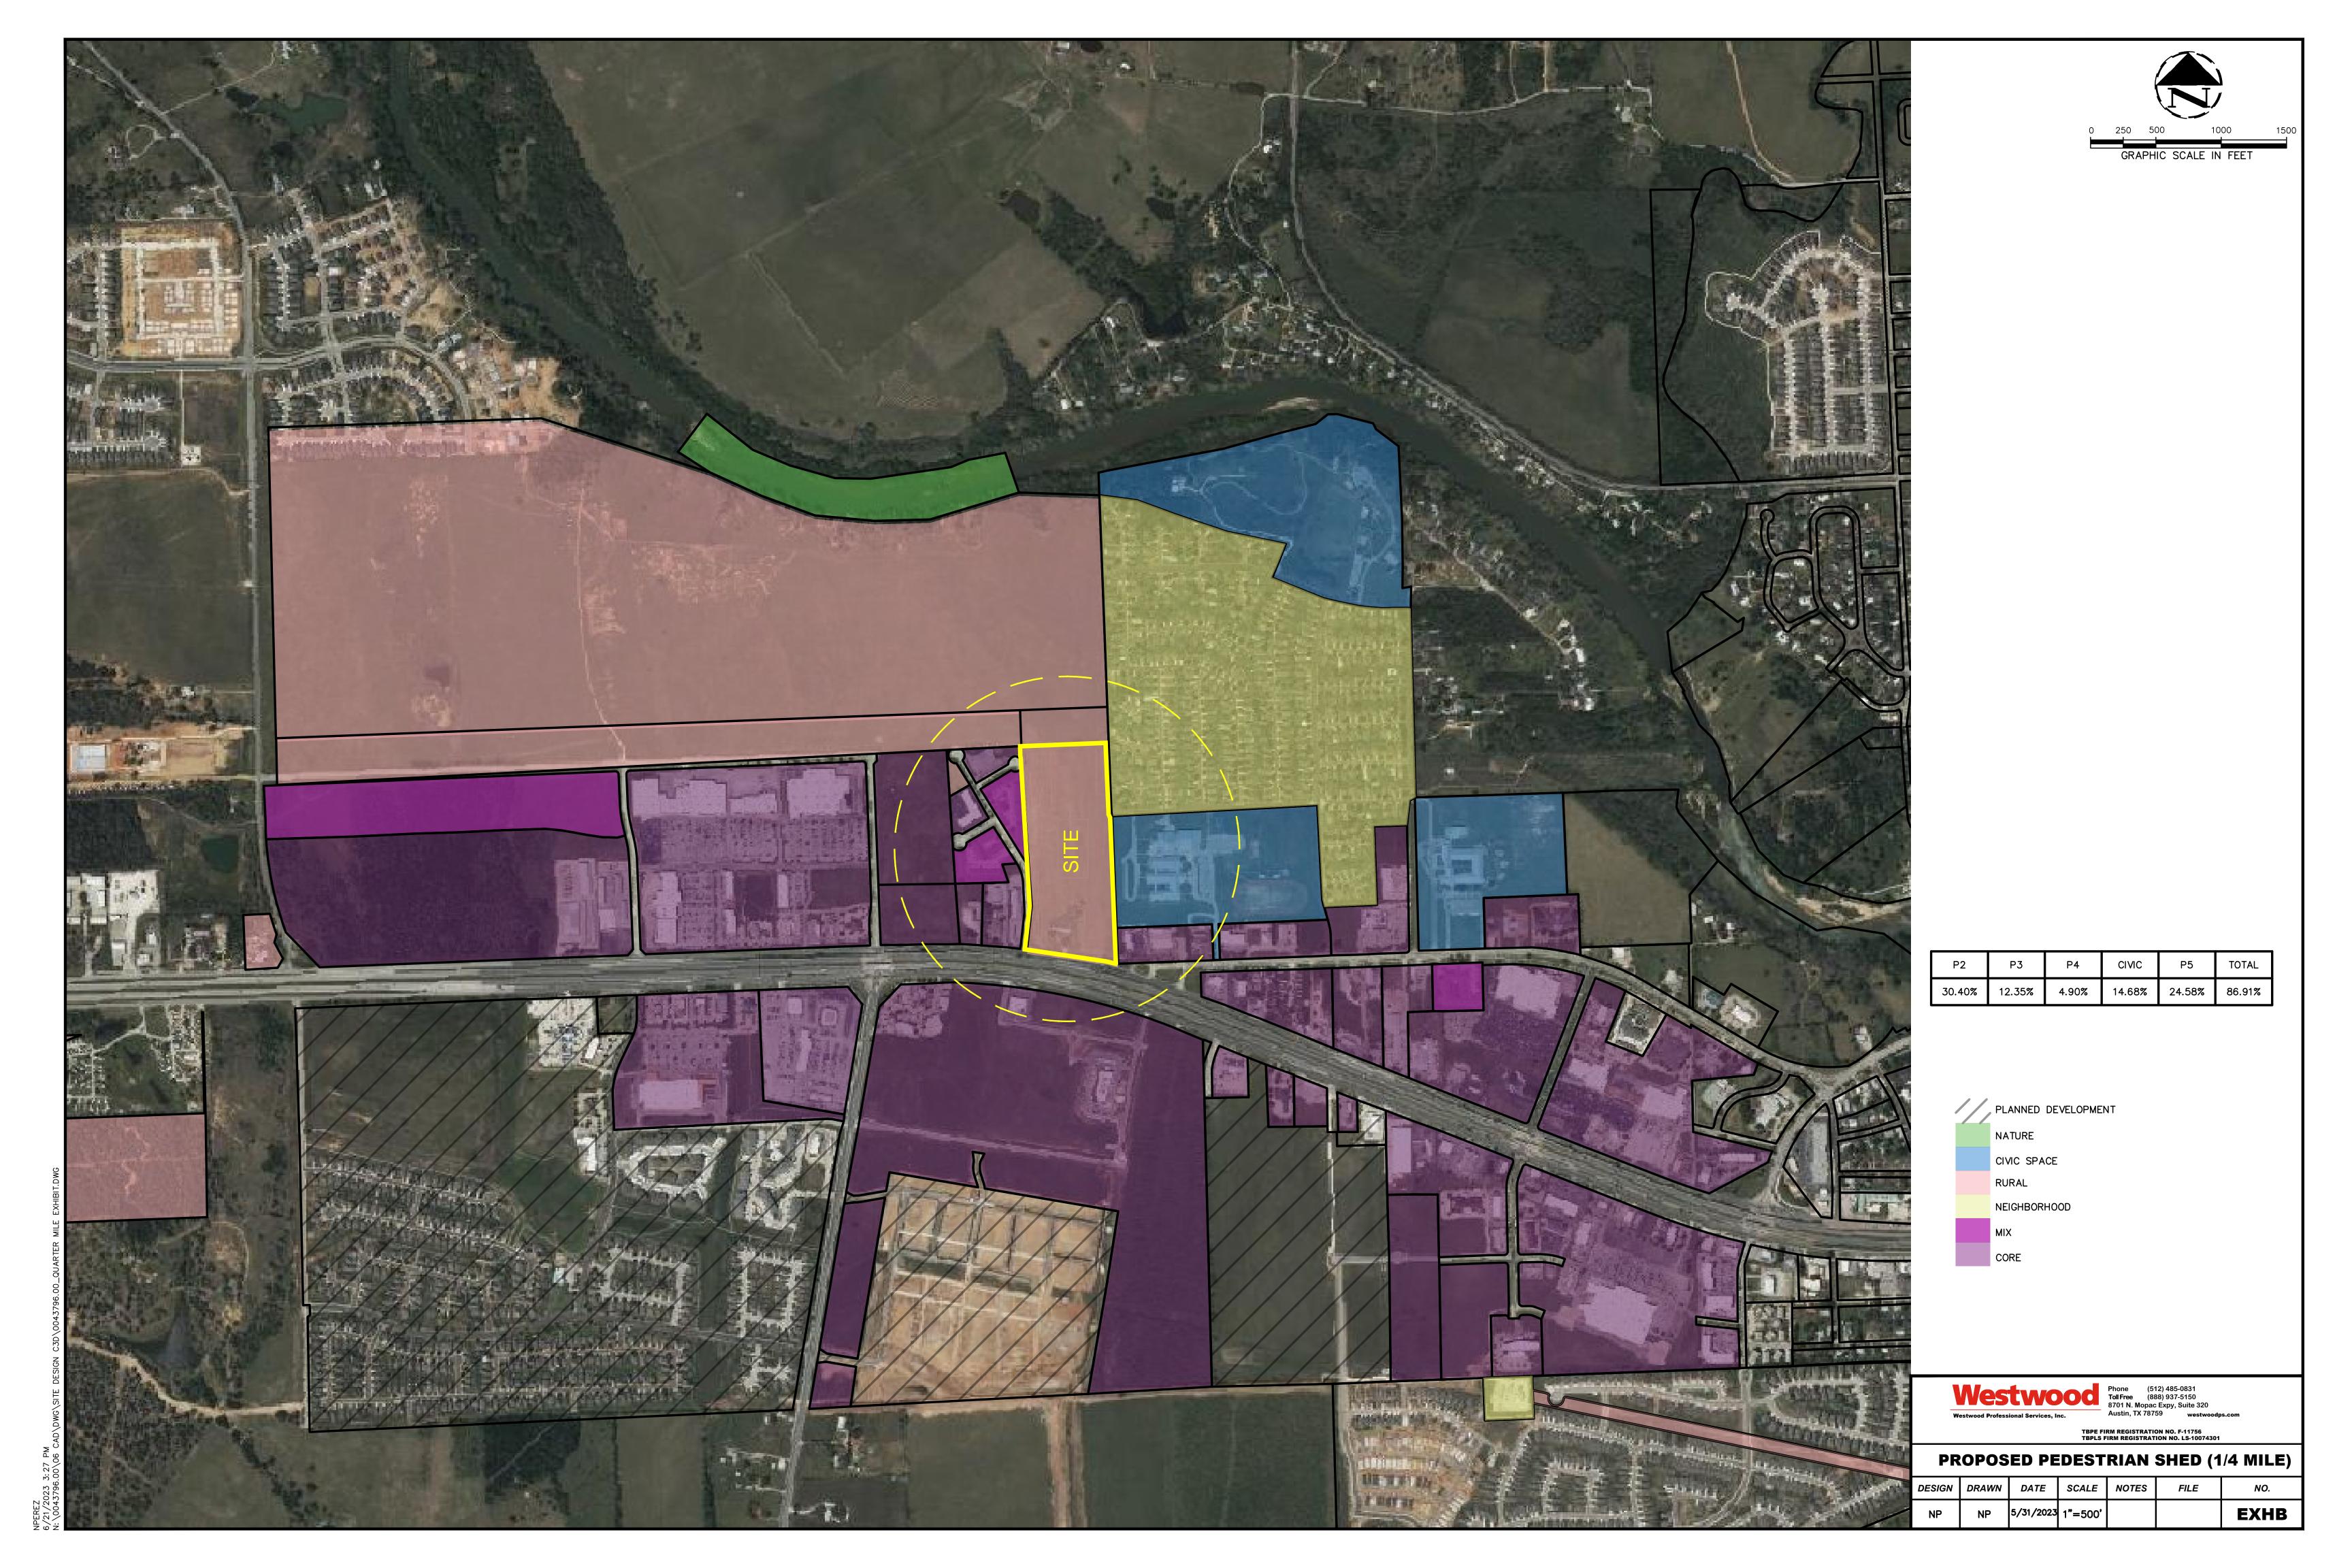
PREPARED BY

Phone (512) 485-0831 8701 N. Mopac Expy, Suite 320 Toll Free (888) 937-5150 Austin, TX 78759

Westwood Professional Services, Inc.
TBPE FIRM REGISTRATION NO. F-11756

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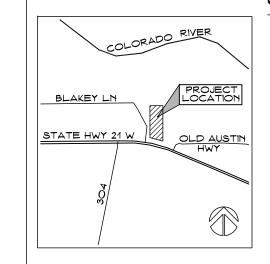


ARCHITECT: GARY G. WOOD

DATE: 10 JUL 23

#12202 PRELIMINARY - NOT TO BE USED FOR REGULATORY APPROVAL, PERMITTING, OR CONSTRUCTION

SITE PLAN



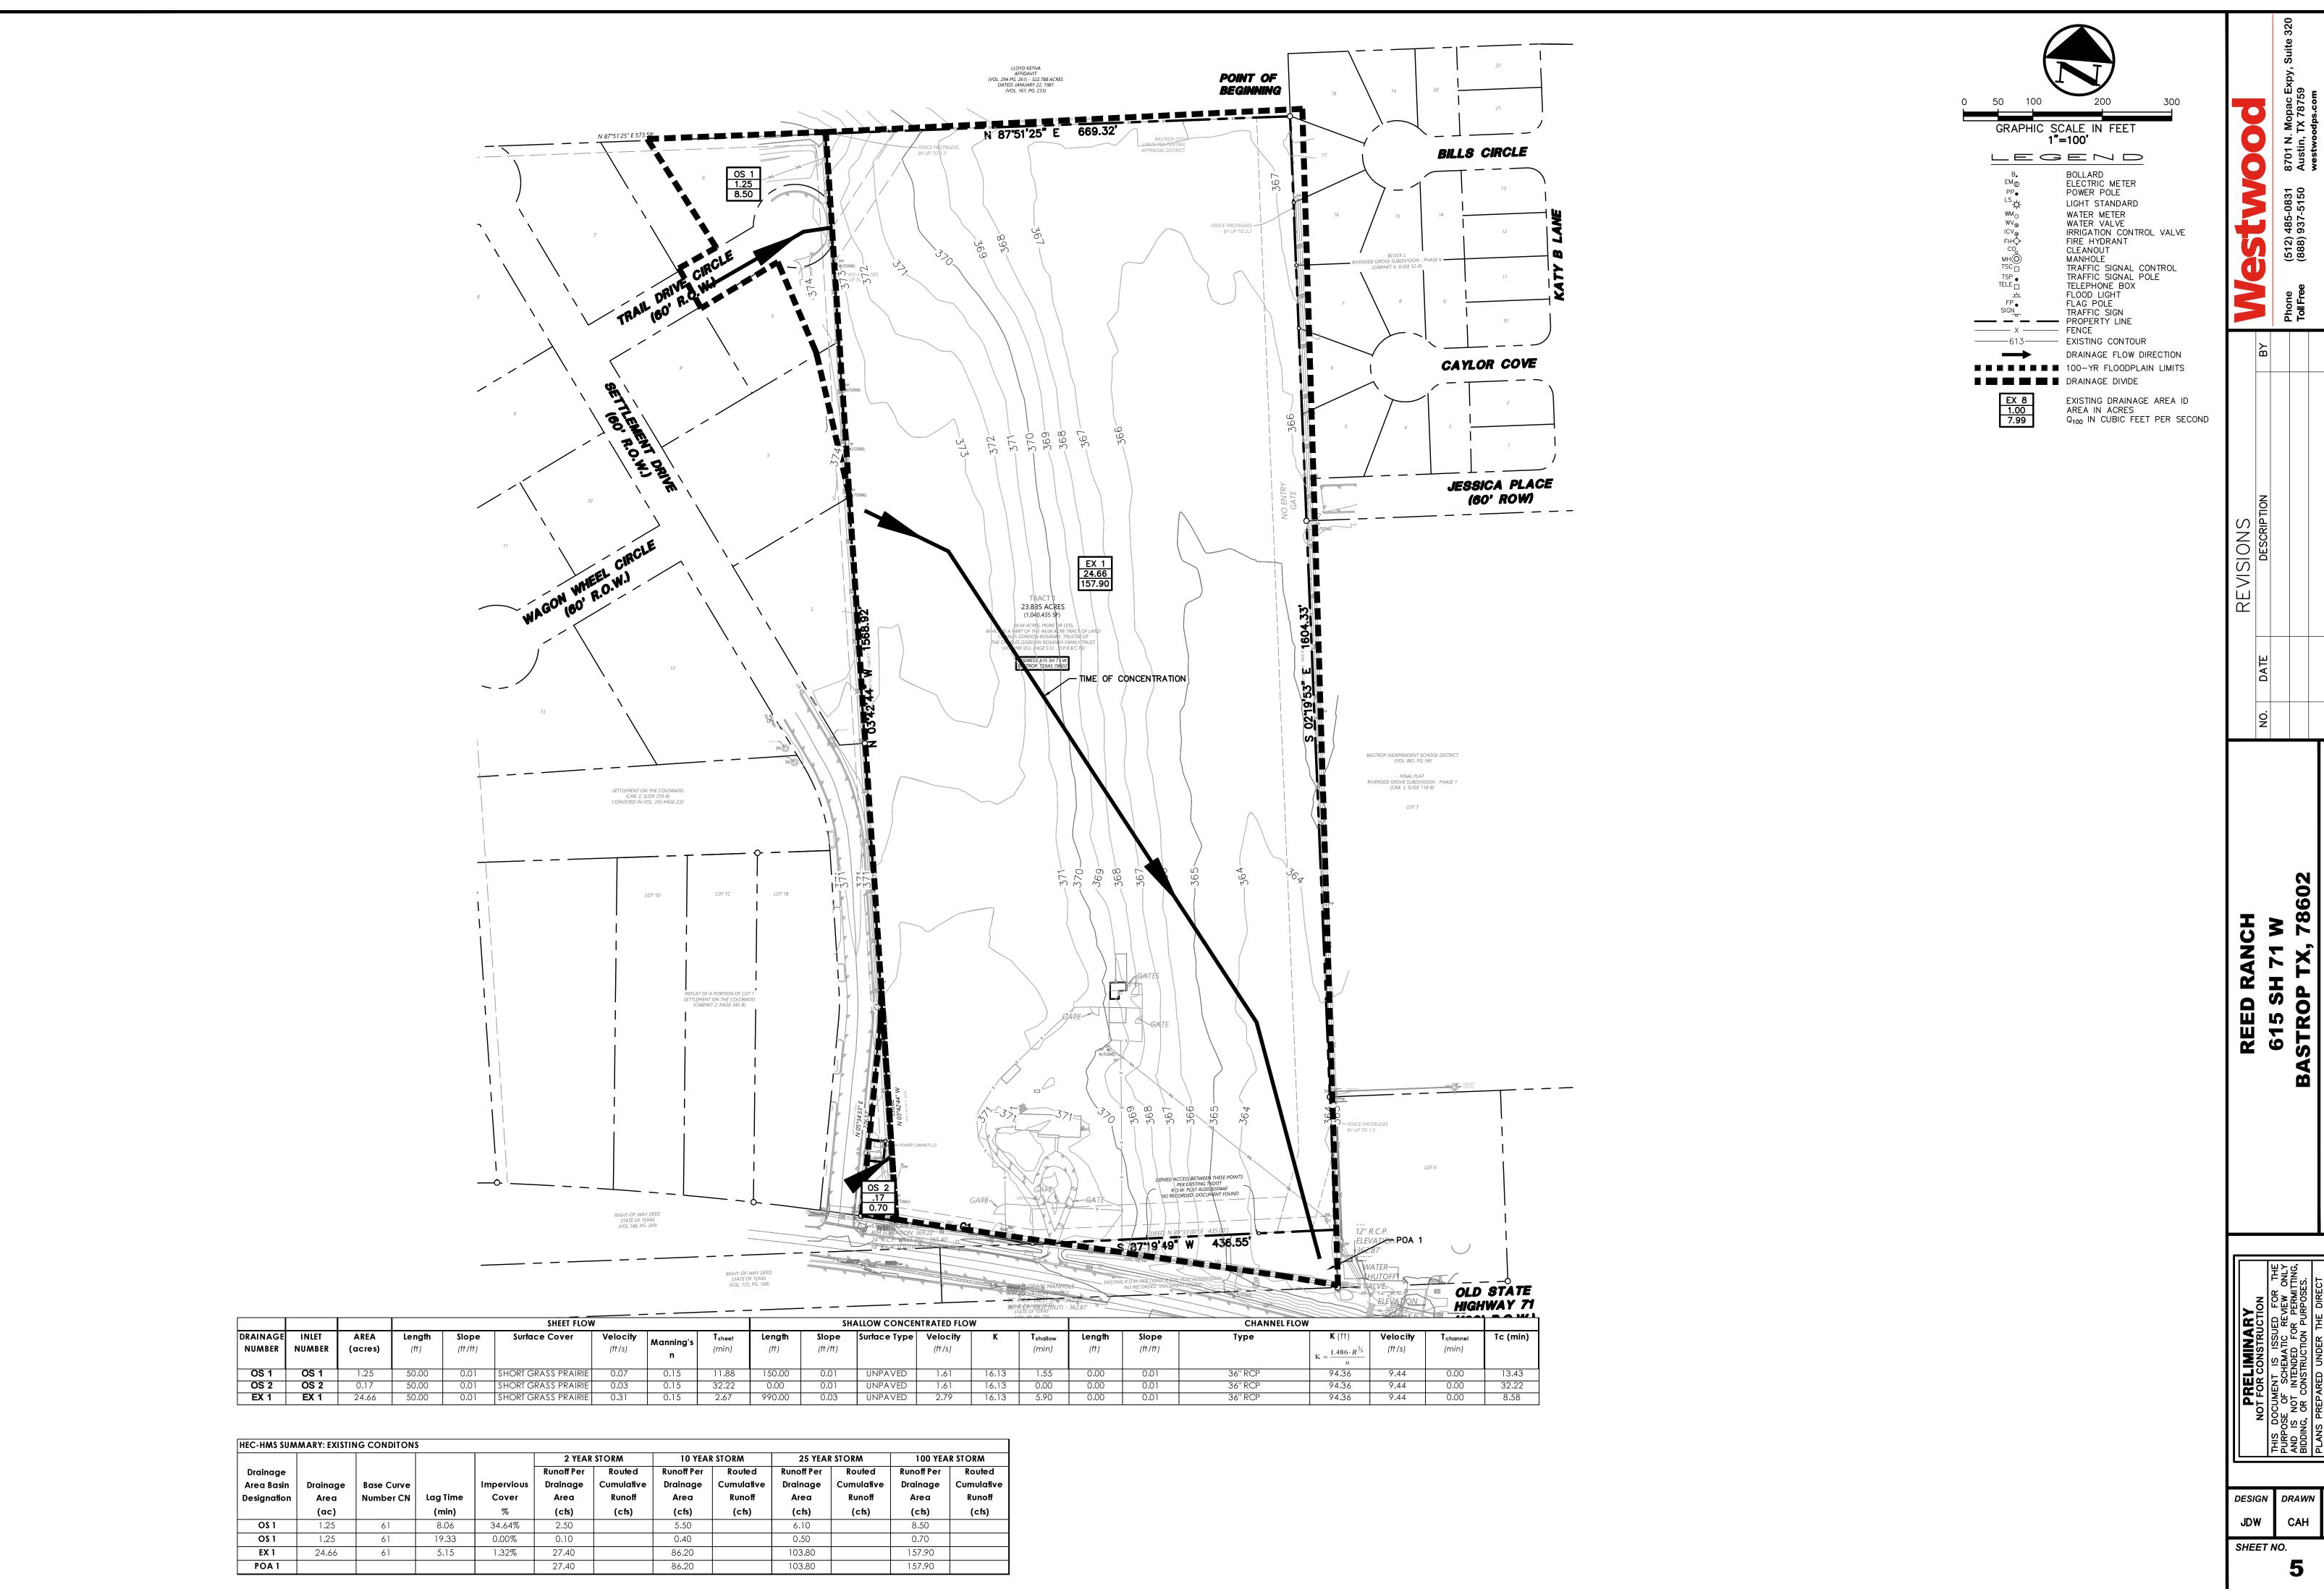
PROJECT NAME: ACERAGE: 24.3 A.

REED RANCH 10 JUL 23

0 10 30 60 SCALE : 1" = 60'-0"

CORPORATION ARCHITECTS / PLANNERS 210 NORTH PARK BLVD. SUITE 100 - GRAPEVINE, TX 76051 214/526-0731





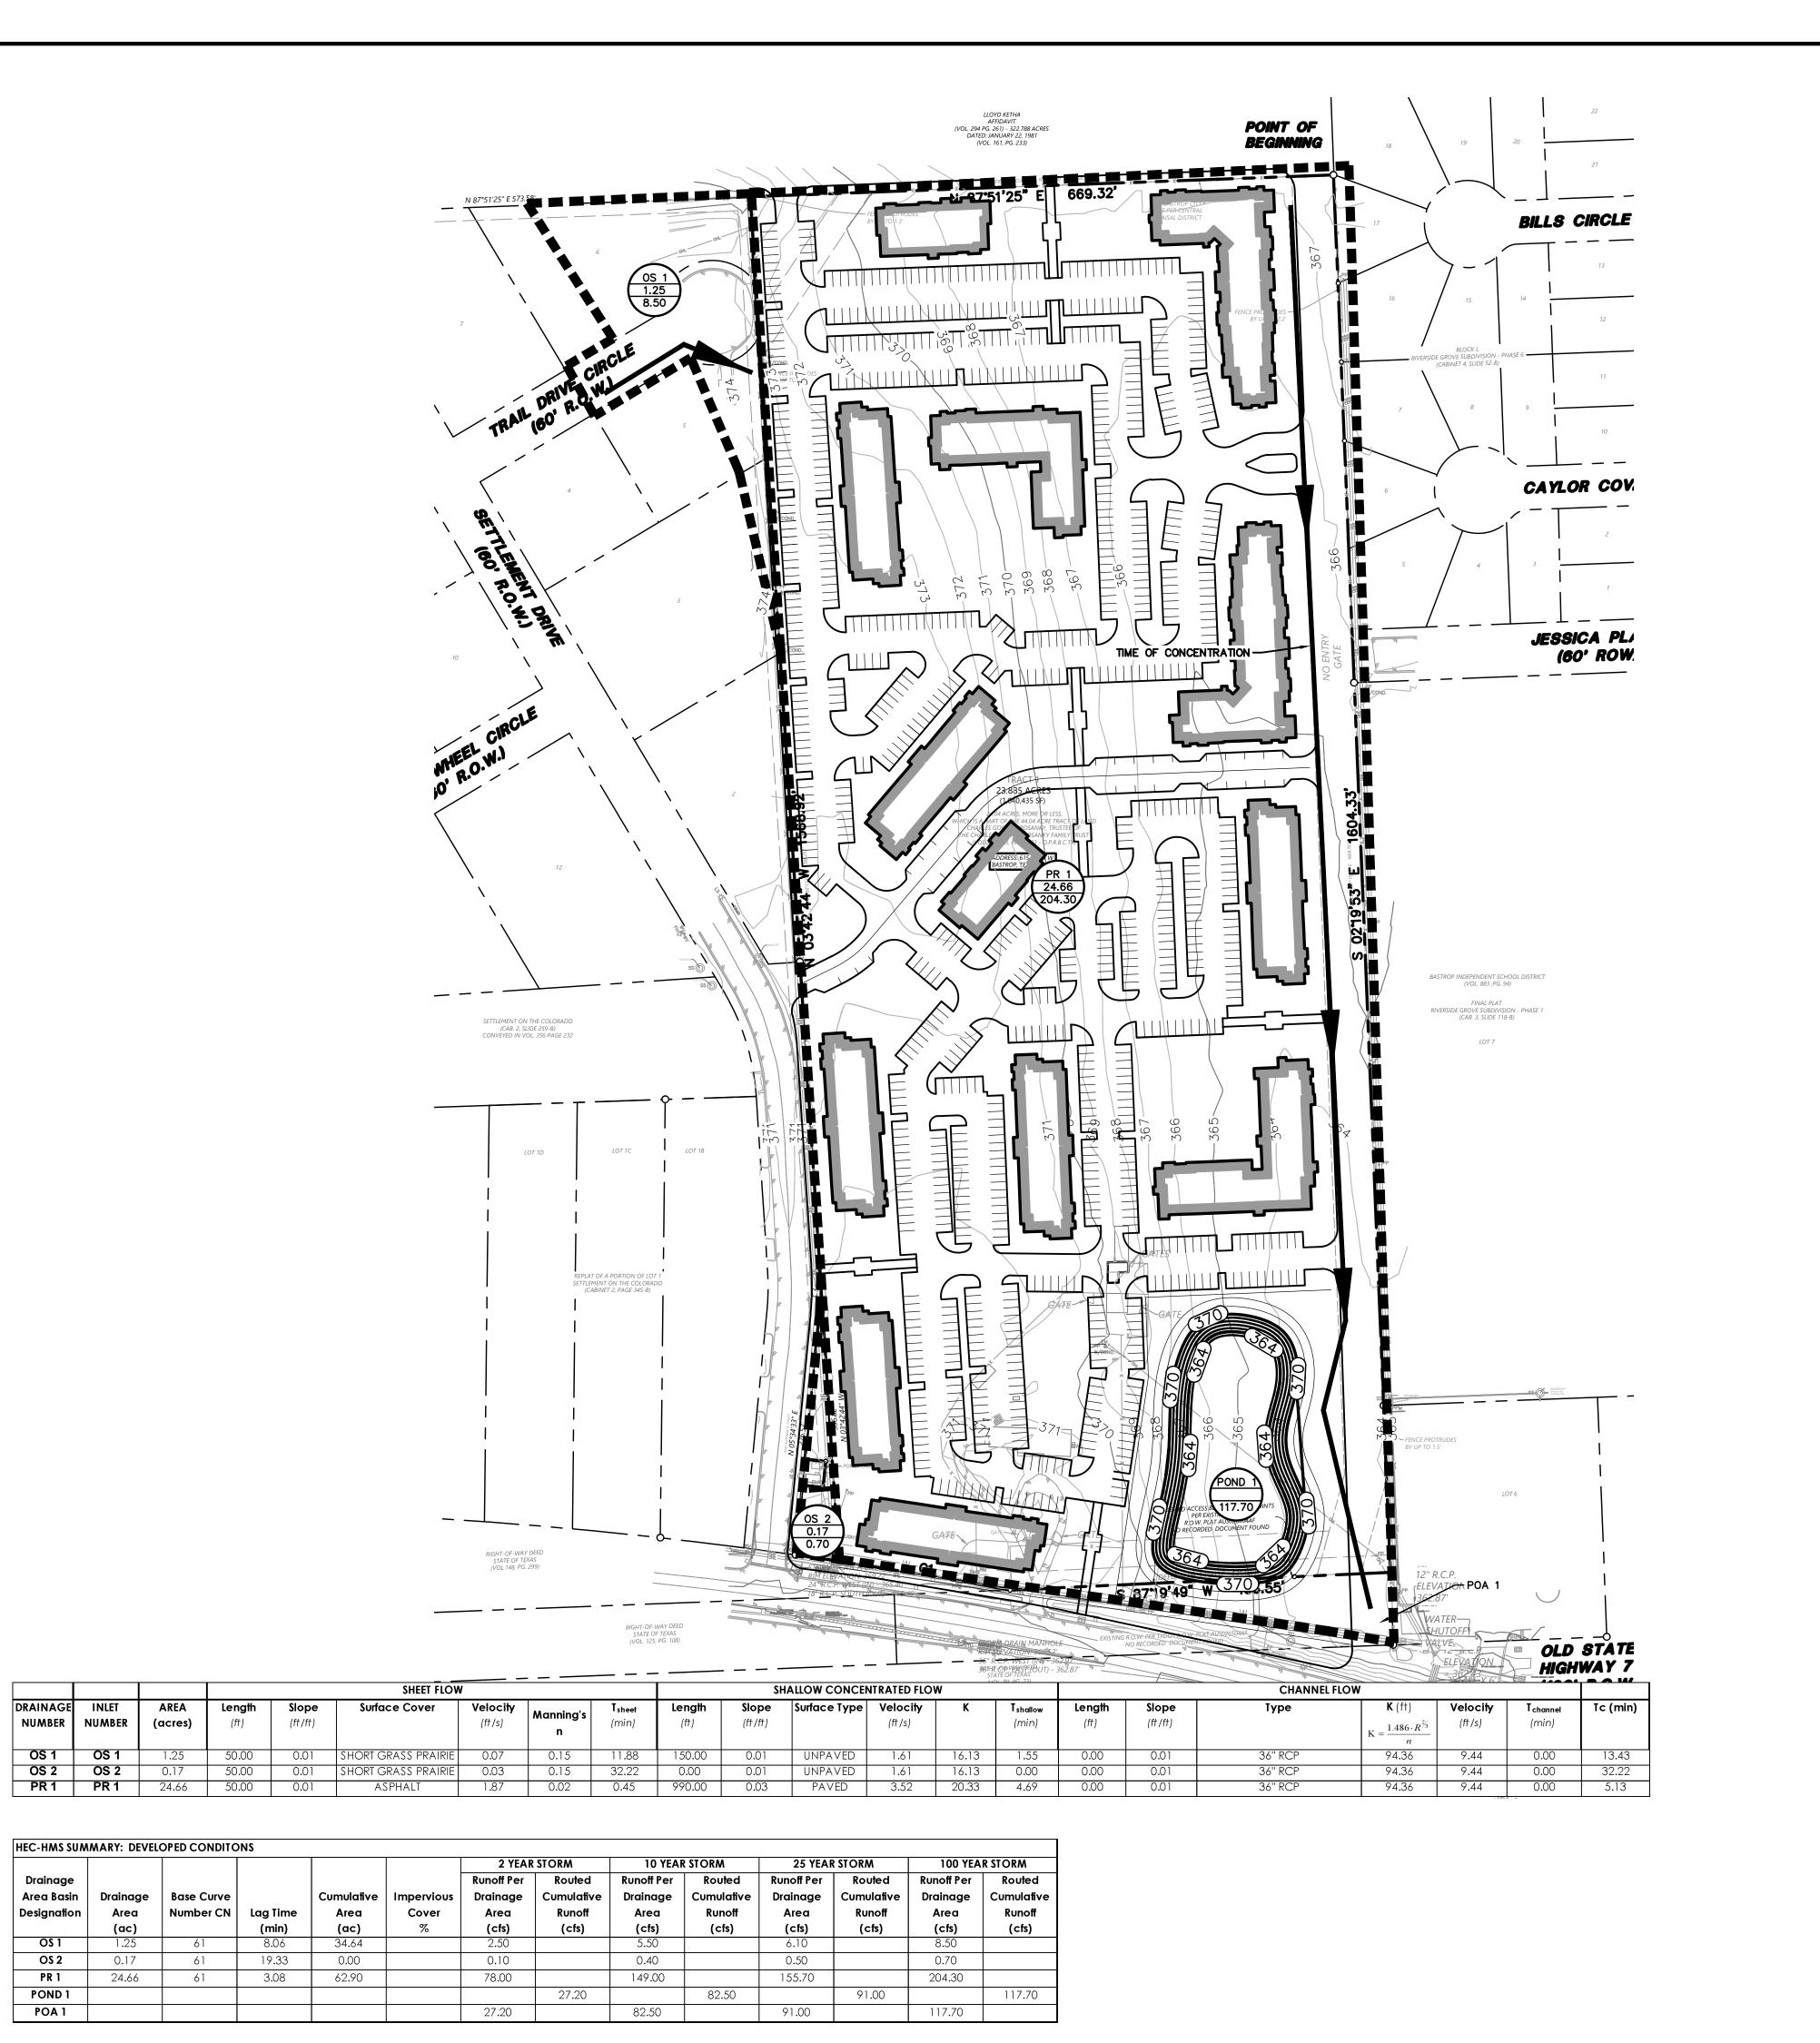
PK-0043796_DAMS.DWG

JULY 2023

DATE

5 OF 8

DRAIN





GRAPHIC SCALE IN FEET

1"=100"

BOLLARD ELECTRIC METER POWER POLE LIGHT STANDARD WATER METER WATER METER WATER VALVE IRRIGATION CONTROL VALVE FIRE HYDRANT CLEANOUT

CLEANOUT
MANHOLE
TRAFFIC SIGNAL CONTROL
TSP TRAFFIC SIGNAL POLE
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PROPOSED CONTOUR DRAINAGE FLOW DIRECTION ■ ■ ■ ■ ■ ■ ■ 100-YR FLOODPLAIN LIMITS ■ ■ ■ ■ ■ DRAINAGE DIVIDE

PROPOSED DRAINAGE AREA ID AREA IN ACRES Q₁₀₀ IN CUBIC FEET PER SECOND

REVISIONS DESCRIPTI

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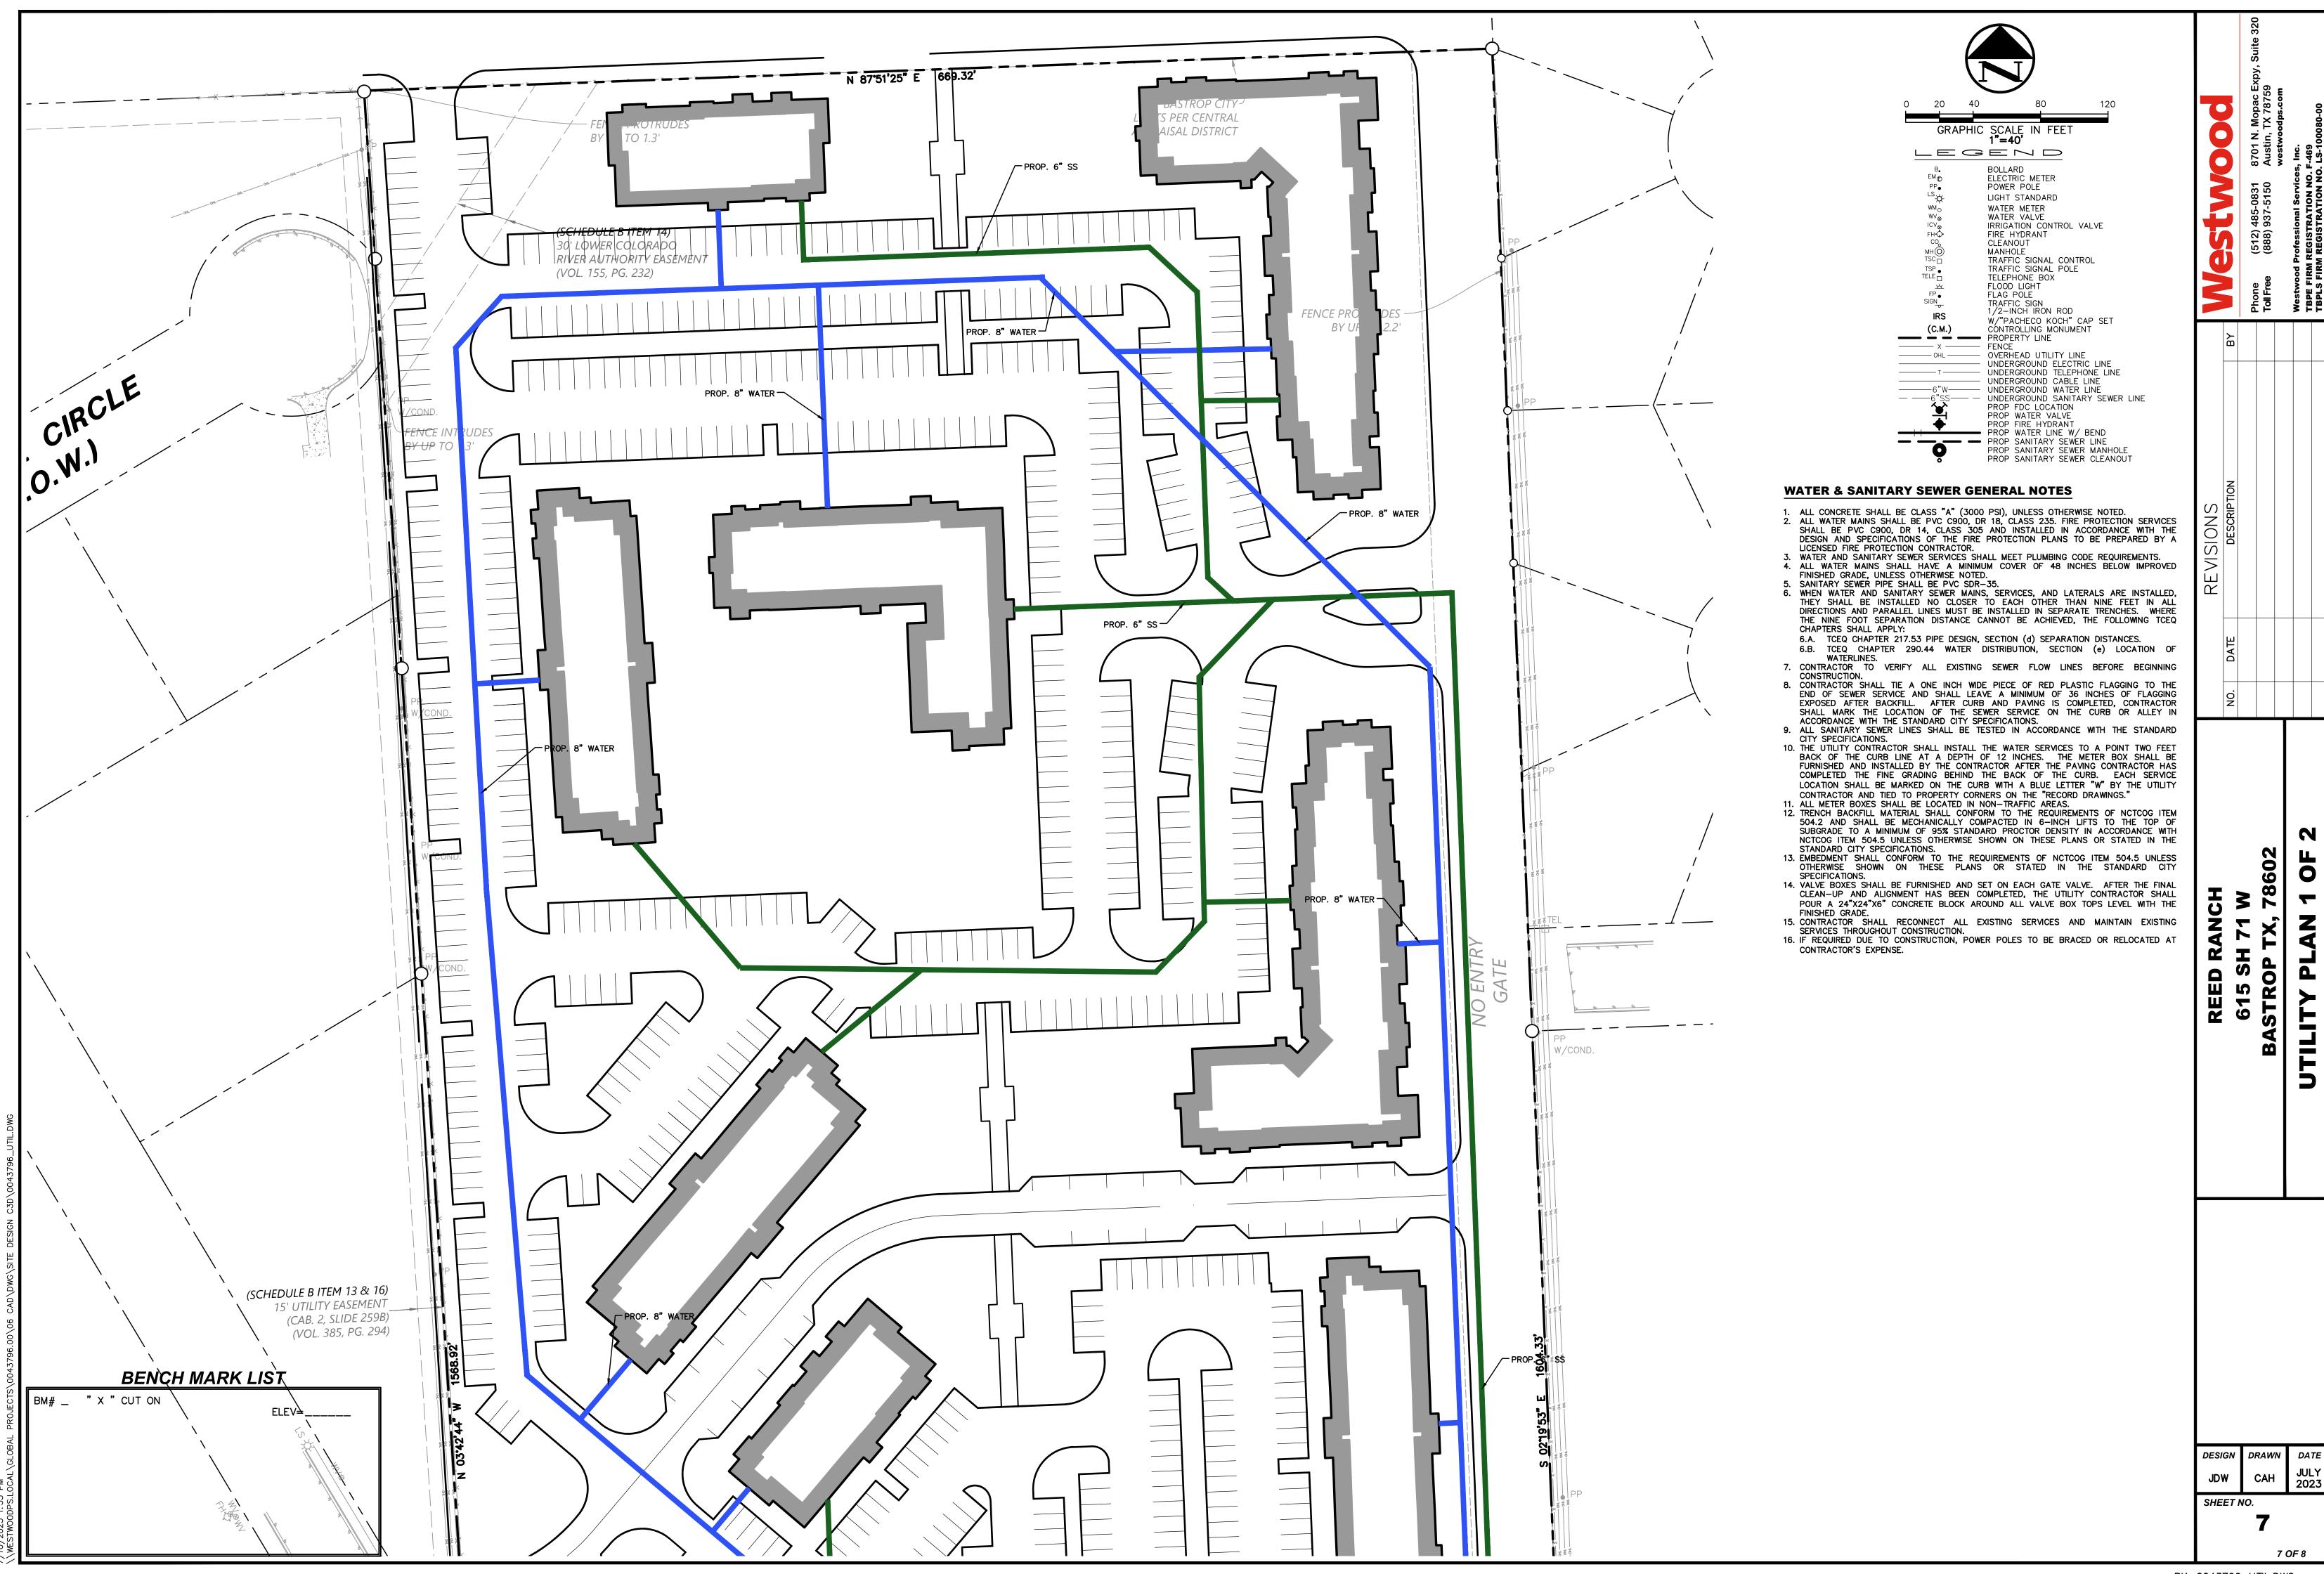
REED RANCH

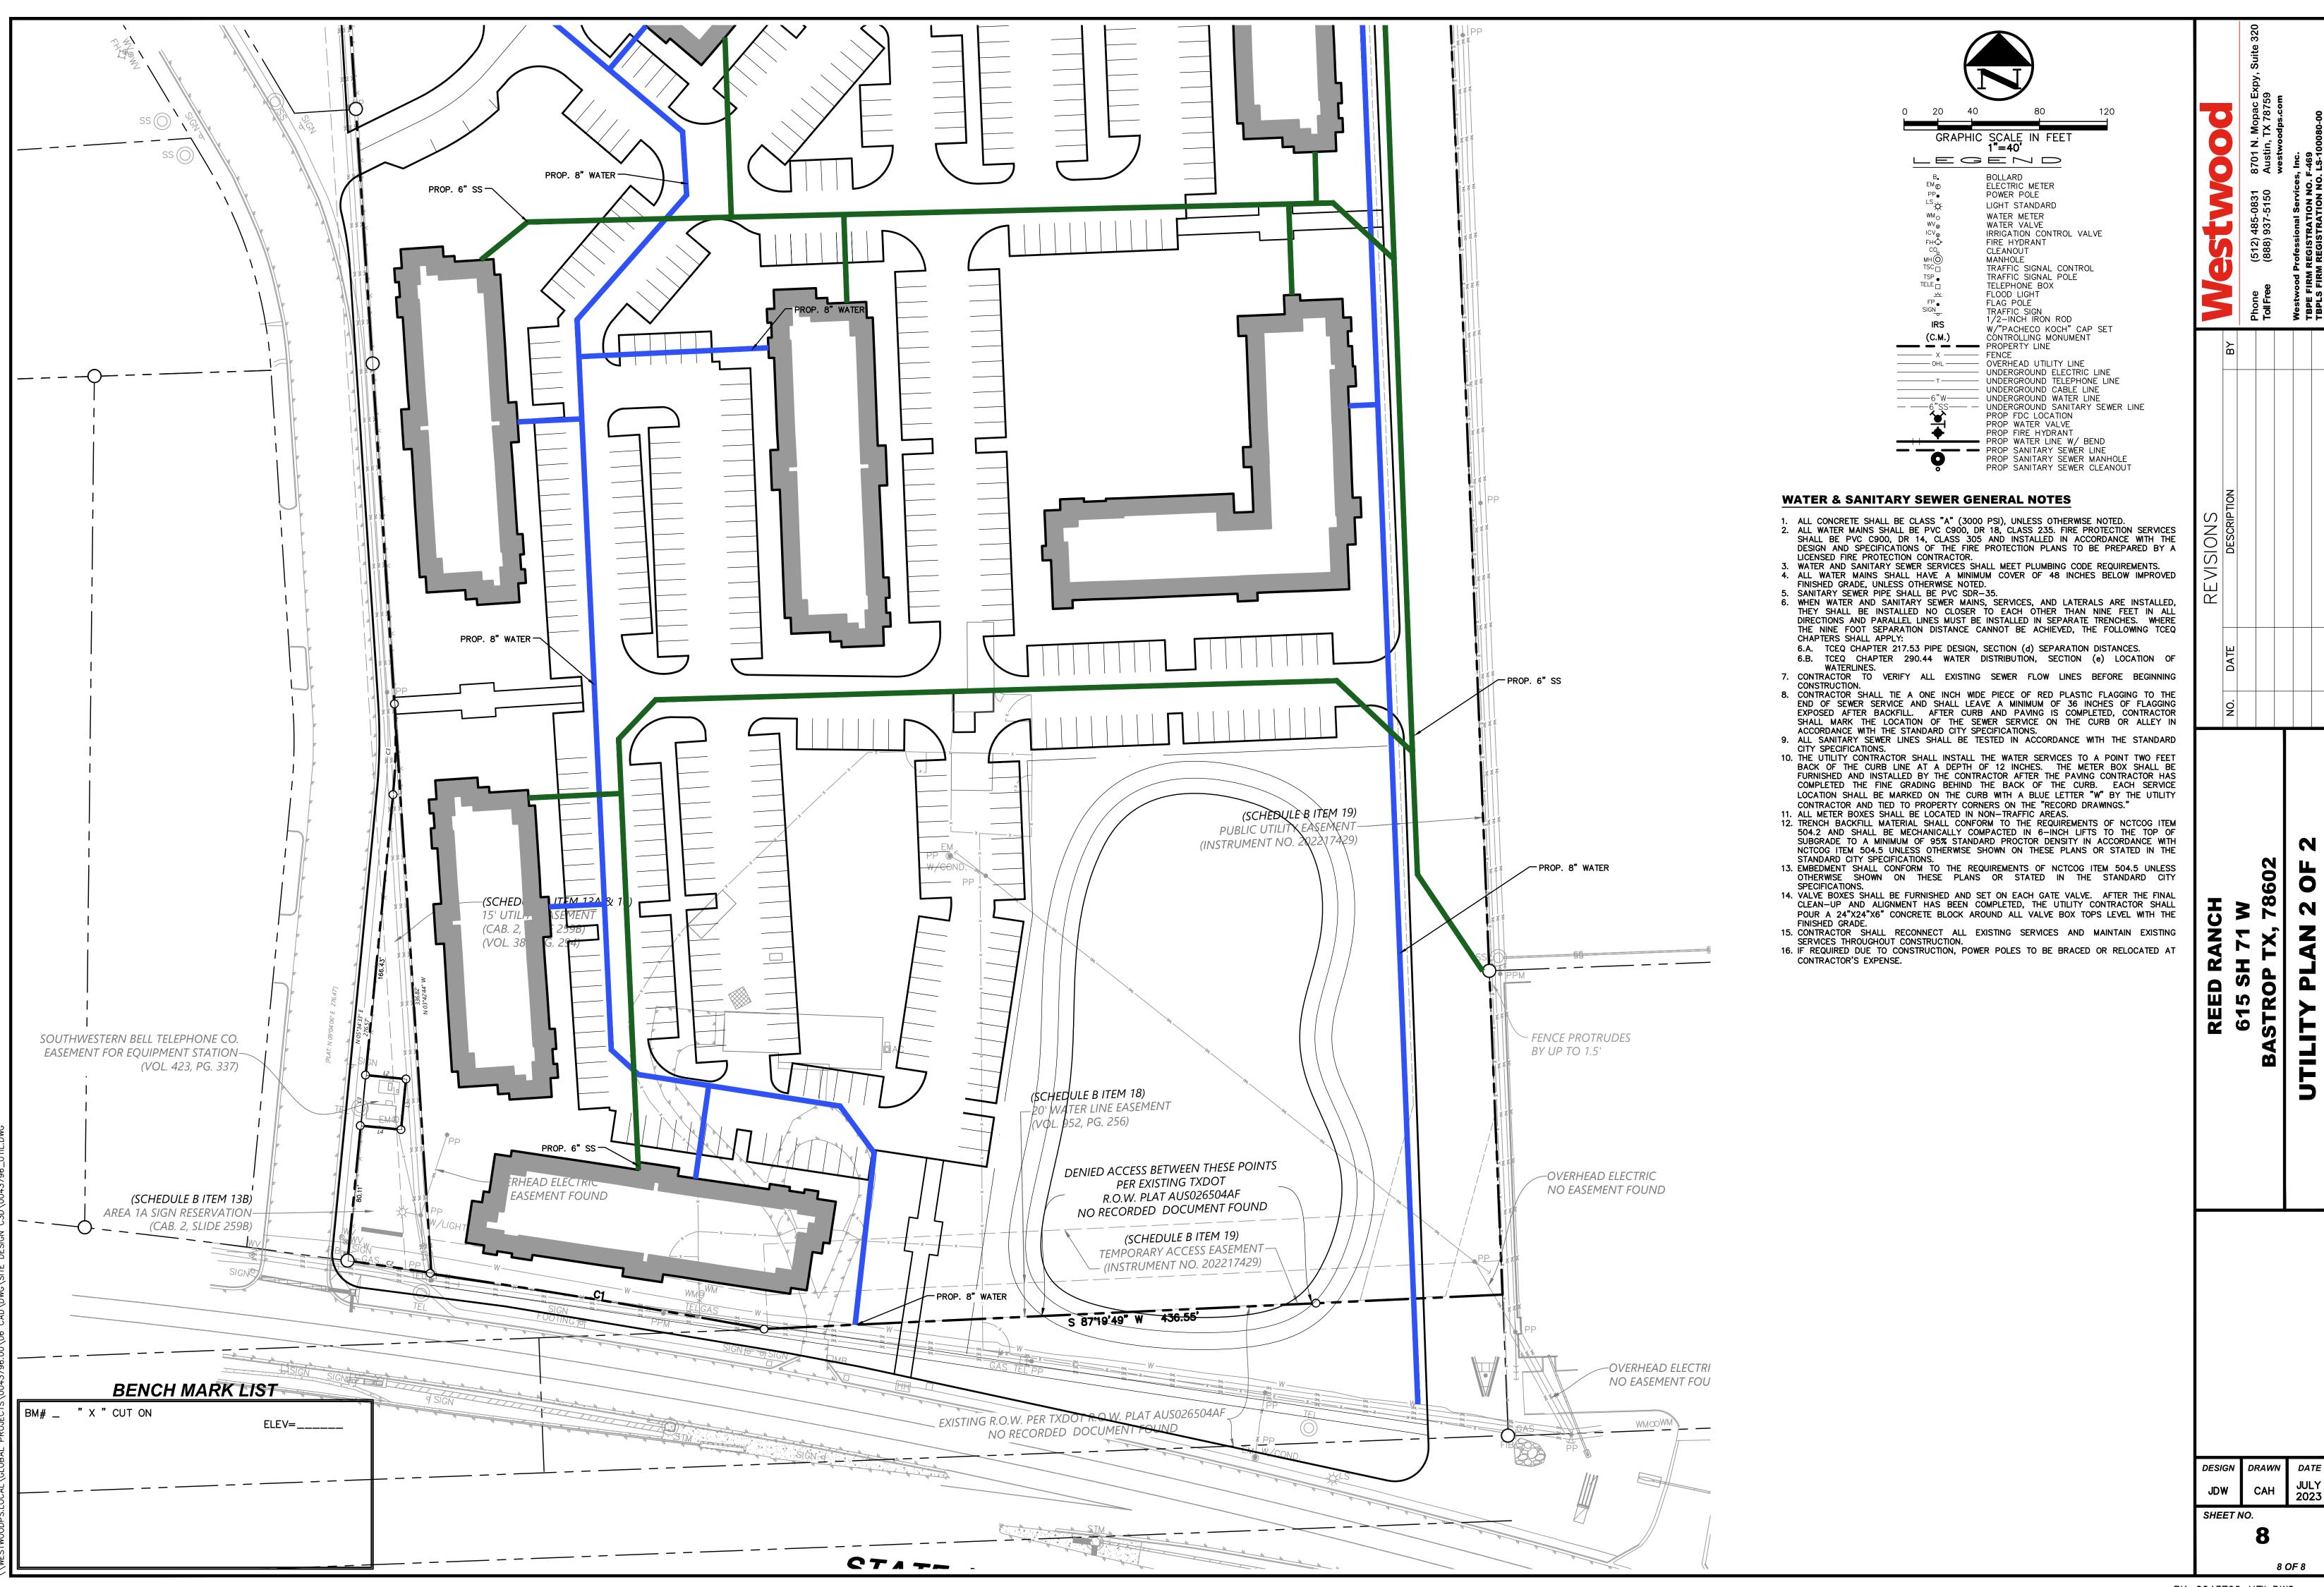
DRAINAGE

PROPOSED

DATE DESIGN DRAWN JULY 2023 JDW CAH

SHEET NO. 6 OF 8





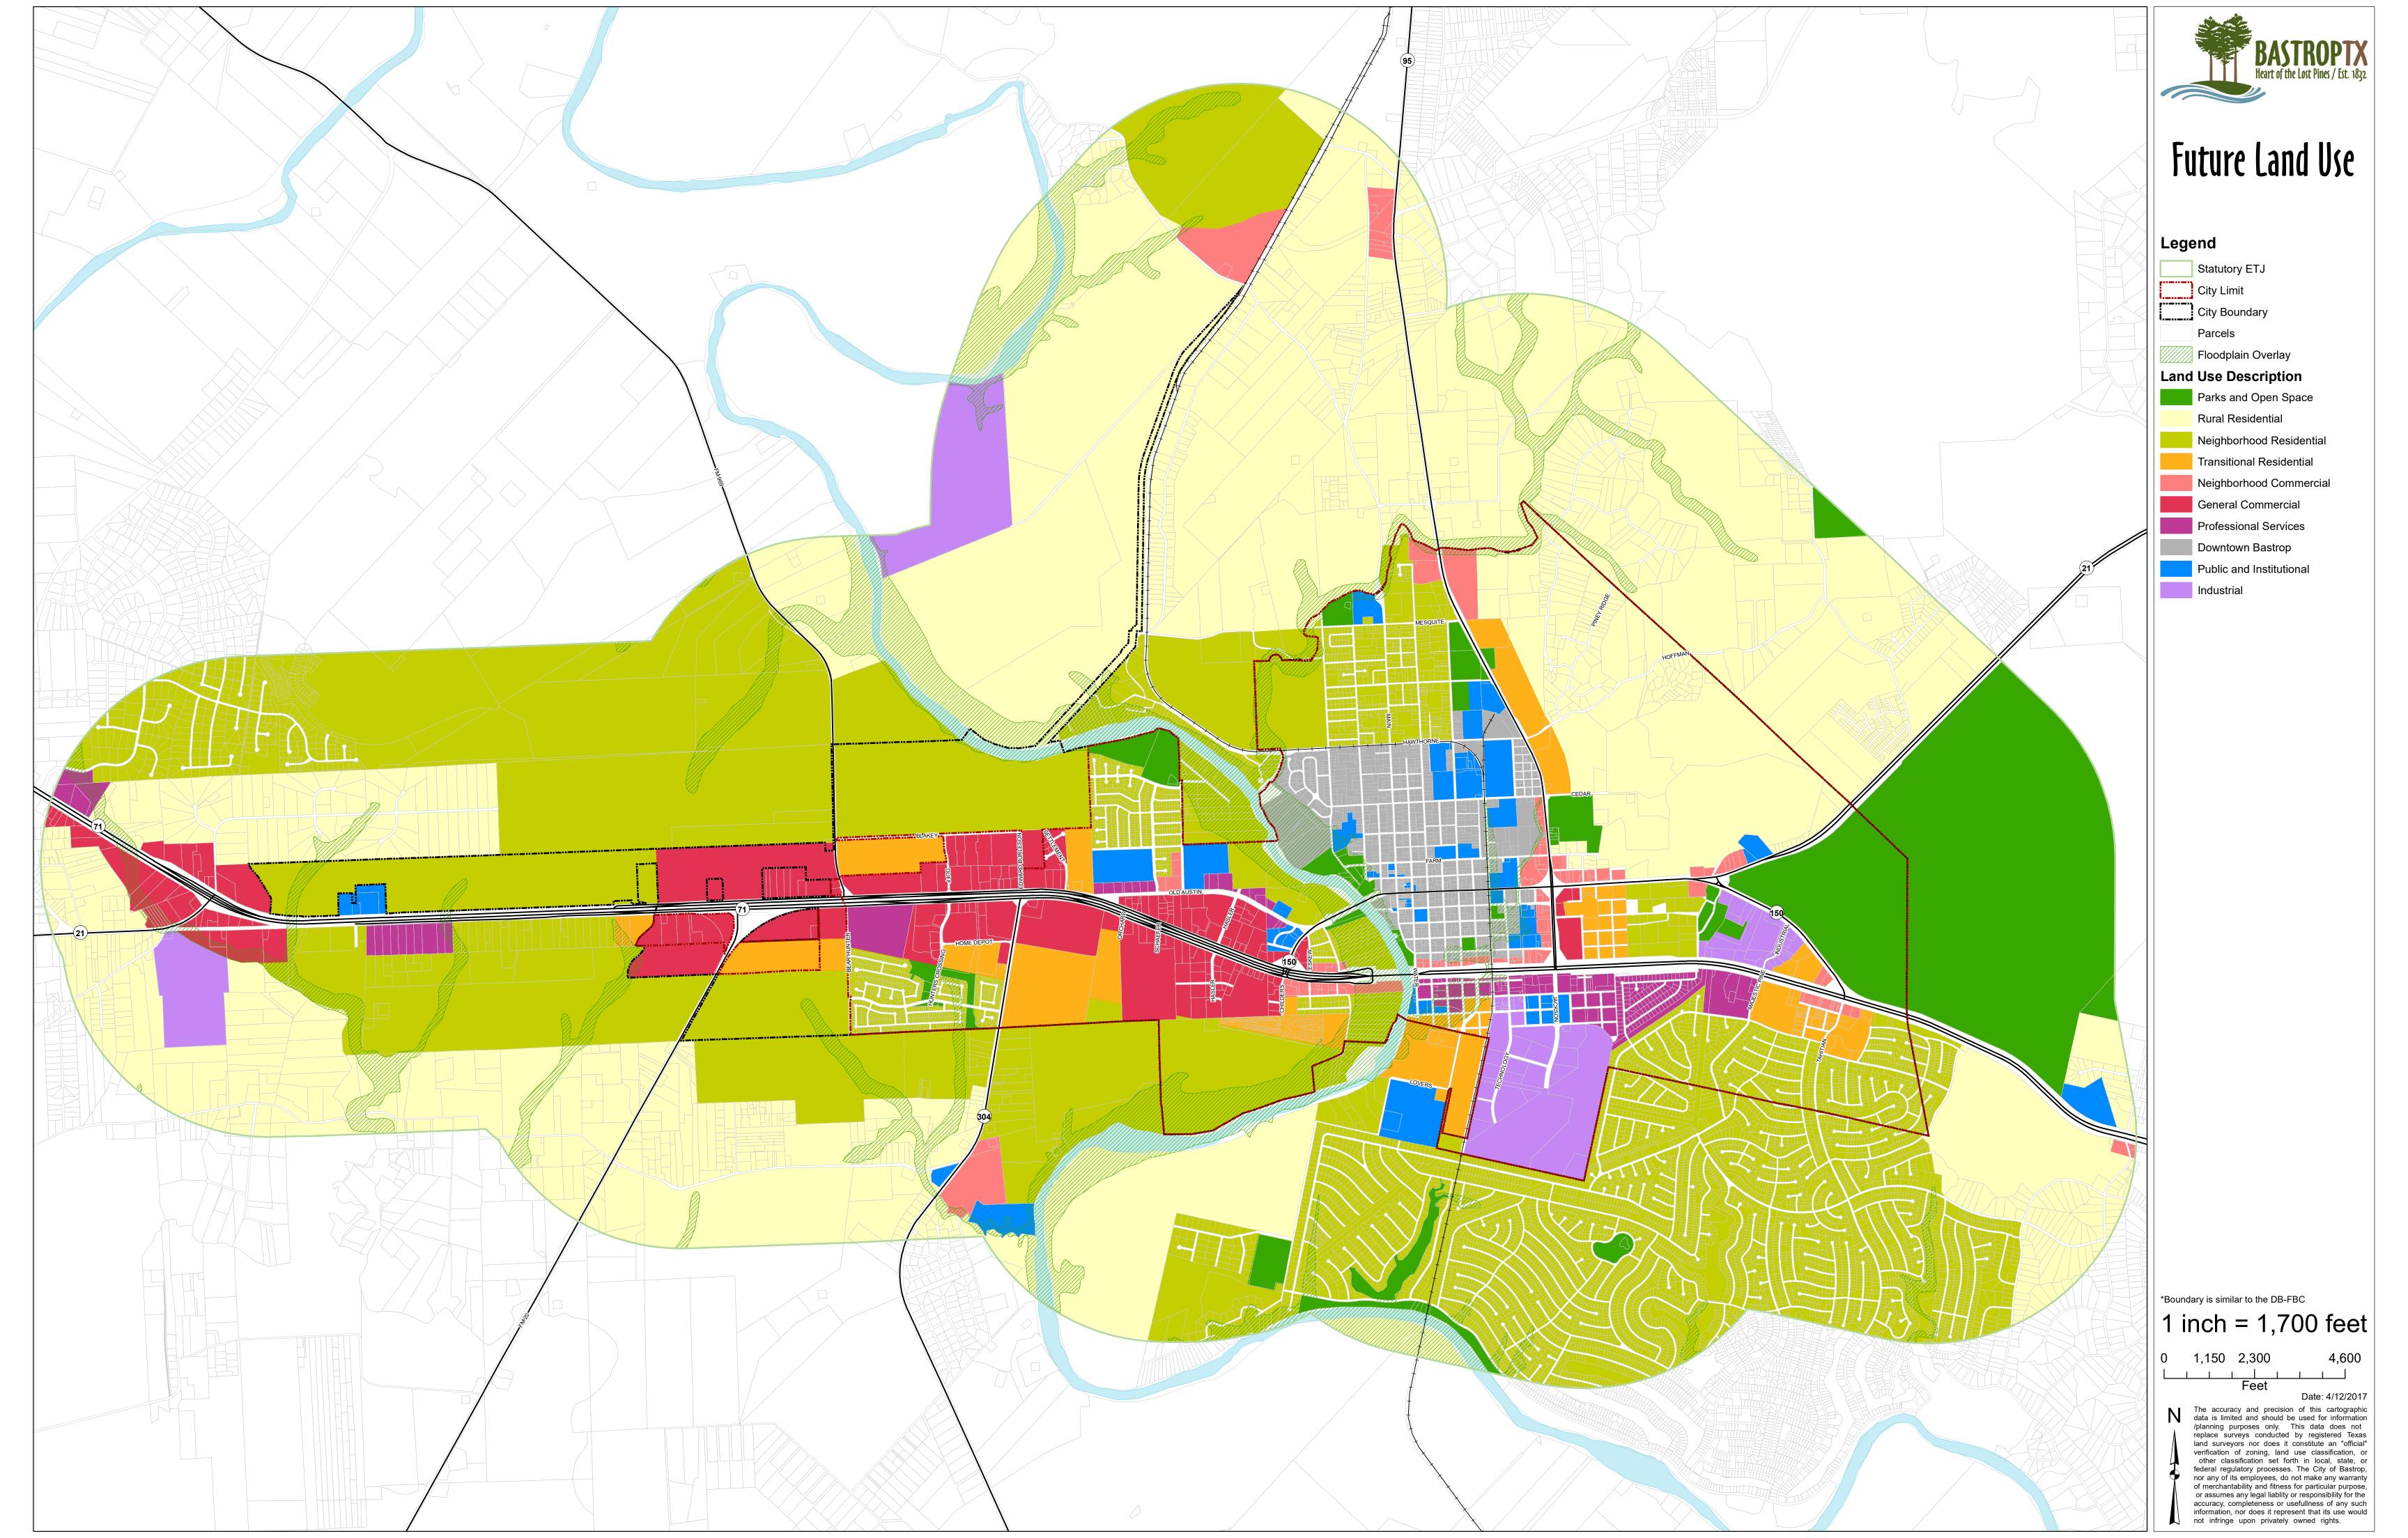
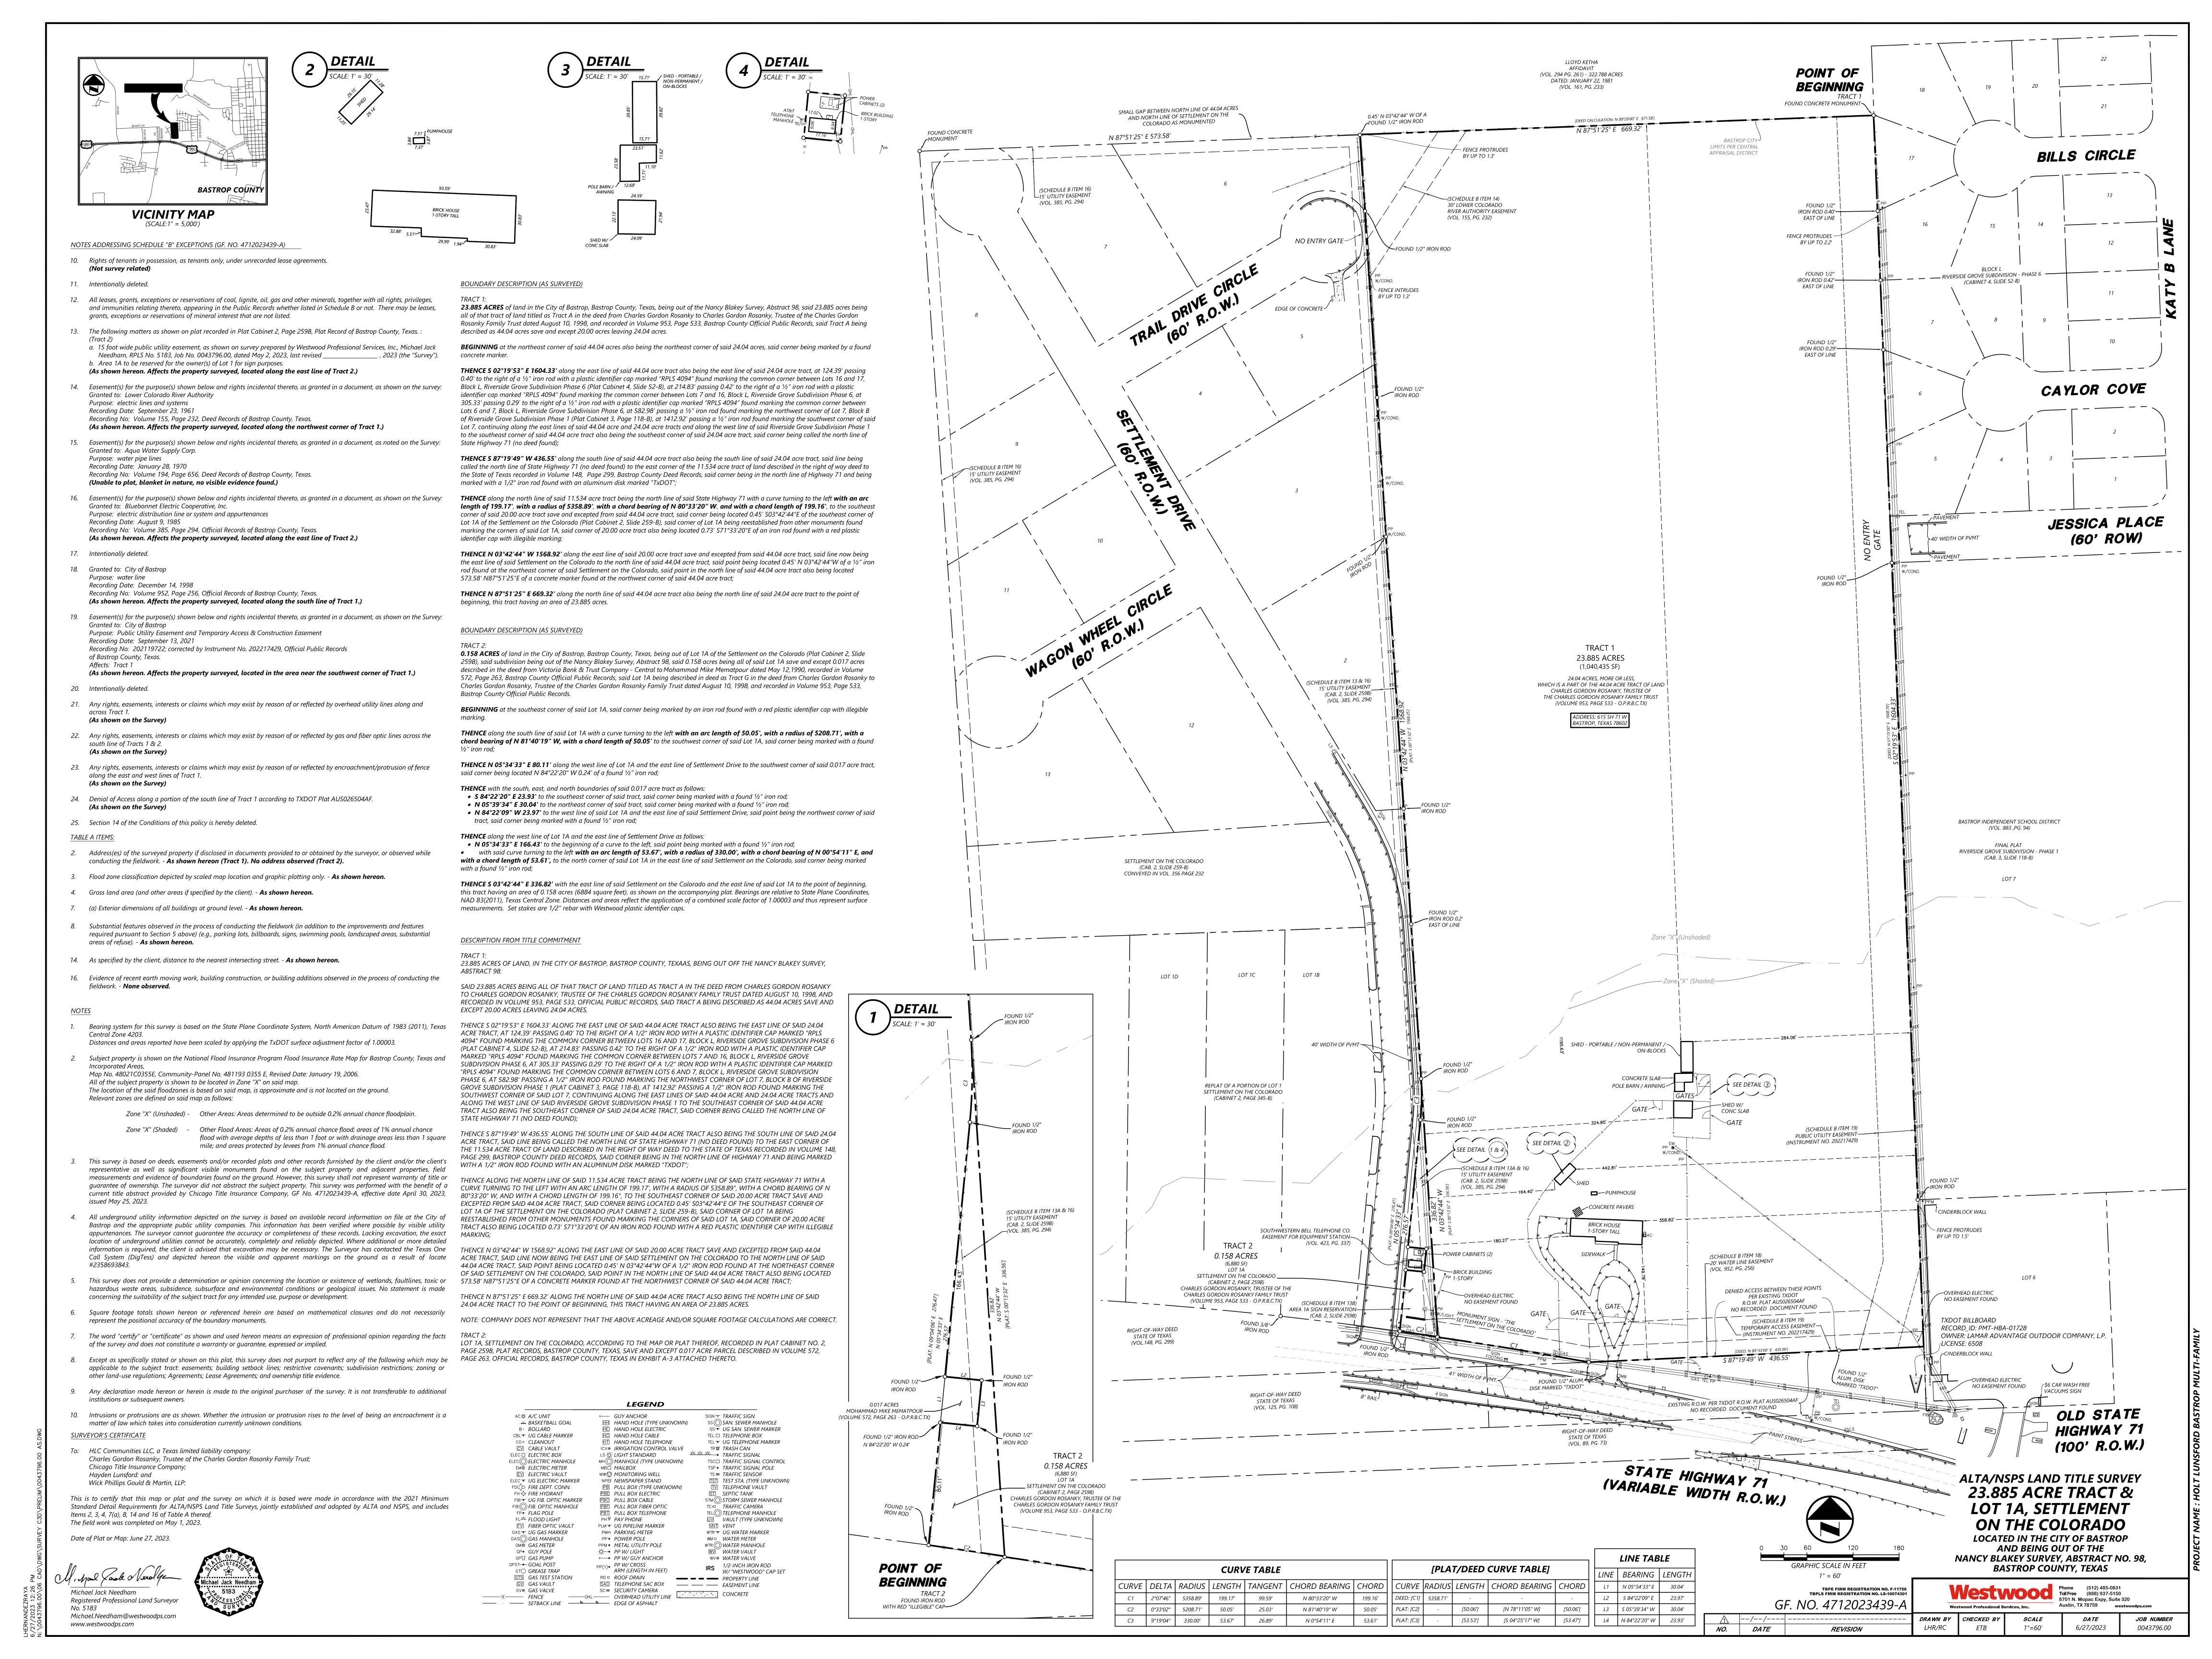


Exhibit C – Warrant List

B3 Code	Description	Development Issue	Proposed Alternative &
Section			Reasoning
7.1.002(k)	To prevent future conflicts regarding Street	Dedication requirement does not	Allowing for streets to be
	maintenance, private Streets are prohibited, except	permit developer to manage and	privately owned, managed, and
	where justified by special considerations.	maintain streets.	maintained is fiscally sustainable.
7.2.003	Street right-of-way must be dedicated		
7.3.004	Traffic Lanes: Two lanes at 10 feet each	Complying with health/safety	Permitting 12.5' lanes such that
		codes requires lanes to be wider.	the street can meet fire lane
	Parking Lanes: Both sides parallel at 8 feet, marked		requirements meets the intent of
		Only parallel parking does not	the code and is fiscally
		allow for a financially feasible	sustainable. Allowing for head-in
		amount of parking spaces.	parking to be 18' is fiscally
			sustainable.
7.5.002(d)	Storm Drainage Facilities, if equipped to provide Civic	Drainage requires a large portion	An amenitized wet pond with a
	Space, may be counted toward the 10% Civic Place	of the project to be a pond. Not	trail meets the intent of code, is
	Type allocations requirement by warrant.	allocating this space toward the	fiscally sustainable, and
		Civic Space requirement makes	authentically Bastrop.
		project fiscally infeasible.	
7.1.002(h)	Dead-end Streets must be avoided.	Proposed design does not show	For avoidance of doubt, internal
		dead-end streets. Rather, internal	drives culminating into 20'
		drives culminate into left and	walkway easement places as
		right parking aisles for buildings	generally shown in the
		or walkway plazas in line with	Conceptual PD Master Plan
		5.2.002(d).	meets the intent of code.
5.2.002	Preferred block size is 330' by 330'and max block	Drainage block is large due to odd	Allowing for a single larger block
	perimeter of 1,320'	shape of site and need for a large	complies with intent of code.
		pond.	
			Permitting private drives as
		Treating private	shown on the Conceptual PD
		streets/driveways as block	Master Plan is fiscally sustainable
		boundaries for this measurement	and meets the intent of code.
		results in an urban fabric of slow	

		streets, with the plazas acting as traffic calming devices.	
5.2.002(f)	In the P4 Mix, a minimum Residential mix of three	Proposed design elects only	As the project is unlikely to move
	Building Types (not less than 20%) shall be required.	apartment buildings with	forward if a variety of building
		amenity and civic spaces. A	types are required, allowing for a
		variety of building types is not	warrant is fiscally sustainable.
		fiscally sustainable.	
6.5.003	-70 percent max lot coverage;	Conceptual PD Master Plan	Permitting lot occupation as
	-60% minimum buildout at build-to-line;	generally meets build-to-line	shown in Conceptual PD Master
	-Build-to-line is 5-15 ft	requirements of P4 but may not	Plan is fiscally sustainable.
		meet all façade buildout or lot	
		coverage requirements.	
		Specifically, the 60% buildout line	
		is doable along the publicly	
		dedicated streets but not interior	
		privately owned and maintained	
		streets.	
7.5.002	Plazas not permitted in P4 and require a minimum	Walkway/paseos as shown on	Allowing warrant meets the
	size of ½ acres.	Conceptual PD Master Plan allow	intent of code in that it improves
		for improved site	walkability.
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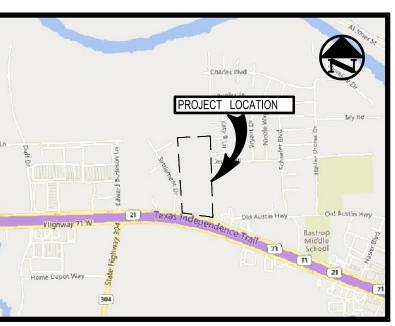
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ZONING CONCEPT PLANS FOR

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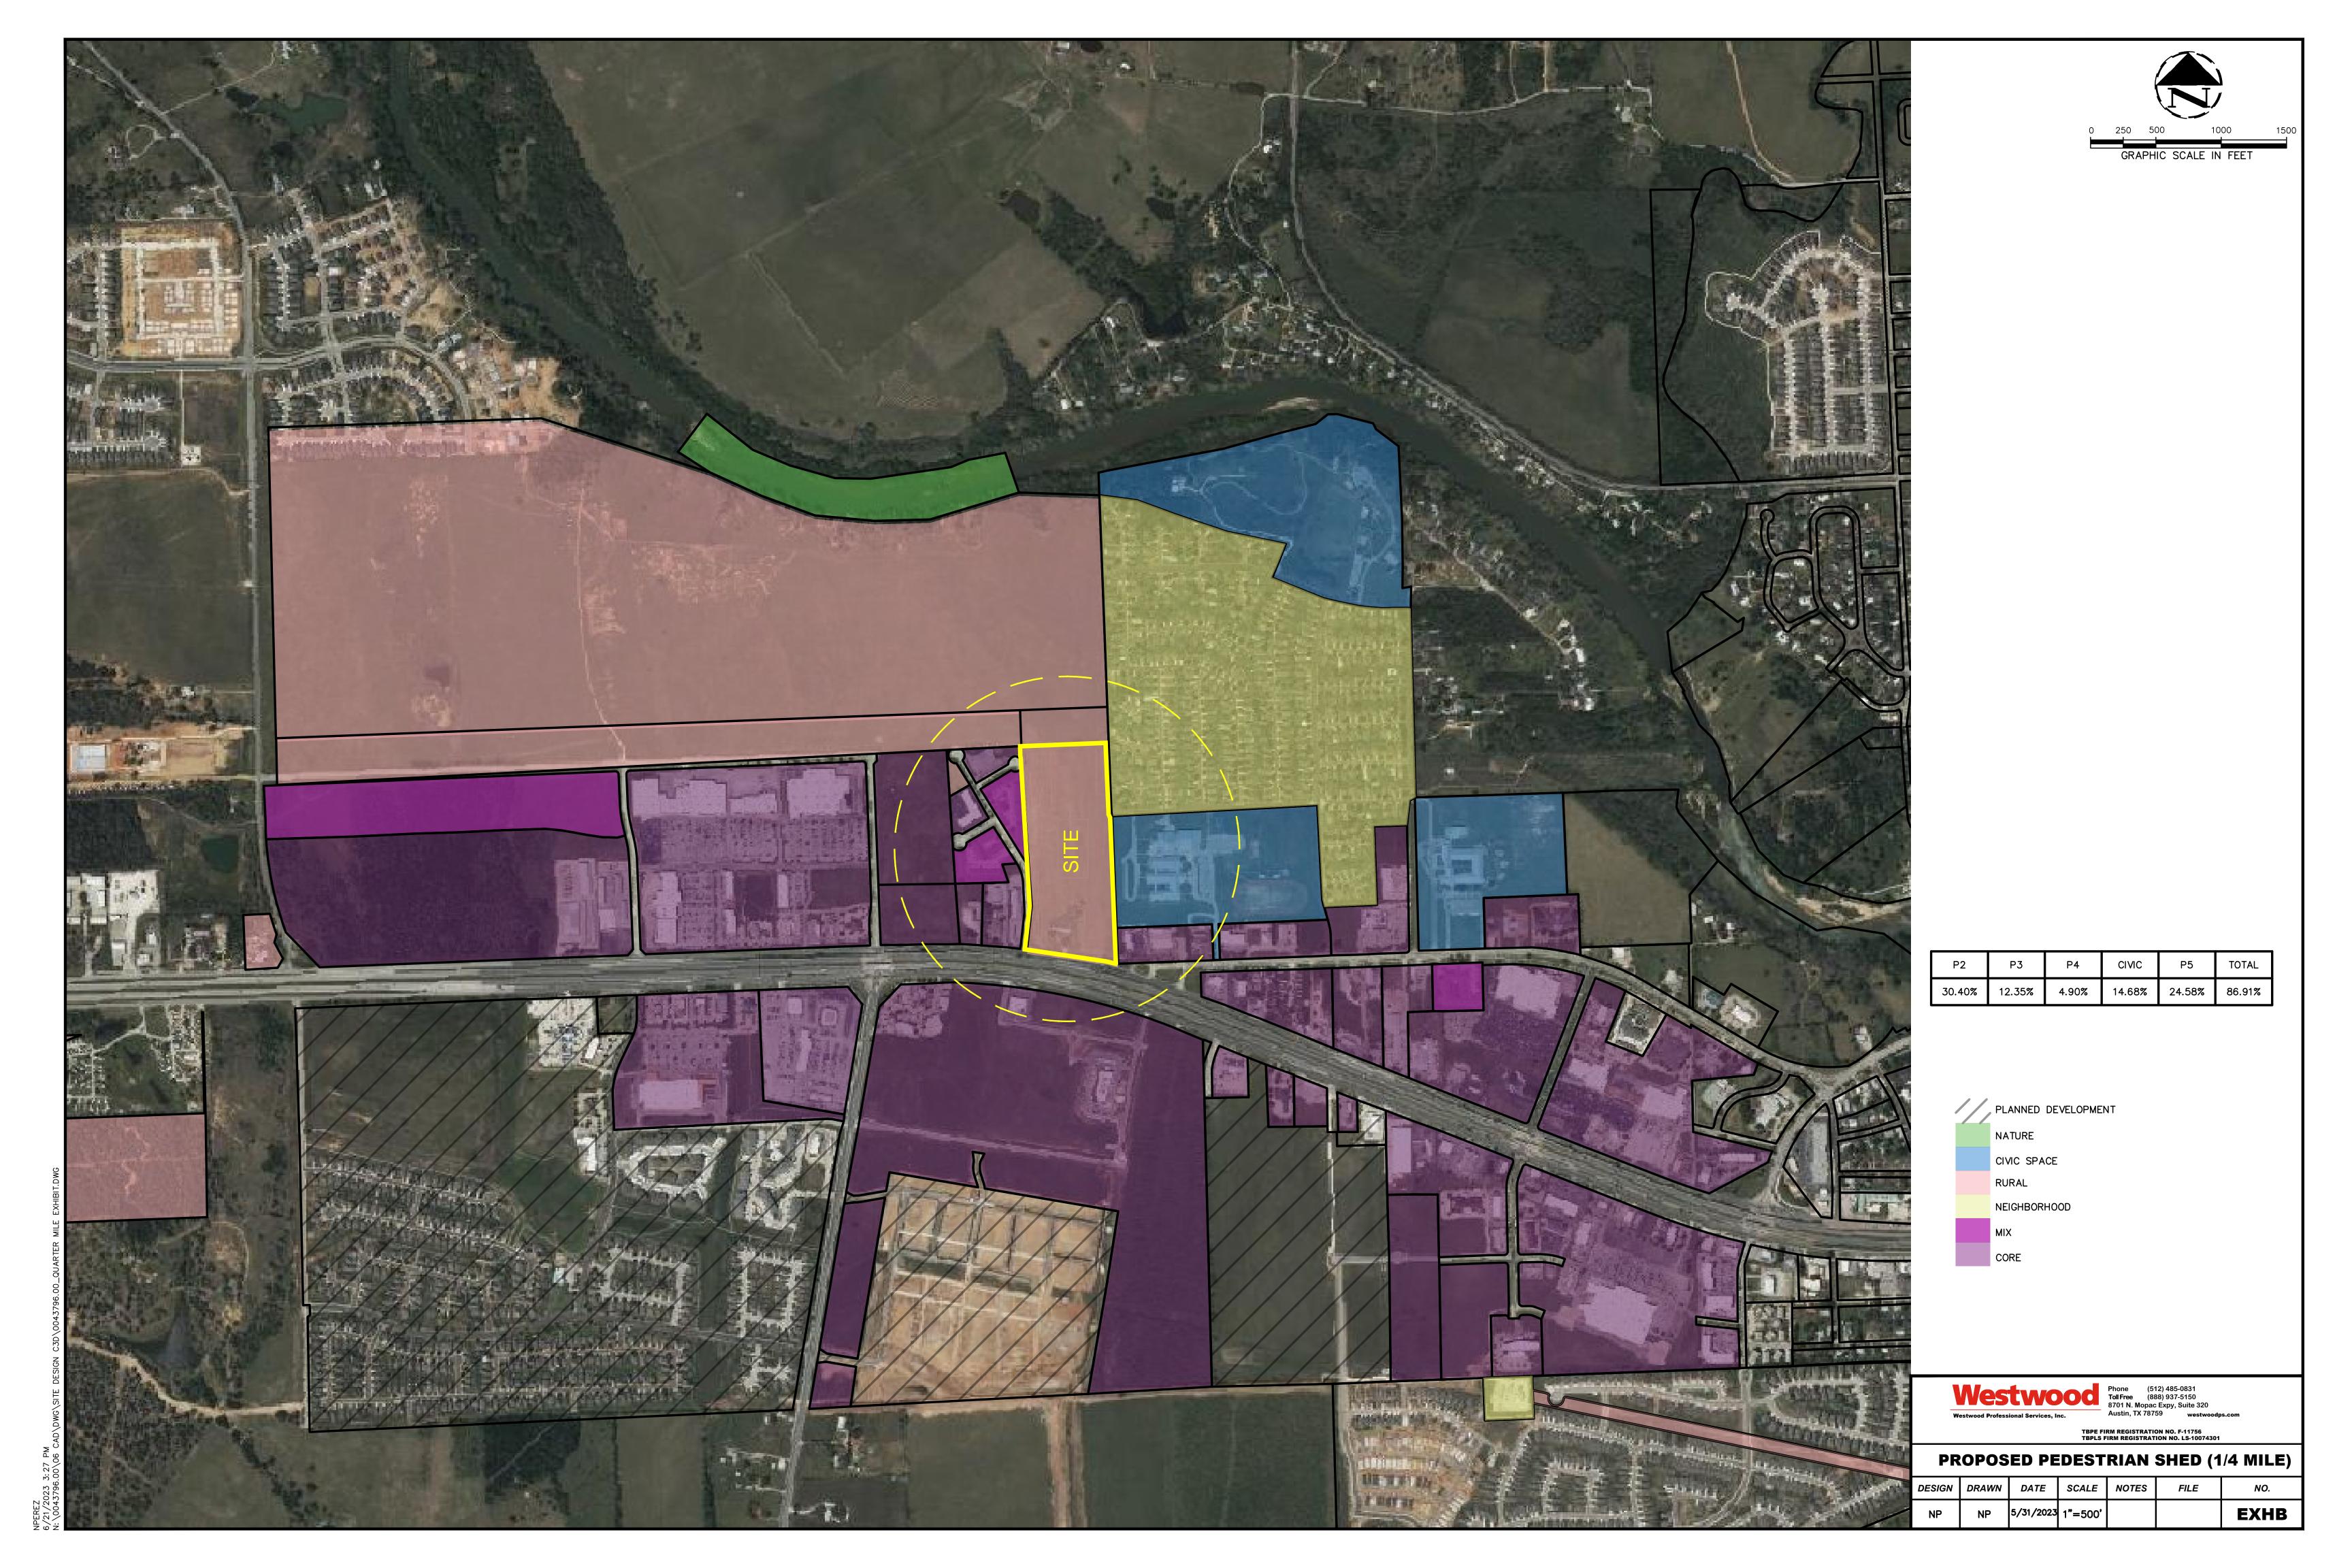
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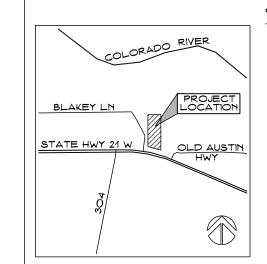
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ARCHITECT: GARY G. WOOD

#12202 PRELIMINARY - NOT TO BE USED FOR REGULATORY APPROVAL, PERMITTING, OR CONSTRUCTION DATE: 10 JUL 23



PROJECT NAME: REED RANCH ACERAGE: 24.3 A.

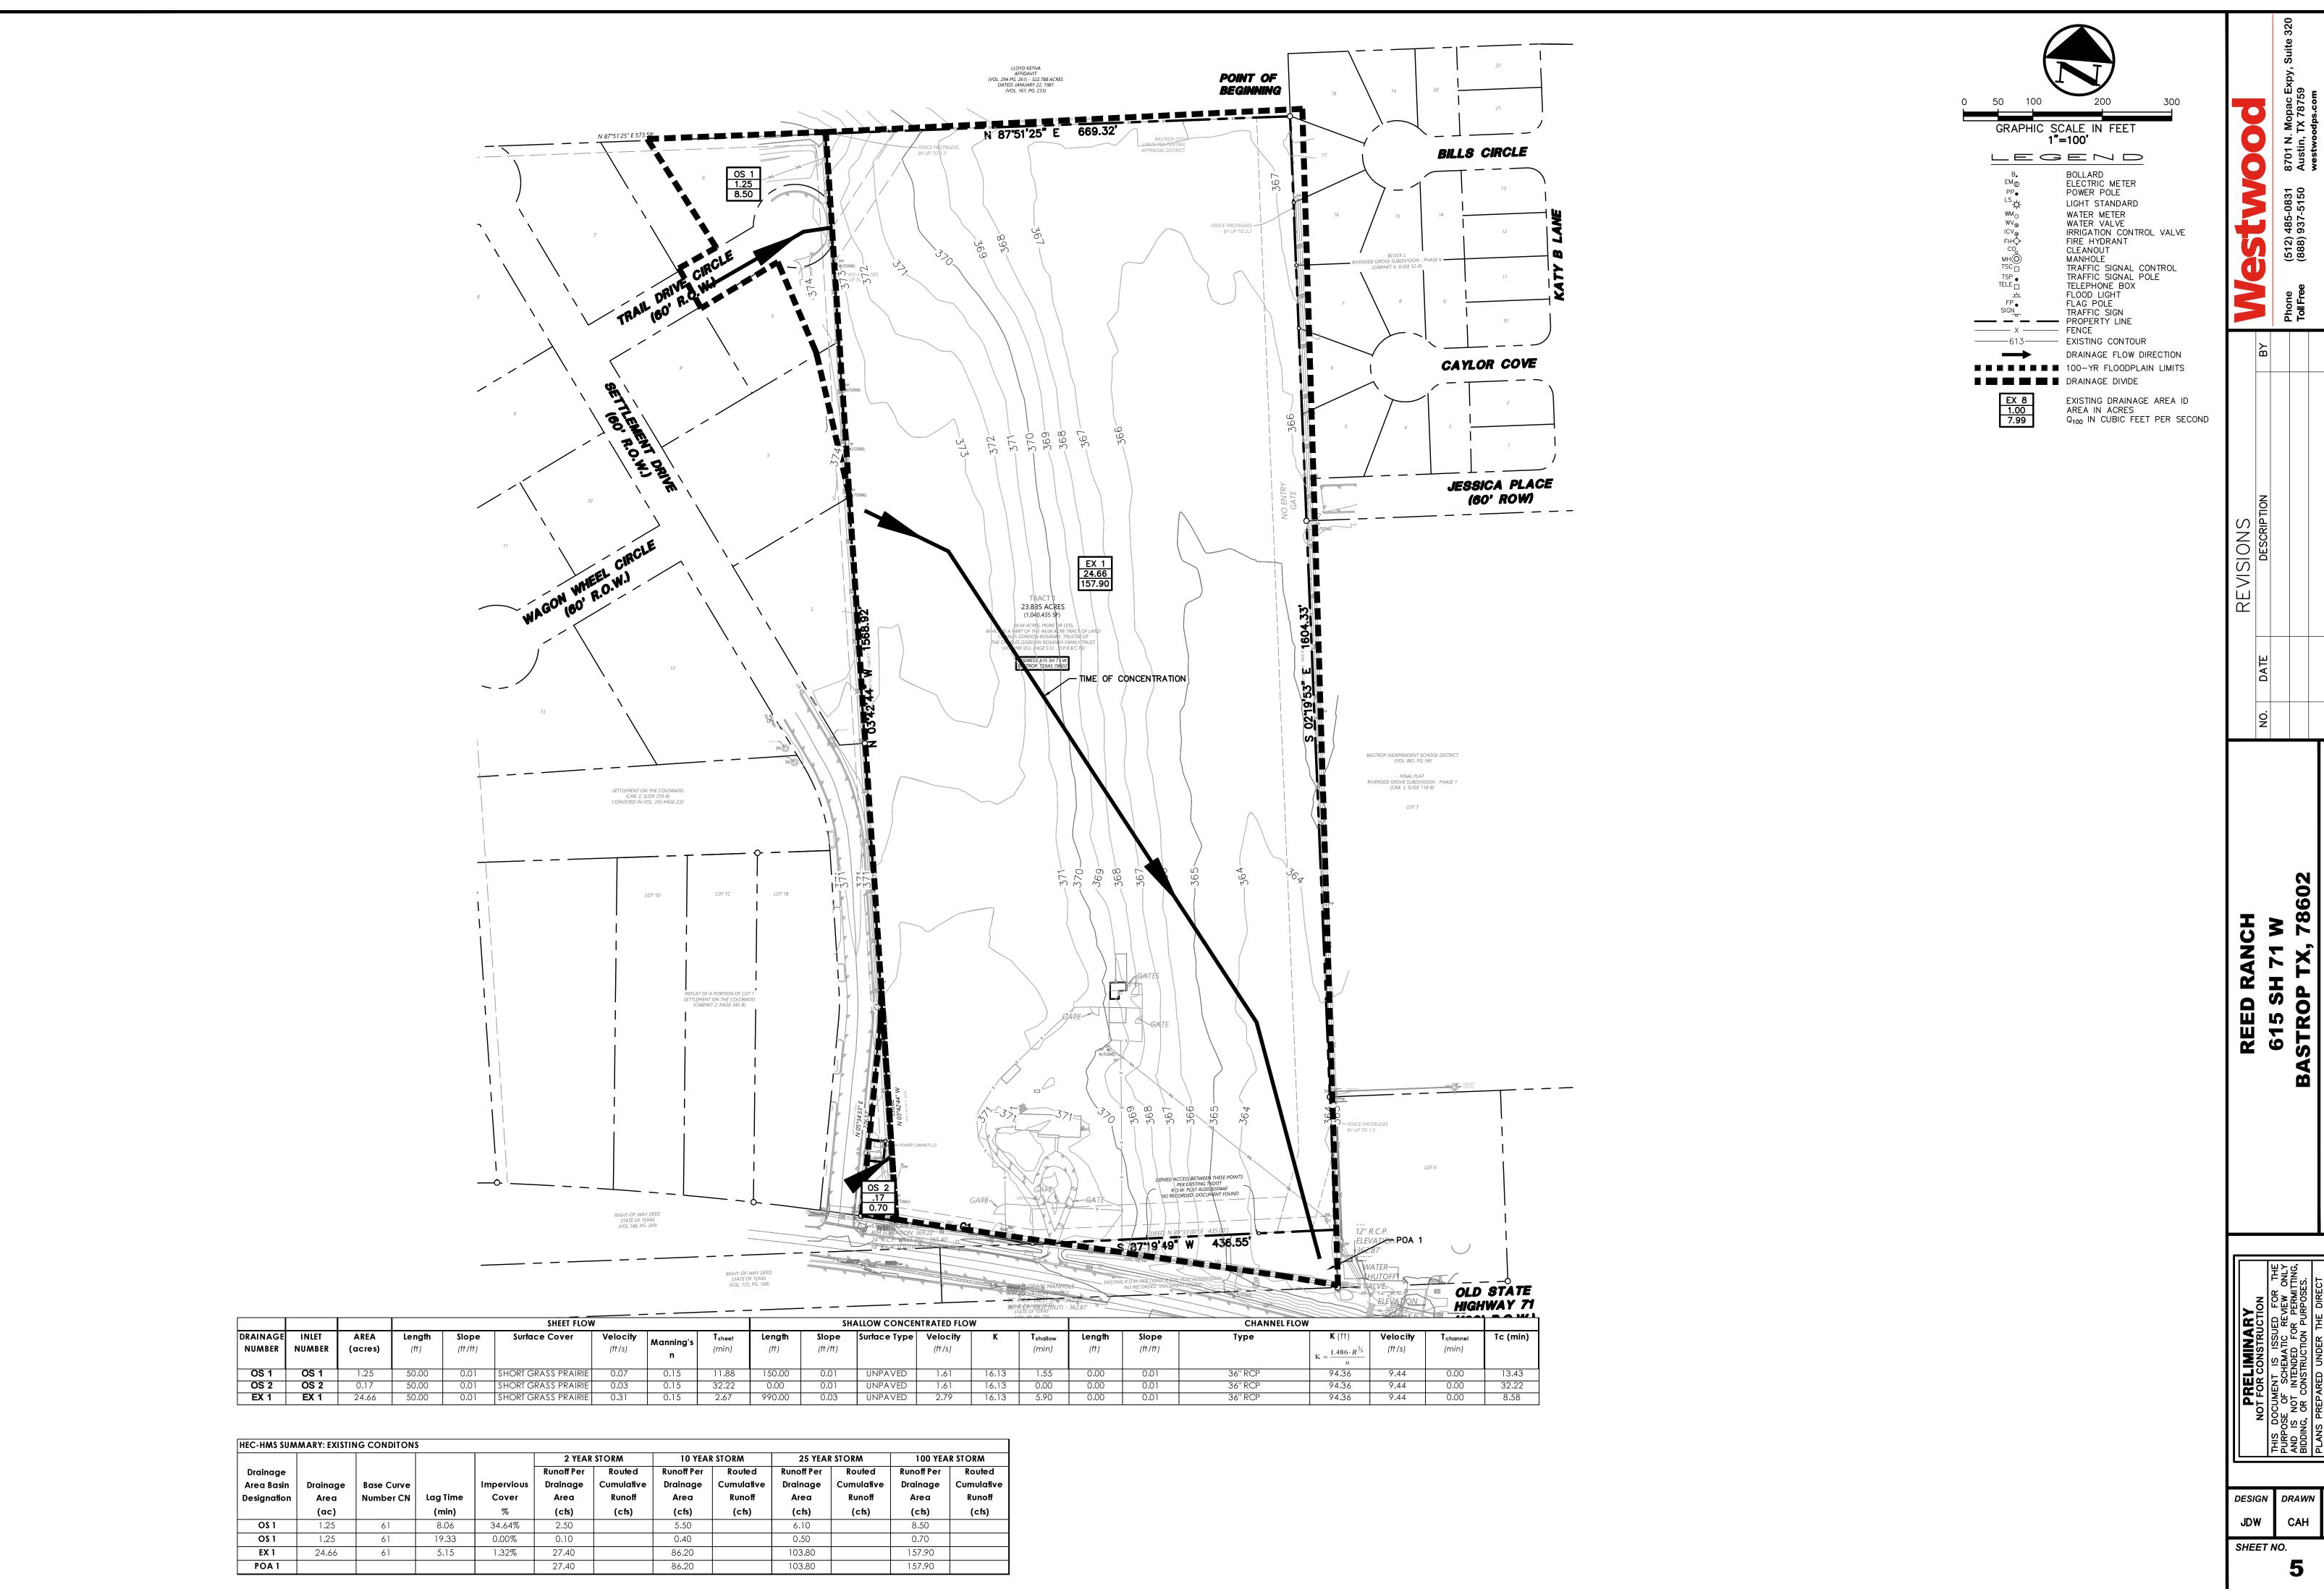
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CORPORATION ARCHITECTS / PLANNERS 210 NORTH PARK BLVD. SUITE 100 - GRAPEVINE, TX 76051 214/526-0731

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SCALE : 1" = 60'-0"





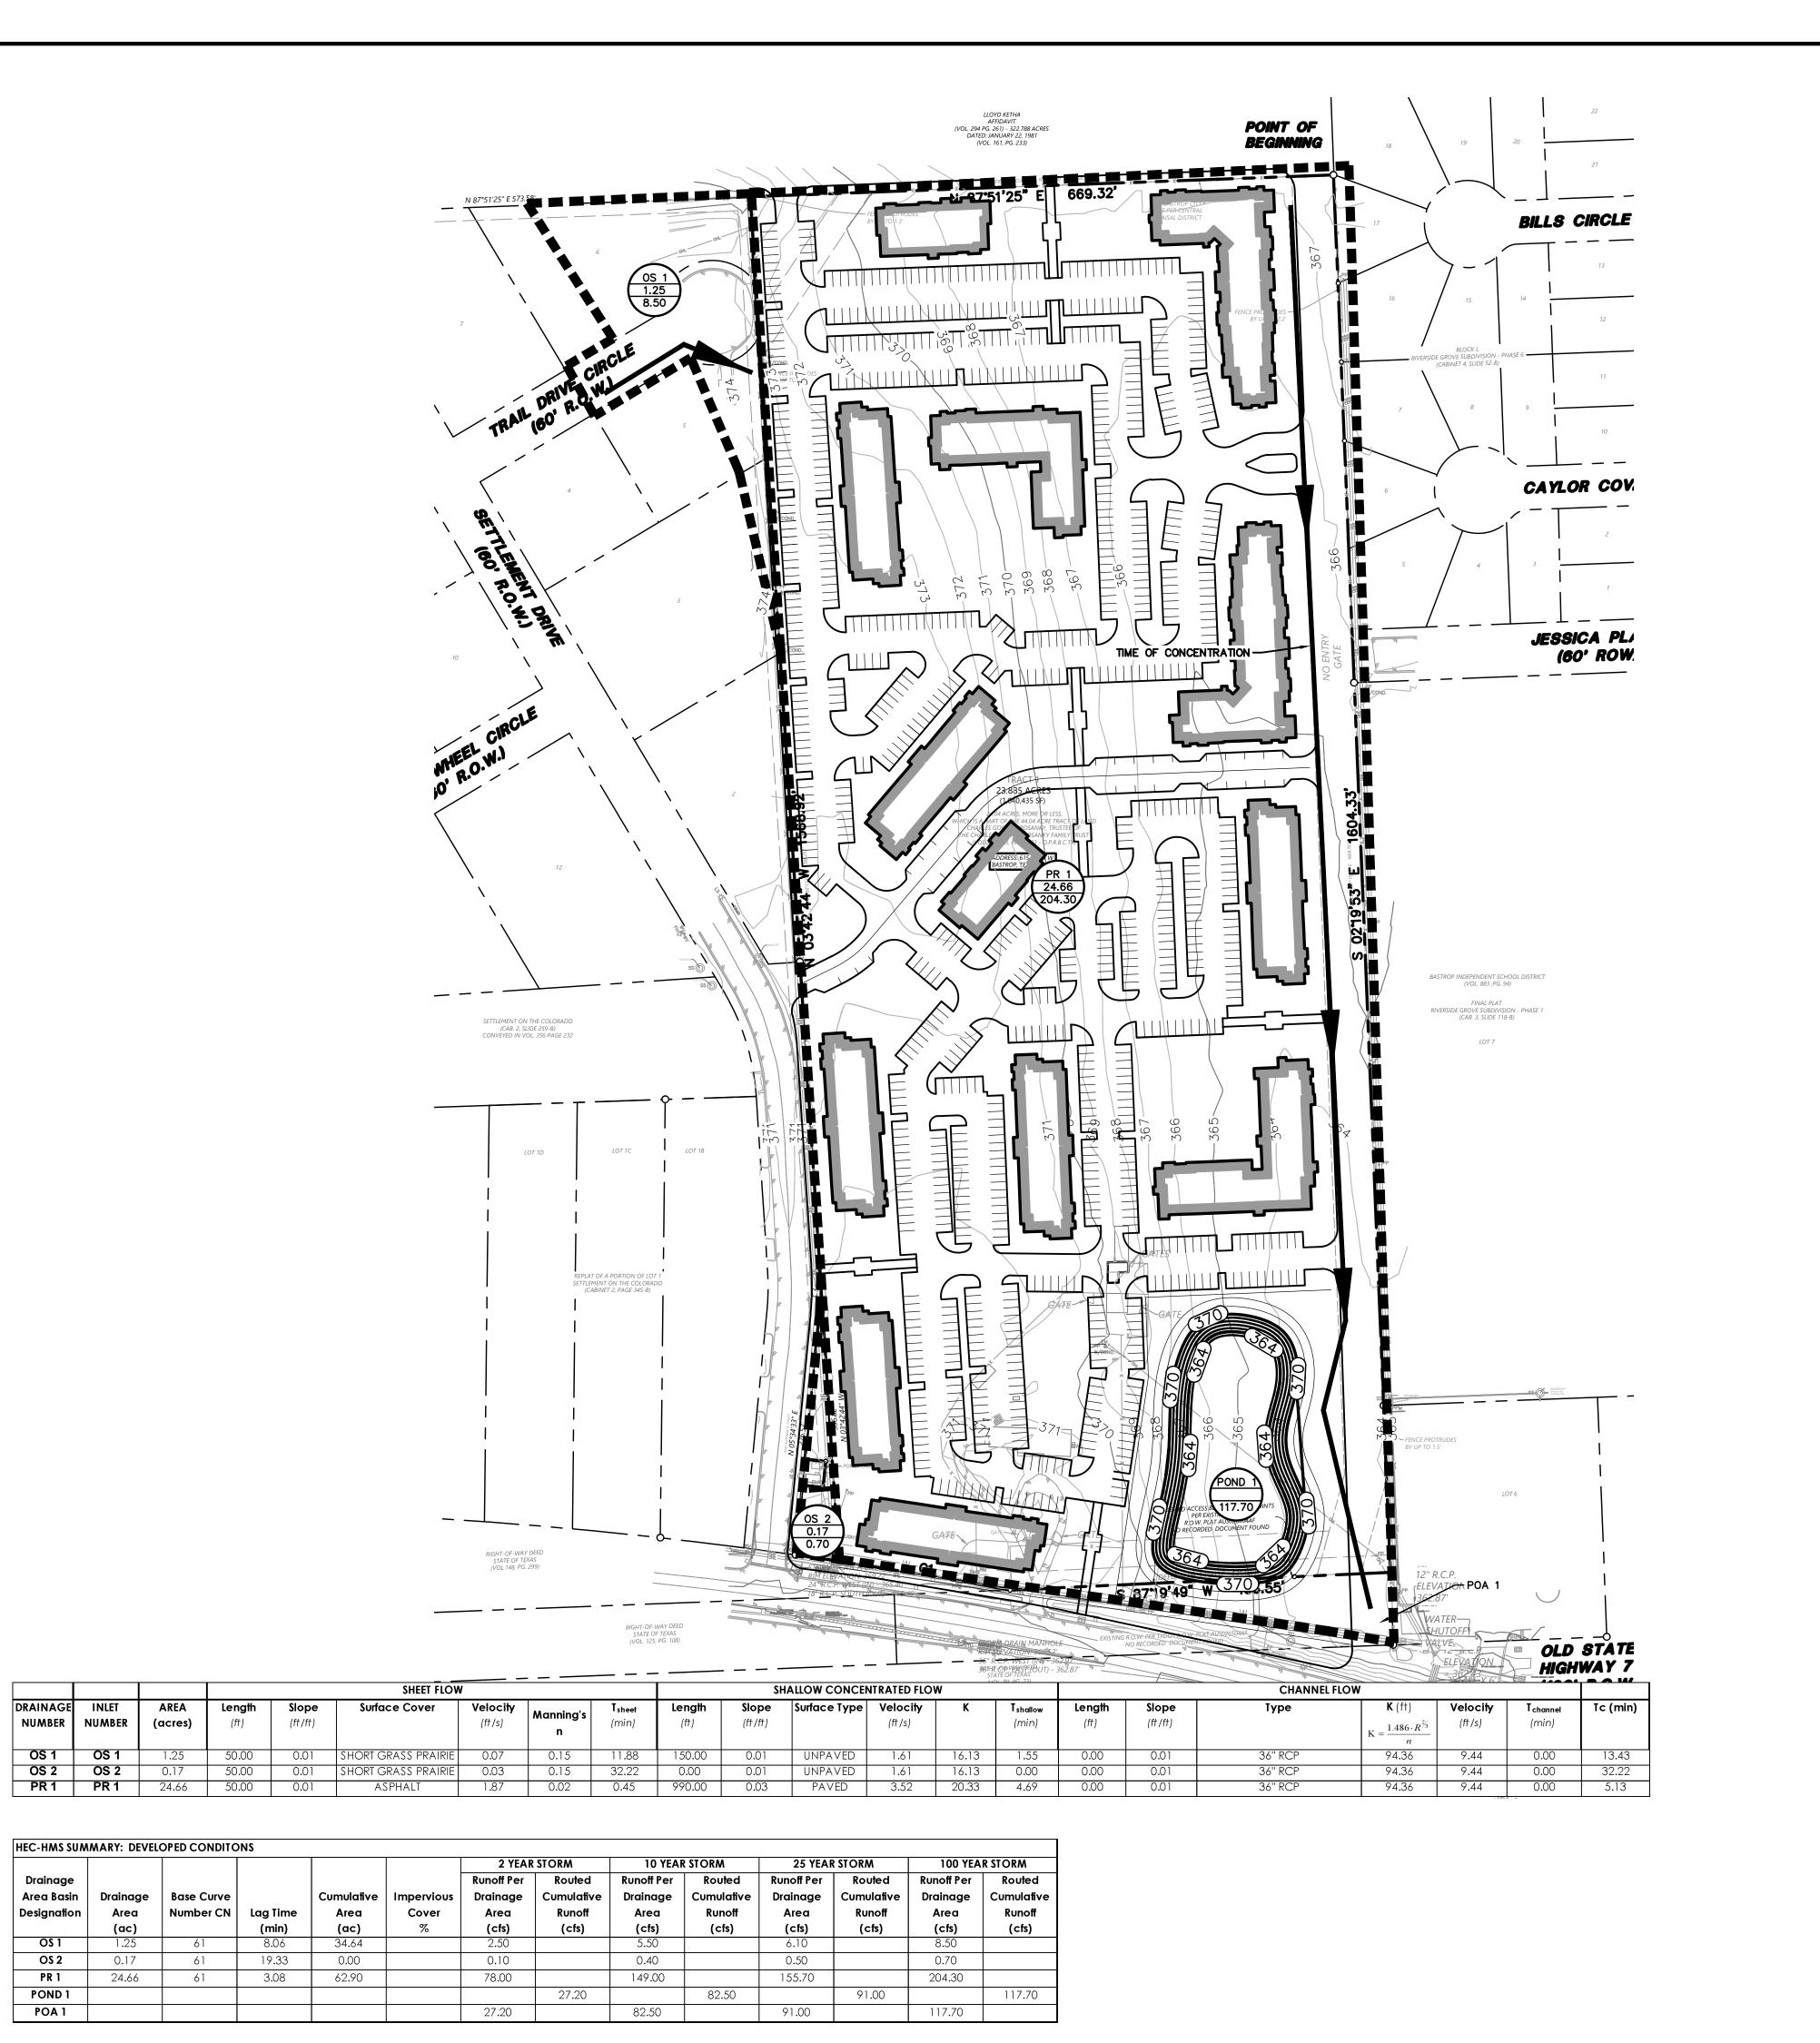
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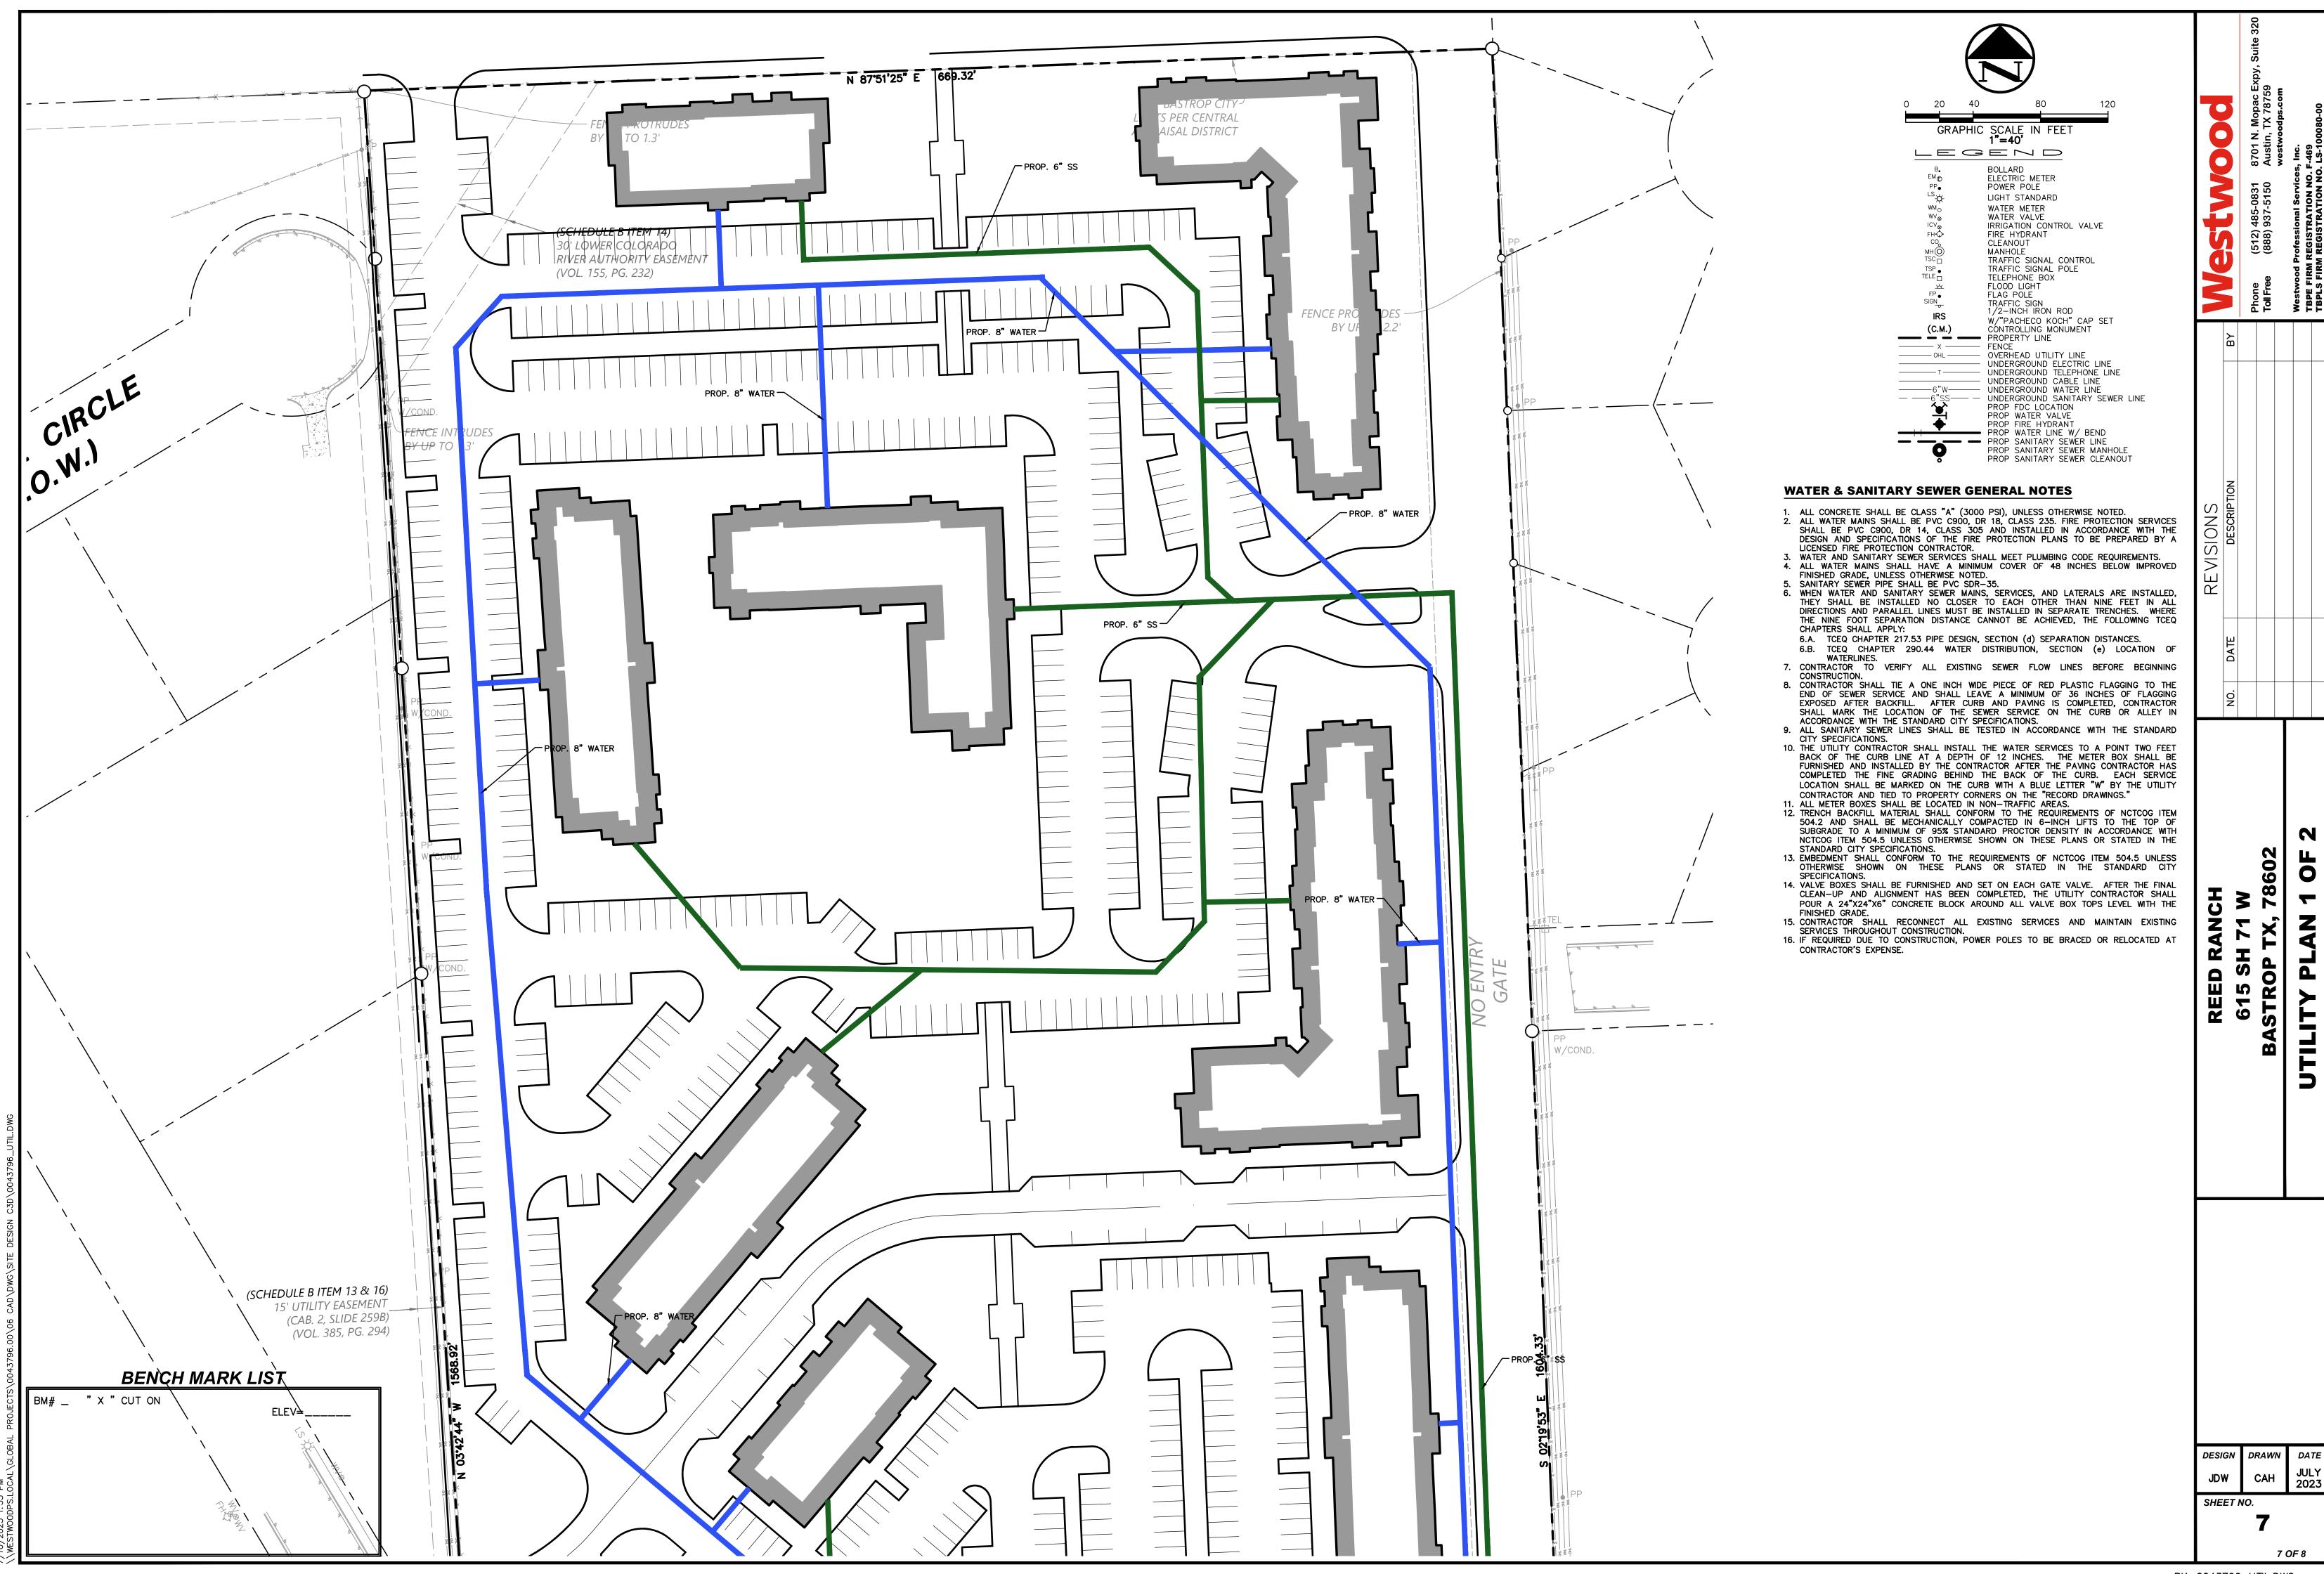
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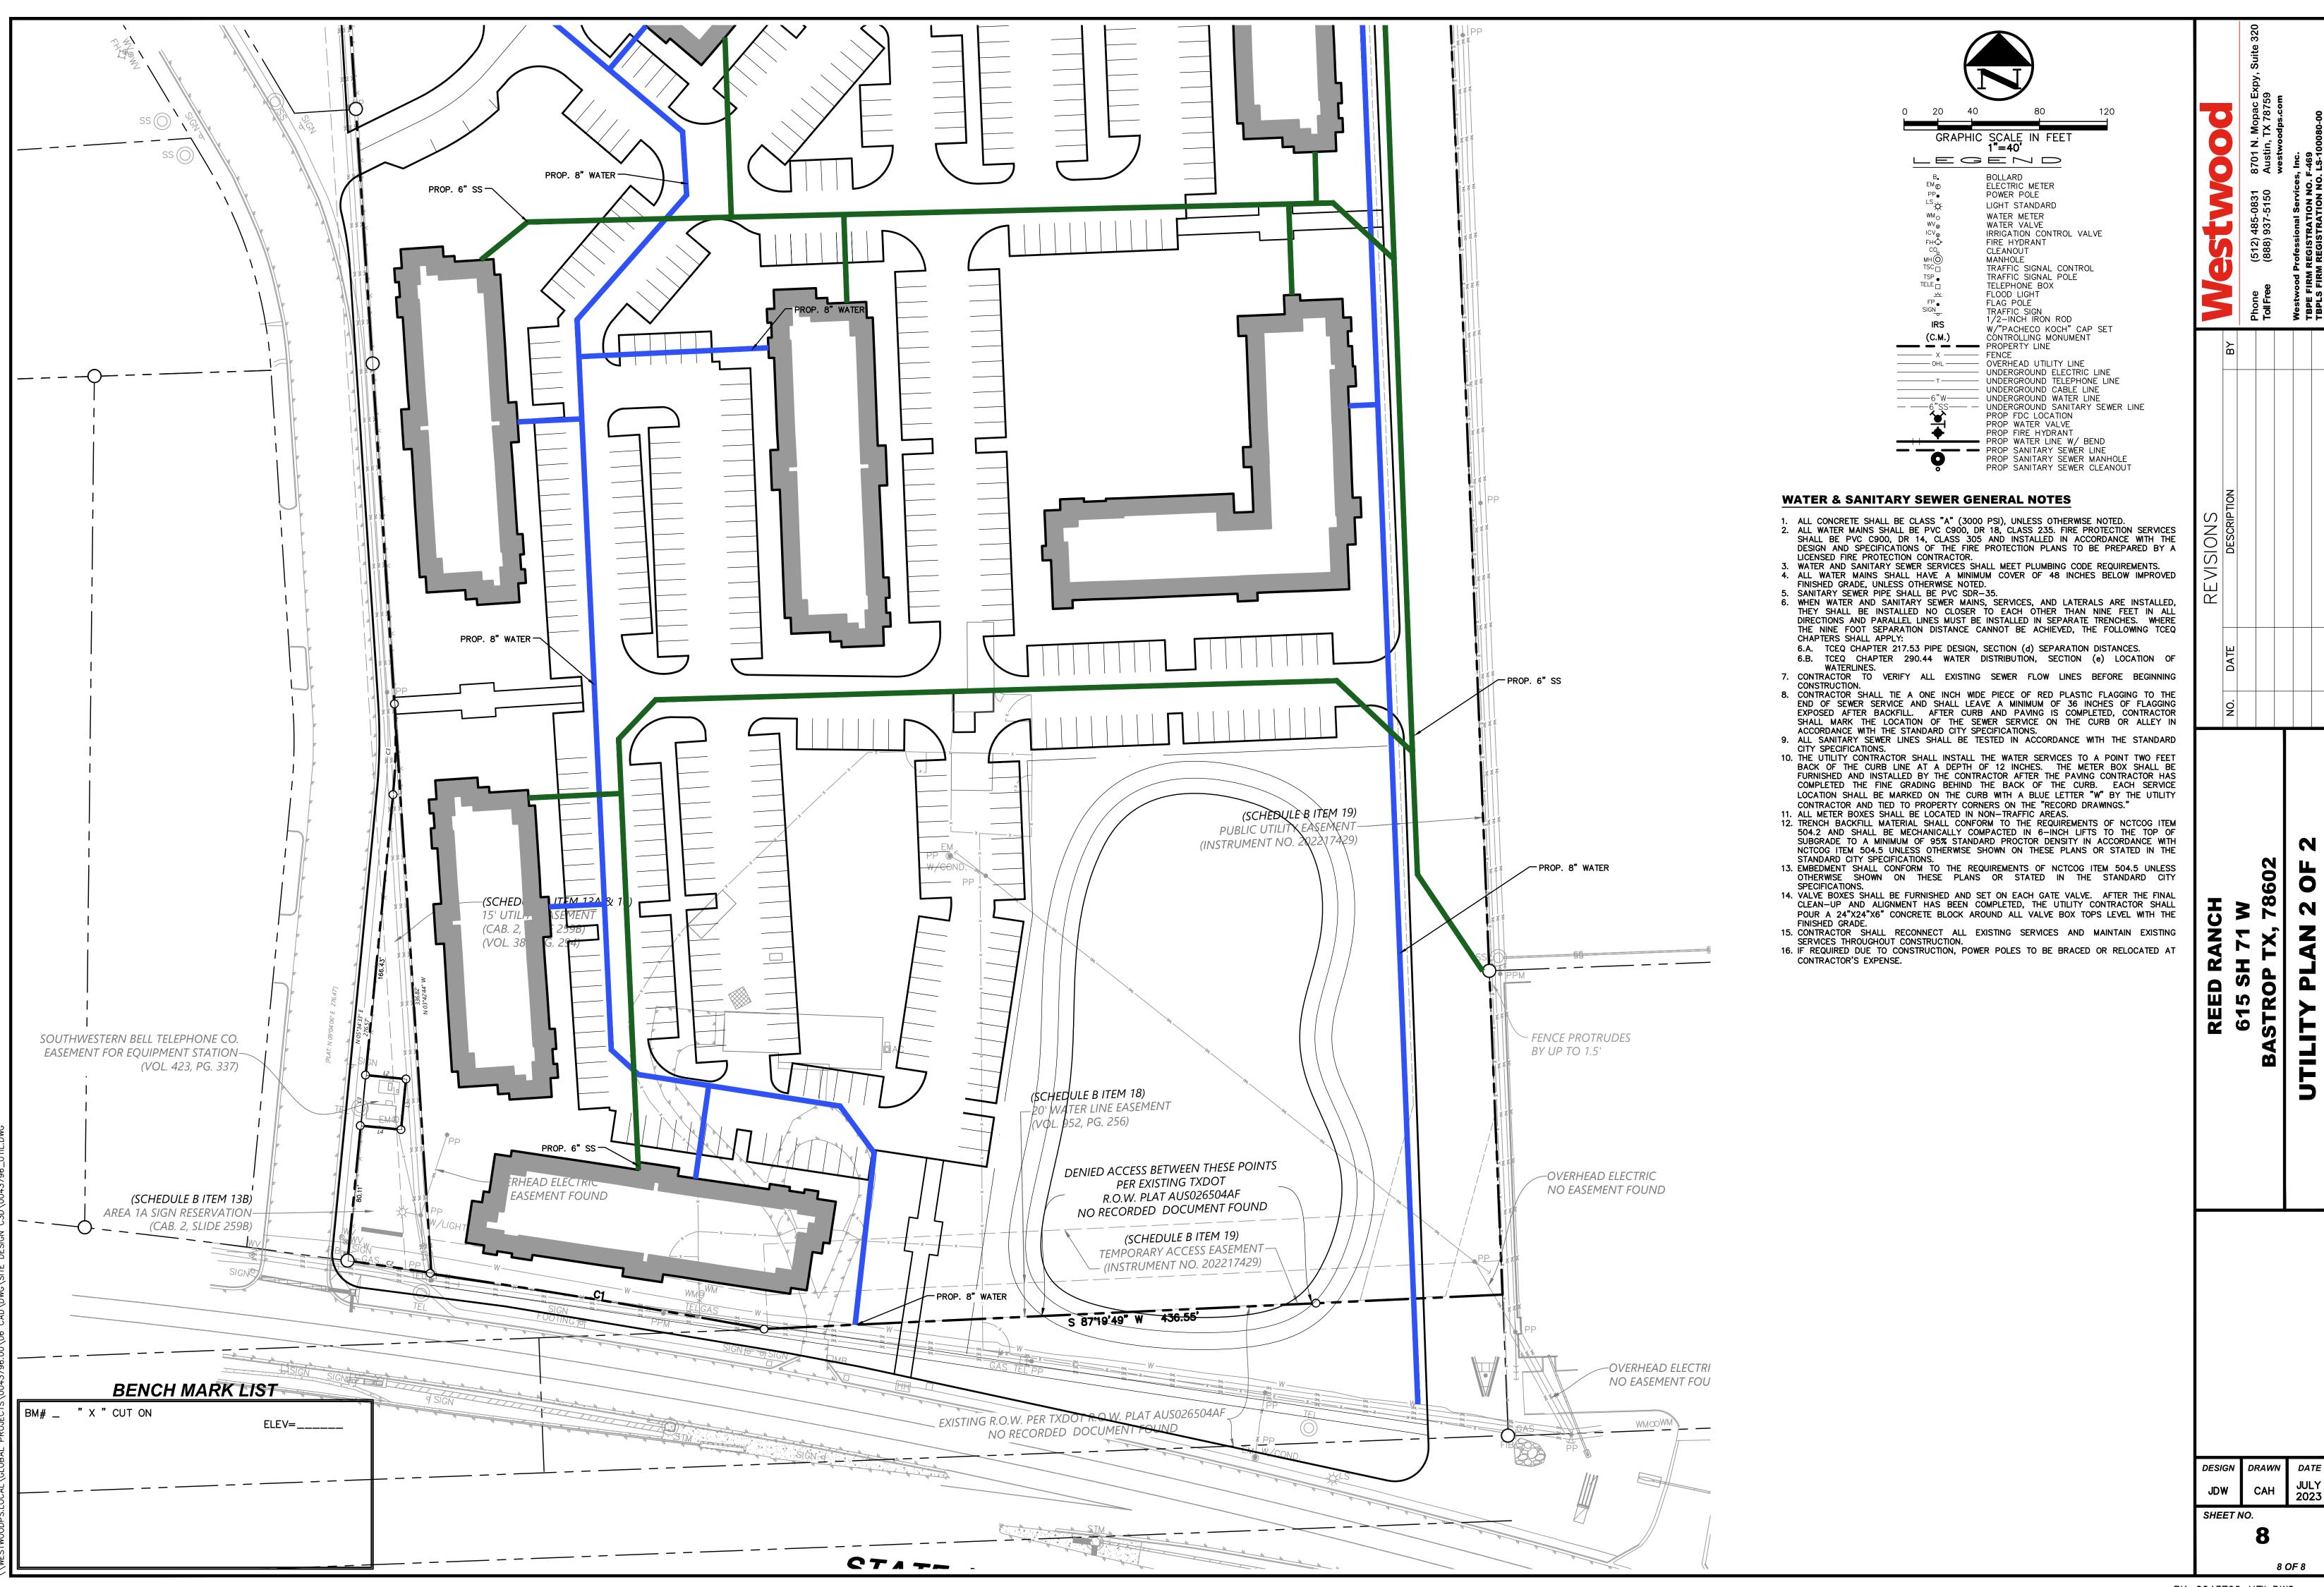
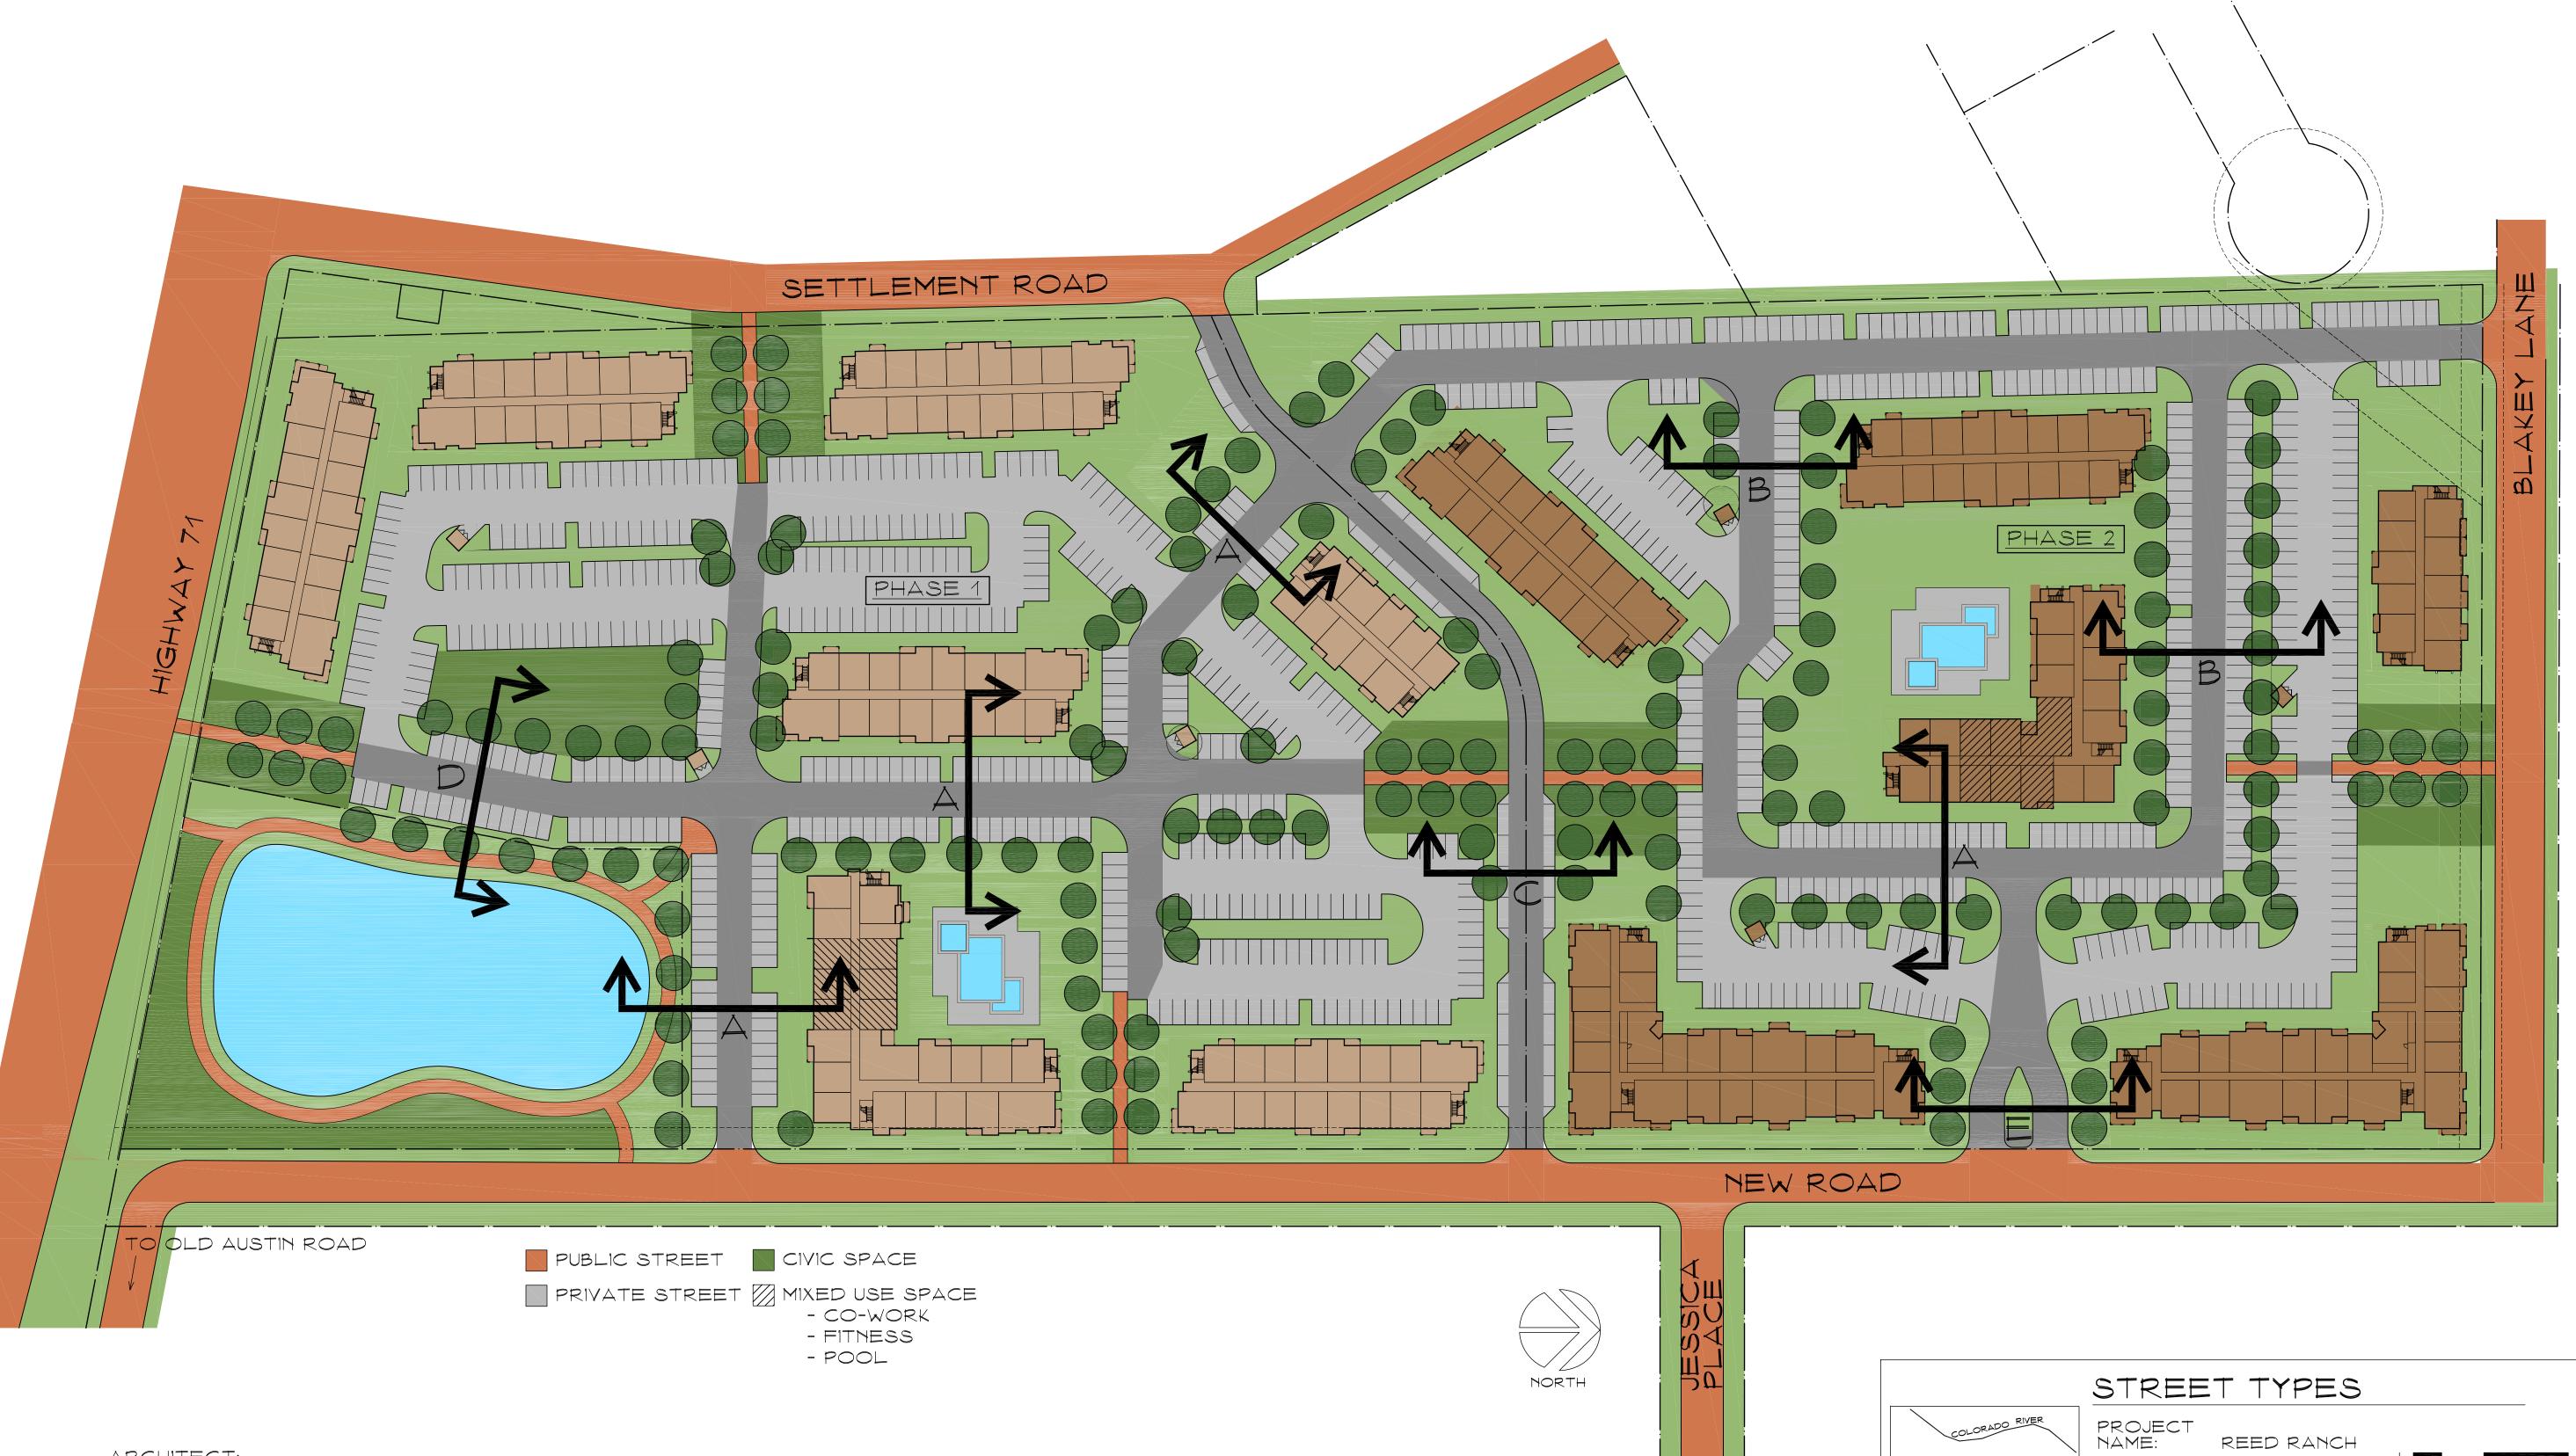


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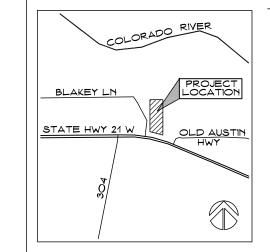


ARCHITECT: GARY G. WOOD

#12202

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DATE: 10 JUL 23

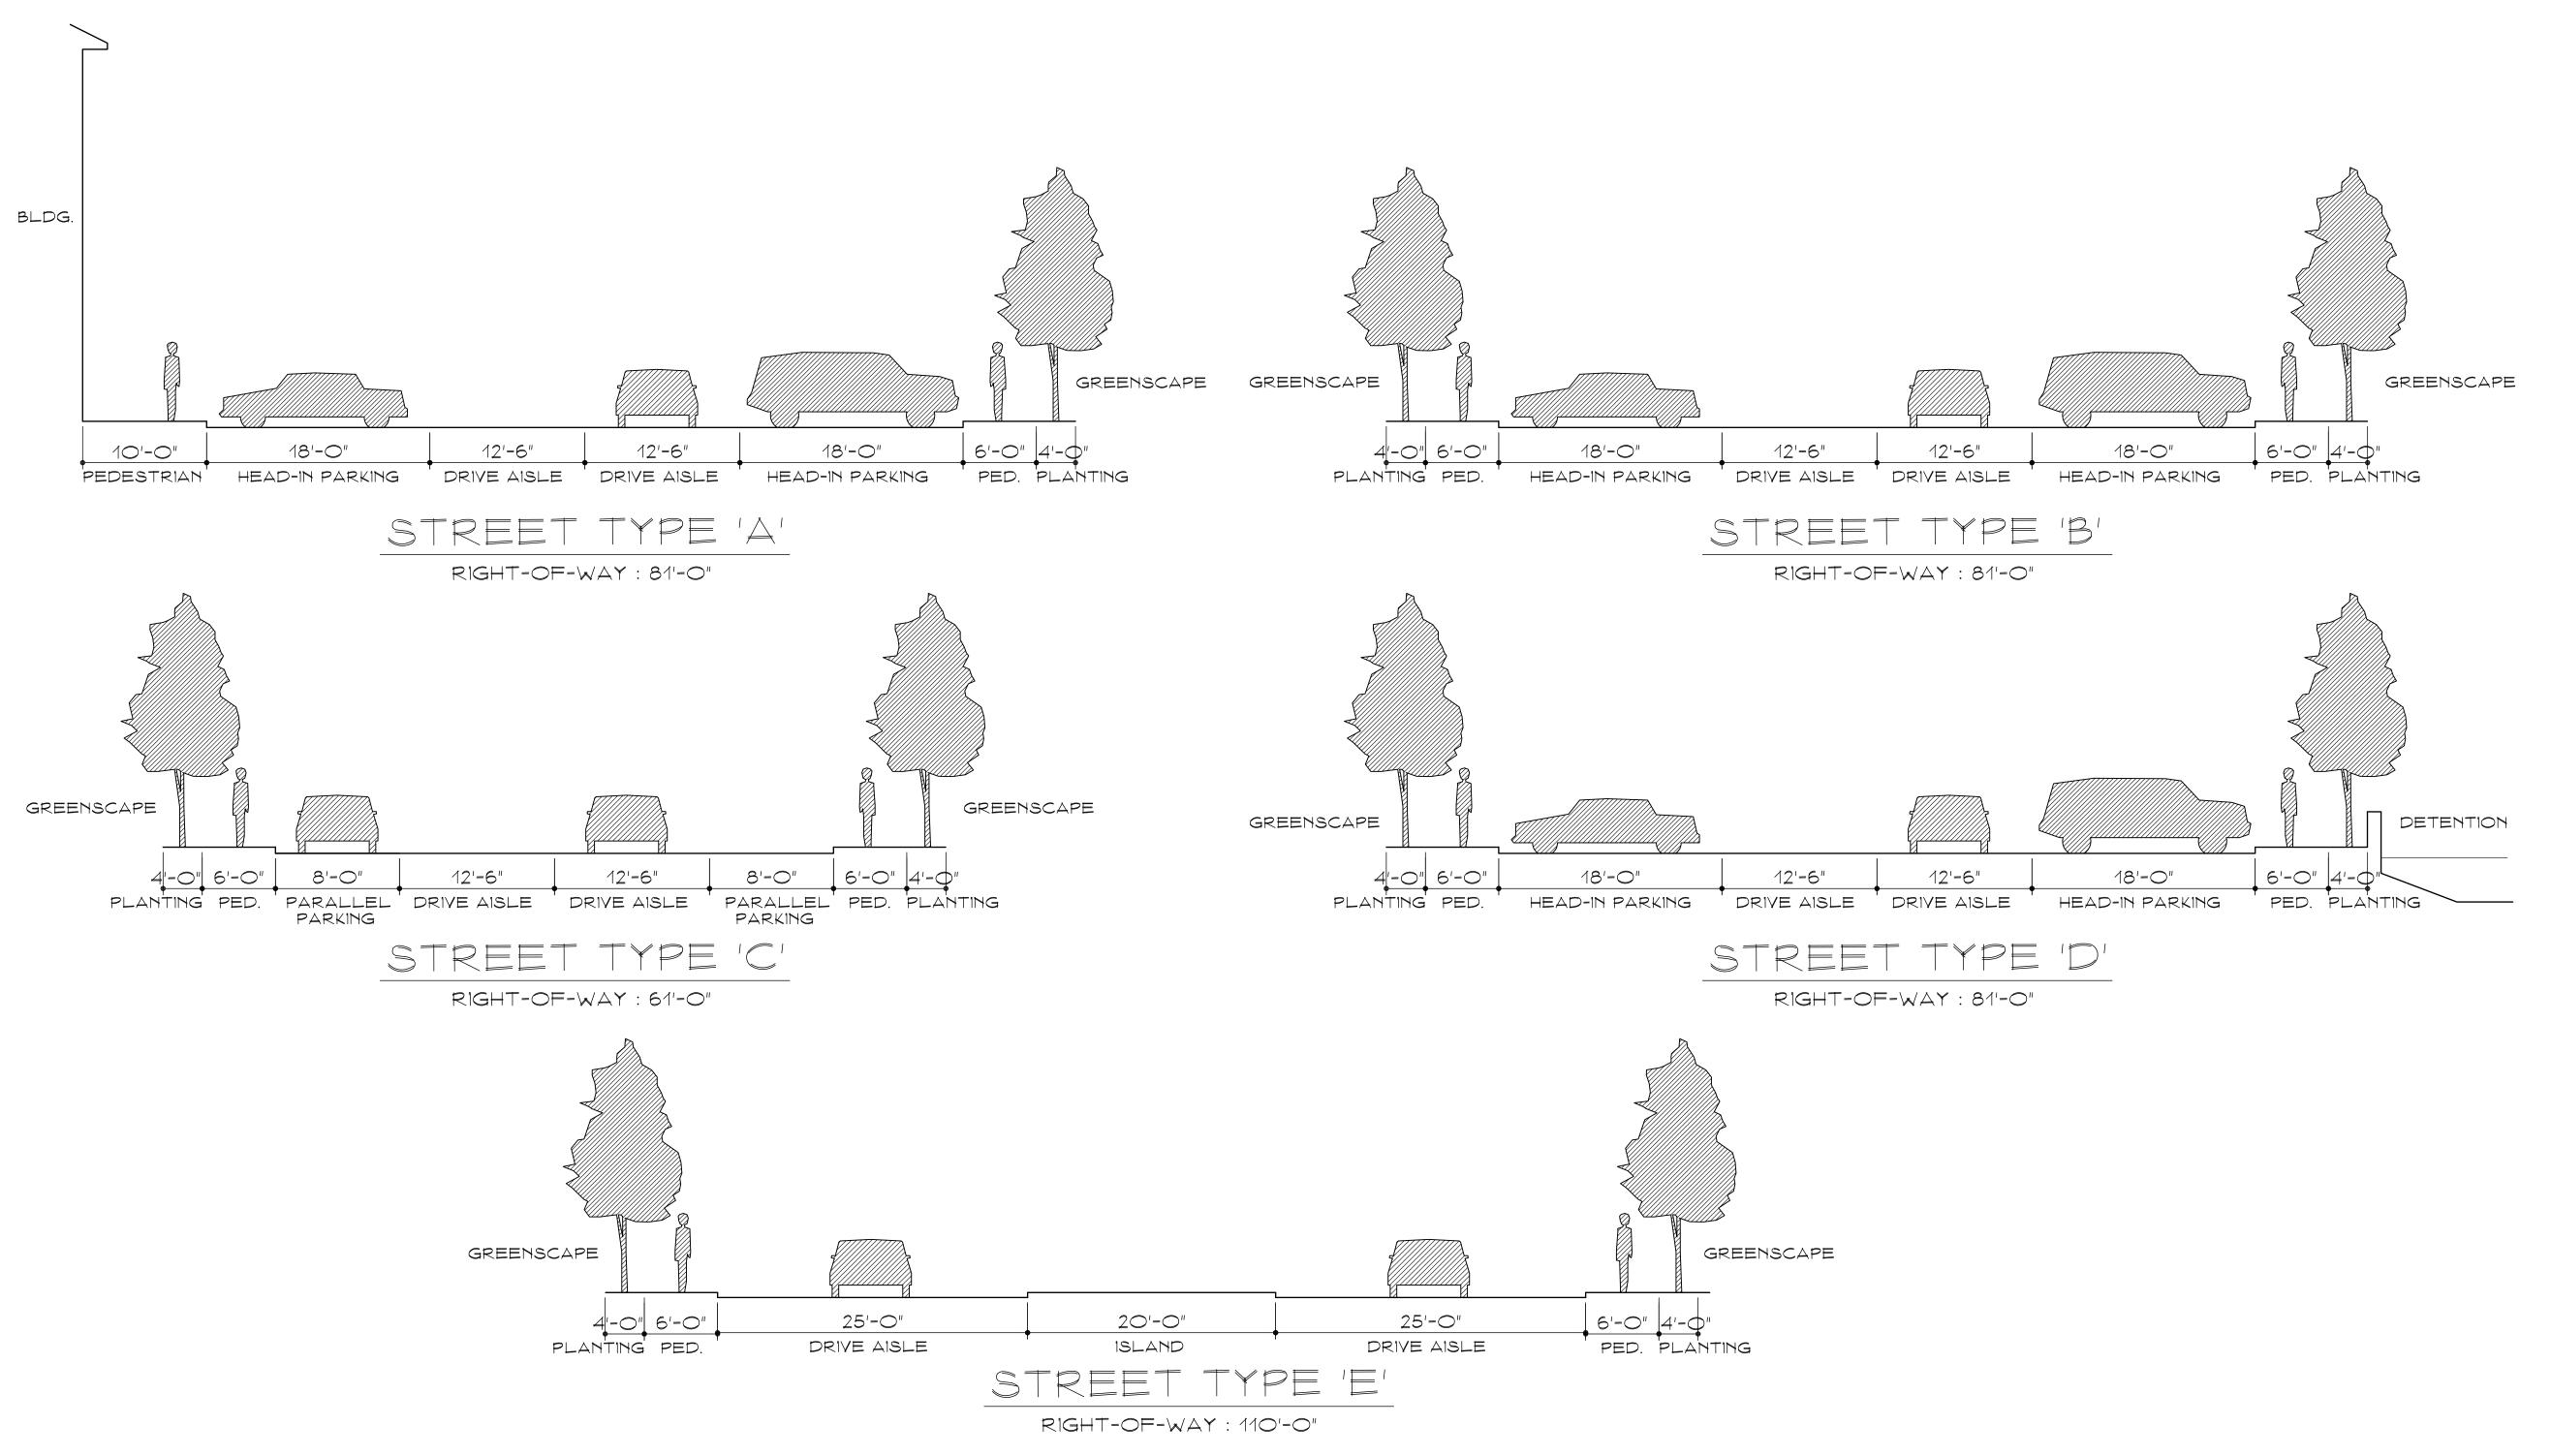


ACERAGE: 24.3 A.

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CORPORATION ARCHITECTS / PLANNERS
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SUITE 100 - GRAPEVINE, TX
76051 214/526-0731



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