Exhibit A

ADAM WORD GATES ARCHITECTURE STUDIO

CITY OF BASTROP ENGINEER

BASTROP AUTOMOTIVE ZONING AND DRAINAGE CONCEPT SCHEMES

118 FM 969 Bastrop, TX 78602

INDEX OF DRAWINGS

NUMBER NAME OF SHEET 00 GENERAL CS 0 DRAINAGE CONCEPT COVER COVERSHEET CS 2 PROJECT INFORMATION

1 OF 3 INFRASTRUCTURE PLAN 2 OF 3 EXISTING DRAINAGE AREA MAP 3 OF 3 PROPOSED DRAINAGE AREA MAP

05 ARCHITECTURAL ZS 0.1 EXISTING PLAN ZS 0.2 PEDESTRIAN SHED EXHIBIT ZS 1.1 PROPOSED DEVELOPMENT SCHEME ZS 1.2 PROPOSED DEVELOPMENT SCHEME ZS 2.1 ARCHITECTURAL VIEWS

PROJECT GOAL

TO RE-ZONE 2 LOTS FROM PLACE TYPE P2 TO P5. THEN AT 118 FM 969, DEMOLISH EXISTING STRUCTURES AND DEVELOP THE SITE FOR USE AS AN AUTOBODY SHOP SIMILAR TO THE ADJACENT SITE.

APPLICABLE CODES

- BASTROP BUILDING BLOCK (B3) CODE
- B³ TECHNICAL MANUAL
- B³ PATTERN BOOK
- STORMWATER DRAINAGE DESIGN MANUAL
- MASTER TRANSPORTATION PLAN CHAPTER 5
- BASTROP CODE OF ORDINANCES

PREVIOUS ENGAGEMENT

AUTOBODY SHOP – 118 FM 969 & 654 W HWY 71 November 3, 2022

Adam Gates and Banks Chisum Jennifer Bills, Trey Job, Keehren Baah, and Vivianna Andre

LEGAL DESCRIPTION

1.192 ACRES WITHING THE NANCY BLAKEY SURVEY, ABSTRACT NO. 98, BASTROP COUNTY, TEXAS

118 FM 969 BASTROP, TX 78602

78667 R78667

0.806 ACRES WITHING THE NANCY BLAKEY SURVEY, ABSTRACT NO. 98, **BASTROP COUNTY, TEXAS**

654 W SH 71 BASTROP, TX 78602

PROPERTY ID: 24712 GEOGRAPHIC ID: R24712

> 01/30/2023 **ISSUE DATE** PROJECT # 22-019 DRAWN BY Author PROJECT ARCHITECT

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ADAW W. GATES, AIA

PROJECT INFORMATION

CS 2

revision

118 FM 969 Bastrop, TX 78602

date

Adam W. Gates, AIA 346 Haliday Ave.

San Antonio, TX 78210

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013 °

EXISTING SITE PLAN

1" = 20'-0"

CELL TOWER

EASEMENT





COLOR LEGEND

GREEN - UNPROTECTED TREE	<13"
ORANGE - PROTECTED TREE	13" - 24"
RED - HERITAGE TREE	≥24"
LIGHT GRAY	IMPERVIOUS COVER
GRAY	EXISTING STRUCTURE
DARK GRAY	EXISTING STREET

TDEELECEND

EXIST HYDRANT AND WELL

EXISTING RESIDENCE

IREE	LEGEND	
001	19" DIAMETER - CEDAR ELM	
002	POST OAK (DEAD)	TO BE REMOVED
004	8" DIAMETER - POST OAK	
005	19" DIAMETER - LIVE OAK	
006	12" DIAMETER - POST OAK	
007	11" & 12" DIAMETER - PECAN	TO BE REMOVED
800	11" DIAMETER - PECAN	TO BE REMOVED
009	22" DIAMETER - POST OAK	TO BE REMOVED
010	17" DIAMETER - POST OAK	TO BE REMOVED
011	18" DIAMETER - POST OAK	
012	14" DIAMETER - POST OAK	TO BE REMOVED
013	15" DIAMETER - CEDAR (DEAD)	TO BE REMOVED
014	15" DIAMETER - POST OAK	TO BE REMOVED
015	16" DIAMETER - POST OAK	TO BE REMOVED
016	22" DIAMETER - POST OAK	
017	14" DIAMETER - RED OAK	

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ISSUE DATE 01/30/2023 PROJECT # 22-019


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EXISTING PLAN

—W SH 71 FR-



-BLAKEY LN-

389

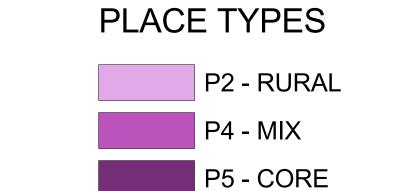0

-W SH 71-

R.O.W.

W SH 71 FR

-W SH 71

P4 - MIX
P5 - CORE
PDD - PLANNED
ROAD AND HWY

P2 - RURAL	P4 - MIX	P5 - CORE	PDD - PLANNED	TOTAL

EXISTING 47.48% 5.36% 19.04% 8.89% 80.77% PROPOSED 45.88% 5.36% 20.54% 8.89% 80.77%

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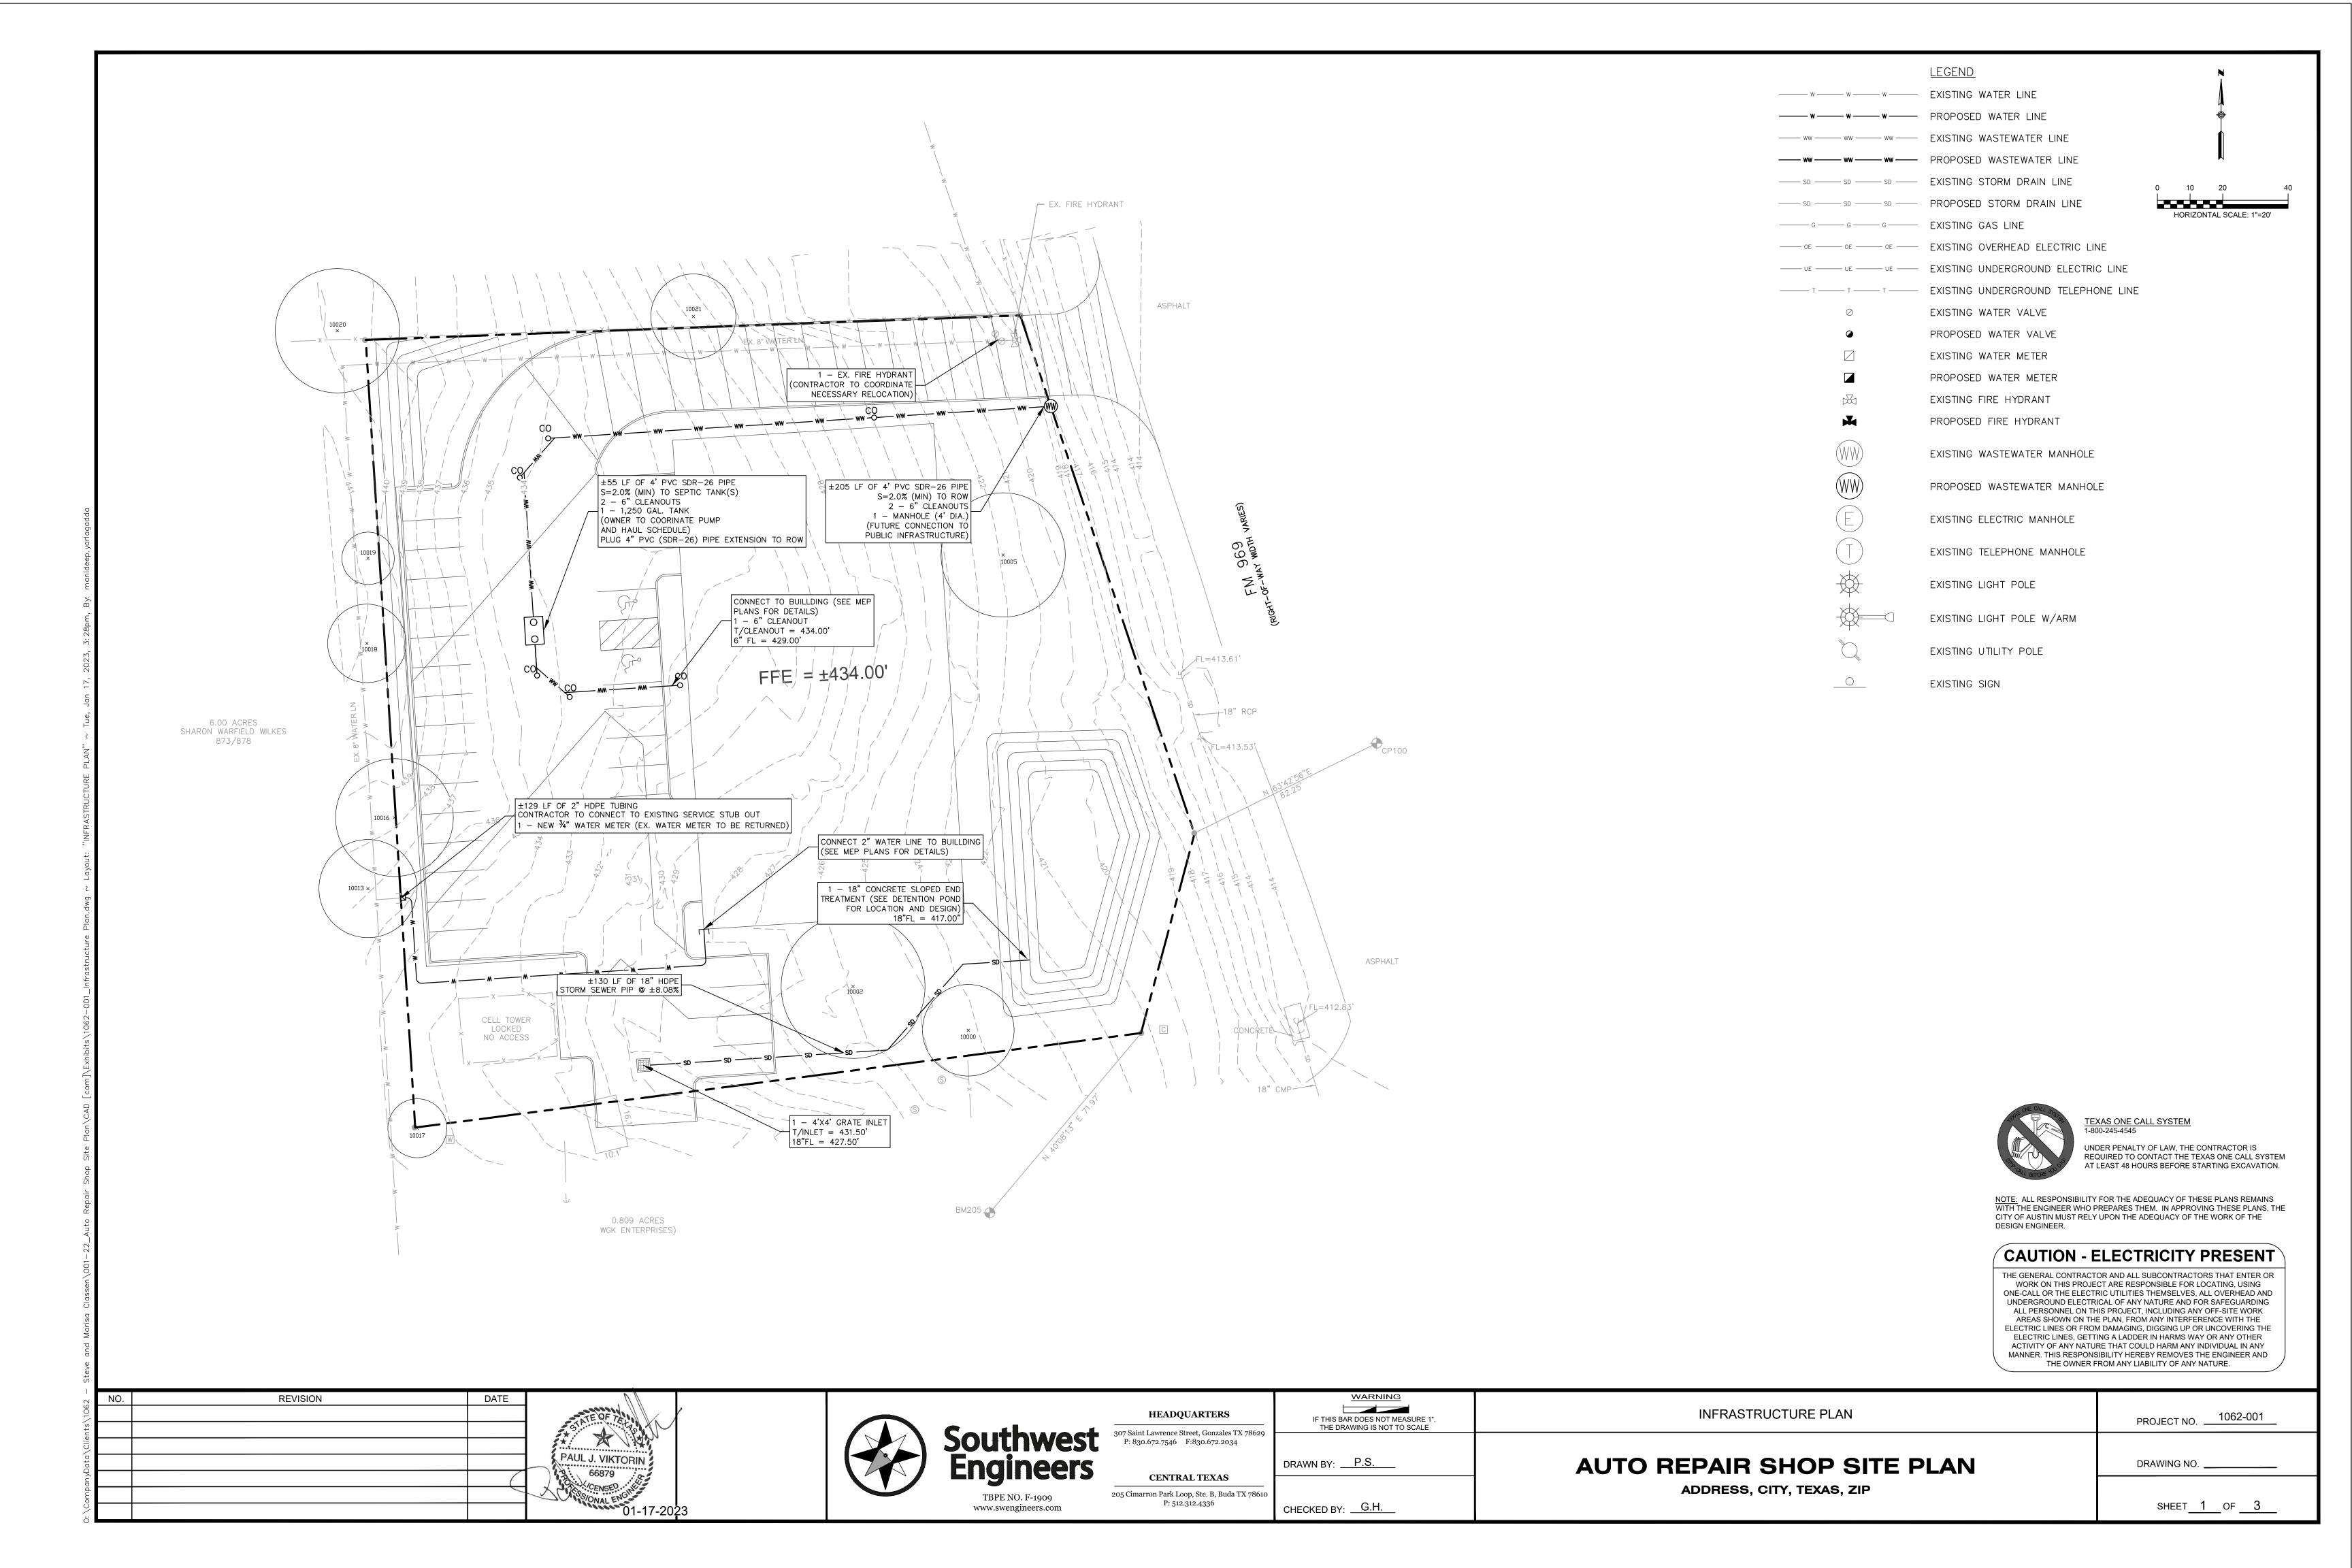
01/30/2023


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PEDESTRIAN SHED **EXHIBIT**


ZS 0.2





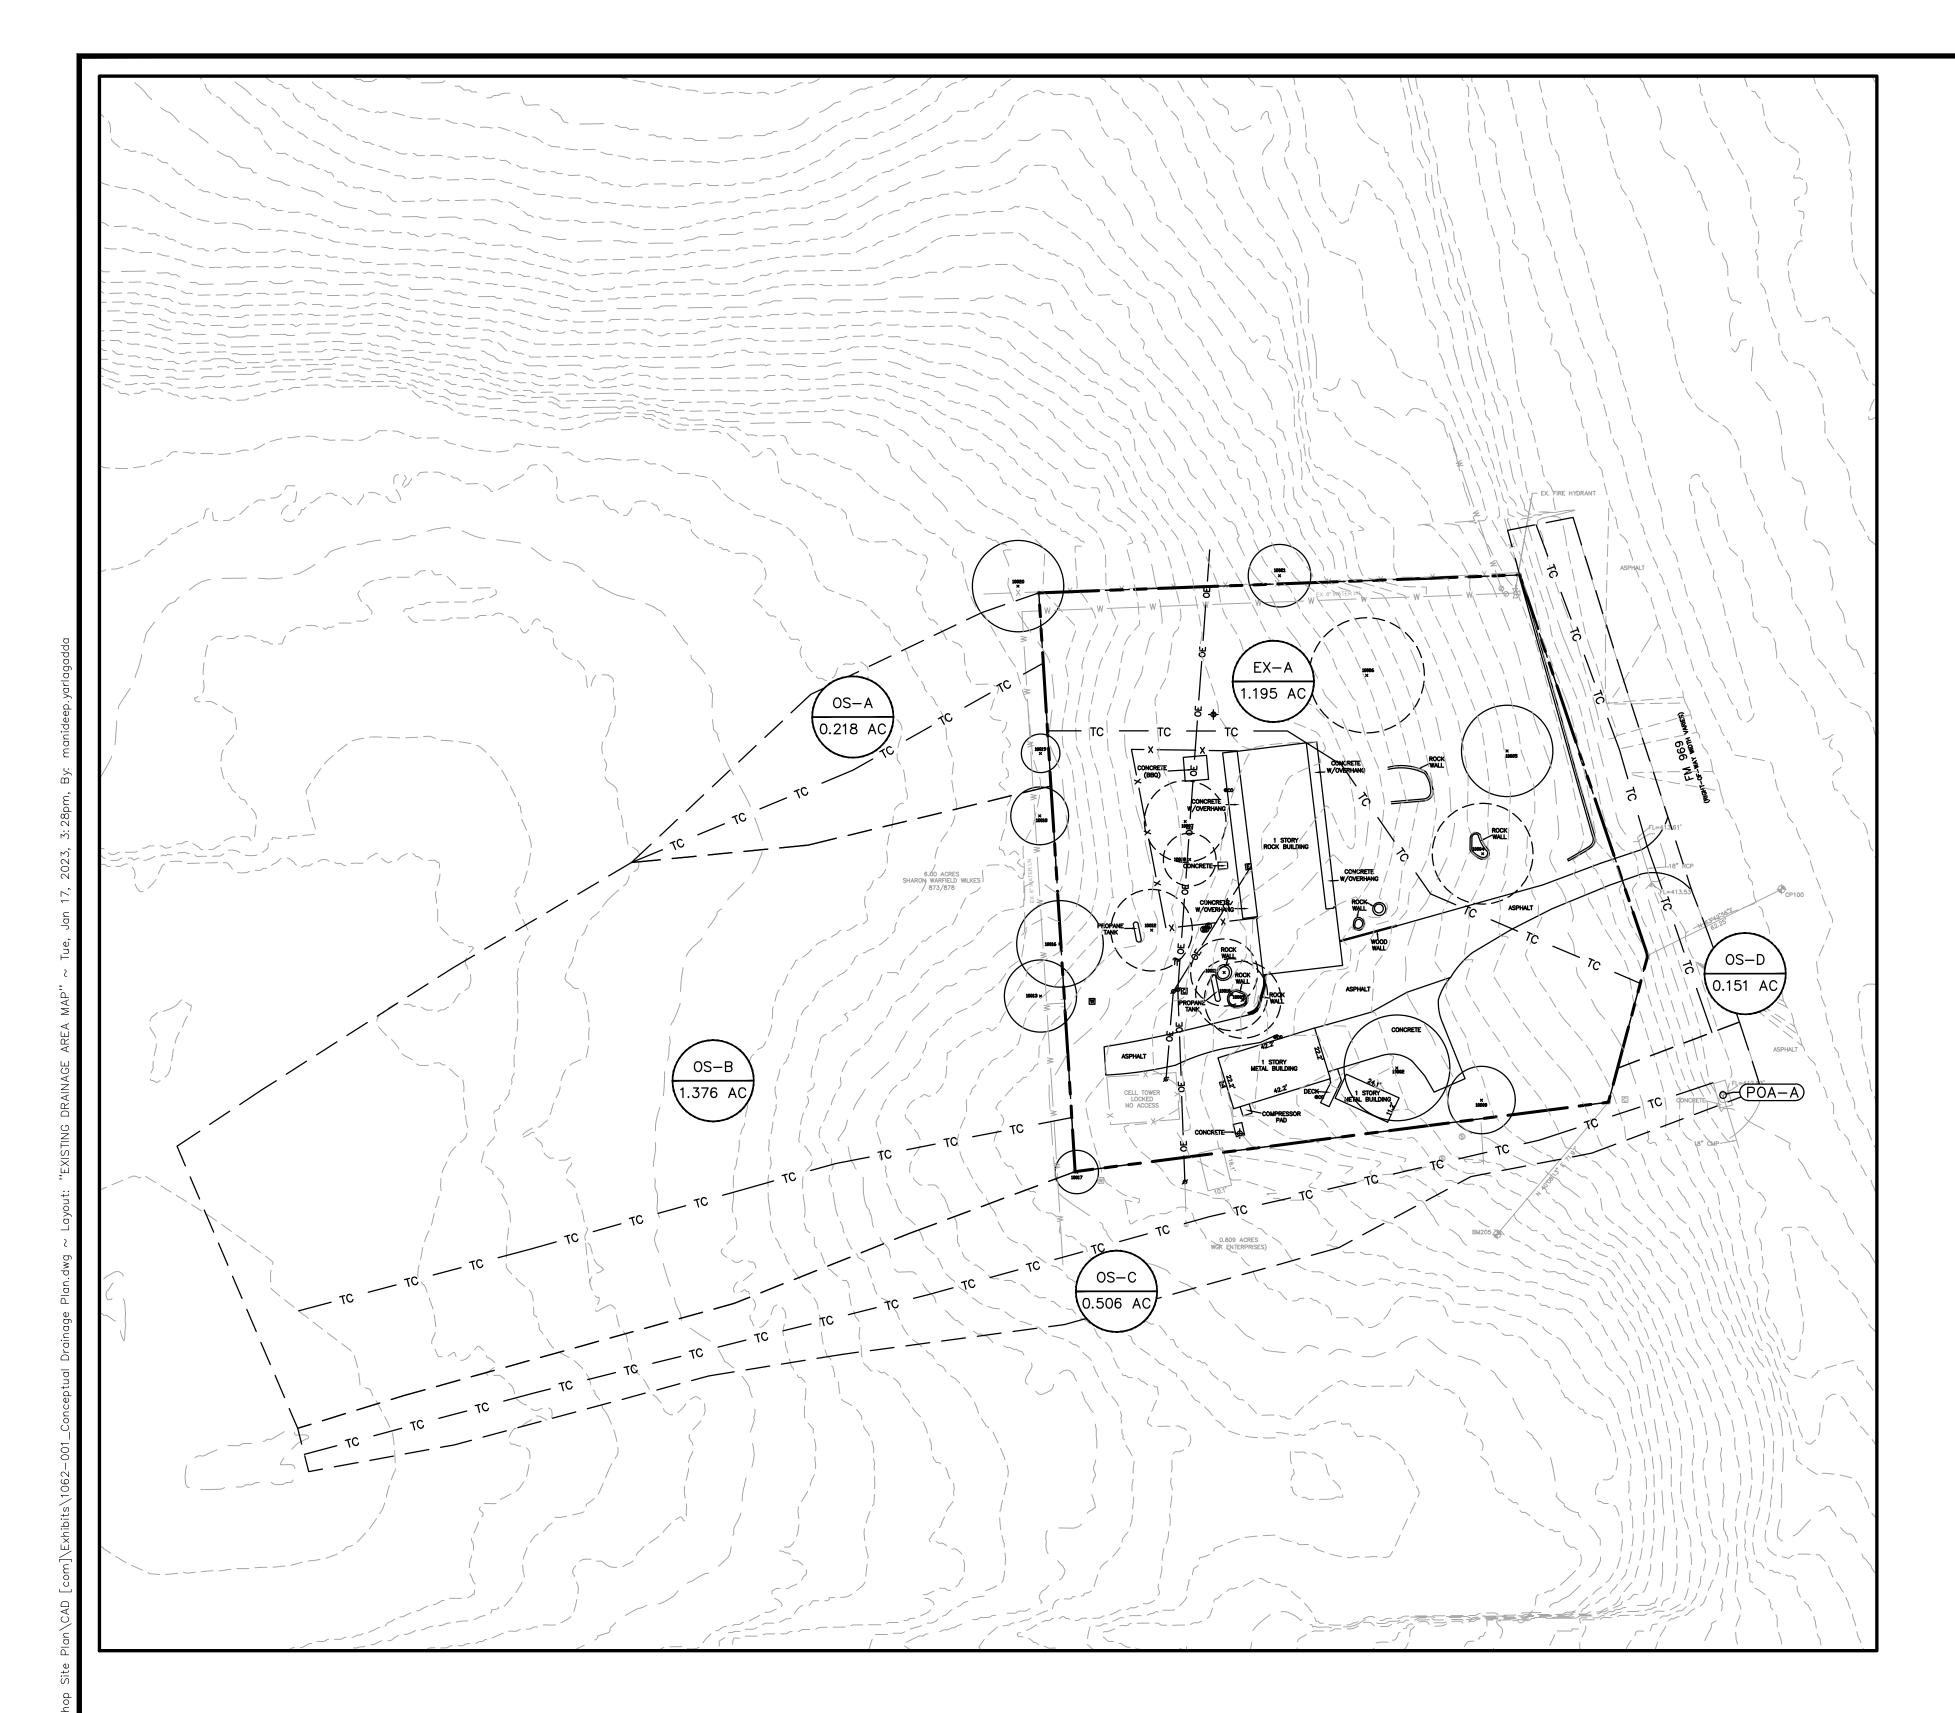

Drainage	Area (ac.)	•	Impervious	T _c (min.)	Pervious Cover Condition			2-Yr.				10-Yr.				25-Yr.				100-Yr.	
Area No.	rii da (ad.,)	Cover (ac.)	Cover (%)	- 0 ()		C _{f2}	C_2	i ₂ (in/hr)	Q ₂ (cfs)	C _{f10}	C ₁₀	i ₁₀ (in/hr)	Q ₁₀ (cfs)	C _{f25}	C ₂₅	i ₂₅ (in/hr)	Q ₂₅ (cfs)	C _{f 100}	C ₁₀₀	i ₁₀₀ (in/hr)	Q ₁₀₀ (cfs)
EX-A	1.195 ac	0.000 ac	0%	10.0 min.	Dev - Grass - Good Condition - Flat, 0-2%	1.00	0.21	4.74 in/hr	1.2 cfs	1.10	0.25	7.47 in/hr	2.5 cfs	1.20	0.29	9.01 in/hr	3.7 cfs	1.25	0.36	11.82 in/hr	6.4 cfs
OS-A	0.218 ac	0.000 ac	0%	13.5 min.	Dev - Grass - Good Condition - Flat, 0-2%	1.00	0.21	4.21 in/hr	0.2 cfs	1.10	0.25	6.60 in/hr	0.4 cfs	1.20	0.29	7.96 in/hr	0.6 cfs	1.25	0.36	10.48 in/hr	1.0 cfs
OS-B	1.376 ac	0.000 ac	0%	12.6 min.	Dev - Grass - Good Condition - Flat, 0-2%	1.00	0.21	4.33 in/hr	1.3 cfs	1.10	0.25	6.79 in/hr	2.6 cfs	1.20	0.29	8.19 in/hr	3.9 cfs	1.25	0.36	10.78 in/hr	6.7 cfs
os-c	0.506 ac	0.000 ac	0%	13.7 min.	Dev - Grass - Good Condition - Flat, 0-2%	1.00	0.21	4.19 in/hr	0.4 cfs	1.10	0.25	6.56 in/hr	0.9 cfs	1.20	0.29	7.92 in/hr	1.4 cfs	1.25	0.36	10.43 in/hr	2.4 cfs
OS-D	0.151 ac	0.000 ac	0%	15.9 min.	Dev - Grass - Good Condition - Flat, 0-2%	1.00	0.21	3.93 in/hr	0.1 cfs	1.10	0.25	6.14 in/hr	0.3 cfs	1.20	0.29	7.40 in/hr	0.4 cfs	1.25	0.36	9.77 in/hr	0.7 cfs

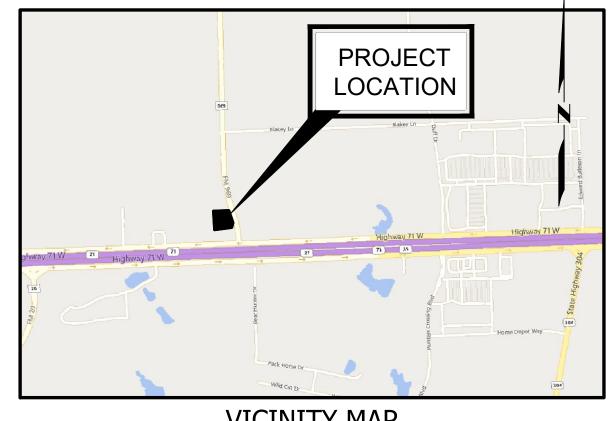

BENCHMARK INFORMATION:


BM #205: COTTON SPINDLE WITH "SURE SHOTT CONTROL" WASHER SET IN THE SPLIT IN THE DRIVE FOR ALIBER AUTO GLASS, +/- 72' SOUTHWEST OF THE MOST

ELEVATION = 428.48'

LEGAL DESCRIPTION A98 BLAKEY, NANCY, ACRES 1.1920

EXISTING IMPERVIOUS COVER 10,673.55 SQFT

PROPOSED IMPERVIOUS COVER 30,935.57 SQFT

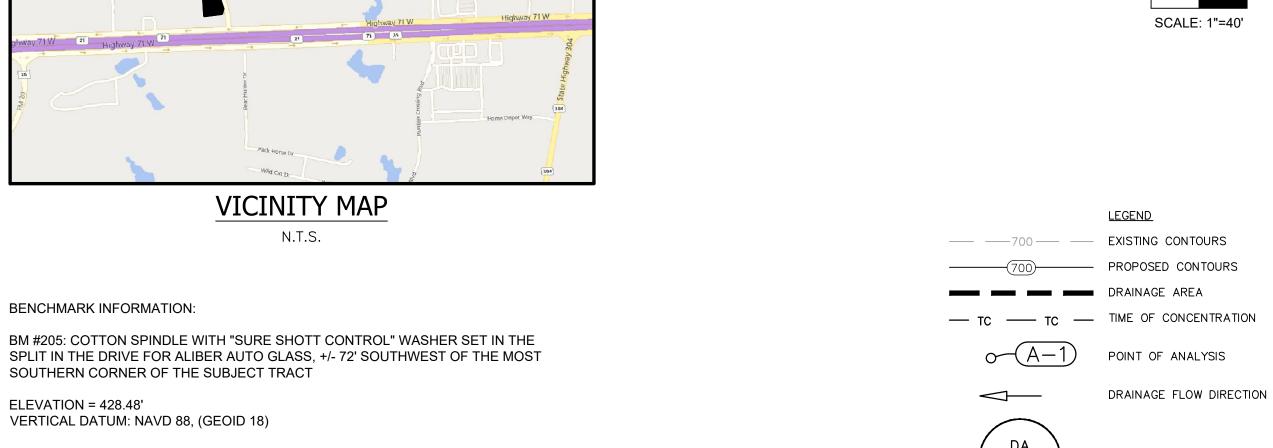

TIME OF CONCENTRATION

	SHEET FLOW				SHAL	LOW CONC	ENTRATED	FLOW	CHANN	EL FLOW (
DRAINAGE AREA	SLOPE	Г	n	Tc sheet	SLOPE	L	Paved?	Tc Shallow	Vavg	L	Tc Channel	Total Tc	Tc Used
	(FT/FT)	FT		(MIN.)	(FT/FT)	FT	Y or N	(MIN.)	(FT/S)		(MIN.)	(MIN.)	(MIN.)
EX A	0.070	100.000	0.240	7.6	0.074	187	N	0.7	4.00	0	0.00	8.3	10.0
OS-A	0.018	100.000	0.240	13.0	0.038	91	N	0.5	4.00	0	0.00	13.5	13.5
OS-B	0.023	100.000	0.240	11.8	0.053	232	Υ	0.8	4.00	0	0.00	12.6	12.6
OS-C	0.022	100.000	0.240	12.0	0.063	507	Υ	1.7	4.00	0	0.00	13.7	13.7
OS-D	0.012	100.000	0.240	15.3	0.000	0	Υ	0.0	4.00	124	0.52	15.9	15.9

	EXISTING DRAINAGE SUMMARY TABLE (NRCS METHOD)												
AREA NAME EX - A OS-A OS-B OS-C OS-D POA - A													
Drainage Area (ac.)	1.195	0.218	1.376	0.506	0.151								
% Impervious	0%	0%	0%	0%	0%								
Tc (hrs)	0.167	0.225	0.211	0.228	0.264								
2 year Discharge (cfs)	1.190	0.193	1.252	0.445	0.125	3.206							
10 year Discharge (cfs)	2.456	0.396	2.571	0.913	0.255	6.591							
25 year Discharge (cfs)	3.747	0.604	3.924	1.394	0.389	10.059							
100 year Discharge (cfs)	6.354	1.028	6.675	2.374	0.664	17.096							



TEXAS ONE CALL SYSTEM 1-800-245-4545

DRAINAGE AREA LABEL


INLET LABEL

UNDER PENALTY OF LAW, THE CONTRACTOR IS REQUIRED TO CONTACT THE TEXAS ONE CALL SYSTEM AT LEAST 48 HOURS BEFORE STARTING EXCAVATION.

 ${
m NOTE:}$ ALL RESPONSIBILITY FOR THE ADEQUACY OF THESE PLANS REMAINS WITH THE ENGINEER WHO PREPARES THEM. IN APPROVING THESE PLANS, THE CITY OF AUSTIN MUST RELY UPON THE ADEQUACY OF THE WORK OF THE DESIGN ENGINEER.

CAUTION - ELECTRICITY PRESENT

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HEADQUARTERS 307 Saint Lawrence Street, Gonzales TX 78629 P: 830.672.7546 F:830.672.2034

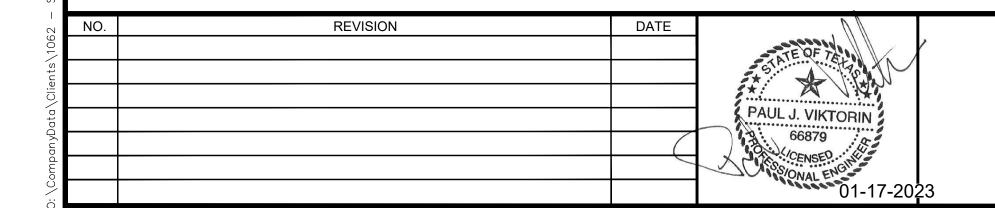CENTRAL TEXAS 205 Cimarron Park Loop, Ste. B, Buda TX 78610 P: 512.312.4336

	IF THIS BAR DOES NOT MEASURE 1", THE DRAWING IS NOT TO SCALE
AUT	DRAWN BY: P.S.


CHECKED BY: G.H.

O REPAIR SHOP SITE PLAN ADDRESS, CITY, TEXAS, ZIP

EXISTING DRAINAGE AREA MAP


DRAWING NO. ___ SHEET 2 OF 3

PROJECT NO. 1062-001

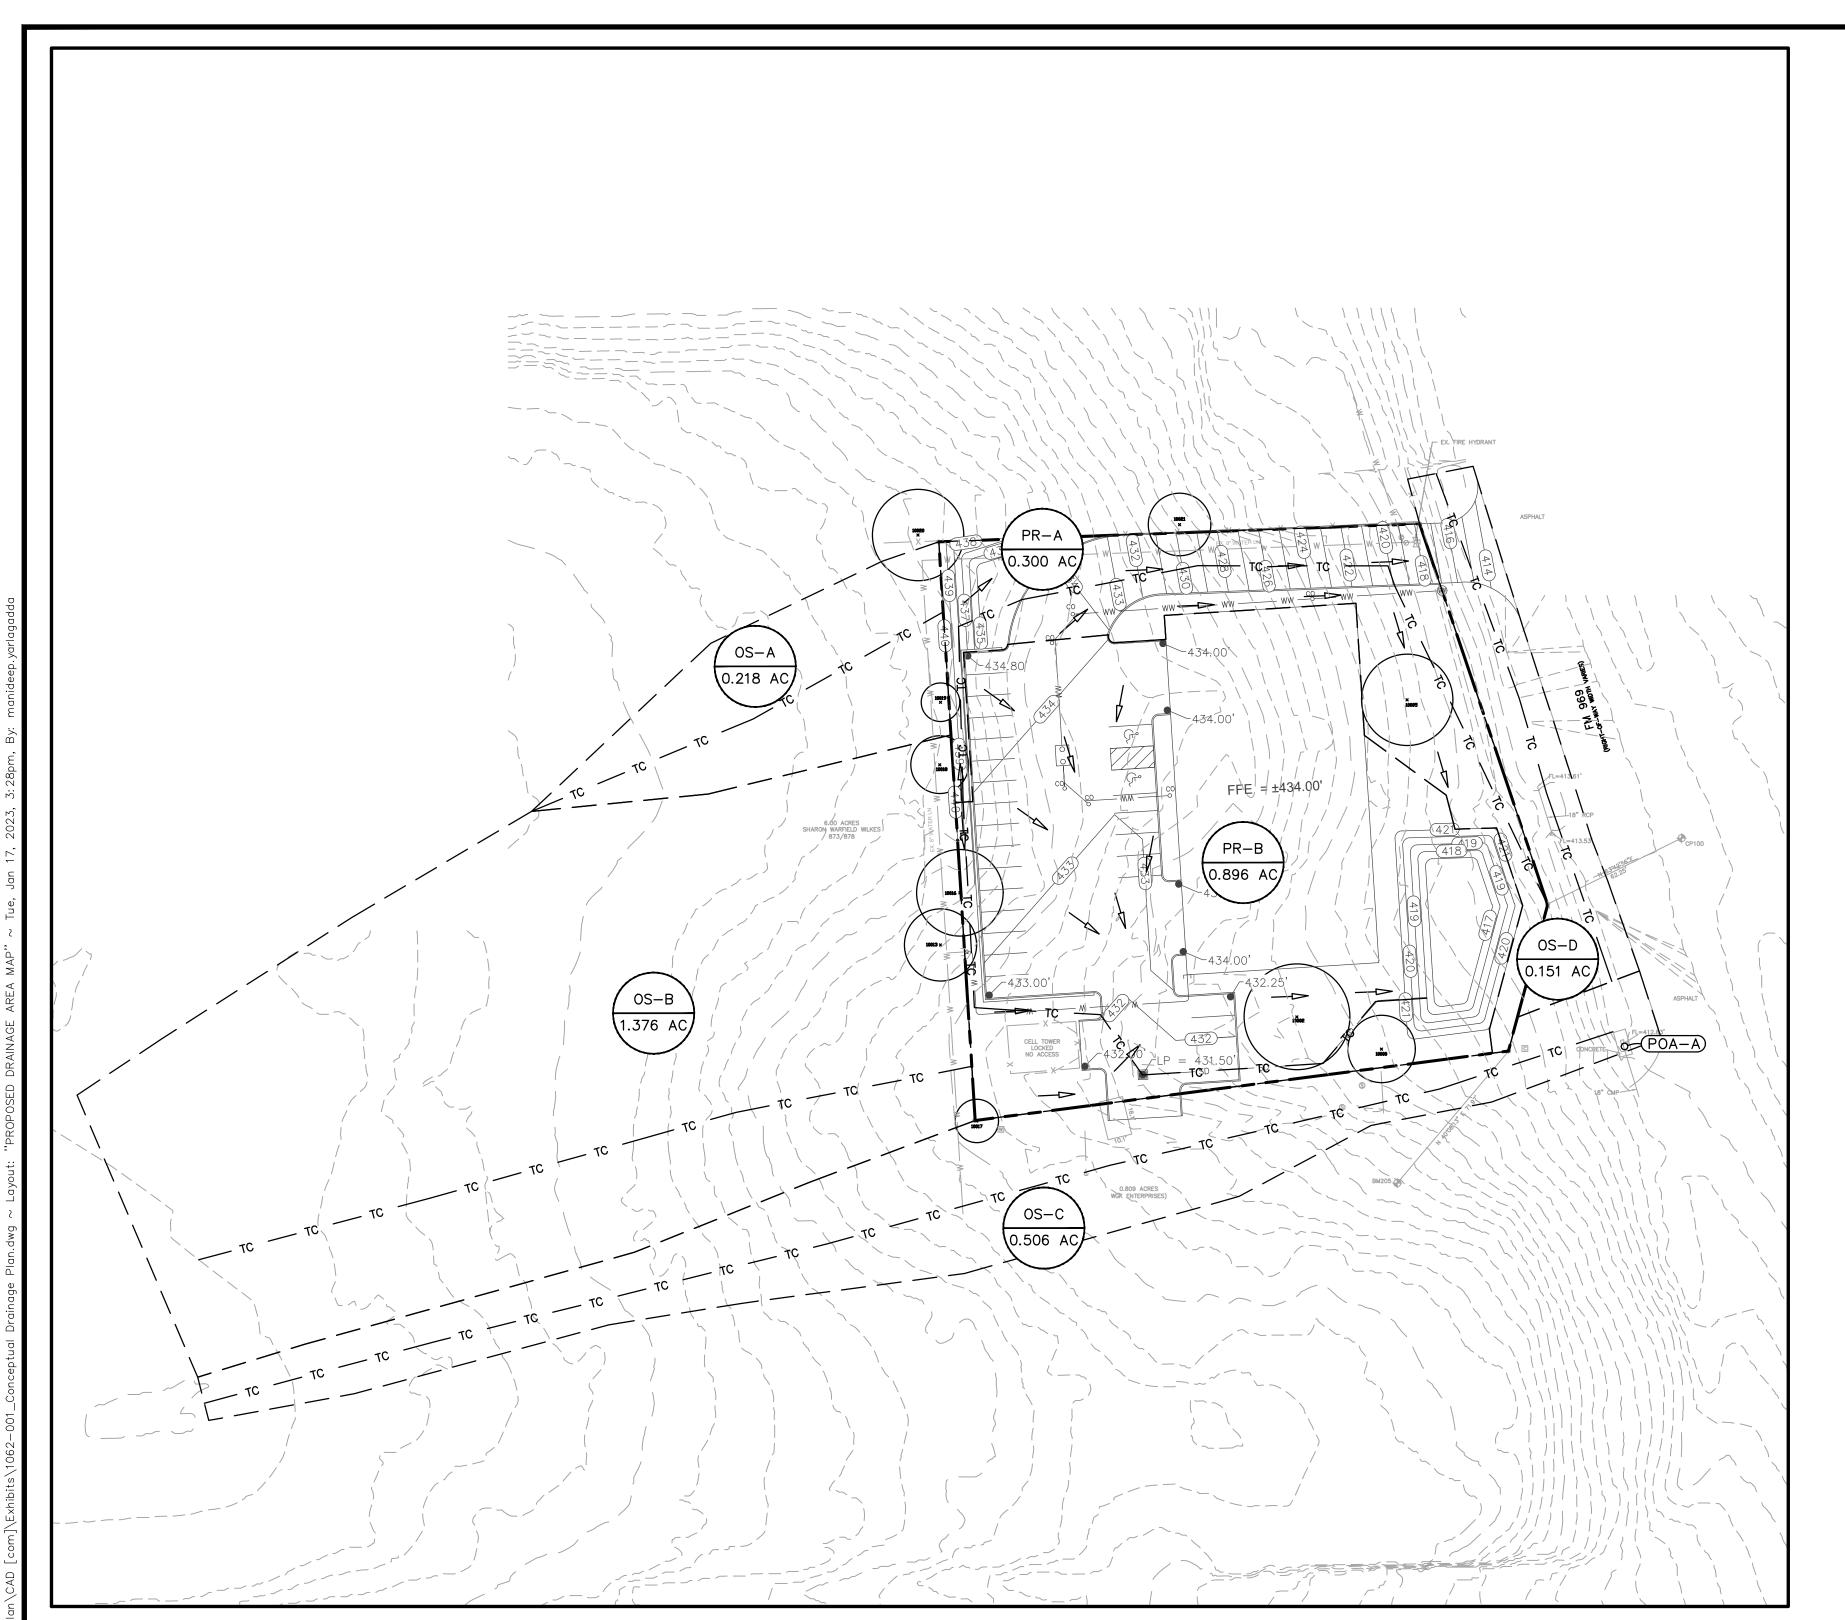

PROPOSED DRAINAGE SUMMARY TABLE (RATIONAL METHOD)

Drainage	Drainage Area (ac.) Estimated Impervious Cover (ac.) Cover (%) T _c (min.)		T (min)	.) Pervious Cover Condition			2-Yr.		10-Yr.			25-Yr.				100-Yr.					
Area No.			16 ()			C_2	i ₂ (in/hr)	Q ₂ (cfs)	C _{f10}	C ₁₀	i ₁₀ (in/hr)	Q ₁₀ (cfs)	C _{f25}	C ₂₅	i ₂₅ (in/hr)	Q ₂₅ (cfs)	C _{f 100}	C ₁₀₀	i ₁₀₀ (in/hr)	Q ₁₀₀ (cfs)	
PR-A	0.300 ac	0.112 ac	37%	10.6 min.	Dev - Grass - Good Condition - Flat, 0-2%	1.00	0.41	4.65 in/hr	0.6 cfs	1.10	0.47	7.32 in/hr	1.1 cfs	1.20	0.51	8.82 in/hr	1.6 cfs	1.25	0.59	11.58 in/hr	2.6 cfs
PR-B	0.896 ac	0.598 ac	67%	10.3 min.	Dev - Grass - Good Condition - Flat, 0-2%	1.00	0.57	4.69 in/hr	2.4 cfs	1.10	0.64	7.38 in/hr	4.6 cfs	1.20	0.68	8.89 in/hr	6.5 cfs	1.25	0.77	11.67 in/hr	10.0 cfs
OS-A	0.218 ac	0.000 ac	0%	13.5 min.	Dev - Grass - Good Condition - Flat, 0-2%	1.00	0.21	4.21 in/hr	0.2 cfs	1.10	0.25	6.60 in/hr	0.4 cfs	1.20	0.29	7.96 in/hr	0.6 cfs	1.25	0.36	10.48 in/hr	1.0 cfs
OS-B	1.376 ac	0.000 ac	0%	12.6 min.	Dev - Grass - Good Condition - Flat, 0-2%	1.00	0.21	4.33 in/hr	1.3 cfs	1.10	0.25	6.79 in/hr	2.6 cfs	1.20	0.29	8.19 in/hr	3.9 cfs	1.25	0.36	10.78 in/hr	6.7 cfs
os-c	0.506 ac	0.000 ac	0%	13.7 min.	Dev - Grass - Good Condition - Flat, 0-2%	1.00	0.21	4.19 in/hr	0.4 cfs	1.10	0.25	6.56 in/hr	0.9 cfs	1.20	0.29	7.92 in/hr	1.4 cfs	1.25	0.36	10.43 in/hr	2.4 cfs
OS-D	0.151 ac	0.000 ac	0%	15.9 min.	Dev - Grass - Good Condition - Flat, 0-2%	1.00	0.21	3.93 in/hr	0.1 cfs	1.10	0.25	6.14 in/hr	0.3 cfs	1.20	0.29	7.40 in/hr	0.4 cfs	1.25	0.36	9.77 in/hr	0.7 cfs

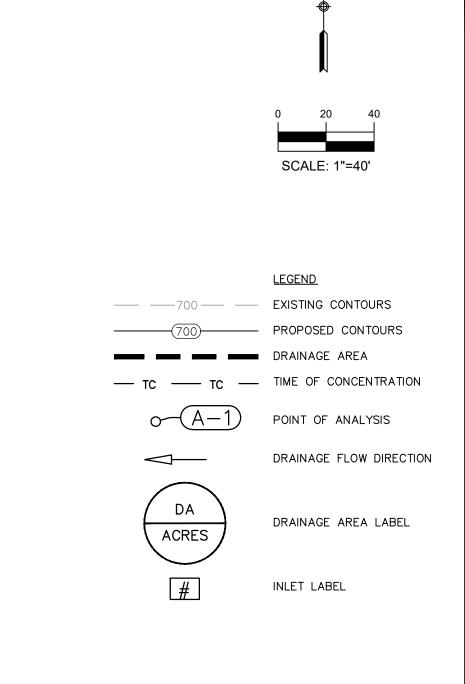

TIME OF CONCENTRATION

	SHEET FLOW				SHAL	LOW CONC	ENTRATED	FLOW	CHANN	IEL FLOW (GUTTER)		
DRAINAGE AREA	SLOPE	L	n	Tc sheet	SLOPE	L	Paved?	Tc Shallow	Vavg	L	Tc Channel	Total Tc	Tc Used
	(FT/FT)	FT		(MIN.)	(FT/FT)	FT	Y or N	(MIN.)	(FT/S)		(MIN.)	(MIN.)	(MIN.)
PR A	0.040	100.000	0.240	9.5	0.080	162	Y	0.5	4.00	147	0.61	10.6	10.6
PR B	0.040	100.000	0.240	9.5	0.029	68	Y	0.3	4.00	131	0.54	10.3	10.3
OS-A	0.018	100.000	0.240	13.0	0.038	91	N	0.5	4.00	0	0.00	13.5	13.5
OS-B	0.023	100.000	0.240	11.8	0.053	232	Y	0.8	4.00	0	0.00	12.6	12.6
OS-C	0.022	100.000	0.240	12.0	0.063	507	Y	1.7	4.00	0	0.00	13.7	13.7
OS-D	0.012	100.000	0.240	15.3	0.000	0	Y	0.0	4.00	124	0.52	15.9	15.9

	PROPOSED DRAINAGE SUMMARY TABLE													
	(NRCS METHOD)													
AREA NAME	PR - A	PR - B (TO POND)	DETENTION POND (WSE)	DETENTION POND RELEASE (POA-B2)	OS-A	OS-B	OS-C	OS-D	PROPOSED POA - A	EXISTING POA-A				
Drainage Area (ac.)	0.300	0.896			0.218	1.376	0.506	0.151						
% Impervious	37%	67%			0.00%	0.00%	0.00%	0.00%						
Tc (hrs)	0.176	0.172			0.225	0.211	0.228	0.264						
2 year Discharge (cfs)	0.575	2.39	417.65 (msl)	0.61	0.193	1.252	0.445	0.125	3.202	3.206				
10 year Discharge (cfs)	1.128	4.63	418.13 (msl)	1.29	0.396	2.571	0.913	0.255	6.553	6.591				
25 year Discharge (cfs)	1.622	6.54	418.46 (msl)	2.02	0.604	3.924	1.394	0.389	9.954	10.059				
100 year Discharge (cfs)	2.554	10.02	418.99 (msl)	3.76	1.028	6.675	2.374	0.664	17.056	17.096				

PROPOSED POND A								
Elevation	Area	Area (sf)	Volume	Volume	Cumulative			
(ft)	(acres)	Area (SI)	(acre-ft)	(cf)	Volume (cf)			
416.00	0	0	0	0	0			
417.00	0.030	1,307	0.010	436	436			
418.00	0.041	1,786	0.035	1,525	1,960			
419.00	0.055	2,396	0.048	2,091	4,051			
420.00	0.070	3,049	0.062	2,701	6,752			
421.00	0.087	3,777	0.078	3,398	10,149			



TEXAS ONE CALL SYSTEM
1-800-245-4545

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CAUTION - ELECTRICITY PRESENT

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NO.	REVISION	DATE	
			GTATE OF TA
			PAUL J. VIKTORIN
			66879
			O SSONAL ENGINE
			01-17-2023




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CENTRAL TEXAS
205 Cimarron Park Loop, Ste. B, Buda TX 78 P: 512.312.4336


IF THIS BAR DOES NOT MEASURE 1", THE DRAWING IS NOT TO SCALE	PROPOSED DRAINAGE AREA MAP	
DRAWN BY: P.S. CHECKED BY: G.H.	AUTO REPAIR SHOP SITE PLAN ADDRESS, CITY, TEXAS, ZIP	

PROJECT NO1062-001	_
DRAWING NO	
SHEET 3 OF 3	_

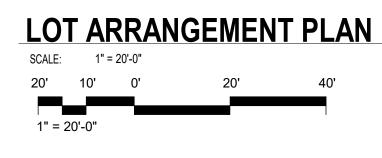

EXISTING UTILITY

EASEMENT

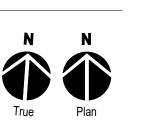


DRIVEWAY BUILT IN DEDICATED R.O.W.

60' - 0" BUILD-TO-LINE

PER ARTICLE 6.4 OF B3 CODE PER 6.5.003 OF B3 CODE FOR LOTS > 1/2 ACRE

20' - 0" SECOND LAYER

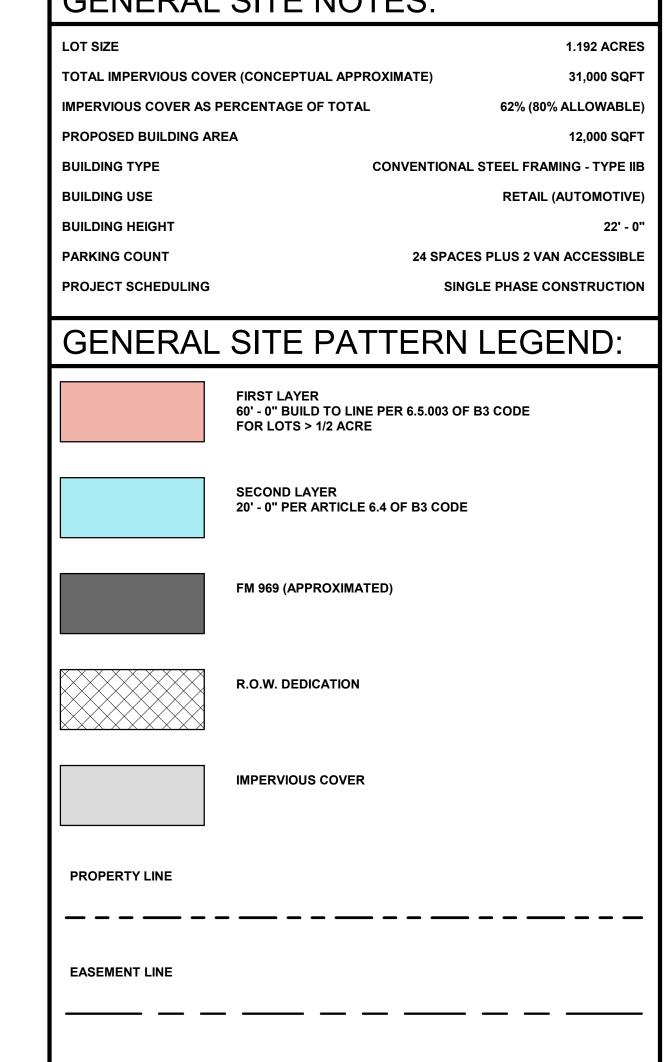

GENERAL SITE NOTES:


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PROPOSED DEVELOPMENT **SCHEME**



OFF PROPERTY TREE TO BE PRESERVED

OFF PROPERTY
TREE TO BE
PRESERVED

OFF PROPERTY TREE TO BE PRESERVED

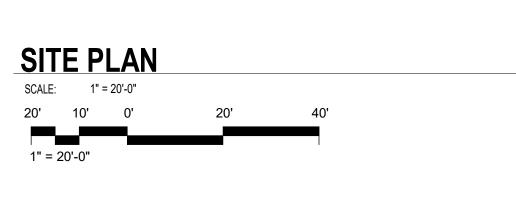OFF PROPERTY
TREE TO BE
PRESERVED

TREE TO BE PRESERVED


RETAINING WALL

TREE TO BE PRESERVED

TREE TO BE PRESERVED

TREE TO BE PRESERVED

+ RENTENTION

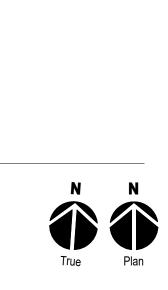

SHADE TREES - REF TABLE 2.1.003 PREFERRED PLANT

LIST B3 TECH MANUAL -MIN 8' CLR TO CANOPY AT MATURITY PER SEC 7.3.014 OF B3 CODE

GENERAL SITE NOTES:

TREES AT LAYERS 1 & 2 TO BE PRESERVED. EXISTING TREES ON SOUTH BORDER OF LOT TO SCREEN PARKING THAT IS NOT OTHERWISE OBSCURED FROM VIEW BY BUILDING. PUBLIC FRONTAGE TO INCLUDE 8' - 12' SIDEWALK, 1' 9" LIGHTWELL, AND 4' TREEWELL SWIFT TOPOGRAPHY OF THE SITE WILL REQUIRE THE USE OF RETAINING WALLS TO TERRACE THE LOT.

GENERAL SITE PATTERN LEGEND:

+ + + +

MIXED PERENNIAL SHRUB AND WETLAND PLANTING

DROUGHT RESISTANT NATIVE GRASS AND WILDFLOWER SEEDING



revision

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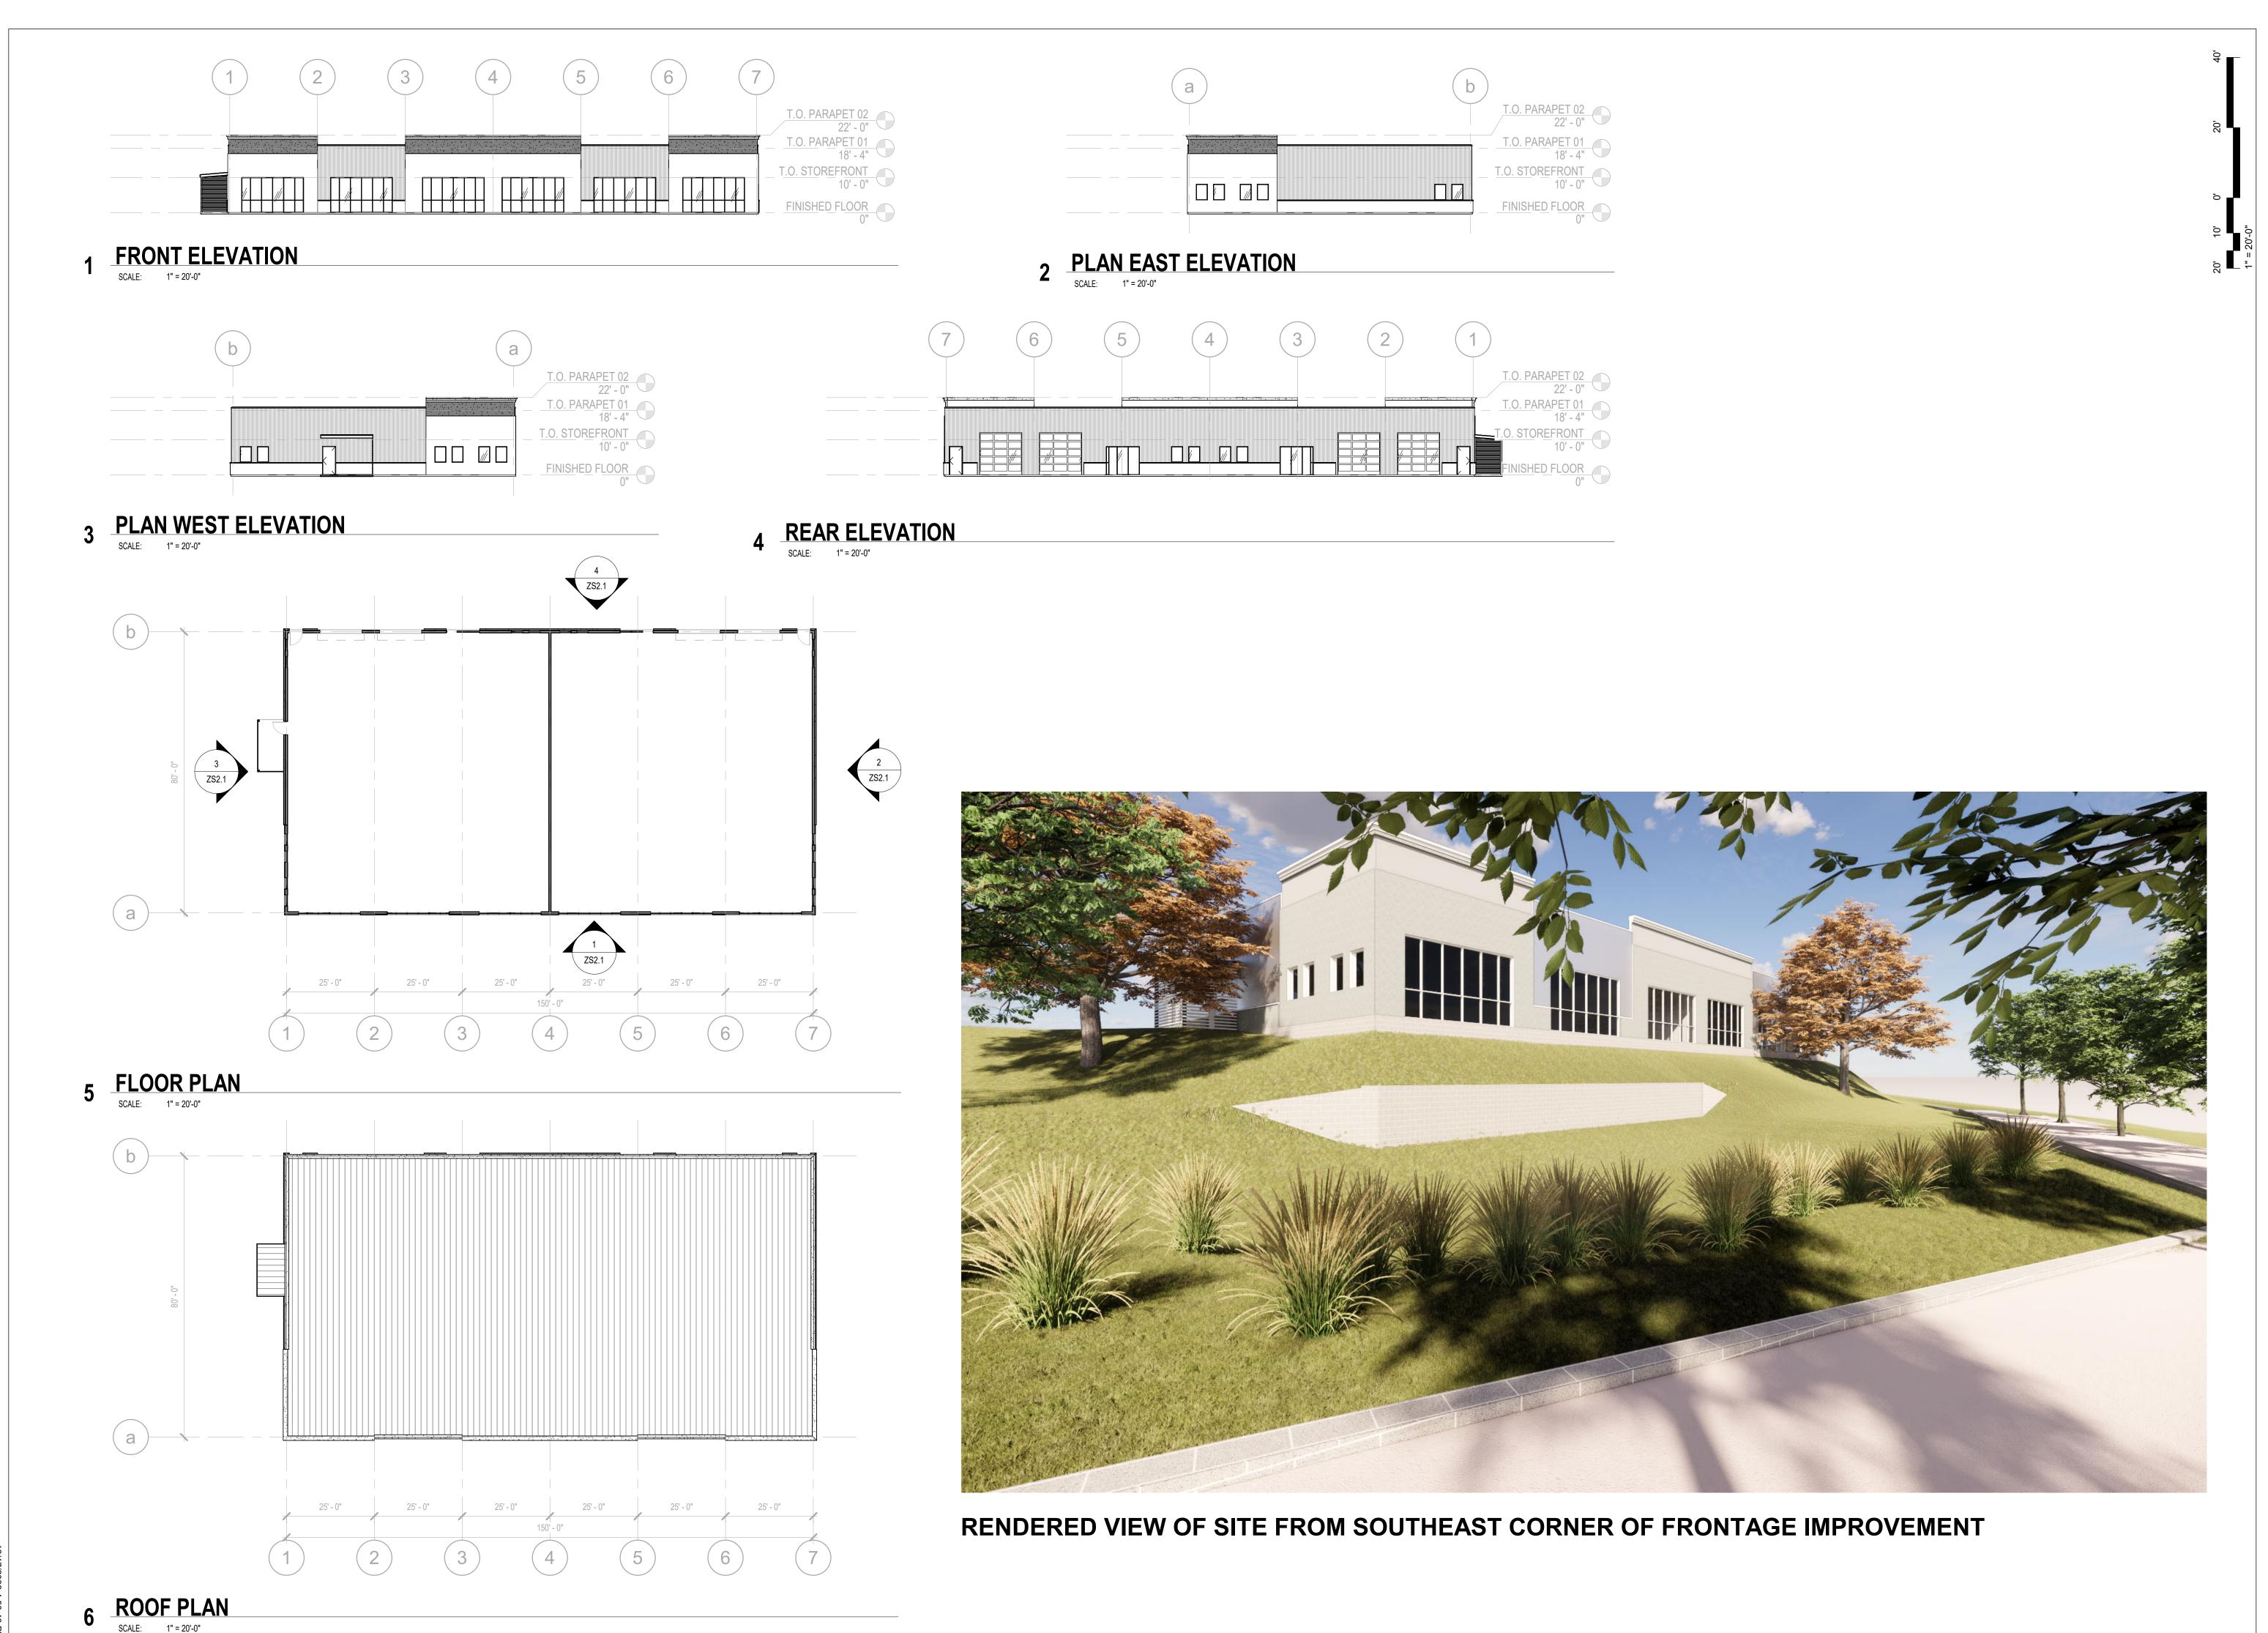
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