

**SITE PLAN DEMOLITION NOTES:**

- CONTRACTOR IS RESPONSIBLE FOR ALL DEMOLITION. HISTORICAL BRICKS ARE NOT TO BE DAMAGED. COORDINATE DEMOLITION WITH OWNER.
- DEMOLISH ALL UNUSED ELECTRICAL BOXES.
- TRACE CIRCUITS IN FIELD FROM EXISTING PANELS AND CONTACTOR BOXES. COORDINATE WITH OWNER WHICH EXISTING CIRCUITS ARE TO BE DEMOLISHED AND WHICH ARE TO REMAIN IN PANELS.

**SITE PLAN CONSTRUCTION NOTES:**

- ALL LOCATIONS ON DRAWINGS ARE APPROXIMATE. COORDINATE EXACT LOCATIONS WITH OWNER.
- COORDINATE EXACT LOCATIONS OF BOLLARDS AND RECEPTACLES WITH OWNER.
- COORDINATE ROUTING OF CONDUIT WITH OWNER.
- VERIFY THAT ALL PANELS IN ELECTRICAL ROOM ARE GROUNDED PROPERLY.
- ALL HISTORICAL BRICKS MUST BE SAVED.
- CONTRACTOR IS TO RESTORE ANY DISTURBED LANDSCAPING AND BRICKWORK TO ITS ORIGINAL CONDITION AFTER CONSTRUCTION.

**SITE PLAN KEYED NOTES:**

- INDICATED PANEL LOCATION IS APPROXIMATE, COORDINATE EXACT LOCATION WITH OWNER.
- DEMOLISH EXISTING FIXTURE AND ELECTRICAL IN THIS LOCATION.
- DEMOLISH EXISTING RV BOX AT THIS LOCATION.
- CONNECT BOLLARD LIGHTS USING 2 #10 AWG, #10 GND AND A 20A BREAKER TO CIRCUIT A-12. PROVIDE PHOTOCELL AND TIME CLOCK TO CONTROL LIGHTING.
- CONNECT BOLLARD LIGHTS USING 2 #10 AWG, #10 GND AND A 20A BREAKER TO CIRCUIT A-14. PROVIDE PHOTOCELL AND TIME CLOCK TO CONTROL LIGHTING.
- CONNECT BOLLARD LIGHTS USING 2 #10 AWG, #10 GND AND A 20A BREAKER TO CIRCUIT A-16. PROVIDE PHOTOCELL AND TIME CLOCK TO CONTROL LIGHTING.
- CONNECT BOLLARD LIGHTS USING 2 #10 AWG, #10 GND AND A 20A BREAKER TO CIRCUIT A-18. PROVIDE PHOTOCELL AND TIME CLOCK TO CONTROL LIGHTING.
- CONNECT BOLLARD LIGHTING TO ADJACENT LIGHTING CIRCUIT USING 2 #10 AWG, #10 GND.
- FIELD EVALUATE EXISTING WIRE AND REUSE IF POSSIBLE.


**ELECTRICAL PANELS CONSTRUCTION NOTES:**

- PROVIDE NEW DISCONNECT FOR PANEL "B". COORDINATE LOCATION OF DISCONNECT WITH OWNER.
- COORDINATE WITH OWNER AND MOVE ALL CIRCUITS/LOADS REQUIRING CONTINUOUS OPERATION TO PANEL "A".
- PANEL/CIRCUIT SCHEDULING AND PLACEMENT CAN BE ADJUSTED AS NECESSARY.


SPECIAL OUTLET SCHEDULE	
ID	DESCRIPTION
1	AUGUSTA LED BOLLARD WITH QTY TWO (2) GROUND FAULT INTERRUPTER TYPE RECEPTACLES. STERNBERG PART NUMBER 5201LED-4671L40TS-MDL072-GFI-LPIUC/BK. PROVIDE TWO (2) GFCI RECEPTACLES. PROVIDE FOR A COMPLETE INSTALLATION.
2	CHRISTMAS TREE POWER. PROVIDE AND INSTALL WATERPROOF INGROUND QUADRAPLEX RECEPTACLE. LEGRAND MODEL # XB814C520BK. PROVIDE LOCKABLE RV STYLE 50/30/20 PEDESTAL. COORDINATE EXACT TYPES AND LOCATIONS WITH OWNER. MOUNT AGAINST WALL. PROVIDE FOR A COMPLETE INSTALLATION.
3	STAGE POWER STAND. PROVIDE LARGE WEATHERPROOF GREEN ELECTRICAL FREE STANDING ENCLOSURE TO CONCEAL CONTRACTOR PROVIDED 100A 3 PHASE DISCONNECTS QTY 2. PROVIDE SEPARATE CIRCUIT FOR EACH DISCONNECT. PROVIDE COMPATIBLE FLUSH MOUNT PLUG ON SIDE OF BOX FOR STAGE POWER. COORDINATE EXACT TYPES AND LOCATIONS WITH OWNER. PROVIDE FOR A COMPLETE INSTALLATION.
4	AUGUSTA BOLLARD (WITHOUT LED LIGHT) WITH QTY TWO (2) GROUND FAULT INTERRUPTER TYPE RECEPTACLES. STERNBERG PART NUMBER 5201B-4672-GFI-LPIUC/BK. PROVIDE TWO (2) GFCI RECEPTACLES. PROVIDE FOR A COMPLETE INSTALLATION.
5	SPECIAL OUTLET SCHEDULE NOTES: PROVIDE LOCAL DISCONNECTING FOR DEVICES WITHOUT RECEPTACLE. COORDINATE WITH MOCP.

LIGHTING FIXTURE SCHEDULE							
ID	MANUF.	MODEL NUMBER	VOLT.	WATTS	LAMP TYPE	MOUNTING	REMARKS
C	LIGMAN	UFRE-10021 2X12W LED W35 BY OWNER 120/277V	120/277	24	LED	BOLLARD	BOLLARD LIGHT. AIM LIGHTING AT STATUE. MANUFACTURER TO PROVIDE CHAIN CONNECTIONS. CONTRACTOR TO PROVIDE APPROVED CHAIN BETWEEN BOLLARDS. COORDINATE ROTATION OF BASE PLATE AND STUDS WITH MANUFACTURER.


LIGHTING FIXTURE SCHEDULE NOTES:  
COORDINATE ALL FINISH OPTIONS WITH ARCHITECT.

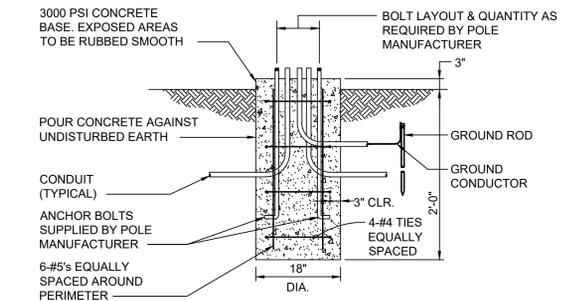

2 TYPICAL - BOLLARD MOUNTING DETAIL  
ES100 NOT TO SCALE

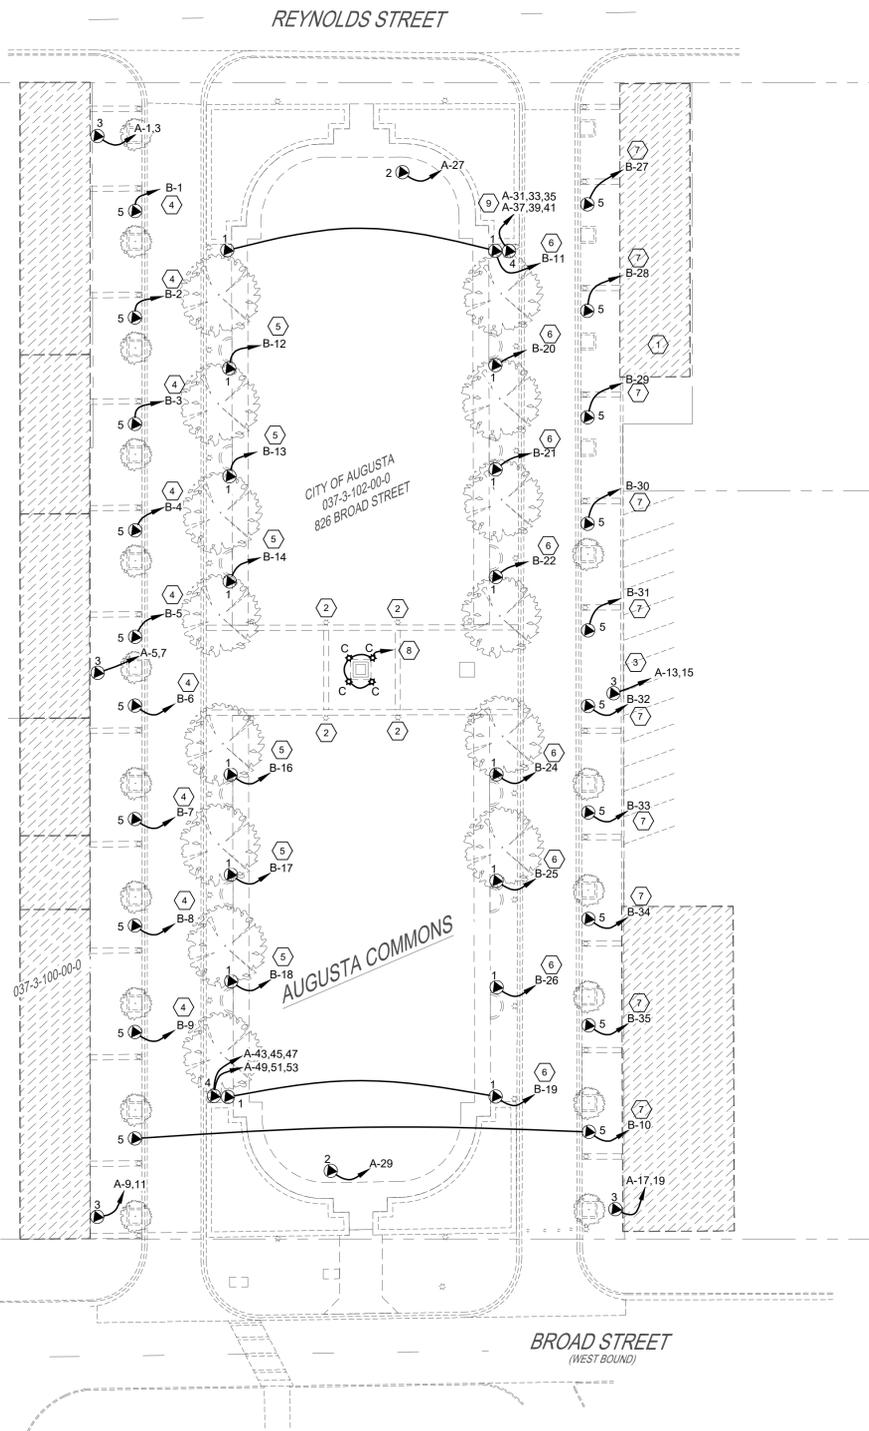

1 ELECTRICAL SITE PLAN  
ES100 SCALE: 1/32" = 1'-0"

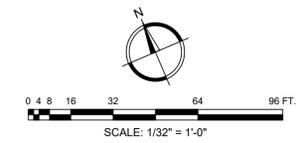

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CLIENT: AUGUSTA - RICHMOND COUNTY CENTRAL SERVICES DEPARTMENT  
PROJECT NAME: AUGUSTA COMMONS ELECTRICAL IMPROVEMENTS  
PROJECT LOCATION: 836 REYNOLDS ST., AUGUSTA, GA 30901

REV	DATE	BY	DESCRIPTION
C	11/26/24	CEB	ISSUED FOR VE CHANGES
B	08/06/24	HIW	ISSUED FOR CONSTRUCTION
A	07/01/24	HIW	ISSUED FOR 60% OWNER REVIEW

PROJECT NO.	3042.2405
DRAWN BY:	CEB
CHECKED BY:	CEB
DATE:	06/28/2023
SHEET TITLE:	
<b>ELECTRICAL SITE PLAN</b>	

SCALE: AS NOTED  
DRAWING NO. **ES100** REV. **C**