THE ENCLOSED INFORMATION IS INTENDED TO ASSIST AND INFORM YOU THROUGH THE CONSTRUCTION OF YOUR HOME. YOUR CONSTRUCTION PLANS HAVE BEEN DRAWN TO PRESCRIBE TO INDUSTRY STANDARDS. THESE PROFESSIONAL STANDARDS DETERMINE HOW CONSTRUCTION PLANS ARE DRAWN AND WHAT INFORMATION THEY INCLUDE. CONSTRUCTION PLANS ARE INTENDED AS A TECHNICAL GUIDE TO PROFESSIONAL CONTRACTORS AND ARE NOT INTENDED TO BE A SET OF STEP-BY-STEP INSTRUCTIONS. THEREFORE, IF YOU ARE PLANNING TO BUILD YOUR HOME WITHOUT THE SERVICE OF A PROFESSIONAL BUILDER WE SUGGEST THAT YOU BECOME THOROUGHLY FAMILIAR WITH READING CONSTRUCTION PLANS OR CONSIDER CONSULTING A CONSTRUCTION SPECIALIST. GREAT CARE AND EFFORT GOES INTO THE DESIGN AND CREATION OF THE CONSTRUCTION PLANS; HOWEVER, BECAUSE OF THE IMPOSSIBILITY OF PROVIDING ANY PERSONAL AND/OR

"ON-SITE" CONSULTATION, SUPERVISION AND CONTROL OVER THE ACTUAL CONSTRUCTION, AND BECAUSE OF THE GREAT VARIANCES IN LOCAL BUILDING CODE REQUIREMENTS AND OTHER GEOGRAPHIC LOCATION AND WEATHER CONDITIONS, HOUSE PLAN ZONE, LLC. NOR THE AGENTS OR EMPLOYEES ASSUMES NO RESPONSIBILITY FOR ANY DAMAGES INCLUDING BUT NOT LIMITED TO, ANY DEFICIENCIES, OMISSIONS, OR ERRORS IN THE DESIGN. IN ANY CASE, ANY DISCREPANCIES, ERRORS, AND/OR OMISSIONS IN THE DIMENSIONS, AND/OR DRAWINGS CONTAINED IN THE CONSTRUCTION PLANS SHALL BE BROUGHT TO THE ATTENTION OF HOUSE PLAN ZONE, LLC. PRIOR TO COMMENCEMENT OF CONSTRUCTION. PROCEEDING WITH CONSTRUCTION CONSTITUTES THE ACCEPTANCE OF THE CONSTRUCTION DOCUMENTS 'AS IS' AND ANY DISCREPANCIES. ERRORS, AND/OR OMISSIONS BECOME THE SOLE RESPONSIBILITY OF THE PURCHASER. IF ANY ERRORS ARE DISCOVERED PRIOR TO CONSTRUCTION HOUSE PLAN ZONE, LLC. WILL BE GIVEN FULL OPPORTUNITY TO CORRECT ANY ERRORS AND/OR OMISSIONS TO THE CONSTRUCTION PLANS. IN ANY OR ALL CIRCUMSTANCES, THE MAXIMUM FINANCIAL LIABILITY TO HOUSE PLAN ZONE, LLC. CAN NOT EXCEED THE TOTAL PLAN PURCHASE.

PROFESSIONAL SEAL/ ADDITIONAL DRAWINGS

THOUGH EVERY EFFORT WAS MADE TO MAKE THE CONSTRUCTION DOCUMENTS FOLLOW THE I.R.C. NATIONAL CODE METHODOLOGIES, A FEW STATES AND CITIES HAVE PASSED BI-LAWS REGARDING CONSTRUCTION PLANS THAT WOULD BE SUBMITTED TO YOUR LOCAL MUNICIPALITY AND USED FOR THE CONSTRUCTION OF YOUR HOME. THESE BI-LAWS REQUIRE THE CONSTRUCTION PLANS TO BE REVIEWED AND/OR PREPARED, INSPECTED, AND SEALED (OR STAMPED) BY A LICENSED ARCHITECT, ENGINEER IN YOUR STATE. IT IS ADVISED THAT YOU CONTACT YOUR MUNICIPALITY'S BUILDING DEPARTMENT FOR INSTRUCTIONS TO COMPLY WITH THEIR CONSTRUCTION PLANS REVIEW PROCESS. FURTHERMORE, ADDITIONAL ITEMS SUCH AS STRUCTURAL, HVAC, PLUMBING, SITE, ENERGY EFFICIENCY DOCUMENTATION, ETC. MAY BE REQUIRED AND THESE SHALL BE PROVIDED BY A LOCAL PROFESSIONAL THAT IS FAMILIAR WITH THE REQUIREMENTS AND THESE SHALL BE PROVIDED AT THE OWNERS EXPENSE.

OTHER IMPORTANT INFORMATION

MATERIALS LIST DISCLAIMER - IF A MATERIALS LIST WAS ORDERED, IT WILL ONLY CONFORM TO THE PLAN IN ITS ORIGINAL FORMAT. ADDITIONAL OPTIONS SUCH AS 2X6 EXTERIOR WALLS, BASEMENT, OR WALKOUT BASEMENT FOUNDATIONS, THREE CAR GARAGE VERSIONS, ETC. WILL NOT BE REFLECTED IN THE LIST. WHILE IT WILL NOT MATCH THESE OPTIONS, THE LIST IS STILL A GREAT REFERENCE DOCUMENT FOR THE MATERIALS THAT WILL BE REQUIRED TO CONSTRUCT YOUR HOME **FOUNDATIONS - MOST OF OUR FOUNDATIONS ARE DESIGNED WITH** CONCRETE BLOCK STEM WALLS AND NOT POURED-IN-PLACE CONCRETE. ADDITIONALLY, THE MAJORITY OF OUR SLAB FOUNDATIONS ARE DESIGNED WITH A CHAIN WALL (RAISED) SLAB AND NOT MONOLITHIC (SLAB ON GRADE). CONTRACTOR/ LOCAL ENGINEER SHALL ADJUST DESIGN AS NEEDED FOR YOUR SPECIFIC AREA/ NEED. SQUARE FOOTAGES - BONUS ROOMS (WHERE APPLICABLE) ARE NOT INCLUDED IN THE HEATED AREA OF THE DESIGN UNLESS SPECIFICALLY NOTED. GARAGE PLANS ARE EXCLUDED. SQUARE FOOTAGES SHOWN ARE CALCULATED TO THE OUTSIDE OF THE STUD WALL AND DO NOT INCLUDE THE EXTERIOR MATERIALS SUCH AS BRICK, STONE, OR SIDING. **DIMENSIONS - OUR PLANS ARE DIMENSIONED TO THE OUTSIDE OF THE** STUD WALL ONLY AND NOT TO THE OUTSIDE OF THE BRICK LEDGE (WHERE APPLICABLE).

REPRODUCTION OF THESE CONSTRUCTION PLANS, EITHER IN WHOLE OR IN PART, INCLUDING ANY FORM COPYING AND/OR PREPARATION OF A DERIVATIVE WORKS THEREOF, FOR ANY REASON IS STRICTLY PROHIBITED THE PURCHASE OF A SET OF CONSTRUCTION PLANS IN NO WAY TRANSFERS ANY COPYRIGHT OR OTHER OWNERSHIP INTEREST IN IT TO THE PURCHASER EXCEPT FOR A LIMITED LICENSING RELEASE TO USE THE SAID PLAN SET FOR CONSTRUCTING ONE AND ONLY ONE DWELLING UNIT. THE PURCHASE OF ADDITIONAL SETS OF THE SAID PLANS AT A REDUCED PRICE FROM THE ORIGINAL SET OR AS PART OF A MULTIPLE SET PACKAGI DOES NOT CONVEY TO THE PURCHASER A LICENCE TO CONSTRUCT MORE THAN ONE DWELLING. SIMILARLY, THE PURCHASE OF REPRODUCIBLE CONSTRUCTION PLANS (A.K.A. SEPIAS, MYLARS, OR VELLUMS) CARRIES THE SAME COPYRIGHT PROTECTION AS MENTIONED ABOVE. IT IS GENERALLY A SINGLE DWELLING ONLY. TO USE ANY PLAN MORE THAN ONCE, AND TO AVOID ANY COPYRIGHT/ LICENSE INFRINGMENT, IT IS NECESSARY TO CONTACT THE ORIGINAL DESIGNER TO RECEIVE A LICENSE FOR ANY EXTENDED USAGE. WHEREAS A PURCHASER OF REPRODUCIBLE'S IS GRANTED A LICENSE TO MAKE COPIES. IT SHOULD BE NOTED THAT AS COPYRIGHTED MATERIALS, MAKING PHOTOCOPIES FROM CONSTRUCTION PLANS IS ILLEGAL. COPYRIGHT AND LICENSEE OF CONSTRUCTION PLANS EXISTS TO PROTECT ALL PARTIES. IT RESPECTS AND SUPPORTS THE INTELLECTUAL PROPERTY OF THE ORIGINAL ARCHITECT AND/OR DESIGNER. THEREBY KEEPING IT POSSIBLE TO OFFER PRE-DRAWN PLANS AT AFFORDABLE PRICES. COPYRIGHT LAW FOR PRE-DRAWN CONSTRUCTION PLANS IS NOW BEING VIGOROUSLY ENFORCED. COPYRIGHT INFRINGEMENT COULD LEAD TO FINES OF UP TO \$100,000 PER VIOLATION.

GENERAL SITE NOTES

CONTRACTOR TO VERIFY LOCATIONS OF SITE UTILITIES REQUIREMENTS, AND CONNECTIONS FEES. OWNER, CONTRACTOR AND SUB-CONTACTORS TO PAY ALL OF THEIR RELATED CONSTRUCTION PERMIT FEES AS AGREED UPON BETWEEN THE OWNER AND CONTRACTOR. 2. BEFORE EXCAVATION, THE CONTRACTOR SHALL EXAMINE ALL DRAWINGS, MAPS, AND BUILDING SITE TO DETERMINE THE ROUTES OF ALL UNDERGROUND UTILITIES.

BEFORE DIGGING COMMENCES IT IS ADVISED THAT THE OWNER AND OR CONTRACTOR CALL THEIR STATES UTILITY LOCATOR FACILITATOR. 3. IT IS RECOMMENDED THAT THE SITES SOIL BE TESTED FOR COMPRESSION RATING TO DETERMINE FOUNDATION AND FOOTING DESIGN. CONCRETE FOUNDATIONS AND FOOTING DESIGN SHALL BE IN ACCORDANCE TO CHAPTER 4 OF THE I.R.C. CODE. FOUNDATION DESIGN TO BE VERFIED BY A LOCAL PROFESSIONAL OR ENGINEER. CONSULT A LOCAL CIVIL ENGINEER FOR SITE PLANS AND SURVEYS OF EXISTING PROPERTY. A LANDSCAPE ARCHITECT SHOULD BE CONSULTED FOR MORE EXTENSIVE LANDSCAPE DESIGNS.

HLADKY - COX HOUSE PLANS

LOT #9



PLAN #: 2216-5

FOUNDATION TYPE: BASEMENT EXTERIOR MALL SIZE: 2×4 EXT. MALLS

HLADKY MODIFICATION #2 LIC. NO. - 737-025

SHEET INDEX:

- Cover Sheet
- Floor Plan
- **Exterior Views**

Exterior Views

- Misc. Detailing
- Roof Plan Architectural
- Section View & Cabs
- Electrical Plan

Structural Plans

- S0.1 Structural General Notes
- S1.1 Foundation Plan
- S1.2 Floor Framing Plan
- S1.3 Roof Framing Plan
- S2.1 Foundation Sections
- S2.2 Roof Framing Sections

DESIGN DATA

MINIMUM SOIL BEARING CAPACITY = 2000 P.S.F. FOR GROUP II CONCRETE MINIMUM (28 DAYS) fc:

STANDARD ABBREVIATIONS

MANUF. MANUFACTURER

MASONRY

MAXIMUM

MINIMUM

N.I.C. NOT IN CONTRACT

ON CENTER

ORIENTED STRAND BOARD

POUNDS PER SQUARE INCH

OWNER TO SELECT

OWNER TO SELECT

OPTIONAL

PANTRY

PLATE

PLATE

POLY. POLYETHYLENE

PRE-FAB PREFABRICATED

REFRIGERATOR

REINFORCED

RESISTANCE

RETURN AIR R.A.G. RETURN AIR GRILLE

SIMPSON STRONG TIE

SOUTHERN PINE

SQUARE FOOTAGE

TO BE DETERMINED

PECS. SPECIFICATIONS

THICK THICKNESS

TRANSOM TYPICAL

UTIL. UTILITY

VERT. VERTICAL

VANITY

U.T.C. UNDER THE COUNTER

MATER HEATER

MASHER

MINDOM

WIRE MESH

MEIGHT

MOOD

LY'MD PLYMOOD

PLYM'D PLYMOOD

SHLYS. SHELVES

SHR. SHOWER

SHMR. SHOMER

POUND(S)

BETWEEN

BLOCKING

BOARD

BOARD

CEILING

COLUMNS

CONCRETE

CONDENSOR UNIT

CONNECTION

CONTINUOUS

CRAWL SPACE

DECORATIVE

DIAMETER

DRYER

ELEVATION

ENGINEER

FINISH

FIRE CO

FLOOR

FOOTING

FOUNDATION

GAUGE GALVANIZED

HORIZONTA

INCHES INCLUDE INSULATION

DISHWASHER

DOUGLAS FIR

FINISHED FLOOR LINE

HEATING, VENTILATION &

AIR CONDITIONING

OVER'G COVERING

CONCRETE MASONRY UNIT

APPROX. APPROXIMATELY

FOOTERS = 3000 P.S.I.

SLABS & WALLS = 3000 P.S.I.

REINFORCING STEEL: A.S.T.M. A615-60

ROOF LIVE LOAD (GROUND SNOW LOAD) = 30 P.S.F.

ROOF DEAD LOAD = 10 P.S.F.

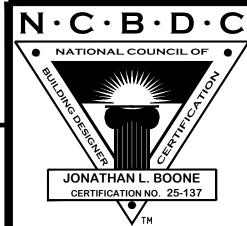
FLOOR LIVE LOAD = 40 P.S.F. 30 P.S.F. SLEEPING AREAS

FLOOR DEAD LOAD = 10 P.S.F.

DECK LIVE LOAD = 40 P.S.F.

DECK DEAD LOAD = 10 P.S.F.

NOTE: ALL REQUIRED BRACE WALL PANELS LOCATED BY CONTRACTOR PER LOCAL CODE REQUIREMENTS.

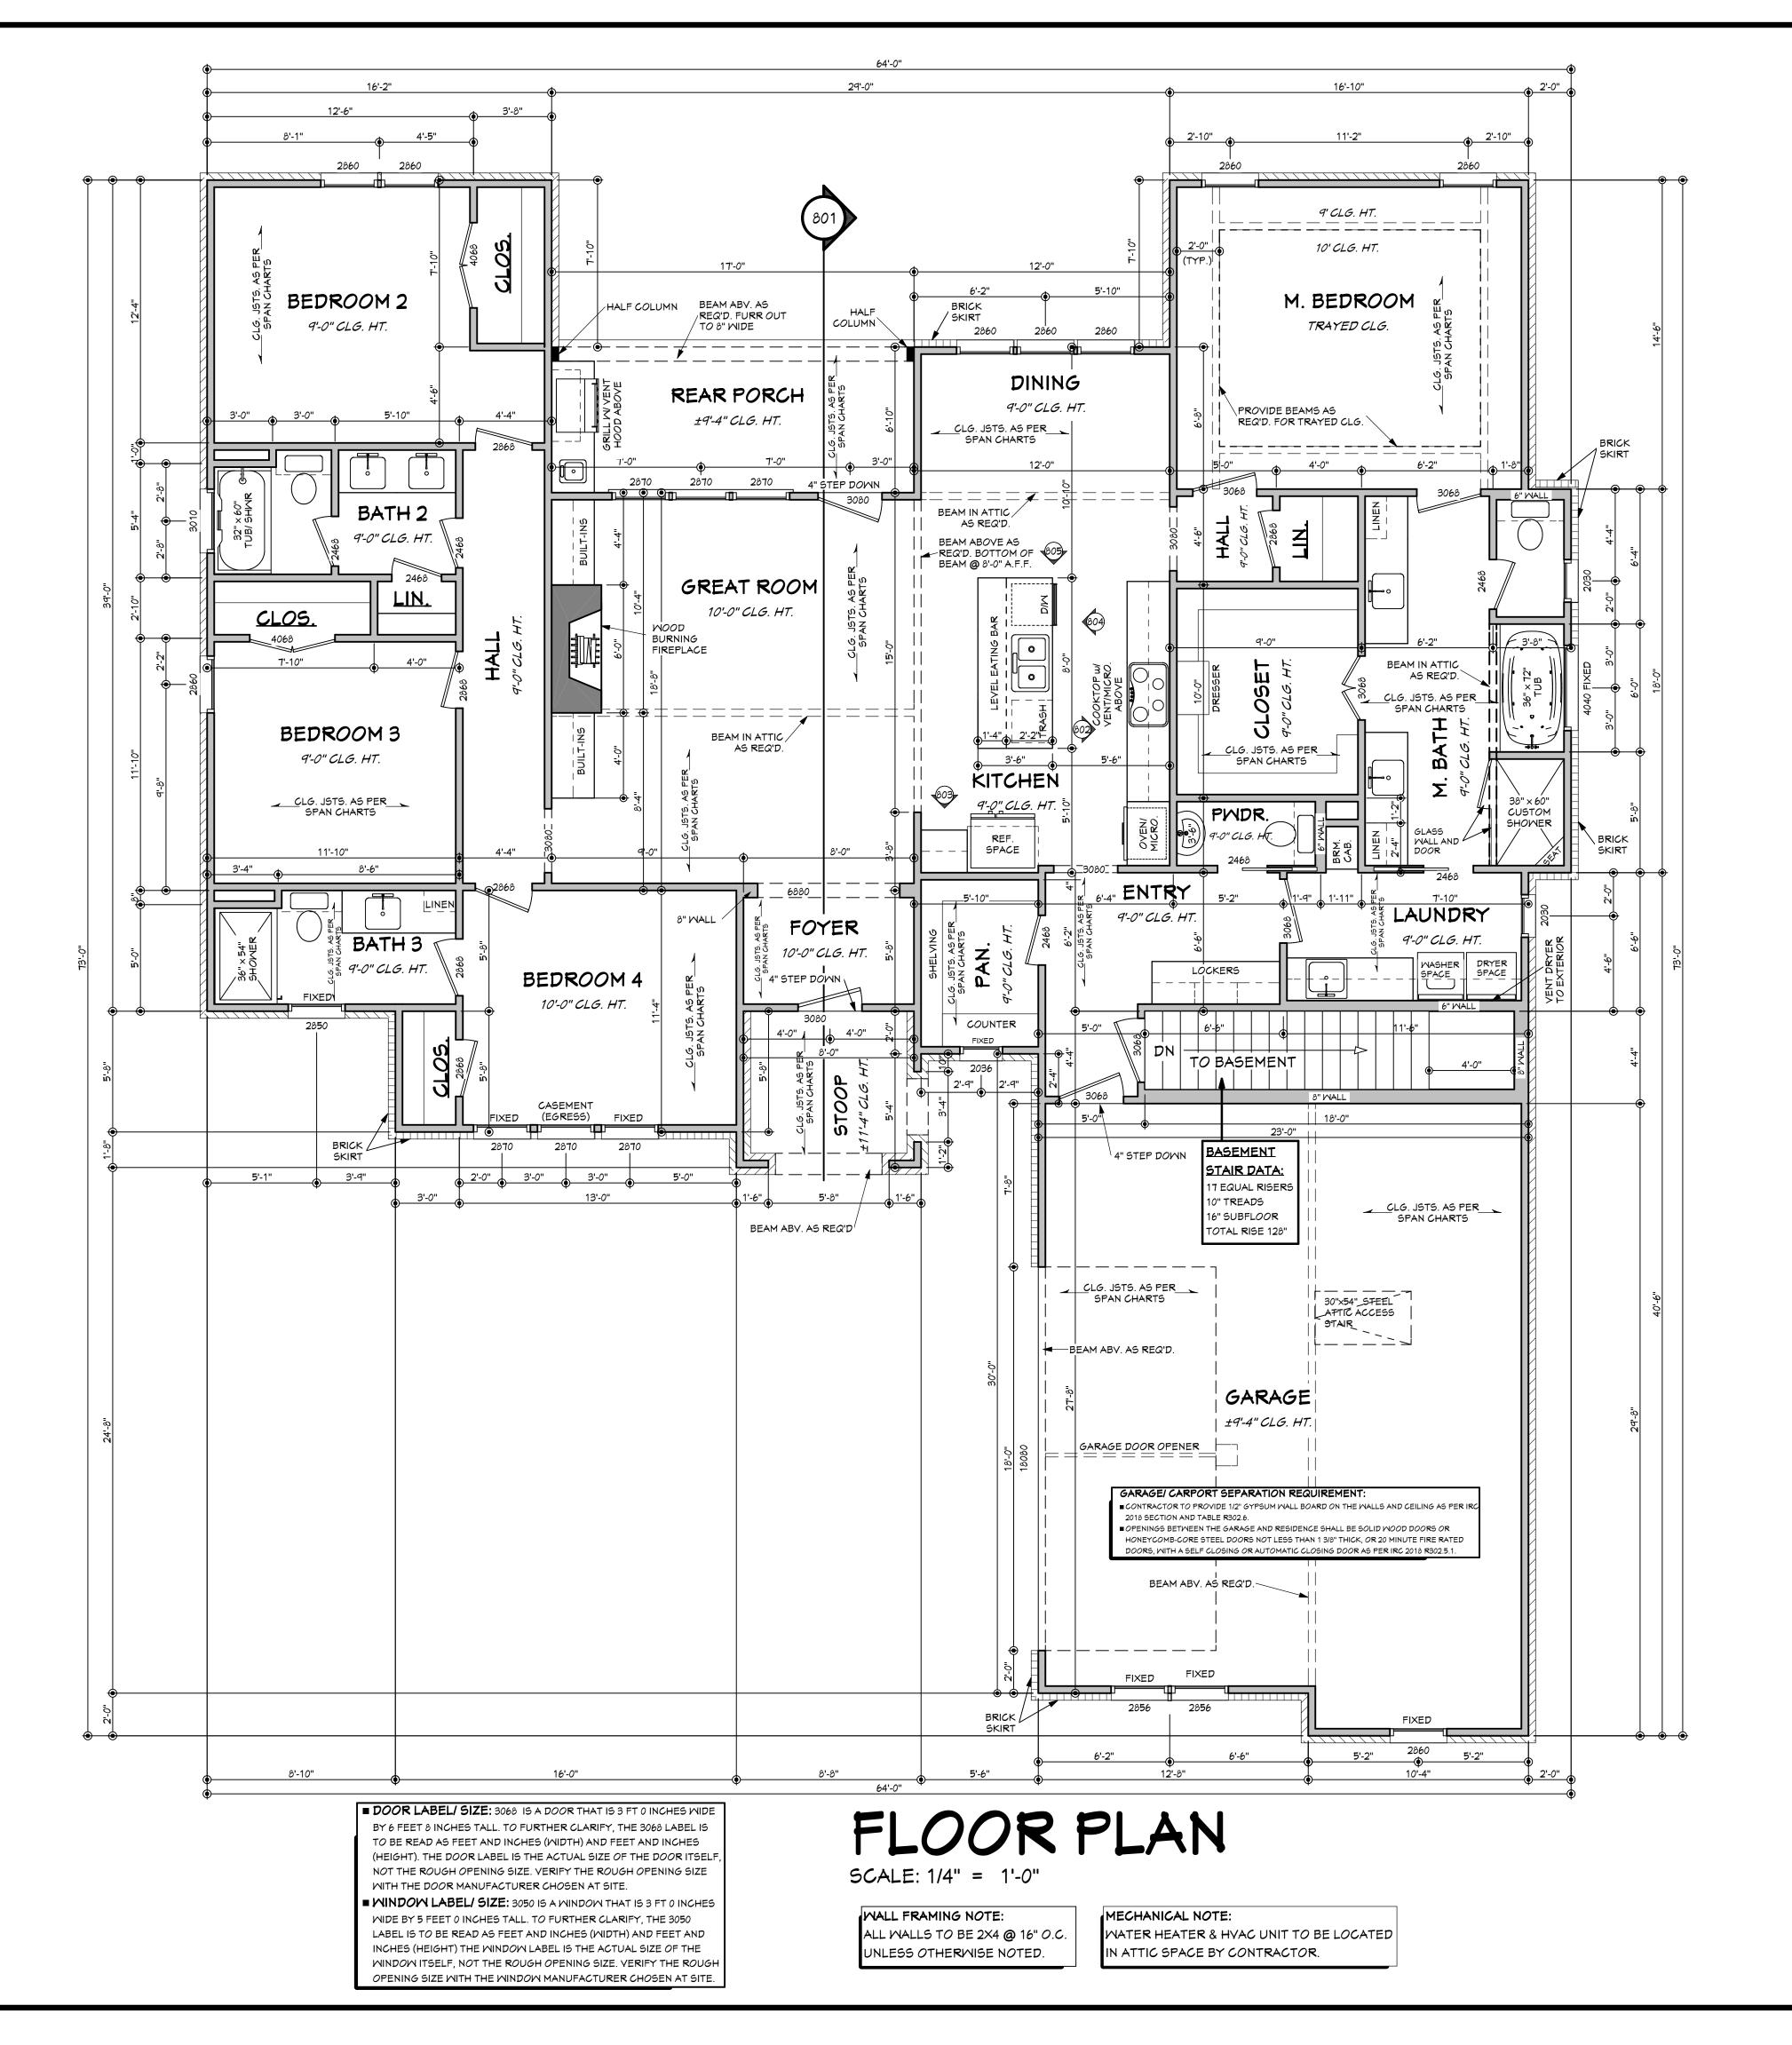


Date:

7.13.21 Drawn By:

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C.A.B.



FLOOR PLAN NOTES: (2018 IRC)

1. ALL BEAMS TO BE SIZED BY A LICENSED STRUCTURAL ENGINEER.

- 1. ALL DIMENSIONS & SITE CONDITIONS TO BE VERIFIED BY CONTRACTOR PRIOR TO CONSTRUCTION
- 2. ALL EXTERIOR DIMENSIONS ARE TO THE OUTSIDE FACE OF THE STUD AND DO NOT INCLUDE EXTERIOR FINISHES SUCH AS SIDING, BRICK, STUCCO, ETC.
- 3. ALL FINISHES (INTERIOR & EXTERIOR) TO BE VERIFIED WITH OWNER PRIOR TO CONSTRUCTION. 4. VERIFY ALL DOOR AND WINDOW STYLES AND SIZES WITH OWNER PRIOR TO CONSTRUCTION. MANUFACTURER TO SUPPLY ALL ROUGH OPENING SIZES.
- 5. CONTRACTOR TO VERIFY ALL CLEARANCES OF ALL DOORS, WINDOWS AND OTHER ITEMS THAT ARE CRITICAL, PRIOR TO CONSTRUCTION.
- 6. CONTRACTOR TO ADAPT PLANS AS REQUIRED TO MEET ALL APPLICABLE CODES AT SITE.
- 8. PORCHES, BALCONIES OR RAISED FLOOR SURFACES LOCATED MORE THAN 30 INCHES ABOVE THE FLOOR OR GRADE BELOW AT ANY POINT WITHIN 36 INCHES HORIZONTALLY SHALL HAVE GUARDS NOT LESS THAN 36 INCHES IN HEIGHT. OPEN SIDES OF STAIRS WITH A TOTAL RISE OF MORE THAN 30 INCHES ABOVE THE FLOOR OR GRADE BELOW SHALL HAVE GUARDS NOT LESS THAN 34 INCHES IN HEIGHT MEASURED VERTICALLY FROM THE NOSING OF THE TREADS. INSECT

SCREENING SHALL NOT BE CONSIDERED AS A GUARD. IRC 2018, R312.1.1 & R312.1.2

- 1. M1305.1.2 APPLIANCES IN ATTICS. ATTICS CONTAINING APPLIANCES SHALL BE PROVIDED WITH AN OPENING AND A CLEAR AND UNOBSTRUCTED PASSAGEMAY LARGE ENOUGH TO ALLOW REMOVAL OF THE LARGEST APPLIANCE, BUT NOT LESS THAN 30 INCHES HIGH AND 22 INCHES WIDE AND NOT MORE THAN 20 FEET LONG MEASURED ALONG THE CENTERLINE OF THE PASSAGEWAY FROM THE OPENING TO THE APPLIANCE. THE PASSAGEWAY SHALL HAVE CONTINUOUS SOLID FLOORING IN ACCORDANCE WITH CHAPTER 5 NOT LESS THAN 24 INCHES WIDE. A LEVEL SERVICE SPACE AT LEAST 30 INCHES DEEP AND 30 INCHES WIDE SHALL BE PRESENT ALONG ALL SIDES OF THE APPLIANCE WHERE ACCESS IS REQUIRED. THE CLEAR ACCESS OPENING DIMENSIONS SHALL BE A MINIMUM OF 20 INCHES BY 30 INCHES, AND LARGE ENOUGH TO ALLOW REMOVAL OF THE LARGEST APPLIANCE. EXCEPTIONS: (A) THE PASSAGEWAY AND LEVEL SERVICE SPACE ARE NOT REQUIRED WHERE THE APPLIANCE CAN BE SERVICED AND REMOVED THROUGH THE REQUIRED OPENING. (B) WHERE THE PASSAGEWAY IS UNOBSTRUCTED AND NOT LESS THAN 6 FEET HIGH AND 22 INCHES WIDE FOR ITS ENTIRE LENGTH, THE PASSAGEWAY SHALL BE NOT MORE THAN 50 FEET LONG.
-). APPLIANCE ACCESS FOR INSPECTION SERVICE, REPAIR AND REPLACEMENT. APPLIANCES SHALL BE ACCESSIBLE FOR INSPECTION, SERVICE, REPAIR AND REPLACEMENT WITHOUT REMOVING PERMANENT CONSTRUCTION, OTHER APPLIANCES, OR ANY OTHER PIPING OR DUCTS NOT CONNECTED TO THE APPLIANCE BEING INSPECTED, SERVICED, REPAIRED OR REPLACED. A LEVEL WORKING SPACE AT LEAST 30 INCHES DEEP AND 30 INCHES WIDE SHALL BE PROVIDED IN FRONT OF THE CONTROL SIDE TO SERVICE AN APPLIANCE. M1305.1.1
- . EMERGENCY ESCAPE AND RESCUE OPENINGS SHALL BE OPERATIONAL FROM THE INSIDE OF THE ROOM WITHOUT THE USE OF KEYS, TOOLS OR SPECIAL KNOWLEDGE. WINDOW OPENING CONTROL DEVICES COMPLYING WITH ASTM F 2090 SHALL BE PERMITTED FOR USE ON WINDOWS SERVING AS A REQUIRED EMERGENCY ESCAPE AND RESCUE OPENING. ALL SLEEPING ROOMS TO HAVE AN EXTERIOR ACCESS THROUGH A DOOR OR WINDOW WITH A MINIMUM OF 5.7 SQUARE FEET NET CLEAR OPENING AS PER IRC 2018 R310.2.1. EXCEPTION: GRADE FLOOR OR BELOW GRADE OPENINGS SHALL HAVE A MINIMUM NET CLEAR OPENING OF 5 SQUARE FEET. MAXIMUM SILL HEIGHT TO BE 44 INCHES. MINIMUM NET CLEAR OPENING HEIGHT TO BE 24 INCHES. MINIMUM NET CLEAR OPENING WIDTH TO BE 20 INCHES.
- 12. ALL RETURN AIR GRILLS ARE TO BE LOCATED TO COMPLY WITH SECTION M1602 OF THE IRC 2018. 13. ALL SQUARE FOOTAGE MEASUREMENTS ARE APPROXIMATE AND MAY DIFFER FROM ACTUAL CONSTRUCTED RESIDENCE OR BUILDING. FOOTAGES SHOWN ARE TO THE OUTSIDE OF THE STUDWALL AND DO NOT INCLUDE THE EXTERIOR FINISH MATERIAL SUCH AS SIDING, BRICK, STONE ETC.
- 14. FIRE SPRINKLER SYSTEM TO BE DESIGNED AND INSTALLED (IF REQUIRED BY LOCAL CODES) AS PER THE IRC 2018 AND BY A LICENSED PROFESSIONAL IN THE AREA OF CONSTRUCTION. 15. ALL BATHROOM EXHAUST VENTS SHALL BE VENTED DIRECTLY TO THE EXTERIOR OF THE HOME

AREAS (FRAME):

2237 S.F. FIRST FLOOR HEATED - INTERIOR NOT INCLUDING PORCH &

2148 S.F. BASEMENT HEATED 657 S.F. GARAGE

61 S.F. STOOP

79 S.F. BASEMENT STAIR

116 S.F. REAR PORCH

5121 S.F. TOTAL WITHIN EXTERIOR WALLS

AND NOT INTO THE ATTIC. IRC 2018, M1505.2

5298 S.F. TOTAL UNDER ROOF

FRAMING SQUARE FOOTAGE CALCULATION NOTES: 1. SQUARE FOOTAGE OF HEATED AREA IS FIGURED TO THE OUTSIDE OF THE STUDWALL OF THE EXTERIOR WALLS (DOES NOT INCLUDE MASONRY OR OTHER EXTERIOR MATERIALS). 2. FIREPLACES THAT PROTRUDE FROM THE EXTERIOR FOOTPRINT ARE NOT INCLUDED IN THE HEATED

3. STAIRWELLS ARE ONLY INCLUDED IN THE FIRST FLOOR CALCULATIONS AND NOT THE SECOND FLOOR CALCULATIONS (IF APPLICABLE).

Mebsite: www.HPZplans.com

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> Phone: 601.336.3254

Fax: 1.800.574.1387



Date: 7.13.21

C.A.B.

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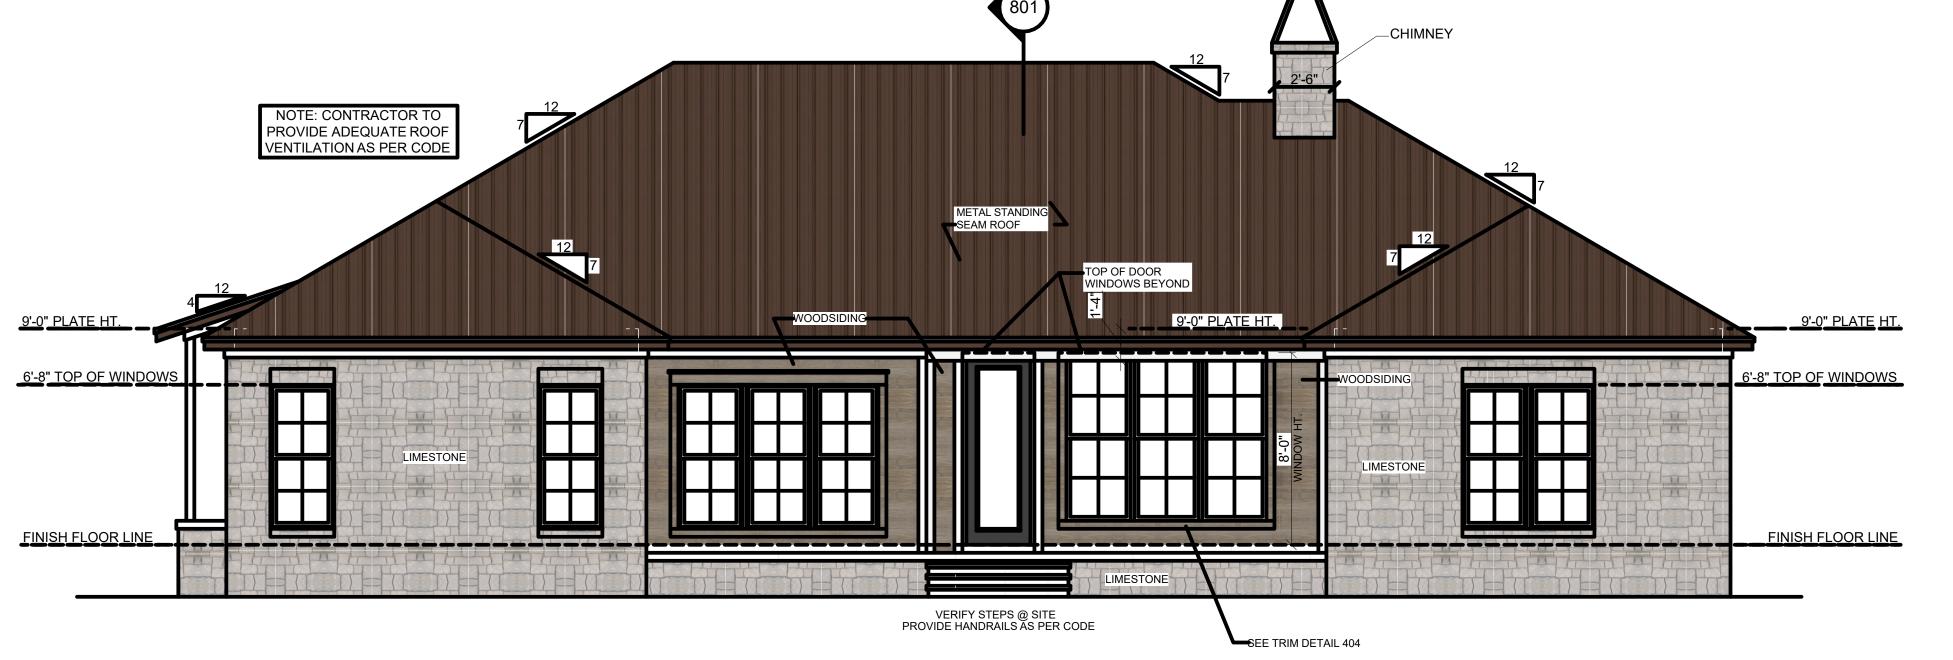


OUTER & INNER EDGE OF BEAM SHALL LINE UP WITH OUTER SHAFT OF COLUMN AS SHOWN. FUR BEAM AS REQ'D TO LINE UP WITH SHAFT OF COLUMN. INCORRECT INCORRECT

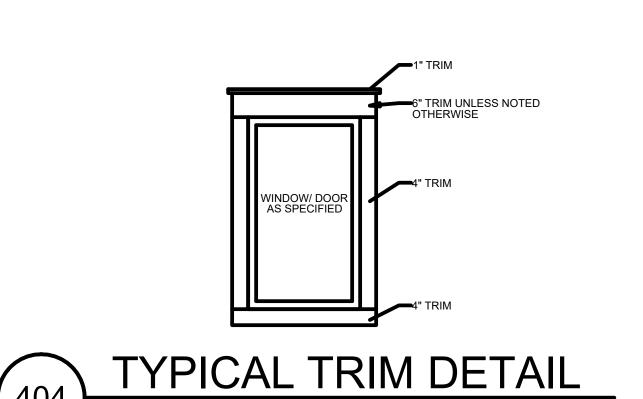
COLUMN/ BEAM LOCATIONS SCALE-------N.T.S.

EXTERIOR ELEVATION NOTES:

- 1. CONTRACTOR TO VERIFY ALL WINDOW AND DOOR STYLES AND SIZES WITH OWNER PRIOR TO CONSTRUCTION.
- 2. PROVIDE STEPS AND GUARD RAILS AS PER CODE BASED ON SITE CONDITIONS.
- 3. GROUND LINES SHOWN FOR REFERENCE ONLY AND VARY DEPENDING ON SITE CONDITIONS.
- 4. ALL FINISH MATERIALS TO BE VERIFIED WITH OWNER PRIOR TO CONSTRUCTION.
- 5. REFER TO TYPICAL WALL DETAIL FOR FRAMING METHODS AND OTHER MISC. INFORMATION.
- 6. CONTRACTOR TO PROVIDE ADEQUATE ROOF VENTILATION AS REQ'D BY CURRENT CODES.







Pre-Drawn Plan ID: 2216-S

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N·C·B·D·C

● NATIONAL COUNCIL OF ●

JONATHAN L. BOONE
CERTIFICATION NO. 25-137

House Plan Zone, LLC. has exercised great care and documents. However, due to the great variance in buresponsibility for any damages, including structural far House Plan Zone, LLC. highly recommends that these in addition to your local building officials prior to construct and the published by local building conditions required by local building conditions and the conditions required by local building conditions and the conditions are conditions and conditions and conditions are conditions and conditions and conditions are conditions are conditions and conditions are conditions and conditions are conditions and conditions are conditions are conditions and conditions are conditions are conditions are conditions and conditions are conditions and conditions are conditions.

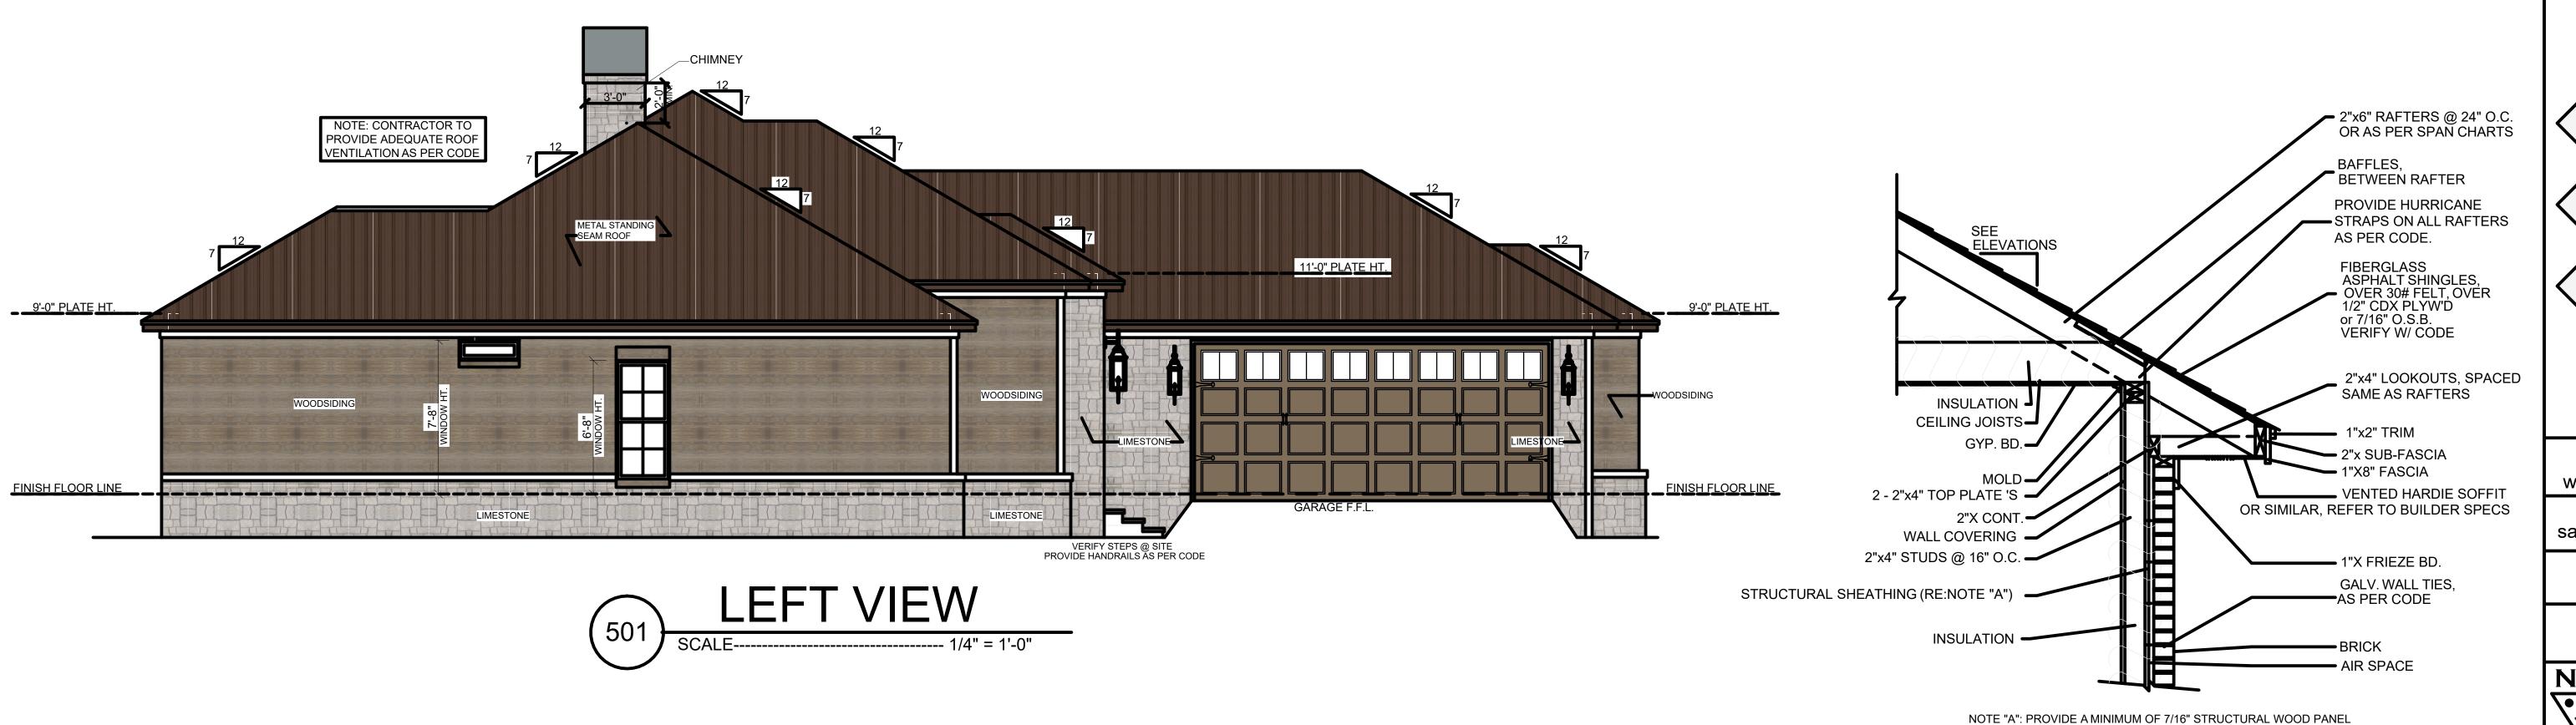
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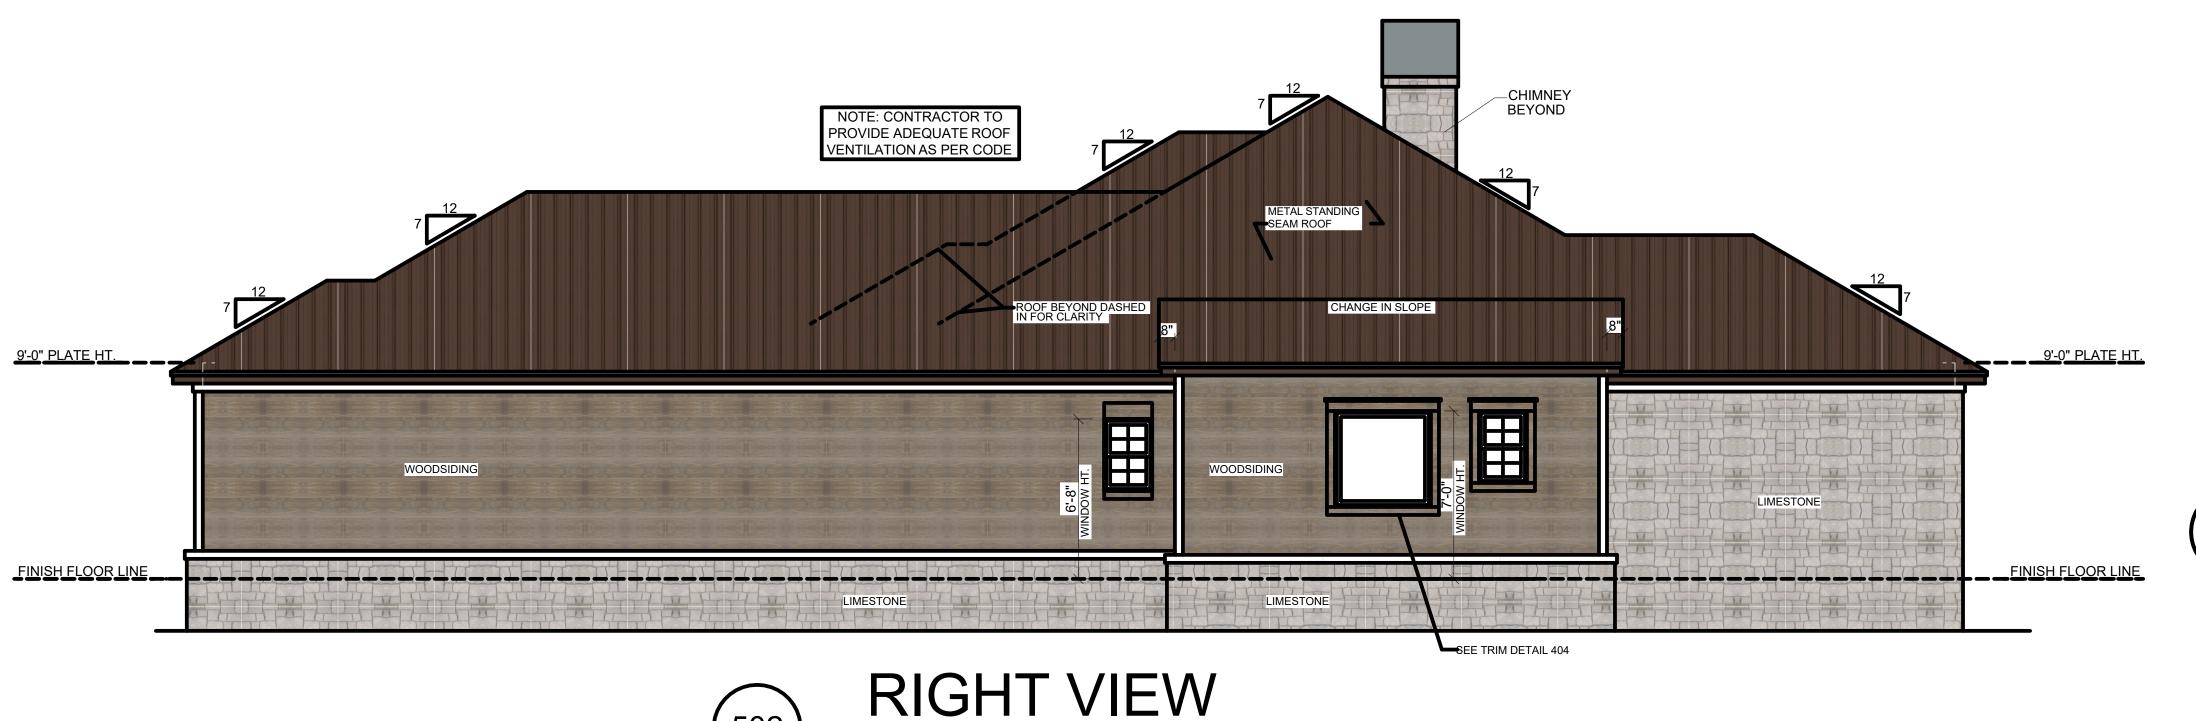
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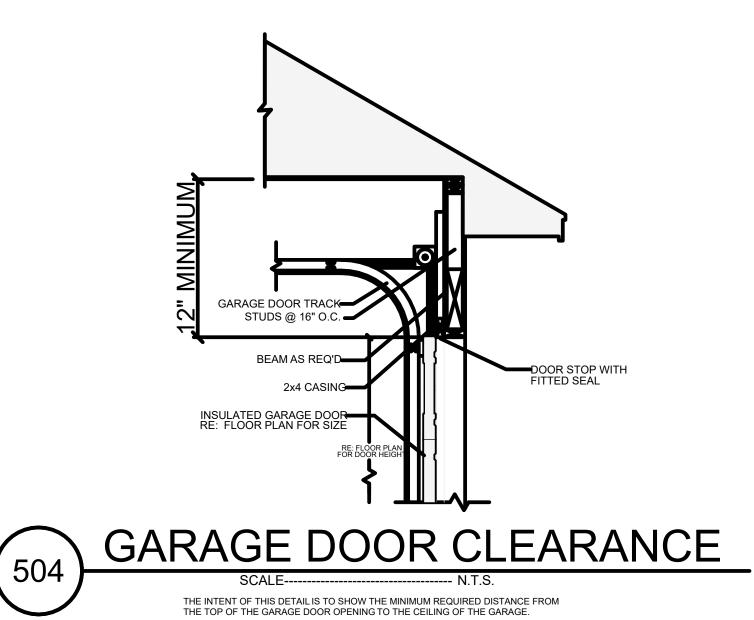


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- AND OTHER MISC. INFORMATION.

 6. CONTRACTOR TO PROVIDE ADEQUATE ROOF VENTILATION AS REQ'D BY CURRENT CODES.





ATTACHED w/ 8d COMMON OR 10d BOX NAILS AT 4" SPACING ON EDGE

NOTE "B": CORNICE DETAIL FOR REFERENCE ONLY. REFER TO BUILDER SPECS FOR ACTUAL MATERIALS.

TYPICAL CORNICE DETAIL

Designing Homes

HOUSE PLAN ZONE

Building Relationships

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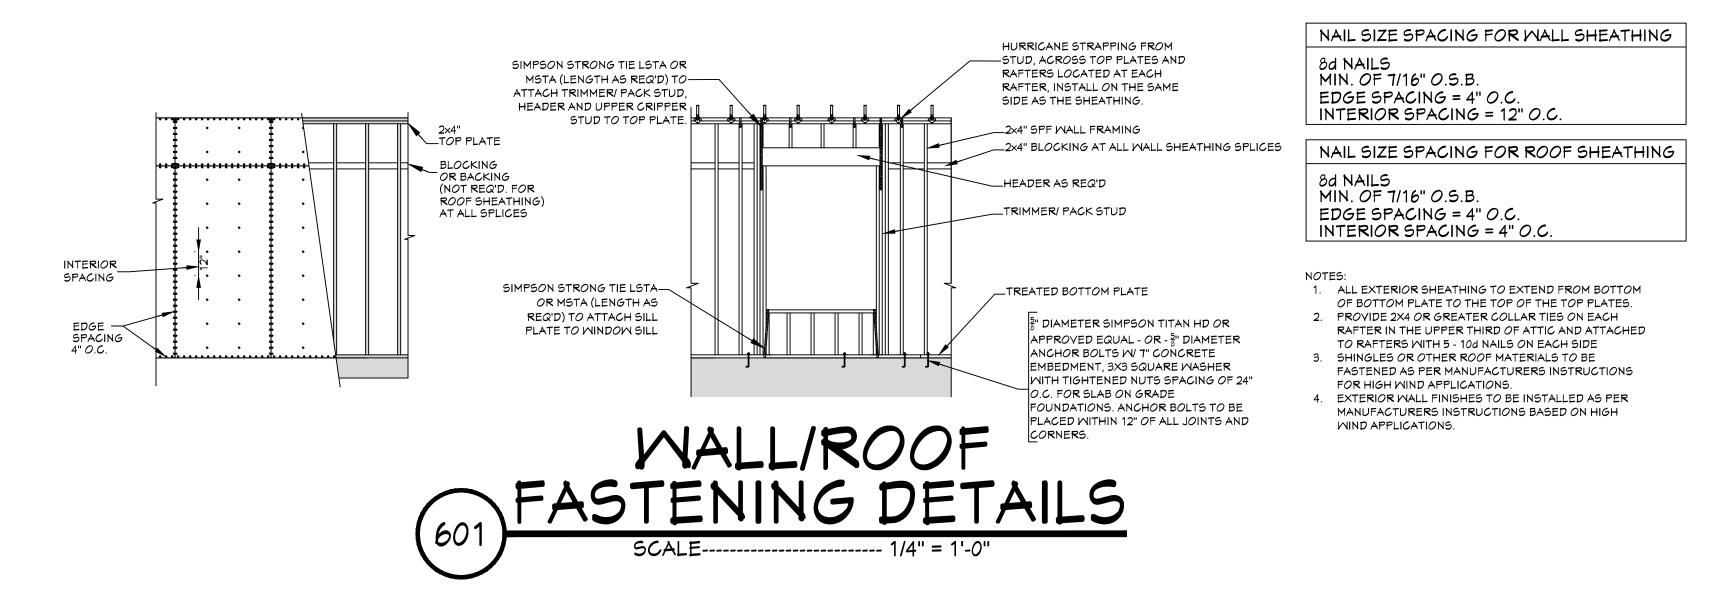
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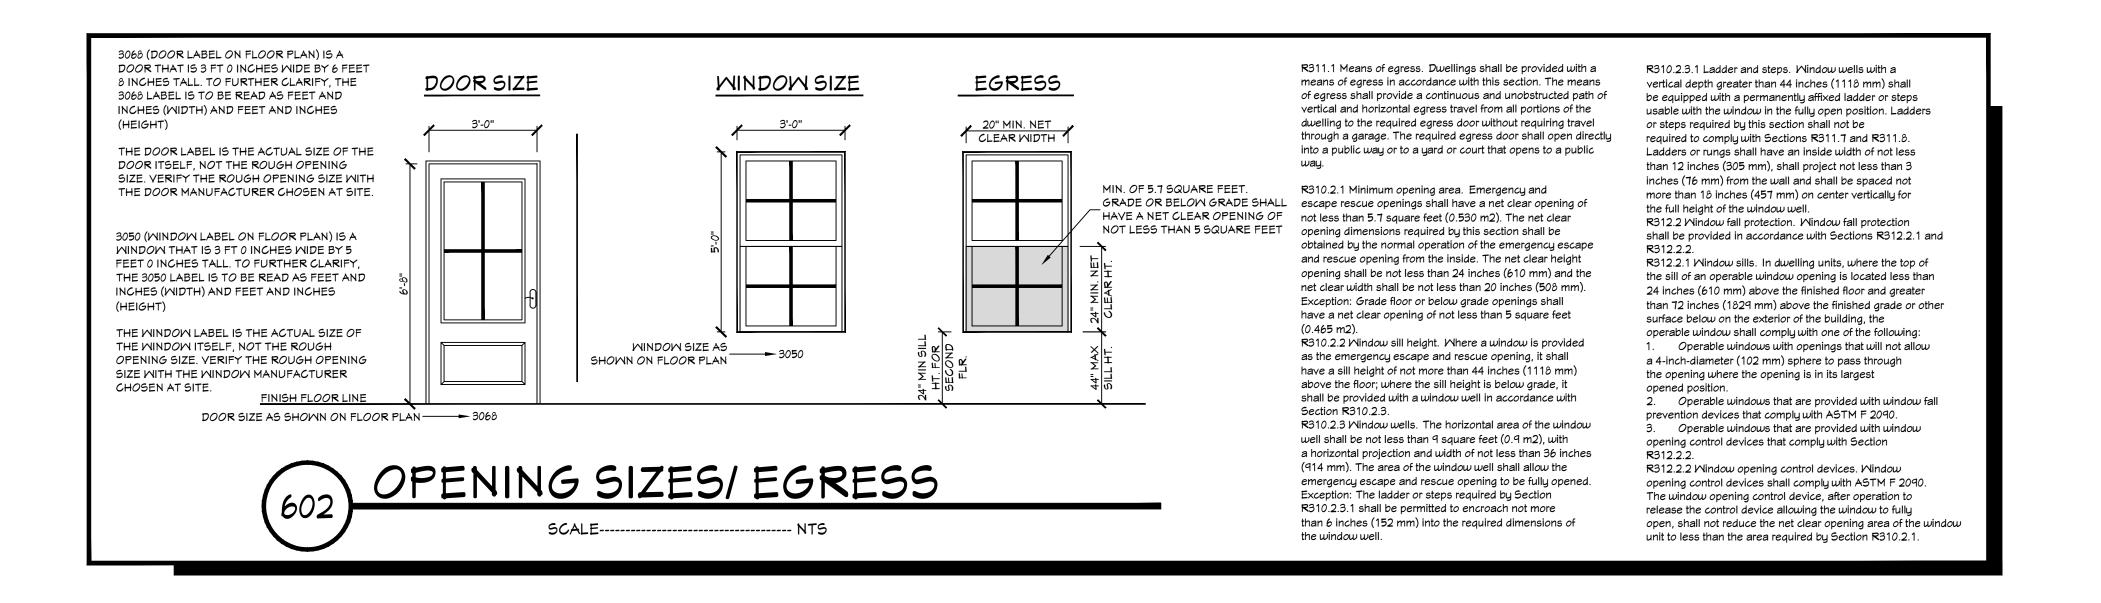
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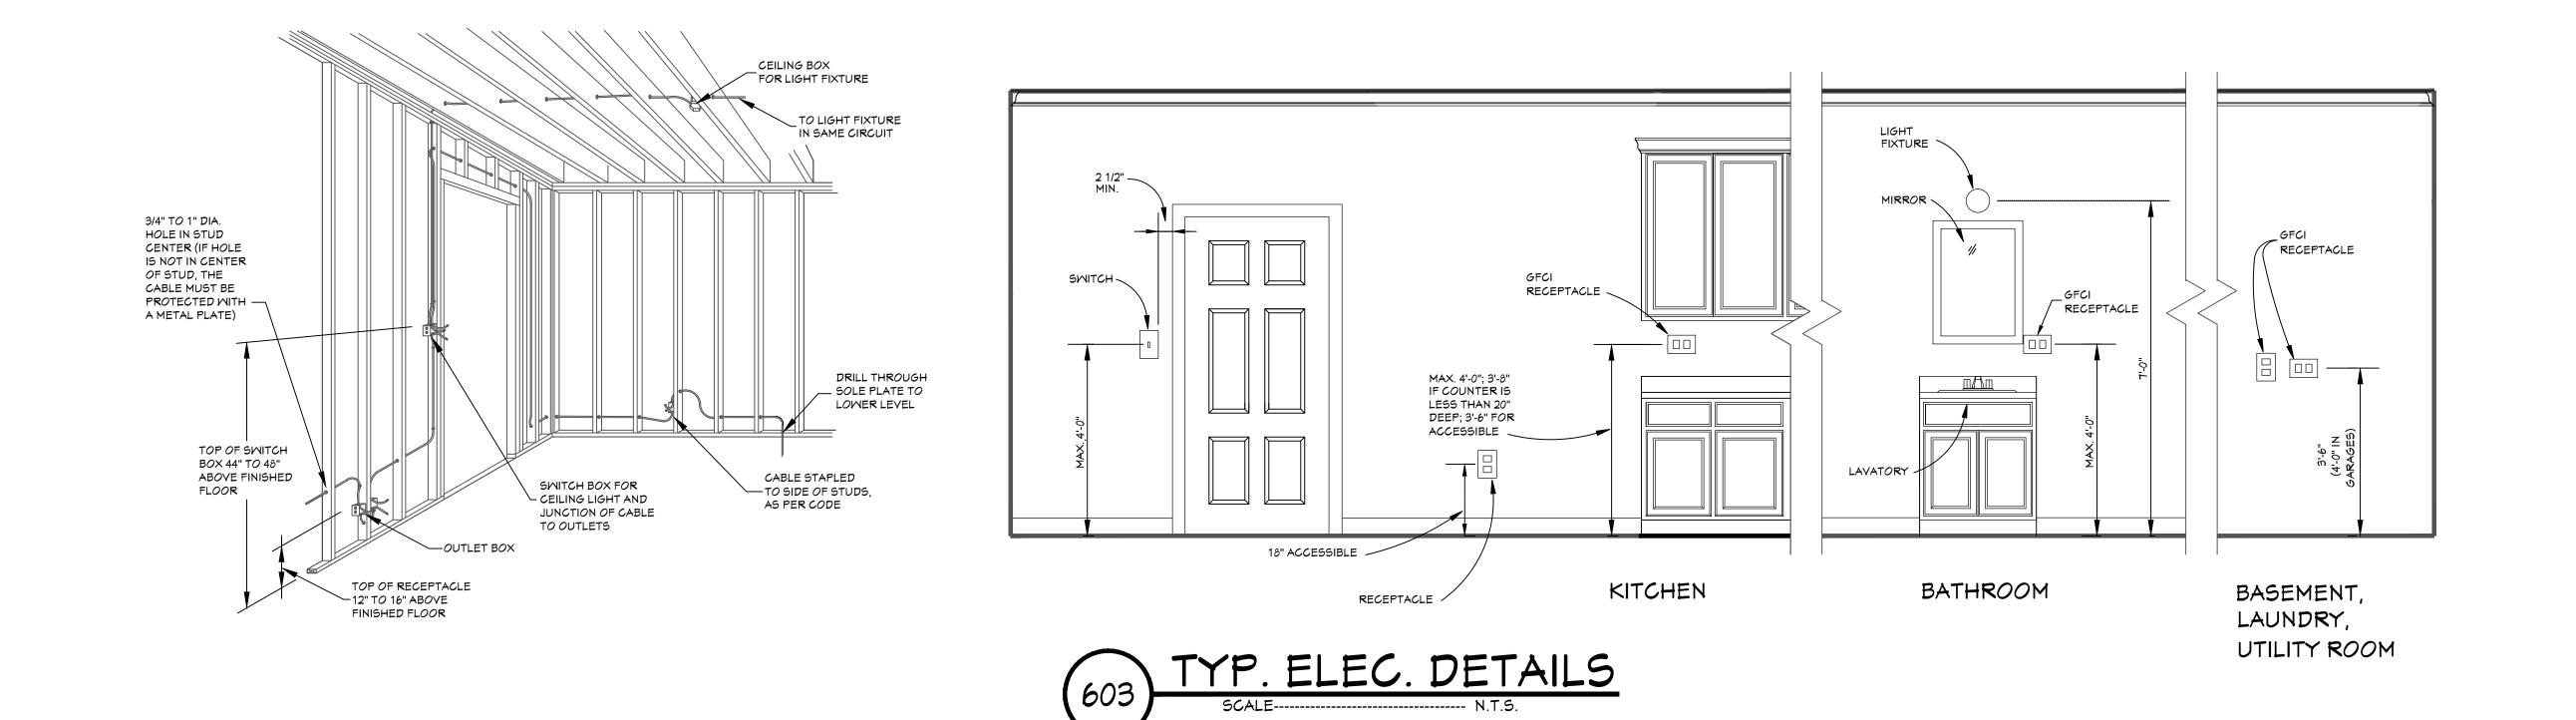
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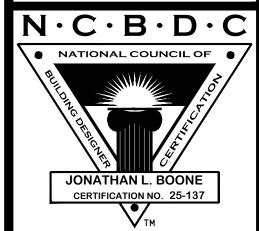


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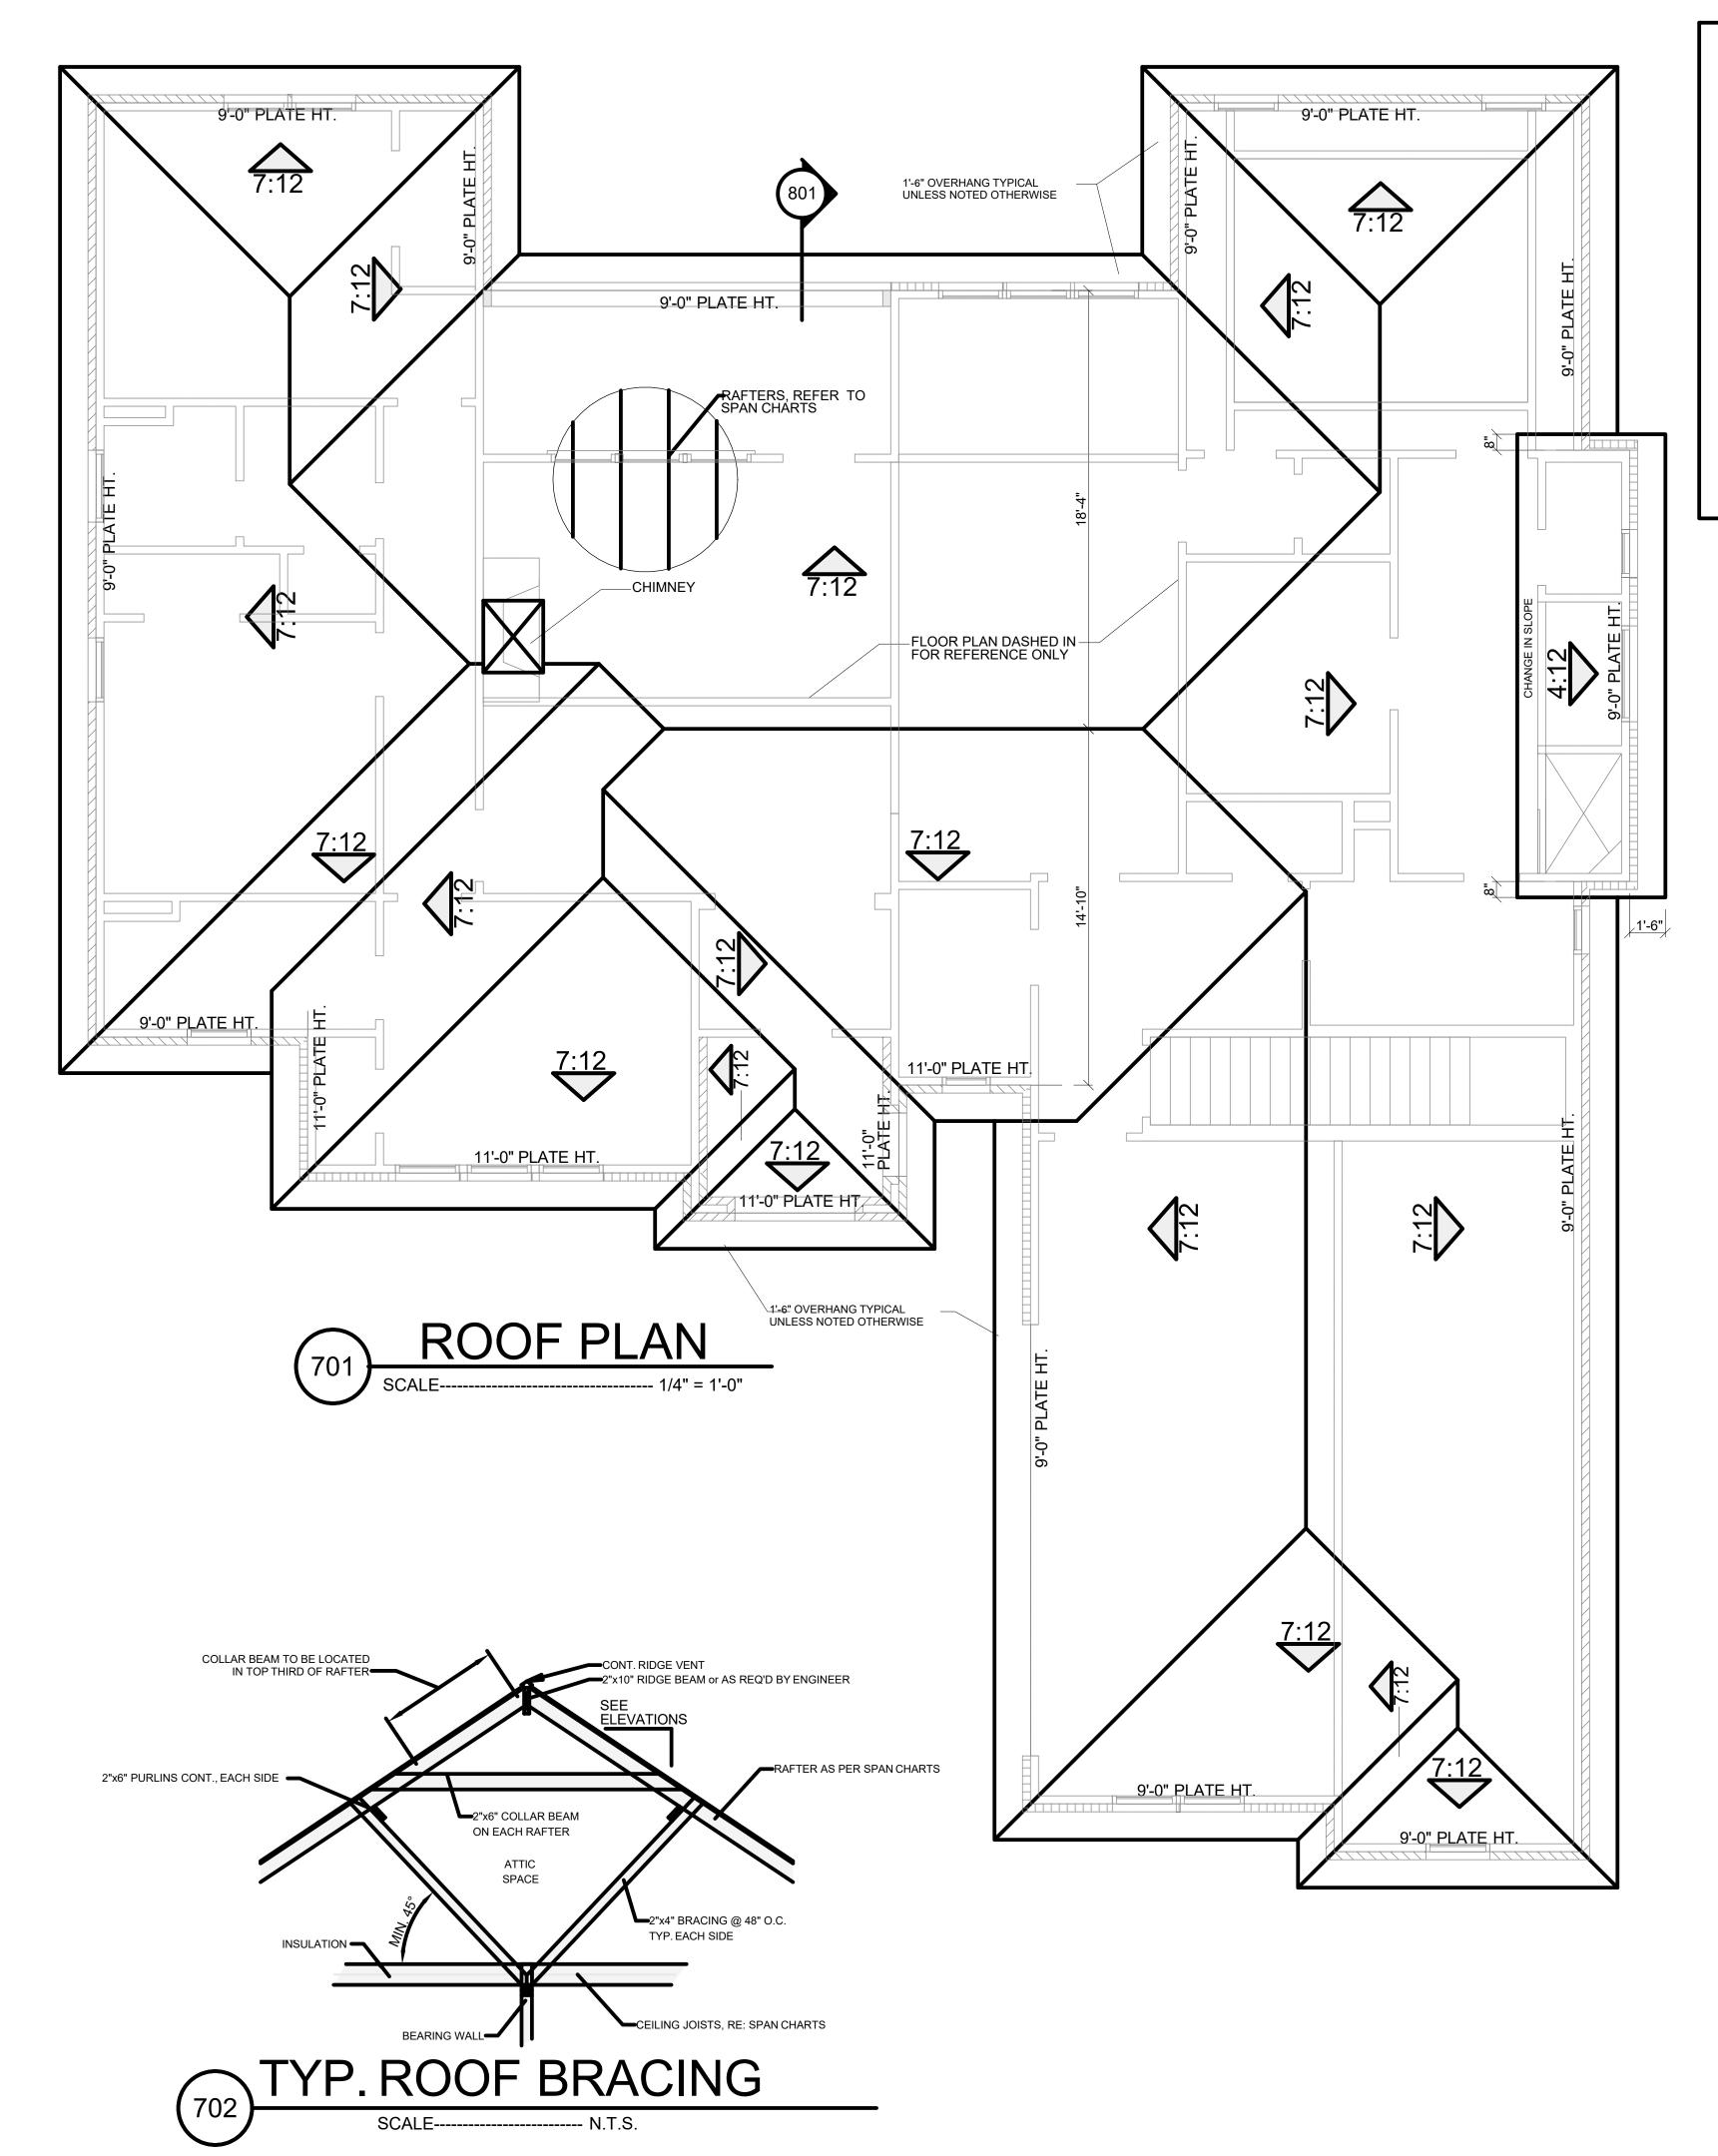
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ROOF PLAN NOTES:

- VALLEY RAFTERS CONTRACTOR TO TO BE 2" X 10", No.2 S.Y.P.OR AS REQ'D BY ENGINEER.
- 3. ALL RAFTERS TO BE SIZED AS PER SPAN CHART.
- ROOF INTERSECTIONS AS PER CODE
- PITCHES WITH EXTERIOR **ELEVATIONS PRIOR TO** CONSTRUCTION.
- PER CODE.

- 1. CONTRACTOR SHALL COMPLY WITH ALL APPLICABLE CODES
- 2. ALL RIDGE BEAMS, HIP RAFTERS, &
- 4. CONTRACTOR TO WATERPROOF ALL
- 5. CONTRACTOR TO VERIFY ALL ROOF
- 6. CONTRACTOR TO PROVIDE ADEQUATE ROOF VENTILATION AS

CEILING JOIST SPANS

MAXIMUM HEADER SPANS

ALL SPANS ARE ASSUMING A MAXIMUM OF 24 FEET OF SUPPORTED ROOF FRAMING.

MAXIMUM SPAN

(FEET AND INCHES)

4-7

5-9

6-10

8-1

7-3

8-7

SUPPORTING ROOF, CEILING AND ONE CENTER BEARING FLOOR

THE ABOVE INFORMATION IS FROM THE 2018 IRC TABLE R602.7(1).

10-1

MAXIMUM SPAN

(FEET AND INCHES)

5-8

6-8

7-2

8-5

PLEASE REFER TO THE IRC 2018 FOR ADDITIONAL LUMBER SPECIES AND HEADER OPTIONS.

ALL HEADER SIZES SHALL BE DESIGNED/ VERIFIED BY A LOCAL PROFESSIONAL.

SUPPORTING ROOF AND CEILING ONLY

LIVE LOAD=30psf DEAD LOAD = 10psf

JACK STUDS

JACK STUDS

2

HEADER SPANS FOR EXTERIOR BEARING WALLS

SOUTHERN PINE #2 OR BETTER

SIZE

NUMBER OF PLIES IN ()

 $(2) 2 \times 6$

(2) 2 x 8

(2) 2 x 10

(2) 2 x 12

 $(3) 2 \times 8$

(3) 2 x 10

(3) 2 x 12

SIZE

(2) 2 x 10

(2) 2 x 12

(3) 2 x 10

(3) 2 x 12

NOTES:

FACTOR

1.05

1.07

1.10

1.14 1.17

1.20

1.30

1.35

1.40

1.54 1.70

NUMBER OF PLIES IN (

CEILING JOIST SPANS FOR SOUTHERN PINE SPECIES (UNINHABITABLE ATTICS WITH LIMITED STORAGE, LIVE LOAD = 20psf, L/ 240) DEAD LOAD = 10psf)

IF HABITABLE ATTIC SPACE IS DESIRED, REFER TO THE INTERNATIONAL RESIDENTIAL CODE, SPAN TABLES.

SIZE	SPACING (INCHES)	VISUALLY GRADED #2 SOUTHERN PINE (MAXIMUM CEILING JOIST SPANS) (FT IN.)
2 x 4	12.0	9-3
	16.0	8-0
	19.2	7-4
	24.0	6-7
2 x 6	12.0	13-11
	16.0	12-0
2.7.0	19.2	11-0
	24.0	9-10
	12.0	17-7
2 x 8	16.0	15-3
2 X O	19.2	13-11
	24.0	12-6
	12.0	20-11
2 x 10	16.0	18-1
2 X 10	19.2	16-6
	24.0	14-9

The above tables are based on the IRC 2018 TABLE R802.5.1(2)

HIP/ VALLEY CONVERSION						
IF COMMON RAFTER ROOF PITCH IS			THEN HIP/ VALLEY RAFTER ROOF PITCH BECOMES			
RISE/ RUN	SLOPE		RISE/ RUN	SLOPE		
1/12	5°		1/17	3°		
2/12	10°		2/17	7°		
3/12	14°		3/17	10°		
4/12	18°		4/17	13°		
5/12	23°		5/17	16°		
6/12	27°		6/17	19°		
7/12	30°		7/17	22°		
8/12	34°		8/17	25°		
9/12	37°		9/17	28°		
10/12	40°		10/17	30°		
11/12	42°		11/17	33°		
12/12	45°		12/17	35°		
CONVERSION CHART FOR SIMPLE ROOFS ONLY.						

CHART DOES NOT APPLY FOR DUAL PITCH ROOFS.

 $\hbox{\tt MULTIPY HORIZONTAL SPAN OF MEMBER BY FACTOR}.$

CHOOSE APPROPRIATE FACTOR BY ROOF PITCH.

RAFTER LENGTH CHART

ROOF PITCH

3/12

4/12

5/12

6/12

8/12

11/12

12/12

14/12

RAFTER SPANS

RAFTER SPANS FOR SOUTHERN PINE SPECIES LIVE LOAD=30psf, L/=180 DEAD LOAD = 10psf

SIZE	SPACING (INCHES)	SPANS (MAXIMUM RAFTER SPANS BETWEEN BRACING) (FT IN.)		
2 x 6	12.0	12-11		
	16.0	11-2		
	19.2	10-2		
	24.0	9-2		
2 x 8	12.0	16-4		
	16.0	14-2		
	19.2	12-11		
	24.0	11-7		
)	12.0	19-5		
2 x 10	16.0	16-10		
	19.2	15-4		
	24.0	13-9		
2 x 12	12.0	22-10		
	16.0	19-10		
	19.2	18-1		
	24.0	16-2		

The above tables are based on the IRC 2018 TABLE R802.4.1(3)

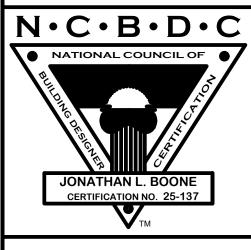


Website: www.HPZplans.com Email:

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Phone: 601.336.3254

Fax: 1.800.574.1387



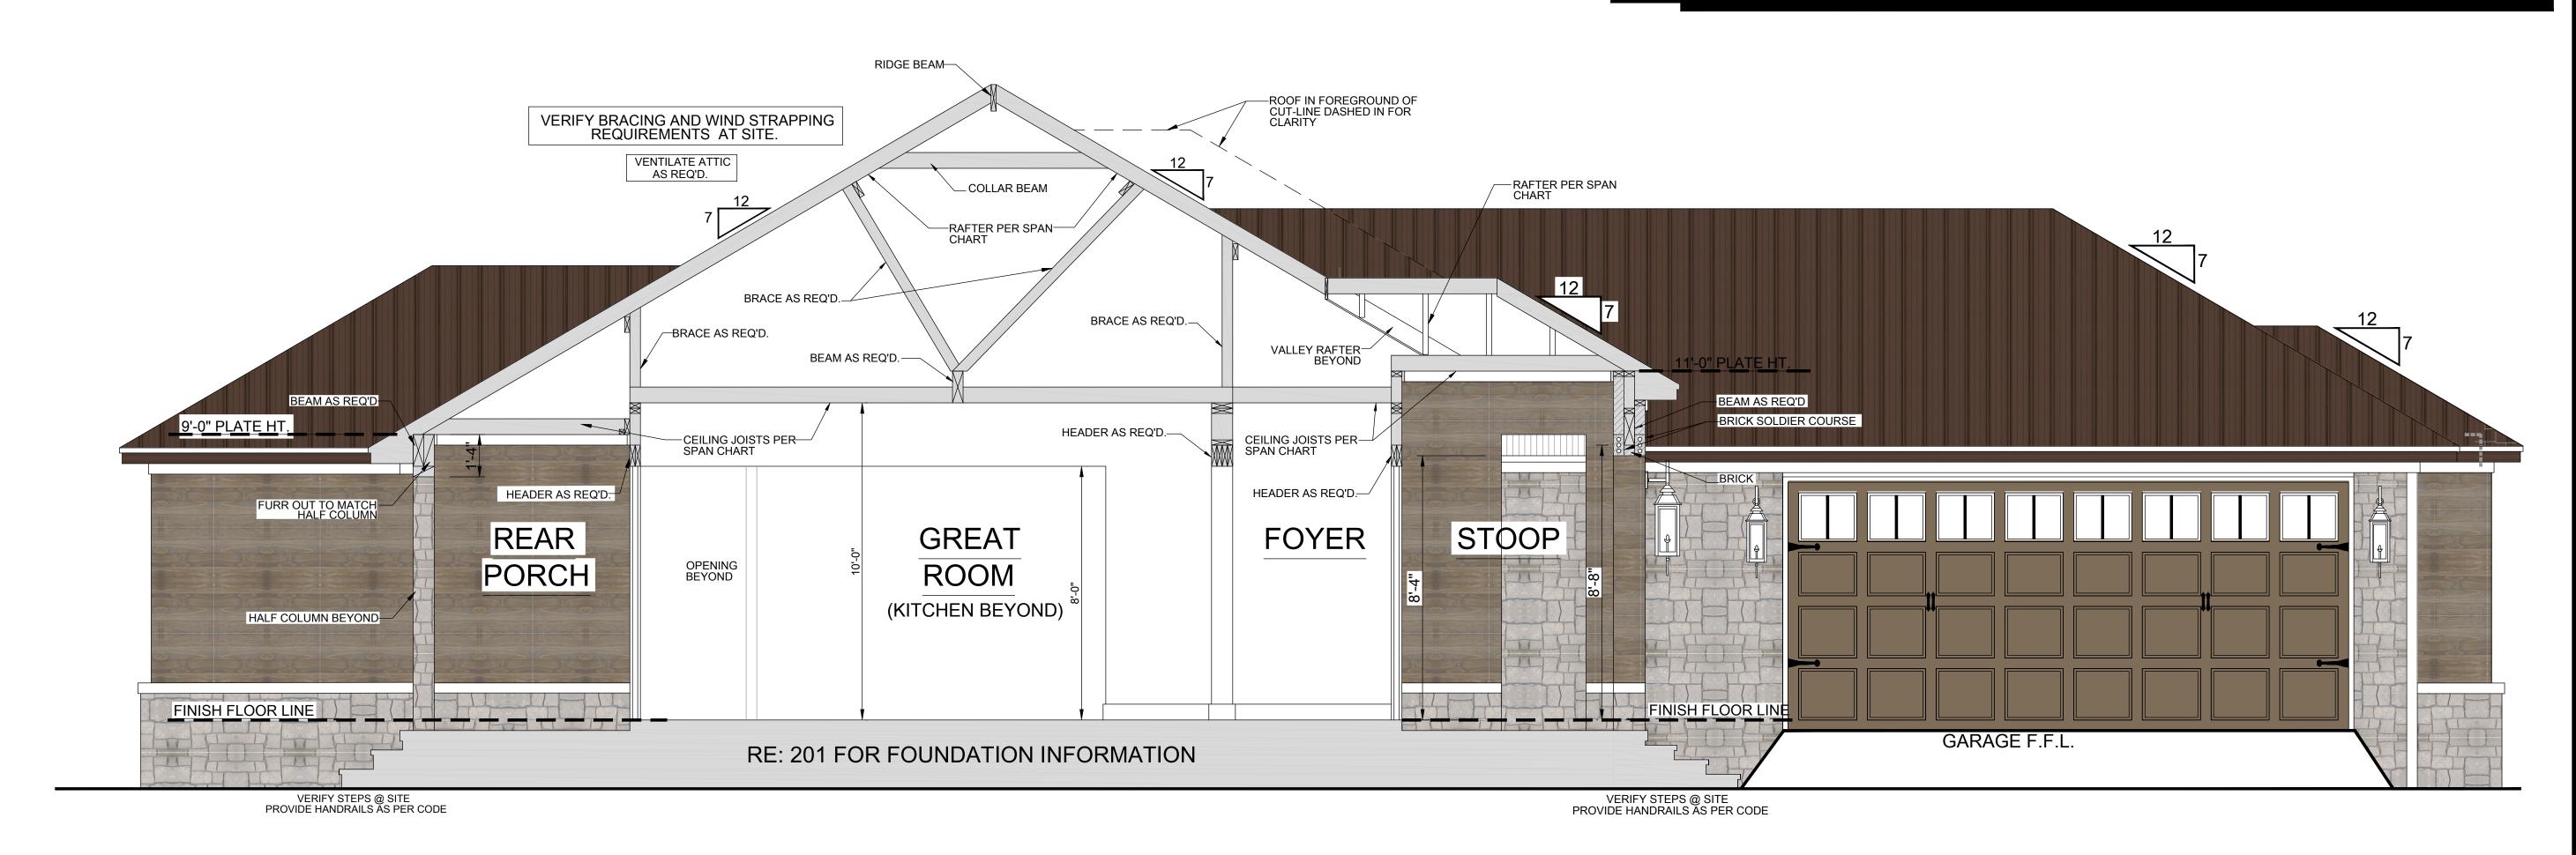
Date: 7.13.21

Drawn By: C.A.B.

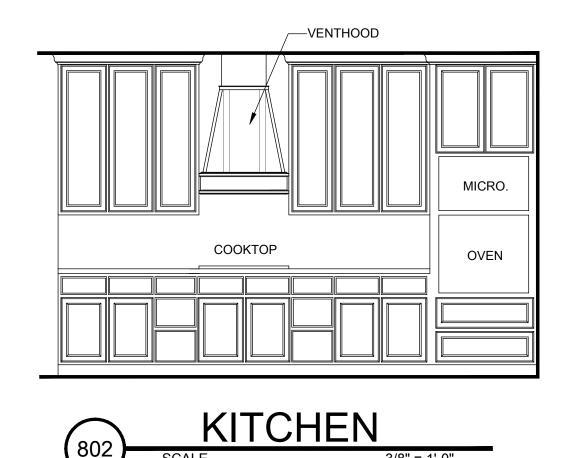
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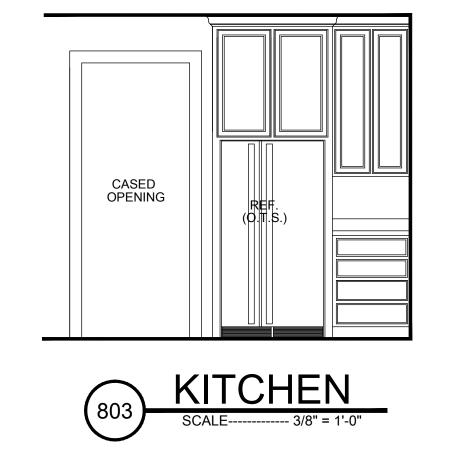
CROSS SECTION NOTES:

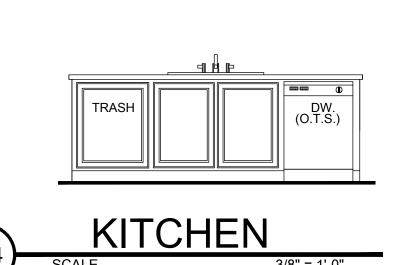
- 1. CONTRACTOR SHALL COMPLY WITH ALL APPLICABLE CODES AT SITE.
- 2. ALL RIDGE BEAMS, HIP RAFTERS, & VALLEY RAFTERS TO BE 2" x 10", OR AS REQUIRED BY LOCAL ENGINEER.
- . CONTRACTOR TO PROVIDE RAFTER BRACING TO MEET APPLICABLE CODES
- 4. CONTRACTOR TO THOROUGHLY WATERPROOF ALL EXTERIOR INTERSECTIONS AS PER CODE AND TYPICAL BUILDING PRACTICES.
- . ALL BEAMS TO BE SIZED BY A LOCAL PROFESSIONAL OR LICENSED STRUCTURAL ENGINEER.
- 6. ALL LUMBER SIZES AND SPACING TO BE VERIFIED BY CONTRACTOR PRIOR TO CONSTRUCTION.
- 7. CONTRACTOR TO PROVIDE ADEQUATE ROOF VENTILATION AS REQ'D. BY CURRENT CODES.

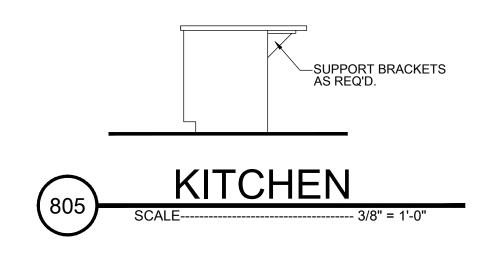


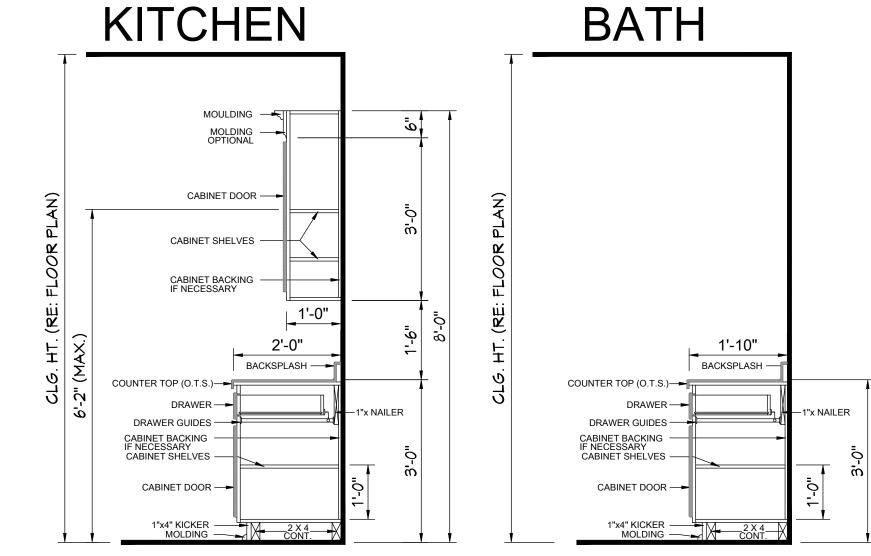














Designing Homes

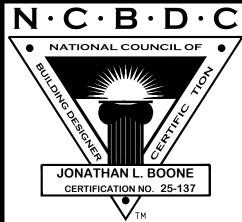
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Building Relationships

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ns and the completion of these construs, House Plan Zone, LLC. assumes no or deficiencies in the design.

Pre-Drawn Plan ID:

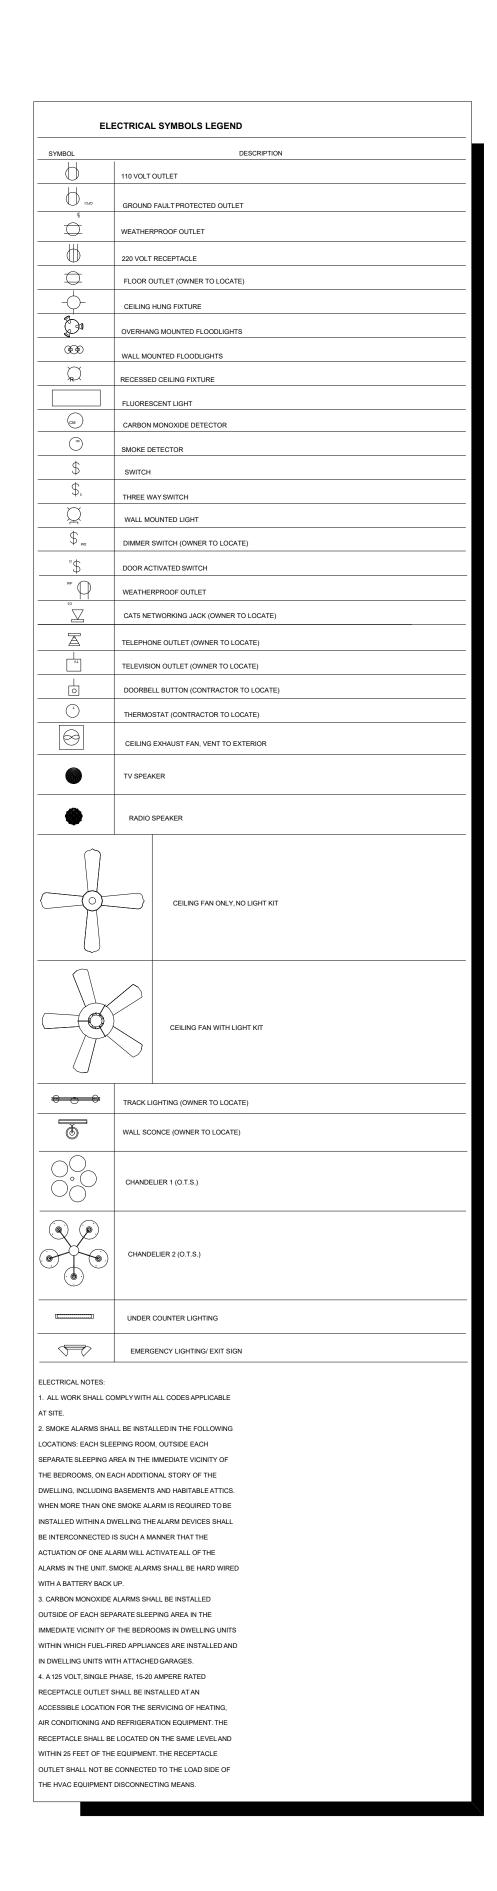
2246

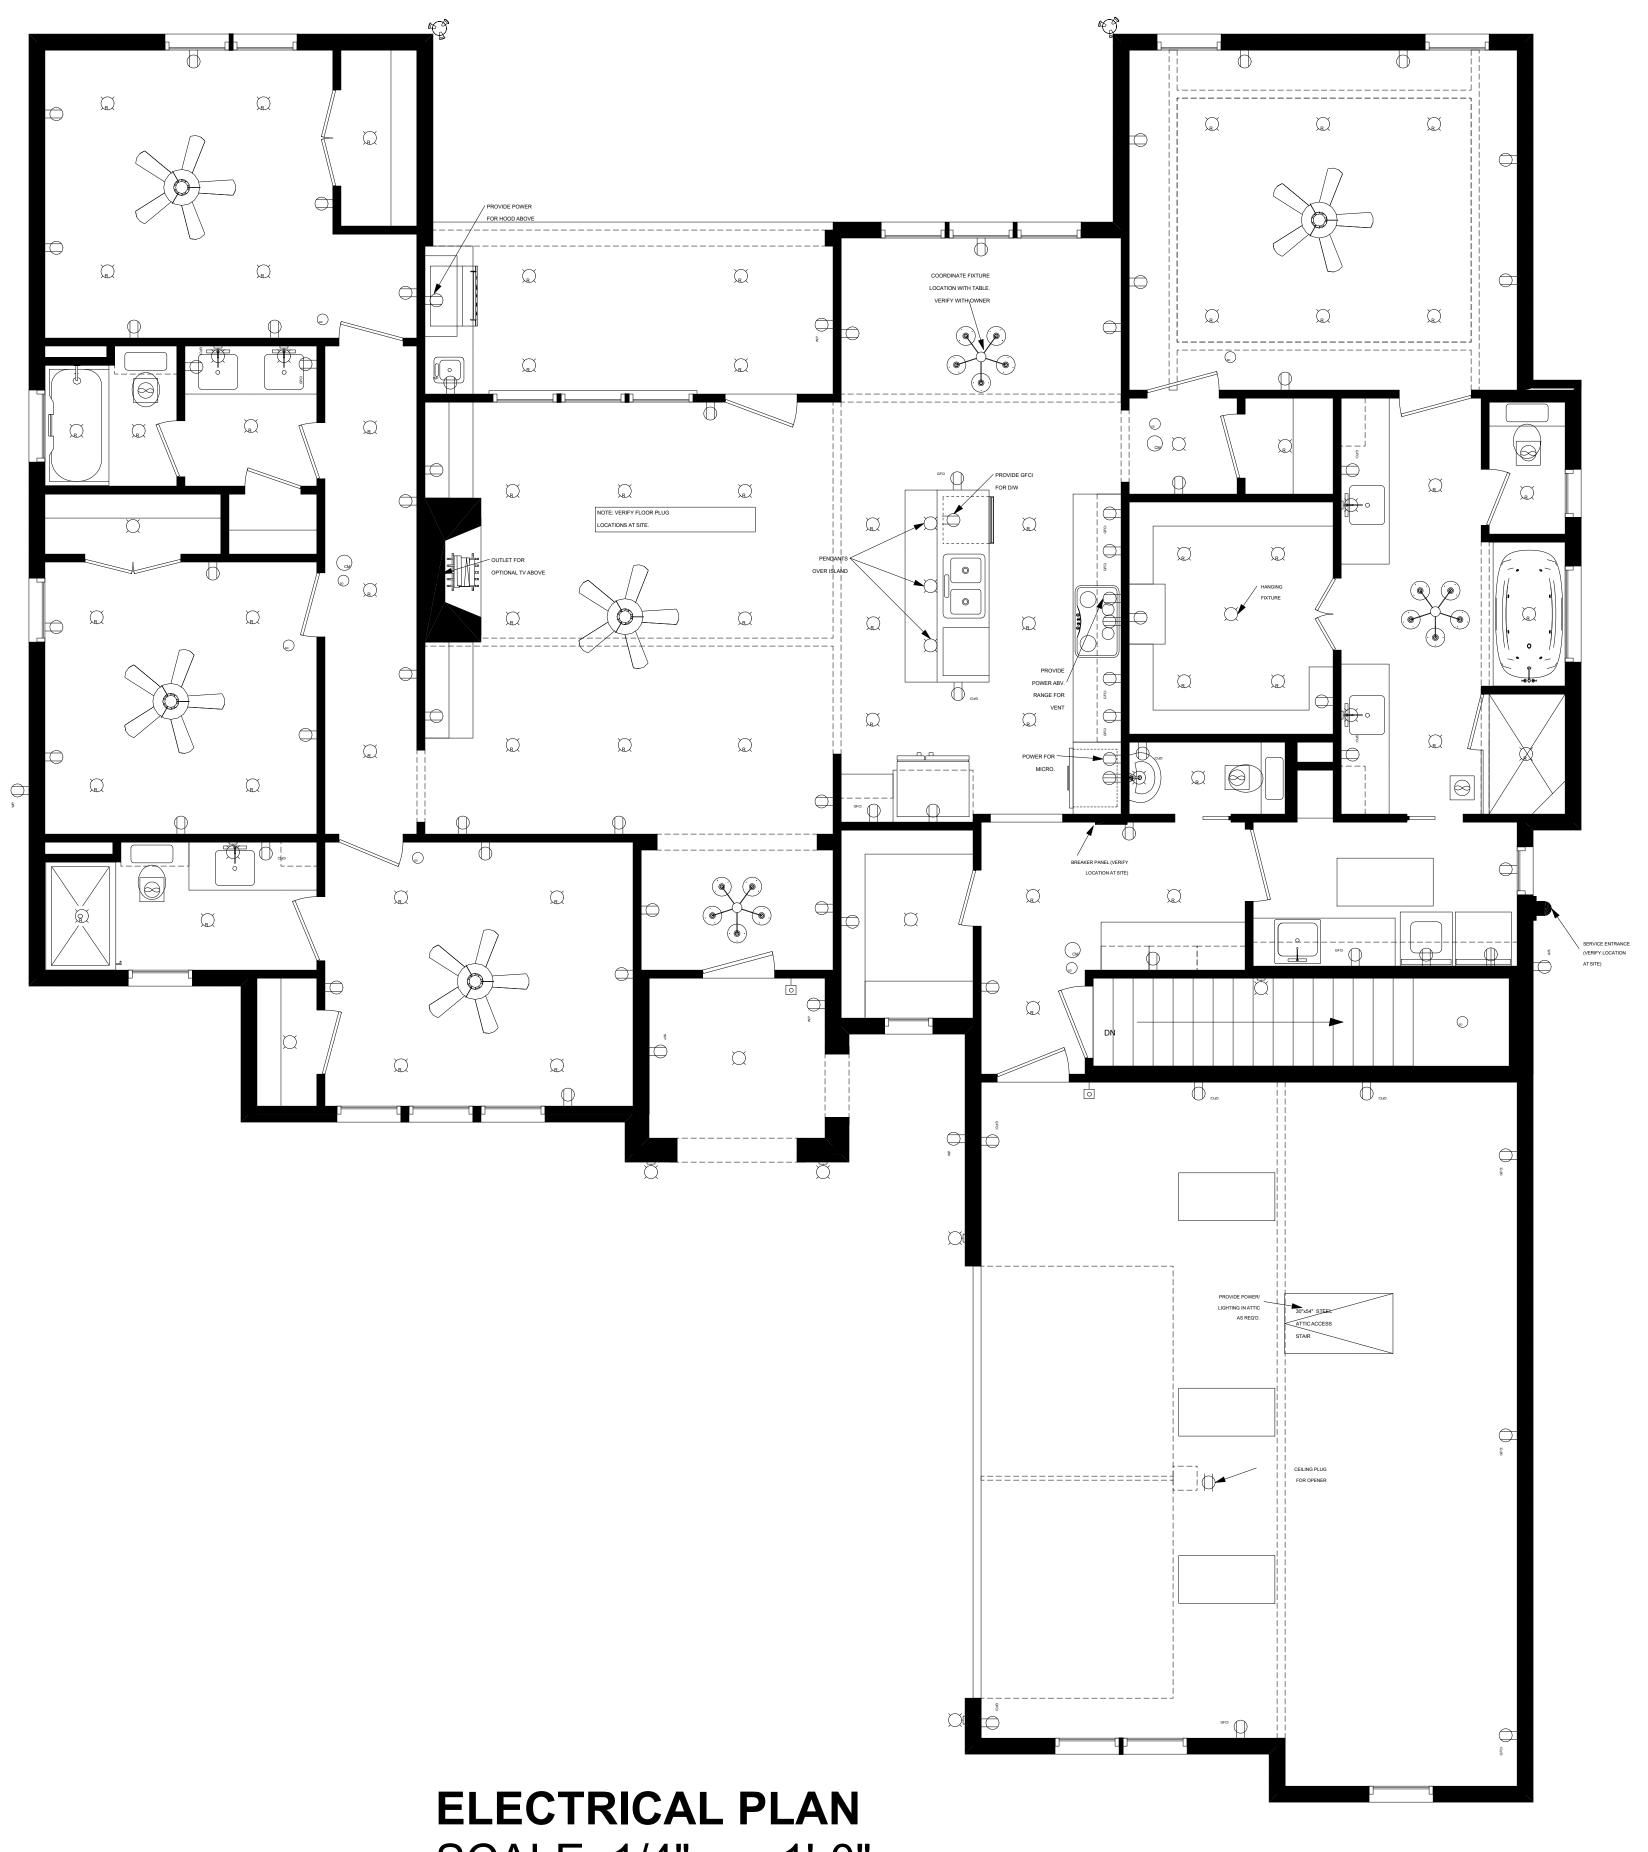
Sised great care and effort in the development of these plans and the caperator of the position of the properties of the propertie

Date: 7.13.21

Drawn By:
C.A.B.

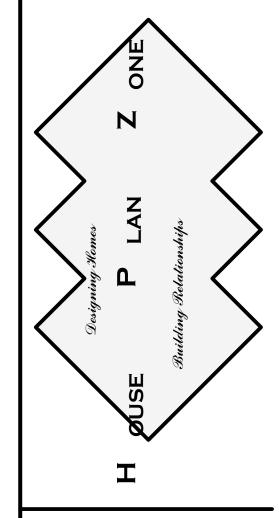
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SCALE: 1/4" = 1'-0"

NOTE: SWITCHES AND ELECTRICAL CONNECTIONS ARE NOT SHOWN. OWNER TO LOCATE THESE ITEMS DURING ELECTRICAL WALK-THROUGH WITH ELECTRICAL CONTRACTOR AT SITE.

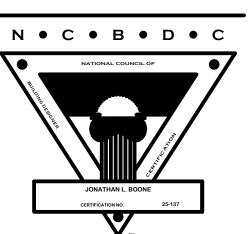


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e-Drawn Plan

6.24.21

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