ABV ABOVE A/C AIR CONDITIONING A.D. AREA DRAIN LA LAUNDRY ADJ ADJUSTABLE LAV LAVATORY ALT ALTERNATE ALUM ALUMINUM LVR LOUVER MAX MAXIMUM ARCH. ARCHITECTURAL MECH MECHANICAL BA BATHROOM MFR. MANUFACTURER BF BI-FOLD (DOOR) MISC MISCELLANEOUS BLDG BUILDING N NORTH N.T.S. NOT TO SCALE BLK BLOCK (CMUs) O.G.D. OVERHEAD GARAGE DOOR BLW BELOW BM BEAM OH OVERHEAD OPT OPTIONAL BP BI-PASS (DOOR) PAR PARALLEL P.B. PUSH BUTTON BOT BOTTOM BTWN BETWEEN PDR POWDER CAB CABINET CER CERAMIC PED PEDESTAL PL PLATE PR PAIR C.J. CONTROL JOINT OR CONSTRUCTION JOINT CL CLOSET OR CENTER LINE P.T. PRESSURE TREATED WOOD CLG CEILING CLR CLEAR PVC POLYVINYL CHLORIDE PIPE CMU CONCRETE MASONRY UNIT PVMT PAVEMENT PMD PLYWOOD CONC CONCRETE C CARPET CR CORROSION RESISTANT RISER RAG RETURN AIR GRILL CSMT CASEMENT C.T. CERAMIC TILE REF REFERENCE REFR REFRIGERATOR REQ REQUIRED D DRYER S SOUTH SD SMOKE DETECTOR S.F. SQUARE FEET S.G.D. SLIDING GLASS DOOR DBL DOUBLE DH DOUBLE HUNG DIM DIMENSION DISP DISPOSAL SH SINGLE HUNG OR SHELF DN DOWN DR DOOR SIM SIMILAR SL SLOPE / SLIDING S&P SHELF AND POLE DS DOWNSPOUT DW DISH WASHER SPEC SPECIFICATIONS DMG DRAWING E EAST EA EACH STD STANDARD STR STRUCTURAL SQ SQUARE ELEV ELEVATION ELEC ELECTRICAL SYM SYMBOL S4S SMOOTH FOUR SIDES TREAD (AT STAIRS) OR TILE EQ EQUAL T.B. TOWEL BAR EXT EXTERIOR TEMP. TEMPERED (GLASS) FAU FORCED AIR UNIT T&G TONGUE & GROOVE F.C. FLOOR CHANGE T.O.C. TOP OF CURB F.D. FLOOR DRAIN TV TELEVISION FFL FINISH FLOOR LINE F.G. FINISHED GRADE TYP TYPICAL U.N.O. UNLESS NOTED OTHERWISE FLR FLOOR(ING) FL FLOURESCENT (LIGHT) V.B. VAPOR BARRIER VERT VERTICAL FND FOUNDATION F.O.S. FACE OF STUD FTG FOOTING V.T.R. VENT THRU ROOF M WASHING MACHINE MD WOOD MDM WINDOW FX FIXED GLASS GALV GALVANIZED WH WATER HEATER GAR GARAGE G.B. GYPSUM BOARD WI WROUGHT IRON GD GRADE OR GRADING WIC WALK-IN CLOSET W WO WITH OR WITHOUT G.D.O. GARAGE DOOR OPENER WP WATERPROOF(ING GFI GROUND FAULT INTERRUPTER GL GLASS OR GLAZING WWM WELDED WIRE MESH SYP BD GYPSUM BOARD PL PROPERTY LINE HB HOSE BIBB HD HEAD OR HARD Ø ROUND / DIAMETER HDR HEADER & AND OL CENTERLINE HGT HEIGHT HVAC HEATING/VENTILATING/AIR COND. HMD HARDWOOD INT INTERIOR JST JOIST JT JOINT KIT KITCHEN

ALL CONSTRUCTION TO COMPLY WITH LOCAL CODES AND ORDINANCES CURRENTLY IN USE WITH THE LOCAL JURISDICTION.

APPLICABLE CODES:

FOLLOW ALL APPLICABLE STATE AND LOCAL CODES. ALABAMA STATE SUPPLEMENTS AND AMENDMENTS 2012

2018- INTERNATIONAL RESIDENTIAL CODE (BUILDING)

2018- INTERNATIONAL FIRE PREVENTION CODE

2018- INTERNATIONAL PLUMBING CODE (BUILDING) 2018- INTERNATIONAL MECHANICAL CODE (BUILDING)

2018- INTERNATIONAL FUEL GAS CODE (BUILDING)

2018- INTERNATIONAL ENERGY CONSERVATION CODE (BUILDING) 2017- NATIONAL ELECTRICAL CODE

PRODUCT:

SINGLE FAMILY RESIDENCE

OCCUPANCY CLASSIFICATION RESIDENTIAL R-3

CONSTRUCTION TYPE: TYPE VB

INDEX MODEL 'TAYLOR' TITLE SHEET / COVER SHEET I A S BUILDING SECTIONS FRONT ELEVATION 'A-I' ELEVATION OPTIONS 1.5 A ROOF PLAN 'A' IST FLOOR UTILITY PLAN SIDE AND REAR ELEVATIONS 'A' 2ND FLOOR UTILITY PLAN MONOLITHIC SLAB PLAN 'A' STEM WALL PLAN 'A' 3 SW A ARCHITECTURAL SHEETS IST FLOOR PLAN 'A' 4 A 2ND FLOOR PLAN 'A' ΙB FRONT ELEVATION 'B-I' ROOF PLAN 'B' 1.5 B SIDE AND REAR ELEVATIONS 'B' MONOLITHIC SLAB PLAN 'B' STEM WALL PLAN 'B 3 SW B IST FLOOR PLAN 'B' 5 B 2ND FLOOR PLAN 'B'

ALL CONSULTANT DRAWINGS ACCOMPANYING THESE ARCHITECTURAL DRAWINGS HAVE NOT BEEN PREPARED BY OR UNDER THE DIRECTION OF GMD DESIGN GROUP, INC. GMD DESIGN GROUP INC. THEREFORE ASSUMES NO LIABILITY FOR THE COMPLETENESS OR CORRECTNESS OF THESE DRAWINGS.

DFI TAYIORI - I H

NO:	DATE:	REVISION:
$\overline{\triangle}$	05.04.24	

PROJECT TITLE:

30' Series

CONSULTANTS:

BUILDER:

DR HORTON 2188 PARKWAY LAKE DRIVE

PLAN CHANGES:

DESCRIPTION:

INITIAL PLAN RELEASE

DATE:

05.02.24

SUITE 200 HOOVER, AL PHONE: (770) 730-7900

CONTACT: GENE VANDEVENDER EMAIL: GVANDEVENDER@DRHORTON.COM **DESIGNER:**

GMD DESIGN GROUP 1138 SATELLITE BLVD. STE 300 SUMANEE, GA. 30024 PHONE: (770) 375-7351

CONTACT: DONALD J. MCGRATH EMAIL: DONNIE@GMDDESIGNGROUP.COM

CLIENTS NAME:

GENERAL NOTES DESIGNER:

THESE DOCUMENTS ARE THE PROPERTY OF THE DESIGNER AND SHALL NOT BE COPIED, PROVIDE BLOCKING AND/OR BACKING AT ALL TOWEL BAR, TOWEL RING AND/OR DUPLICATED, ALTERED, MODIFIED OR REVISED IN ANY WAY WITHOUT THE EXPRESSED WRITTEN APPROVAL OF THE DESIGNER.

CONTRACTOR SHALL VERIFY ALL CONDITIONS AND DIMENSIONS AT THE SITE AND ALL INCONSISTENCES SHALL BE BROUGHT TO THE ATTENTION OF THE DEVELOPER AND THE DESIGNER BEFORE PROCEEDING WITH WORK.

ANY ERRORS OR OMISSIONS FOUND IN THESE DRAWINGS SHALL BE BROUGHT TO DEVELOPERS AND DESIGNERS ATTENTION IMMEDIATELY.

DO NOT SCALE DRAWINGS. WRITTEN DIMENSIONS TAKE PRECEDENCE OVER SCALED ALL DIMENSIONS ARE TO FACE OF STUD OR TO FACE OF FRAMING UNLESS

OTHERWISE NOTED. ALL TRUSS DRAWINGS TO BE REVIEWED AND APPROVED BY THE STRUCTURAL ENGINEER PRIOR TO ISSUANCE OF BUILDING PERMIT.

ALL OR EQUAL SUBSTITUTIONS MUST BE SUBMITTED TO AND APPROVED BY CITY BUILDING OFFICIAL PRIOR TO INSTALLATION.

ALL ANGLED PARTITIONS ARE 45 DEGREES UNLESS OTHERWISE NOTED. PROVIDE FIREBLOCKING. (PER LOCAL CODES)

ALL ELECTRICAL AND MECHANICAL EQUIPMENT AND METERS ARE SUBJECT TO RELOCATION DUE TO FIELD CONDITIONS, CONTRACTOR TO VERIFY

TOILET PAPER HOLDER LOCATIONS, AS SHOWN PER PLAN. TYPICAL AT ALL BATHROOMS AND POWDER ROOMS. VERIFY LOCATIONS AT FRAMING WALK.

ELASTOMERIC SHEET WATERPROOFING: FURNISH AND INSTALL ALL WATERPROOFING COMPLETE. A 40 MIL. SELF-ADHERING MEMBRANE OF RUBBERIZED ASPHALT INTEGRALLY BONDED TO POLYETHYLENE SHEETING, OR EQUAL. INSTALL PER MANUFACTURE'S AND TRADE ASSOCIATION'S PRINTED INSTALLATION INSTRUCTIONS. 6" MINIMUM LAP AT ALL ADJACENT WALL SURFACES.

TO THE BEST OF THE DESIGNER'S KNOWLEDGE THESE DOCUMENTS ARE IN CONFORMANCE WITH THE REQUIREMENTS OF THE BUILDING AUTHORITIES HAVING JURISDICTION OVER THIS TYPE OF CONSTRUCTION AND OCCUPANCY.

SHOP DRAWING REVIEW AND DISTRIBUSTION, ALONG WITH PRODUCT SUBMITTALS, REQUESTED IN THE CONSTRUCTION DOCUMENTS, SHALL BE THE SOLE RESPONSIBILITY OF THE GENERAL CONTRACTOR, UNLESS DIRECTED OTHERWISE UNDER A SEPARATE AGREEMENT.

DEVIATIONS FROM THESE DOCUMENTS IN THE CONSTRUCTION PHASE SHALL BE REVIEWED BY THE DESIGNER AND THE OWNER PRIOR TO THE START OF WORK IN QUESTION. ANY DEVIATIONS FROM THESE DOCUMENTS WITHOUT PRIOR REVIEW, SHALL BE THE SOLE RESPONSIBILITY OF THE GENERAL CONTRACTOR.

THE GENERAL CONTRACTOR SHALL BE RESPONSIBLE FOR ALL WORK AND MATERIALS REPRESENTED ON THESE DOCUMENTS INCLUDING THE WORK AND MATERIALS FURNISHED BY SUBCONTRACTORS AND VENDORS.

THE BUILDER SHALL FURNISH ANY AND ALL REPORTS RECEIVED FROM THE GEOTECHNICAL ENGINEER (SOILS REPORT), ON THE STUDY OF THE PROPOSED SITE,

TO THE DESIGNER, STRUCTURAL ENGINEER, AND GENERAL CONTRACTOR. IN THE EVENT THE GEOTECHNICAL REPORTS DO NOT EXIST, THE SOILS CONDITION SHALL BE ASSUMED TO BE A MINIMUM DESIGN SOIL PRESSURE STATED BY THE STRUCTURAL ENGINEER OF RECORD FOR THE PURPOSE OF STRUCTURAL DESIGN. GENERAL CONTRACTOR SHALL ASSURE THE SOIL CONDITIONS MEET OR EXCEED

ALL WORK PERFORMED BY THE GENERAL CONTRACTOR SHALL COMPLY AND CONFORM WITH LOCAL AND STATE BUILDING CODES, ORDINANCES AND REGULATIONS, ALONG WITH ALL OTHER AUTHORITIES HAVING JURISDICTION. THE GENERAL CONTROATOR IS RESPONSIBLE TO BE AWARE OF THESE REQUIREMENTS AND GOVERNING REGULATIONS.

PROVIDE AN APPROVED WASHER DRAIN PAN AT SECOND FLOOR ONLY THAT DRAINS TO EXTERIOR.

WINDOW SUPPLIER TO VERIFY AT LEAST ONE WINDOW IN ALL BEDROOMS TO HAVE A CLEAR EGRESS OPENING OF 5.7 SQ FT WITH MIN. DIMENSION OF 24" IN HEIGHT AND 20" IN WIDTH: SILL HEIGHT NOT GREATER THAN 44" ABOVE FLOOR. (PER LOCAL CODES) ALL HANDRAIL BALLUSTERS TO BE SPACED SUCH THAT A 4" SPHERE CANNOT PASS

PROVIDE STAIR HANDRAILS AND GUARDRAILS PER LOCAL CODES

BETWEEN BALLUSTERS. (PER LOCAL CODES)

BUILDER SET:

THE SCOPE OF THIS SET OF PLANS IS TO PROVIDE A "BUILDER'S SET" OF CONSTRUCTION DOCUMENTS AND GENERAL NOTES HEREINAFTER REFERRED TO AS "PLANS". THIS SET OF PLANS IS SUFFICIENT TO OBTAIN A BUILDING PERMIT; HOWEVER, ALL MATERIALS AND METHODS OF CONSTRUCTION NECESSARY TO COMPLETE THE PROJECT ARE NOT NECESSARILY DESCRIBED. THE PLANS DELINEATE AND DESCRIBE ONLY LOCATIONS, DIMENSIONS, TYPES OF MATERIALS, AND GENERAL METHODS OF ASSEMBLING OR FASTENING. THEY ARE NOT INTENDED TO SPECIFY PARTICULAR PRODUCTS OR OTHER METHODS OF ANY SPECIFIC MATERIALS, PRODUCT OR METHOD. THE IMPLEMENTATION OF THE PLANS REQUIRES A CLIENT / CONTRACTOR THOROUGHLY KNOWLEDGEABLE WITH THE APPLICABLE BUILDING CODES AND METHODS OF CONSTRUCTION SPECIFIC TO THIS PRODUCT TYPE AND TYPE OF CONSTRUCTION.

CONSTRUCTION REQUIREMENTS AND QUALITY: PROVIDE WORK OF THE SPECIFIC QUALITY; WHERE QUALITY LEVEL IS NOT INDICATED, PROVIDE WORK OF QUALITY CUSTOMARY IN SIMILAR TYPES OF WORK. WHERE THE PLANS AND SPECIFICATIONS, CODES, LAWS, REGULATIONS, MANUFACTURER'S RECOMMENDATIONS OR INDUSTRY STANDARDS REQUIRE WORK OF HIGHER QUALITY OR PERFORMANCE, PROVIDE WORK COMPLYING WITH THOSE REQUIREMENTS AND QUALITY. WHERE TWO OR MORE QUALITY PROVISIONS OF THOSE REQUIREMENTS CONFLICT WITH THE MOST STRINGENT REQUIREMENT; WHERE REQUIREMENTS ARE DIFFERENT BUT APPARENTLY EQUAL, AND WHERE IT IS UNCERTAIN WHICH REQUIREMENT IS MOST STRINGENT, OBTAIN CLARIFICATION FROM THE GMD DESIGN GROUP BEFORE PROCEEDING.

AREA CALCULATIONS:

ELEV 'A' | ELEV 'B'

620 SF | 620 SF

993 SF | 993 SF

1613 SF | 1613 SF

416 SF | 416 SF

42 SF | 42 SF

MODEL 'TAYLOR' SQUARE FOOTAGES

OPT. COVERED PORCH | 80 SF | 80 SF

Ist FLOOR

2nd FLOOR

GARAGE

PORCH

TOTAL LIVING



PROJECT NO: GMD14065

FOR CONSTRUCTION

TITLE SHEET

May 02, 2024

SHEET NO:

NOTES: IRC

- GRADE CONDITIONS MAY VARY FOR INDIVIDUAL SITE FROM THAT SHOWN. BUILDER SHALL VERIFY AND COORDINATE PER ACTUAL SITE CONDITIONS.

- WINDOW HEAD HEIGHTS:

IST FLOOR = 7'-0" U.N.O. ON ELEVATIONS. 2ND FLOOR = 7'-0" U.N.O. ON ELEVATIONS.

- ROOFING: PITCHED SHINGLES PER DEVELOPER.

- WINDOWS: MANUFACTURER PER DEVELOPER. DIVIDED LITES AS SHOWN ON THE EXTERIOR ELEVATIONS - ENTRY DOOR: AS SELECTED BY DEVELOPER.

- GARAGE DOORS: AS SELECTED BY DEVELOPER, RAISED PANEL AS SHOWN.

- CHIMNEY AS OCCURS: TOP OF CHIMNEYS TO BE A MINIMUM OF 24" ABOVE ANY ROOF WITHIN 10^{1} - 0° OF CHIMNEY.

- ALL EXTERIOR MATERIALS TO BE INSTALLED PER MANUFACTURER'S WRITTEN INSTRUCTIONS.

PROTECTION AGAINST DECAY: (ALL PORTIONS OF A PORCH, SCREEN PORCH OR DECK FROM THE BOTTOM OF

THE HEADER DOWN, INCLUDING POST, RAILS, PICKETS, STEPS AND FLOOR STRUCTURE.)

KEY NOTES:

MASONRY:

ADHERED STONE VENEER AS SELECTED BY DEVELOPER, HEIGHT AS NOTED.

2 MASONRY FULL BRICK AS SELECTED BY DEVELOPER. HEIGHT AS NOTED.

3 MASONRY FULL STONE AS SELECTED BY DEVELOPER. HEIGHT AS NOTED.

4 8" SOLDIER COURSE.

5 ROWLOCK COURSE
6 DECORATIVE KEY. SEE DETAIL.

TYPICALS:

TO CORROSION RESISTANT SCREEN LOUVERED VENTS, SIZE AS NOTED.

ODE APPROVED TERMINATION CHIMNEY CAP.

 CORROSION RESISTANT ROOF TO WALL FLASHING. CODE COMPLIANT FLASHING MUST BE INSTALLED AT ALL ROOF/WALL INTERSECTIONS.

O STANDING SEAM METAL ROOF, INSTALL PER MANUFACTURER'S WRITTEN INSTRUCTIONS.

III DECORATIVE WROUGHT IRON. SEE DETAILS.

SIDING:

LOCAL CODES

FIBER CEMENT SHAKE SIDING PER DEVELOPER

W 5/4x4 CORNER TRIM BOARDS.

| BET STATE | BOARDS | BOARD

W/ 5/4x4 CORNER TRIM BOARDS.

FIBER CEMENT WAVY SIDING PER DEVELOPER
W/ 5/4x4 CORNER TRIM BOARDS.

FIBER CEMENT PANEL SIDING W/ IX3 BATTS AT I2" O.C. (VINYL BOARD AND BATT SIDING)

If IX FIBER CEMENT TRIM OR EQUAL, U.N.O. SIZE AS NOTED


IT FALSE WOOD SHUTTERS, TYPE AS SHOWN. SIZE AS NOTED.


ALL WINDOWS WHOSE OPENING IS LESS THAN 24" ABOVE THE FINISH FLOOR AND WHOSE OPENING IS GREATER THAN 72" ABOVE THE OUTSIDE WALKING SURFACE MUST HAVE WINDOW OPENING LIMITING DEVICES COMPLYING WITH

AVAILABLE WITH OPTIONAL 9'-1" FIRST FLOOR PLATE

NOTES AT OPT 9'-1" PLT:

- WDW HT SET AT 7'-6"
- INTERIOR SOFFITS AT 8'-0"
- EXTERIOR SOFFITS AT 8'-0"

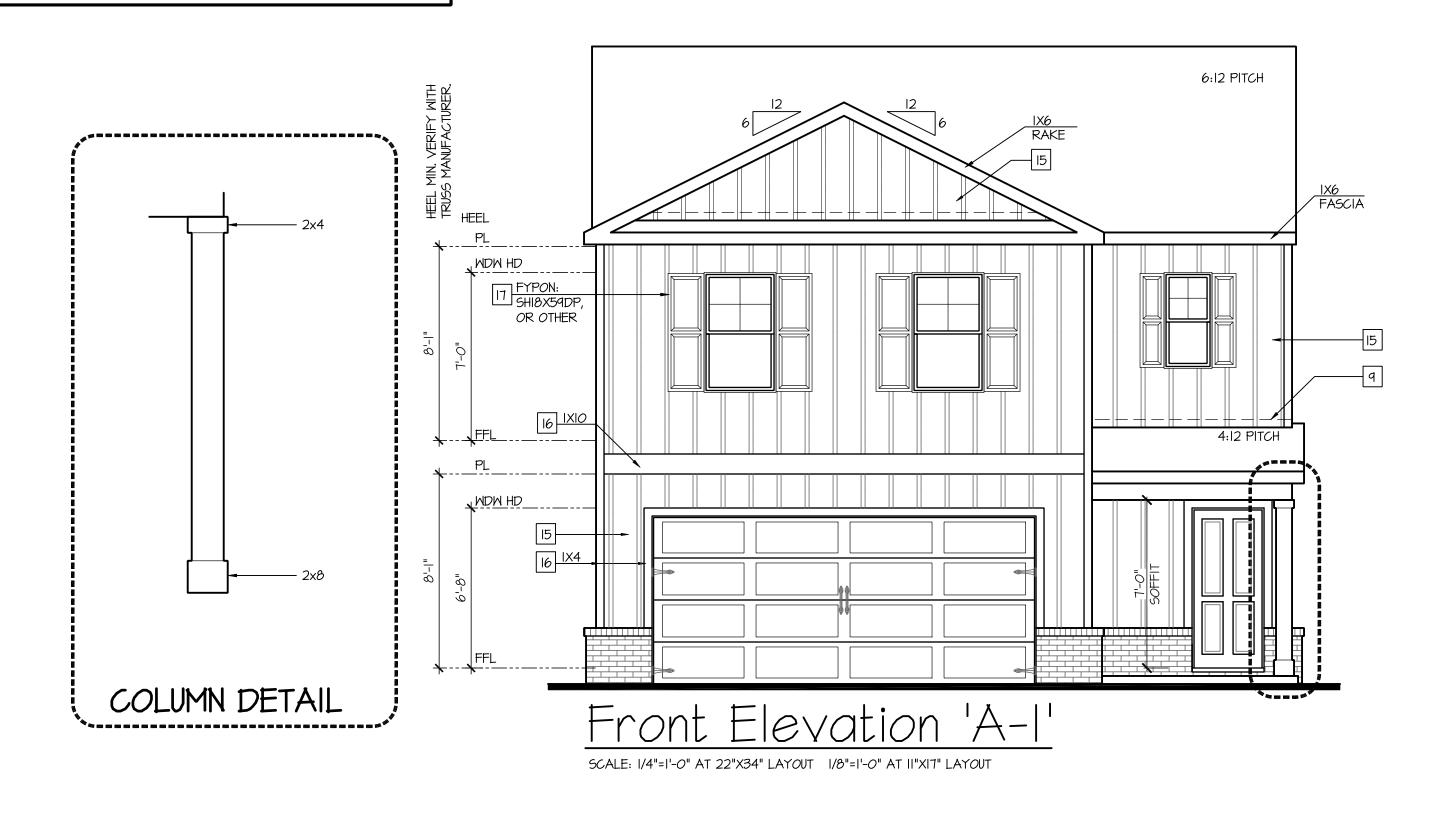

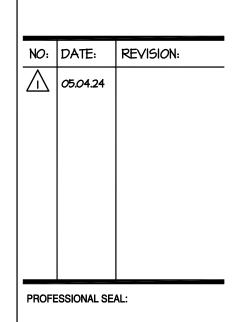

PROJECT TITLE:

30' Series

FOR CONSTRUCTION

CLIENTS NAME:



PROJECT NO: GMD14065

SHEET TITLE:

'TAYLOR'

EXTERIOR

ELEVATIONS

'3EFF-A'

PRINT DATE:

May 02, 2024

ET NO:

A

NOTES: IRC - GRADE CONDITIONS MAY VARY FOR INDIVIDUAL SITE FROM THAT SHOWN. BUILDER SHALL VERIFY AND COORDINATE PER ACTUAL SITE CONDITIONS. - WINDOW HEAD HEIGHTS: IST FLOOR = 7'-0" U.N.O. ON ELEVATIONS. 2ND FLOOR = 7'-0" U.N.O. ON ELEVATIONS. - ROOFING: PITCHED SHINGLES PER DEVELOPER. - WINDOWS: MANUFACTURER PER DEVELOPER. DIVIDED LITES AS SHOWN ON THE EXTERIOR ELEVATIONS - ENTRY DOOR: AS SELECTED BY DEVELOPER. - GARAGE DOORS: AS SELECTED BY DEVELOPER, RAISED PANEL AS SHOWN. - CHIMNEY AS OCCURS: TOP OF CHIMNEYS TO BE A MINIMUM OF 24" ABOVE ANY ROOF WITHIN 10'-0" OF CHIMNEY. - ALL EXTERIOR MATERIALS TO BE INSTALLED PER MANUFACTURER'S WRITTEN INSTRUCTIONS. PROTECTION AGAINST DECAY: (ALL PORTIONS OF A PORCH, SCREEN PORCH OR DECK FROM THE BOTTOM OF THE HEADER DOWN, INCLUDING POST, RAILS, PICKETS, STEPS AND FLOOR STRUCTURE.) KEY NOTES: MASONRY: ADHERED STONE VENEER AS SELECTED BY DEVELOPER. HEIGHT AS NOTED. 2 MASONRY FULL BRICK AS SELECTED BY DEVELOPER. HEIGHT AS NOTED. 3 MASONRY FULL STONE AS SELECTED BY DEVELOPER. HEIGHT AS NOTED. 4 8" SOLDIER COURSE. 5 ROWLOCK COURSE 6 DECORATIVE KEY. SEE DETAIL. TYPICALS: 7 CORROSION RESISTANT SCREEN LOUVERED VENTS, SIZE AS NOTED. 8 CODE APPROVED TERMINATION CHIMNEY CAP. 9 CORROSION RESISTANT ROOF TO WALL FLASHING. CODE COMPLIANT FLASHING MUST BE INSTALLED AT ALL ROOF/WALL INTERSECTIONS. O STANDING SEAM METAL ROOF, INSTALL PER MANUFACTURER'S WRITTEN INSTRUCTIONS. II DECORATIVE WROUGHT IRON. SEE DETAILS. 12 FIBER CEMENT SHAKE SIDING PER DEVELOPER W/ 5/4x4 CORNER TRIM BOARDS. 13 FIBER CEMENT LAP SIDING PER DEVELOPER W/ 5/4x4 CORNER TRIM BOARDS. 14 FIBER CEMENT WAVY SIDING PER DEVELOPER W/ 5/4x4 CORNER TRIM BOARDS. 15 FIBER CEMENT PANEL SIDING W/ IX3 BATTS AT 12" O.C. (VINYL BOARD AND BATT SIDING) 16 IX FIBER CEMENT TRIM OR EQUAL, U.N.O. SIZE AS NOTED 17 FALSE WOOD SHUTTERS, TYPE AS SHOWN. SIZE AS NOTED. ALL WINDOWS WHOSE OPENING IS LESS THAN 24" ABOVE THE FINISH FLOOR AND WHOSE OPENING IS GREATER THAN


72" ABOVE THE OUTSIDE WALKING SURFACE MUST HAVE WINDOW OPENING LIMITING DEVICES COMPLYING WITH

LOCAL CODES

AVAILABLE WITH OPTIONAL 9'-1" FIRST FLOOR PLATE

NOTES AT OPT 9'-1" PLT:

- WDW HT SET AT 7'-6"
- INTERIOR SOFFITS AT 8'-0"
- EXTERIOR SOFFITS AT 8'-0"

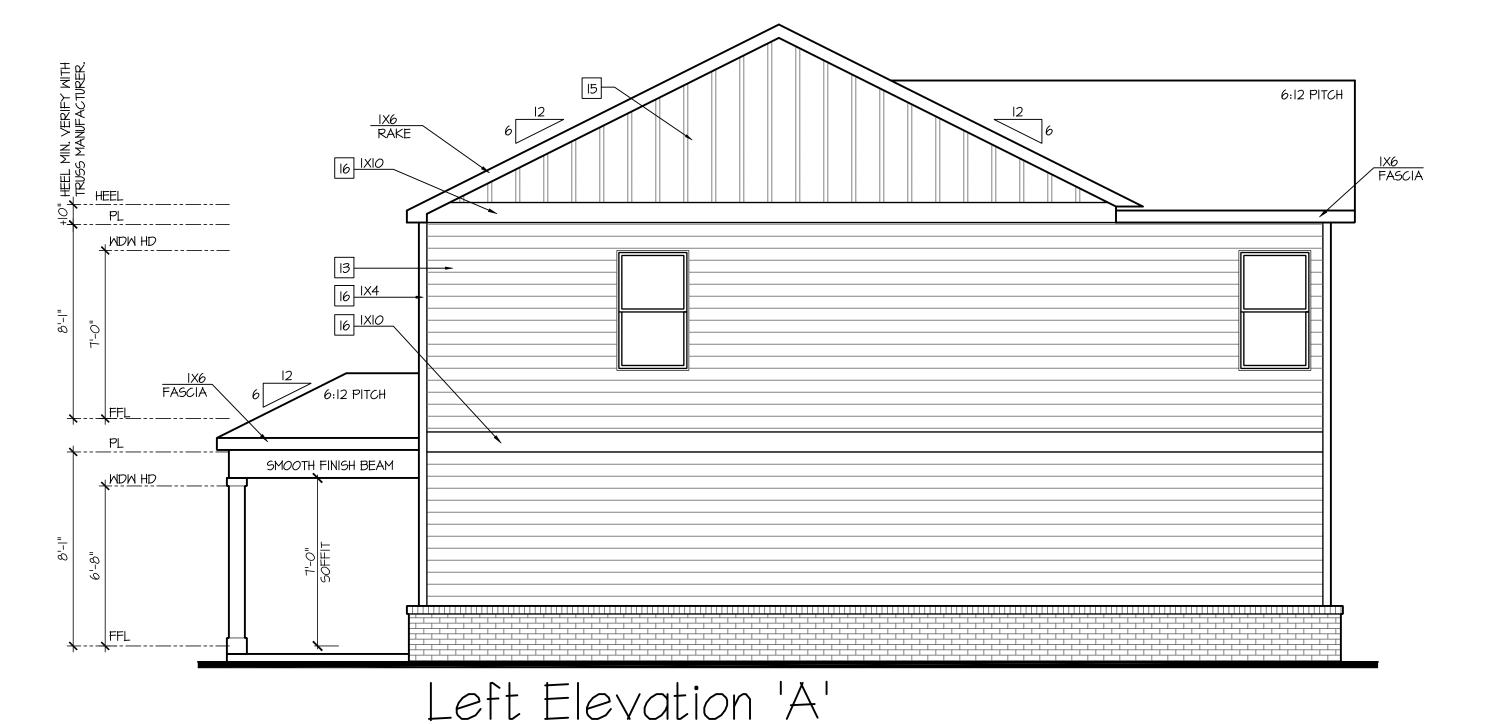

SCALE: I/4"=I'-0" AT 22"X34" LAYOUT I/8"=I'-0" AT II"XI7" LAYOUT

6:12 PITCH IX6 FASCIA MDW HD 6:12 PITCH SMOOTH FINISH BEAM MDM HD

Right Elevation 'A'



NO: DATE: REVISION: 05.04.24 PROFESSIONAL SEAL:

PROJECT TITLE:

30' Series

FOR CONSTRUCTION

CLIENTS NAME:



PROJECT NO: GMD14065

'TAYLOR' **EXTERIOR** ELEVATIONS '3EFF-A'

FOR ADDITIONAL NOTES SEE GENERAL NOTES ON TITLE SHEET AND DETAILS WINDOW HEAD HEIGHTS: IST FLOOR = 7'-0" U.N.O. ON ELEVATIONS. 2ND FLOOR = 7'-0" U.N.O. ON ELEVATIONS. ALL DIMENSIONS TO WINDOWS AND DOORS ARE TO CENTERLINE. WALL LEGEND: ----FULL HEIGHT FULL HEIGHT 2X6 WOOD STUD PARTITION 2X4 WOOD STUD PARTITION STUD WALL BELOW HEIGHT AND STUD SIZE AS NOTED BRICK / STONE VENEER _____ LOW GYPSUM BOARD WALL DRYWALL OPENING. HEIGHT HEIGHT AND STUD SIZE AS NOTED AS NOTED ON PLAN. KEY NOTES: FIRE PROTECTION: HOUSE TO GARAGE FIRE SEPARATION. GARAGE/HOUSE SEPARATION
AT VERTICAL SURFACES SHALL BE PROTECTED WITH ONE (I) LAYER I/2" GYPSUM BOARD. (PER LOCAL CODES) GARAGE/HOUSE SEPARATION AT HORIZONTIAL SURFACES SHALL BE PROTECTED WITH ONE (I) LAYER 5/8" TYPE 'X' GYPSUM BOARD. (PER LOCAL CODES) 7 HOUSE TO GARAGE DOOR SEPARATION. PROVIDE 1-3/8" SOLID CORE DOOR OR APPROVED 20 MINUTE RATED DOOR. (PER LOCAL CODES) BENEATH STAIRS AND LANDINGS. I/2" GYPSUM BOARD ON WALLS AND CEILING OF ENCLOSED ACCESSIBLE AREAS. (PER LOCAL CODES) 4 GAS WATER HEATER ON 18" HIGH PLATFORM. (PER LOCAL CODES) FAU 8'X8' PLATFORM. VERIFY WITH TRUSS MANUFACTURER. (6'-6" MIN. CLEAR HEIGHT TO HORIZONTAL MEMBERS, 2"X6" OVER 2"X4" BOTTOM CHORD. OF TRUSS, VERIFY W/ TRUSSES.) 6 A/C CONDENSER PAD. (VERIFY) 7 PRE-FABRICATED METAL FIREPLACE. INSTALL PER MANUFACTURER'S WRITTEN INSTRUCTIONS. 8 ATTIC ACCESS LARGE ENOUGH TO REMOVE LARGEST PIECE OF EQUIPMENT BUT NOT LESS THAN 30"x22". FIRE RATED ACCESS AS NOTED. (PER LOCAL CODES) ATTIC ACCESS LADDER, VERIFY LOCATION AND SIZE WITH TRUSSES. (25 I/2" X 54" SIZE.) TYPICALS: 1 TEMPERED SAFETY GLASS. (PER LOCAL CODES) 10 PLYWOOD SHELF ABOVE WITH DRYWALL FINISH OVER. HEIGHT AS NOTED. II HALF WALL, HEIGHT AS NOTED. 12 INTERIOR SOFFITS: FFL = 7'-6" U.N.O. SFL = 7'-6" U.N.O. BATHS: 13 SHOWER. TEMPERED GLASS ENCLOSURE.

14 TUB-SHOWER COMBO. TEMPERED GLASS ENCLOSURE.

16 ACRYLIC TUB W/ CERAMIC PLATFORM

18 30" GAS COOKTOP AND HOOD.

19 ELECTRIC OVEN WITH MICROWAVE OVEN.

KITCHEN:

15 CERAMIC TILE SHOWER AND FLOOR. TEMPERED GLASS ENCLOSURE.

30" SLIDE-IN ELECTRICAL RANGE W HOOD AND MICRO ABV. VENT PER MANUFACTURER'S WRITTEN INSTRUCTIONS.

VENT PER MANUFACTURER'S WRITTEN INSTRUCTIONS.


8'-I" STAIR NOTE:

(USE 16" TJI WITH 3/4" PLYWOOD SUBFLOOR) 15 TREADS AT IO" EACH VERIFY 16 RISERS AT +/- 7.11" = 113 3/4" TOTAL RISE VERIFY

9'-1" STAIR NOTE:

(USE 14" TJI WITH 3/4" PLYWOOD SUBFLOOR) 16 TREADS AT IO" EACH VERIFY 17 RISERS AT +/- 7.28" = 123 3/4" TOTAL RISE VERIFY


> -STEPS MAY OCCUR, SEE CIVIL DRAWINGS. PROVIDE HANDRAIL AND GUARDRAIL PER LOCAL CODE. garage 3050 JSH 8'-8" 6'-0" 6'-0" 20'-8" Opt Side Load Garage A SCALE: 1/4"=1'-0" AT 22"X34" LAYOUT 1/8"=1'-0" AT 11"X17" LAYOUT

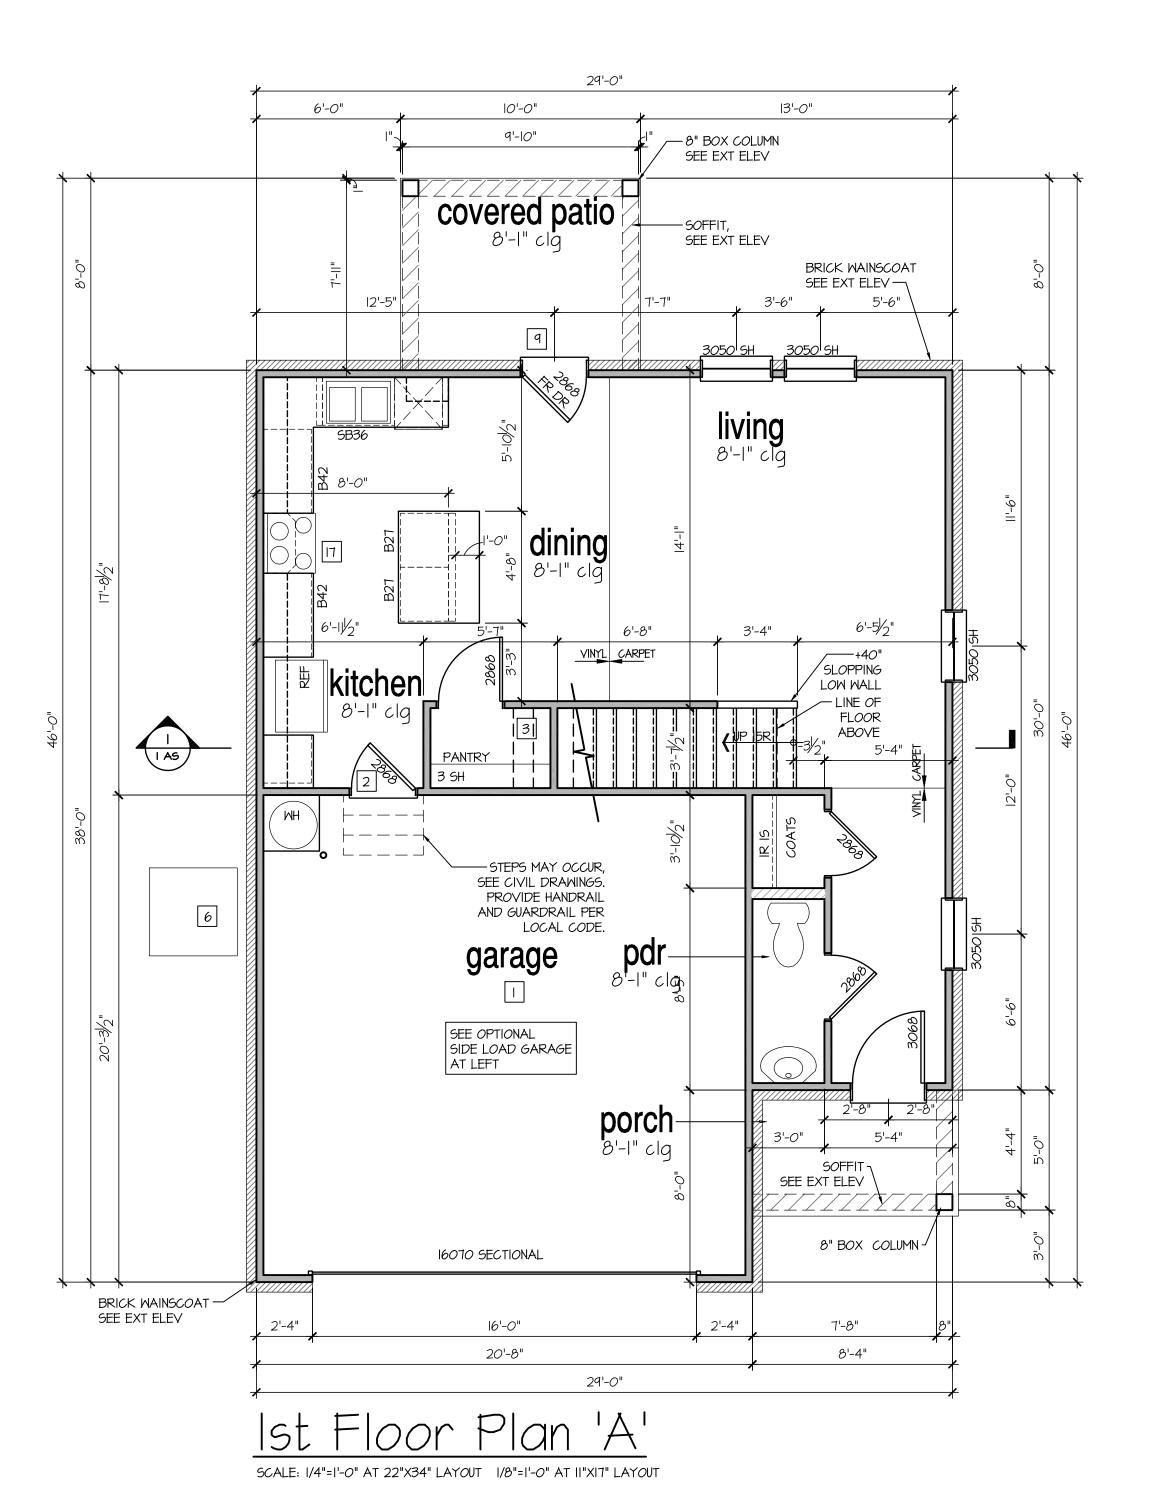



NOTES AT OPT 9'-1" PLT:

- WDW HT SET AT 7'-6"
- INTERIOR SOFFITS AT 8'-0"
- EXTERIOR SOFFITS AT 8'-0"

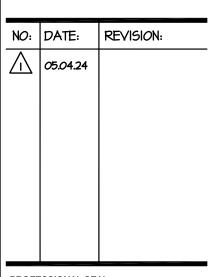

PROFESSIONAL SEAL:

PROJECT TITLE:

30' Series

FOR CONSTRUCTION

CLIENTS NAME:



PROJECT NO: GMD14065

SHEET TITLE: 'TAYLOR' 1st FLOOR PLAN '3EFF-A'

PRINT DATE:

9'-1" STAIR NOTE: (USE 14" TJ<u>I WITH 3/4" PLYWOOD SUBFLOOR)</u> 16 TREADS AT 10" EACH VERIFY 17 RISERS AT +/- 7.28" = 123 3/4" TOTAL

FOR ADDITIONAL NOTES SEE GENERAL NOTES ON TITLE SHEET AND DETAILS.

RISE VERIFY

WINDOW HEAD HEIGHTS: IST FLOOR = 7'-0" U.N.O. ON ELEVATIONS. 2ND FLOOR = 7'-0" U.N.O. ON ELEVATIONS.

ALL DIMENSIONS TO WINDOWS AND DOORS ARE TO CENTERLINE.

WALL LEGEND:

FULL HEIGHT 2X4 WOOD STUD PARTITION

BRICK / STONE VENEER

FULL HEIGHT 2X6 WOOD STUD PARTITION

STUD WALL BELOW HEIGHT AND STUD SIZE AS NOTED

LOW GYPSUM BOARD WALL HEIGHT AND STUD SIZE AS NOTED

DRYWALL OPENING. HEIGHT AS NOTED ON PLAN.

KEY NOTES:

FIRE PROTECTION:

HOUSE TO GARAGE FIRE SEPARATION. GARAGE/HOUSE SEPARATION AT VERTICAL SURFACES SHALL BE PROTECTED

WITH ONE (I) LAYER I/2" GYPSUM BOARD. (PER LOCAL CODES) GARAGE/HOUSE SEPARATION AT HORIZONTIAL SURFACES SHALL BE PROTECTED WITH ONE (I) LAYER 5/8"

TYPE 'X' GYPSUM BOARD. (PER LOCAL CODES) HOUSE TO GARAGE DOOR SEPARATION. PROVIDE I-3/8" SOLID CORE DOOR OR APPROVED 20 MINUTE RATED DOOR. (PER LOCAL CODES)

BENEATH STAIRS AND LANDINGS. I/2" GYPSUM BOARD ON WALLS AND CEILING OF ENCLOSED ACCESSIBLE AREAS. (PER LOCAL CODES)

MEP'S

4 GAS WATER HEATER ON 18" HIGH PLATFORM. (PER LOCAL CODES)

5 FAU 8'X8' PLATFORM. VERIFY WITH TRUSS MANUFACTURER. (6'-6" MIN. CLEAR HEIGHT TO HORIZONTAL MEMBERS, 2"X6" OVER 2"X4" BOTTOM CHORD. OF TRUSS, VERIFY W/ TRUSSES.)

7 PRE-FABRICATED METAL FIREPLACE.

6 A/C CONDENSER PAD. (VERIFY)

INSTALL PER MANUFACTURER'S WRITTEN INSTRUCTIONS.

8 ATTIC ACCESS LARGE ENOUGH TO REMOVE LARGEST PIECE OF EQUIPMENT BUT NOT LESS THAN 30"x22". FIRE RATED ACCESS AS NOTED. (PER LOCAL CODES) ATTIC ACCESS LADDER, VERIFY LOCATION AND SIZE WITH TRUSSES. (25 I/2" X 54" SIZE.) TYPICALS:

1 TEMPERED SAFETY GLASS. (PER LOCAL CODES)

PLYWOOD SHELF ABOVE WITH DRYWALL FINISH OVER. HEIGHT AS NOTED.

III HALF WALL, HEIGHT AS NOTED.

12 INTERIOR SOFFITS: FFL = 7'-6" U.N.O. SFL = 7'-6" U.N.O. BATHS:

13 SHOWER. TEMPERED GLASS ENCLOSURE.

14 TUB-SHOWER COMBO. TEMPERED GLASS ENCLOSURE.

15 CERAMIC TILE SHOWER AND FLOOR. TEMPERED GLASS ENCLOSURE.


6 ACRYLIC TUB W/ CERAMIC PLATFORM


KITCHEN:

[1] 30" SLIDE-IN ELECTRICAL RANGE W HOOD AND MICRO ABV. VENT PER MANUFACTURER'S WRITTEN INSTRUCTIONS.

18 30" GAS COOKTOP AND HOOD. VENT PER MANUFACTURER'S WRITTEN INSTRUCTIONS.

19 ELECTRIC OVEN WITH MICROWAVE OVEN.

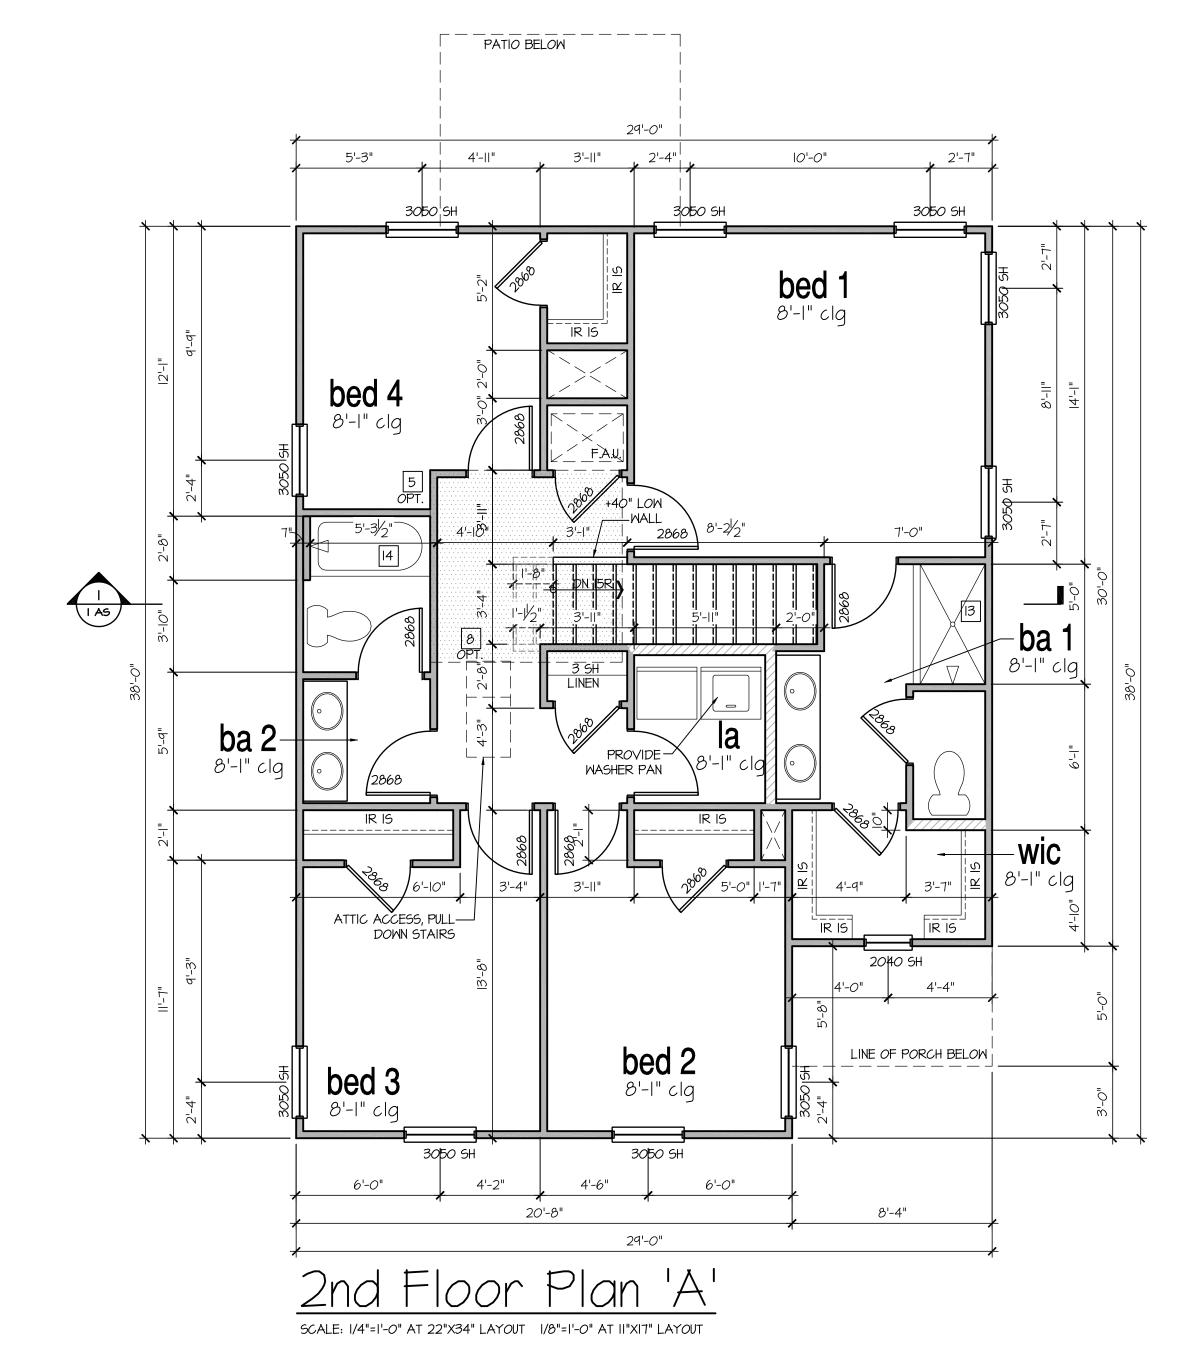

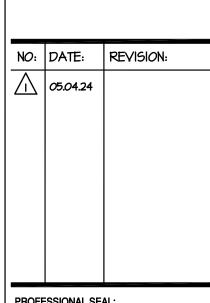

PROFESSIONAL SEAL:

PROJECT TITLE:

30' Series

FOR CONSTRUCTION

CLIENTS NAME:



PROJECT NO: GMD14065

SHEET TITLE: 'TAYLOR' 2nd FLOOR PLAN '3EFF-A'

PRINT DATE:

NOTES: IRC

- GRADE CONDITIONS MAY VARY FOR INDIVIDUAL SITE FROM THAT SHOWN. BUILDER SHALL VERIFY AND COORDINATE PER ACTUAL SITE CONDITIONS.

- MINDOW HEAD HEIGHTS:

IST FLOOR = 7'-0" U.N.O. ON ELEVATIONS. 2ND FLOOR = 7'-0" U.N.O. ON ELEVATIONS.

- ROOFING: PITCHED SHINGLES PER DEVELOPER.

- WINDOWS: MANUFACTURER PER DEVELOPER, DIVIDED LITES AS SHOWN ON THE EXTERIOR ELEVATIONS - ENTRY DOOR: AS SELECTED BY DEVELOPER.

- GARAGE DOORS: AS SELECTED BY DEVELOPER, RAISED PANEL AS SHOWN.

- CHIMNEY AS OCCURS: TOP OF CHIMNEYS TO BE A MINIMUM OF 24" ABOVE ANY ROOF

WITHIN 10'-0" OF CHIMNEY.

ALL EXTERIOR MATERIALS TO BE INSTALLED PER MANUFACTURER'S WRITTEN INSTRUCTIONS.

PROTECTION AGAINST DECAY:
(ALL PORTIONS OF A PORCH, SCREEN PORCH OR DECK FROM THE BOTTOM OF

THE HEADER DOWN, INCLUDING POST, RAILS, PICKETS, STEPS AND FLOOR STRUCTURE.)

KEY NOTES:

MASONRY:

ADHERED STONE VENEER AS SELECTED BY DEVELOPER, HEIGHT AS NOTED.

2 MASONRY FULL BRICK AS SELECTED BY DEVELOPER. HEIGHT AS NOTED.

3 MASONRY FULL STONE AS SELECTED BY DEVELOPER, HEIGHT AS NOTED.

4 8" SOLDIER COURSE.

5 ROWLOCK COURSE
6 DECORATIVE KEY. SEE DETAIL.

TYPICALS:

TO CORROSION RESISTANT SCREEN LOUVERED VENTS, SIZE AS NOTED.

ODE APPROVED TERMINATION CHIMNEY CAP.

 CORROSION RESISTANT ROOF TO WALL FLASHING. CODE COMPLIANT FLASHING MUST BE INSTALLED AT ALL ROOF/WALL INTERSECTIONS.

TO STANDING SEAM METAL ROOF, INSTALL PER MANUFACTURER'S WRITTEN INSTRUCTIONS.

III DECORATIVE WROUGHT IRON. SEE DETAILS.

SIDING

LOCAL CODES

FIBER CEMENT SHAKE SIDING PER DEVELOPER

W 5/4x4 CORNER TRIM BOARDS.

13 FIBER CEMENT LAP SIDING PER DEVELOPER

W 5/4x4 CORNER TRIM BOARDS.

14 FIBER CEMENT WAYY SIDING PER DEVELOPER

W 5/4x4 CORNER TRIM BOARDS.

FIBER CEMENT PANEL SIDING W/ IX3 BATTS AT I2" O.C. (VINYL BOARD AND BATT SIDING)

I6 IX FIBER CEMENT TRIM OR EQUAL, U.N.O. SIZE AS NOTED
IT FALSE WOOD SHUTTERS, TYPE AS SHOWN. SIZE AS NOTED.

ALL WINDOWS WHOSE OPENING IS LESS THAN 24" ABOVE THE FINISH FLOOR AND WHOSE OPENING IS GREATER THAN 72" ABOVE THE OUTSIDE WALKING SURFACE MUST HAVE WINDOW OPENING LIMITING DEVICES COMPLYING WITH


AVAILABLE WITH OPTIONAL 9'-1" FIRST FLOOR PLATE


NOTES AT OPT 9'-1" PLT:

- WDW HT SET AT 7'-6"

- INTERIOR SOFFITS AT 8'-0"

- EXTERIOR SOFFITS AT 8'-0"

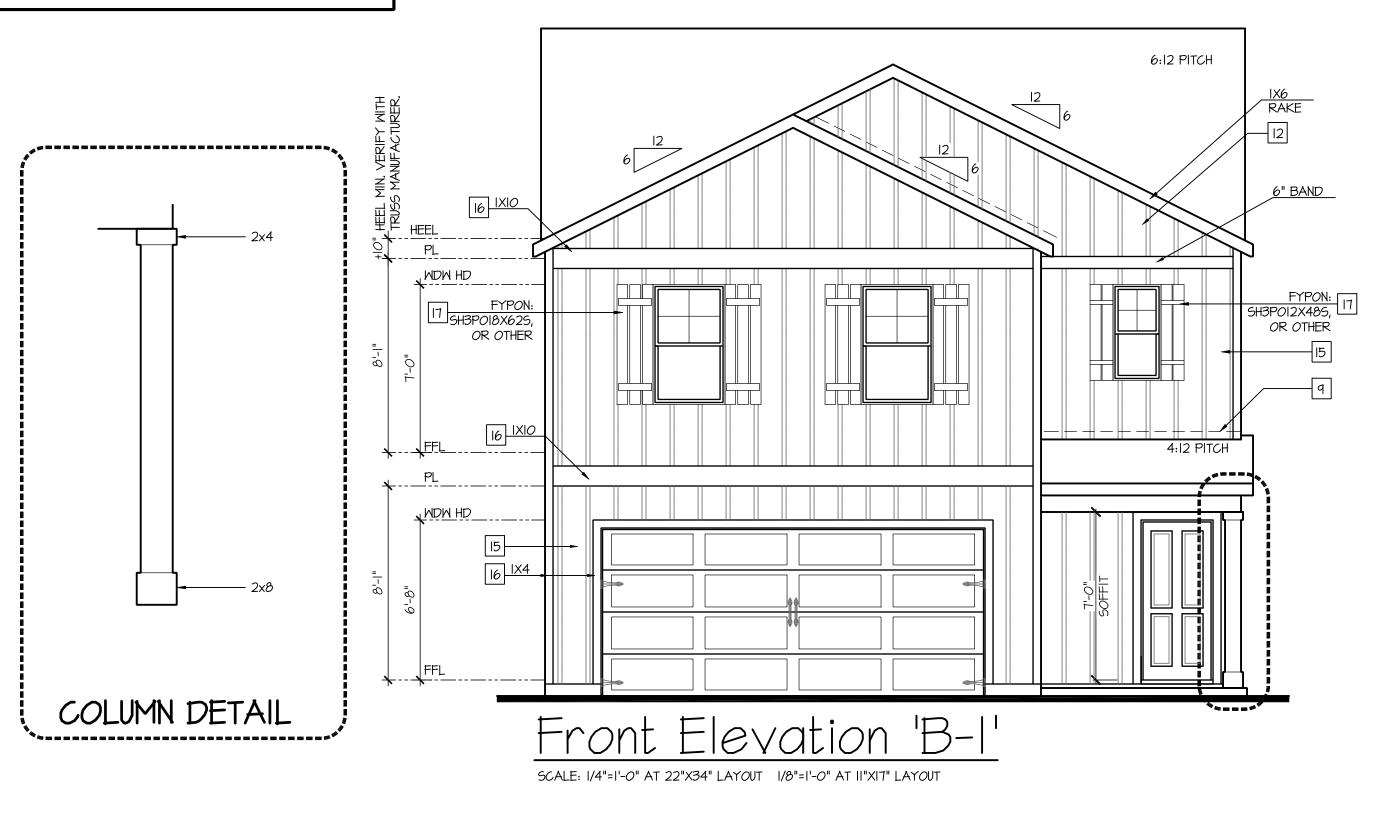

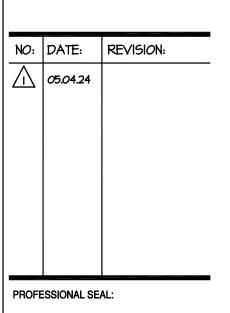

PROJECT TITLE:

30' Series

FOR CONSTRUCTION

CLIENTS NAME:



PROJECT NO: GMD 14065

SHEET TITLE:

'TAYLOR'

EXTERIOR

ELEVATIONS

'3EFF-B'

PRINT DATE:

May 02, 2024

ET NO:

В

ATTIC VENT CALCULATION FOR MODEL 'TAYLOR': 1:150 RATIO.

THE NET FREE VENTILATING AREA SHALL NOT BE LESS THAN 1/150 OF THE AREA OF THE SPACE VENTILATED. GENERAL CONTRACTOR SHALL VERIFY THE NET FREE VENTILATION OF THE VENT PRODUCT SELECTED BY OWNER. VERIFY WITH MANUFACTURER OF HIGH AND LOW VENTS TO BE USED FOR MINIMUM CALCULATED VENTS REQUIRED. THE REQUIRED VENTILATION SHALL BE MAINTAINED. PROVIDE INSULATION STOP SUCH THAT INSULATION DOES NOT OBSTRUCT FREE AIR MOVEMENT AS REQUIRED

BY THE BUILDING OFFICIAL. ALL OVERLAP FRAMED ROOF AREAS SHALL HAVE OPENINGS BETWEEN THE ADJACENT ATTICS IN THE ROOF SHEATHING (AS ALLOWED BY THE STRUCTURAL ENGINEER) TO ALLOW PASSAGE AND ATTIC VENTILATION BETWEEN THE TWO OR ISOLATED ATTIC SPACES SHALL BE VENTED INDEPENDENTLY TO CBC REQUIREMENTS. PER DEVELOPER, AT ALL CANTILEVERED FLOORS, CANTILEVERED ARCHITECTURAL POP-OUTS, AND ANY DOUBLE FRAMING PROJECTIONS THAT ARE SEPARATED FROM THE

VENTING CALCULATIONS SHOWN ABOVE, PROVIDE A CONTINUOUS 2" CORROSION RESISTANT SOFFIT VENT AT UNDERSIDE OF FRAMED ELEMENT.

(PER IRC SECTION R806.2)

I SQUARE INCH VENT FOR EVERY 150 SQUARE INCHES OF CEILING *144 SQ. IN. = 1 SQ. FT.

BLDG. CEILING (SF) X 144 = BLDG (SQ. IN.) BLDG. (SQ. IN.) / 150 = SQ. IN. OF VENT REQUIRED

SQ. IN. OF VENT REQUIRED / 2 = 50% AT HIGH & 50% AT LOW. ROOF AREA I:= 1035 SQ. FT. X 144 = 149040 SQ. IN. 149040 SQ. IN. / 150 = 993.60 SQ. IN. OF VENT REQ'D

ROOF AREA 2:= 42 SF 42 SQ. FT. X I44 = 6048 SQ. IN. 6048 SQ. IN. / I50 = 40.32 SQ. IN. OF VENT REQ'D

ROOF AREA 3:=80 SQ. FT. X I44 = II520 SQ. IN.
II520 SQ. IN. / I50 = 76.80 SQ. IN. OF VENT REQ'D

BUILDER TO PROVIDE ATTIC VENTING MINIMUM AREA PER LOCAL CODE WITH THE AMOUNT/NUMBER VENTS AND TYPE OF VENTING USED PER THE WRITTEN MANUFACTURER'S SPECIFICATIONS PRIOR TO THE FINISH OF ROOFING MATERIAL

ALL ROOF DRAINAGE SHALL BE PIPED TO STREET OR APPROVED DRAINAGE FACILITY.

- DASHED LINES INDICATE WALL BELOW. - LOCATE GUTTER AND DOWNSPOUTS PER BUILDER. PITCHED ROOFS AS NOTED.

- TRUSS MANUFACTURER SHALL SUBMIT STRUCTURAL CALCS AND SHOP DRAWINGS TO THE BUILDER'S GENERAL CONTRACTOR AND BUILDING DEPARTMENT FOR REVIEW PRIOR TO FABRICATIONS.

- ALL PLUMBING VENTS SHALL BE COMBINED INTO A MINIMUM AMOUNT OF ROOF PENETRATIONS. ALL ROOF PENETRATIONS SHALL OCCUR TO THE REAR OF THE MAIN RIDGE.

ATTIC VENT CALCULATION FOR MODEL 'TAYLOR': 1:300 RATIO.

AS AN ALTERNATE TO THE 1/150 RATIO LISTED ABOVE, THE NET FREE CROSS-VENTILATION AREA MAY BE REDUCED TO 1/300 PER IRC SECTION R806.2

GENERAL CONTRACTOR SHALL VERIFY THE NET FREE VENTILATION OF THE VENT PRODUCT SELECTED BY OWNER. VERIFY WITH MANUFACTURER OF HIGH AND LOW VENTS TO BE USED FOR MINIMUM CALCULATED VENTS REQUIRED. THE REQUIRED VENTILATION SHALL BE MAINTAINED. PROVIDE INSULATION STOP SUCH THAT INSULATION DOES NOT OBSTRUCT FREE AIR MOVEMENT AS REQUIRED BY THE BUILDING OFFICIAL.

ALL OVERLAP FRAMED ROOF AREAS SHALL HAVE OPENINGS BETWEEN THE ADJACENT ATTICS IN THE ROOF SHEATHING (AS ALLOWED BY THE STRUCTURAL ENGINEER) TO ALLOW PASSAGE AND ATTIC VENTILATION BETWEEN THE TWO OR ISOLATED ATTIC SPACES SHALL BE VENTED INDEPENDENTLY TO CBC REQUIREMENTS.

PER DEVELOPER, AT ALL CANTILEVERED FLOORS, CANTILEVERED ARCHITECTURAL POP-OUTS, AND ANY DOUBLE FRAMING PROJECTIONS THAT ARE SEPARATED FROM THE VENTING CALCULATIONS SHOWN ABOVE, PROVIDE A CONTINUOUS 2" CORROSION RESISTANT SOFFIT VENT AT UNDERSIDE OF FRAMED ELEMENT.

(PER IRC SECTION R806.2)


I SQUARE INCH VENT FOR EVERY 300 SQUARE INCHES OF CEILING *144 SQ. IN. = 1 SQ. FT. BLDG. CEILING (SF) X 144 = BLDG (SQ. IN.) BLDG. (SQ. IN.) / 300 = SQ. IN. OF VENT REQUIRED

SQ. IN. OF VENT REQUIRED / 2 = 50% AT HIGH & 50% AT LOW. ROOF AREA I: =

ROOF AREA 2: = 42 SQ. FT. X 144 = 6048 SQ. IN.
6048 SQ. FT. / 300 = 20.16 SQ. IN. OF VENT REQ'D
20.16 SQ. IN. / 2 = 10.08 SQ. IN.
10.08 SQ. IN. OF VENT AT HIGH & 10.08 SQ. IN. OF VENT AT LOW REQUIRED.

ROOF AREA 3: =80
11520
38.40 80 SQ. FT. X 144 = 11520 SQ. IN.
11520 SQ. FT. / 300 = 38.40 SQ. IN. OF VENT REQ'D
38.40 SQ. IN. / 2 = 19.20 SQ. IN.
19.20 SQ. IN. OF VENT AT HIGH & 19.20 SQ. IN. OF VENT AT LOW REQUIRED.

BUILDER TO PROVIDE ATTIC VENTING MINIMUM AREA PER LOCAL CODE WITH THE AMOUNT/NUMBER VENTS AND TYPE OF VENTING USED PER THE WRITTEN MANUFACTURER'S SPECIFICATIONS PRIOR TO THE FINISH OF ROOFING MATERIAL.

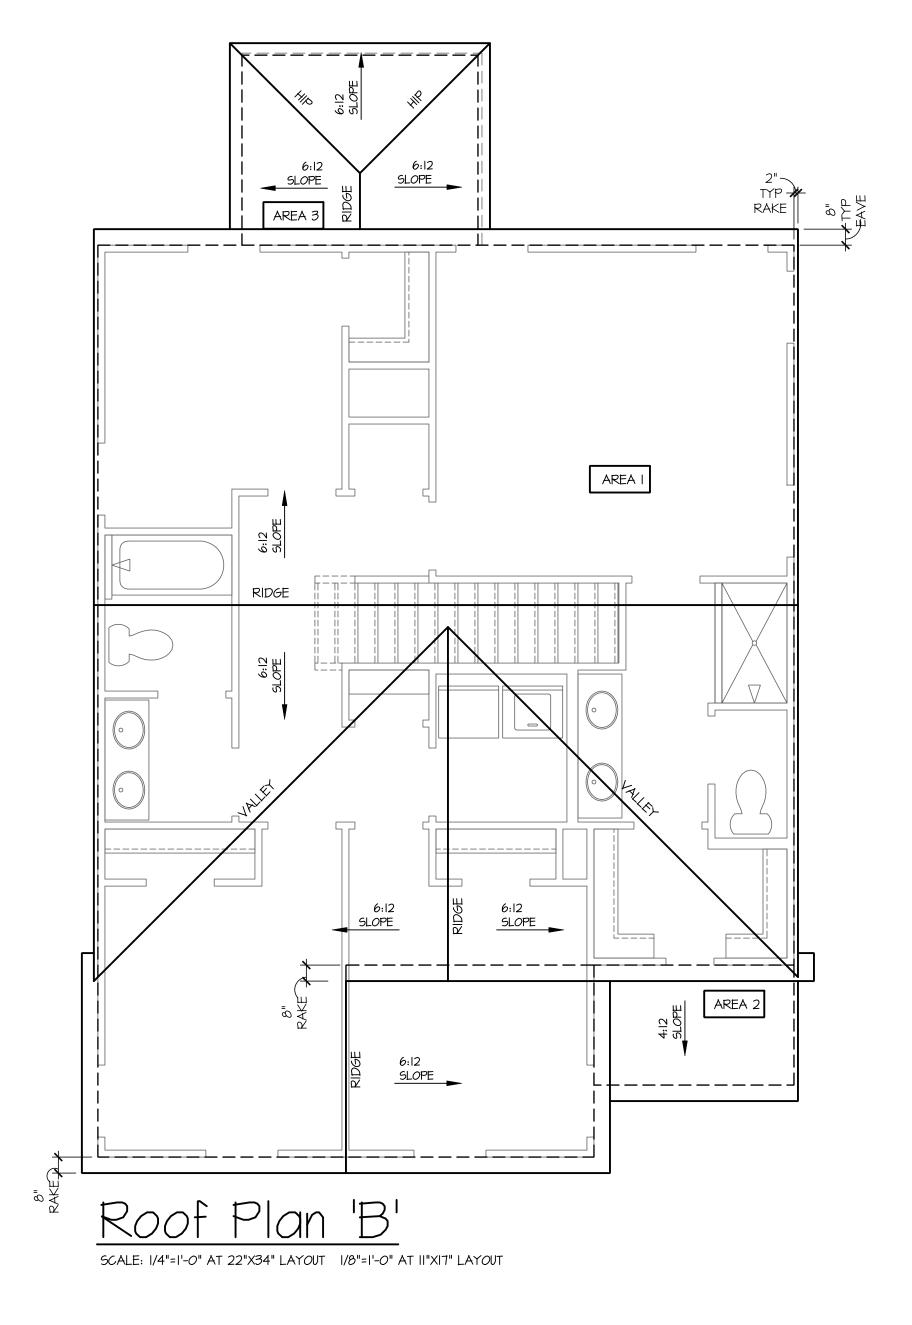

NO: DATE: REVISION: 05.04.24

PROFESSIONAL SEAL:

PROJECT TITLE:

30' Series

FOR CONSTRUCTION

CLIENTS NAME:



PROJECT NO: GMD14065

SHEET TITLE: 'TAYLOR' **ROOF PLAN** '3EFF-B'

PRINT DATE:


NOTES: IRC - GRADE CONDITIONS MAY VARY FOR INDIVIDUAL SITE FROM THAT SHOWN. BUILDER SHALL VERIFY AND COORDINATE PER ACTUAL SITE CONDITIONS. - WINDOW HEAD HEIGHTS: IST FLOOR = 7'-0" U.N.O. ON ELEVATIONS. 2ND FLOOR = 7'-0" U.N.O. ON ELEVATIONS. - ROOFING: PITCHED SHINGLES PER DEVELOPER. - WINDOWS: MANUFACTURER PER DEVELOPER. DIVIDED LITES AS SHOWN ON THE EXTERIOR ELEVATIONS - ENTRY DOOR: AS SELECTED BY DEVELOPER. - GARAGE DOORS: AS SELECTED BY DEVELOPER, RAISED PANEL AS SHOWN. - CHIMNEY AS OCCURS: TOP OF CHIMNEYS TO BE A MINIMUM OF 24" ABOVE ANY ROOF WITHIN 10'-0" OF CHIMNEY. - ALL EXTERIOR MATERIALS TO BE INSTALLED PER MANUFACTURER'S WRITTEN INSTRUCTIONS. PROTECTION AGAINST DECAY: (ALL PORTIONS OF A PORCH, SCREEN PORCH OR DECK FROM THE BOTTOM OF THE HEADER DOWN, INCLUDING POST, RAILS, PICKETS, STEPS AND FLOOR STRUCTURE.) KEY NOTES: MASONRY: ADHERED STONE VENEER AS SELECTED BY DEVELOPER. HEIGHT AS NOTED. 2 MASONRY FULL BRICK AS SELECTED BY DEVELOPER. HEIGHT AS NOTED. 3 MASONRY FULL STONE AS SELECTED BY DEVELOPER. HEIGHT AS NOTED. 4 8" SOLDIER COURSE. 5 ROWLOCK COURSE 6 DECORATIVE KEY. SEE DETAIL. TYPICALS: 7 CORROSION RESISTANT SCREEN LOUVERED VENTS, SIZE AS NOTED. 8 CODE APPROVED TERMINATION CHIMNEY CAP. GORROSION RESISTANT ROOF TO WALL FLASHING. CODE COMPLIANT FLASHING MUST BE INSTALLED AT ALL ROOF/WALL INTERSECTIONS. [IO] STANDING SEAM METAL ROOF, INSTALL PER MANUFACTURER'S WRITTEN INSTRUCTIONS. II DECORATIVE WROUGHT IRON. SEE DETAILS. 12 FIBER CEMENT SHAKE SIDING PER DEVELOPER W/5/4x4 CORNER TRIM BOARDS. 13 FIBER CEMENT LAP SIDING PER DEVELOPER W/ 5/4x4 CORNER TRIM BOARDS. 14 FIBER CEMENT WAVY SIDING PER DEVELOPER W/ 5/4x4 CORNER TRIM BOARDS. 15 FIBER CEMENT PANEL SIDING W/ IX3 BATTS AT 12" O.C. (VINYL BOARD AND BATT SIDING) 16 IX FIBER CEMENT TRIM OR EQUAL, U.N.O. SIZE AS NOTED 17 FALSE WOOD SHUTTERS, TYPE AS SHOWN. SIZE AS NOTED. ALL WINDOWS WHOSE OPENING IS LESS THAN 24" ABOVE THE FINISH FLOOR AND WHOSE OPENING IS GREATER THAN


72" ABOVE THE OUTSIDE WALKING SURFACE MUST HAVE WINDOW OPENING LIMITING DEVICES COMPLYING WITH

LOCAL CODES

AVAILABLE WITH OPTIONAL
9'-I" FIRST FLOOR PLATE

NOTES AT OPT 9'-I" PLT:
- WDW HT SET AT 7'-6"
- INTERIOR SOFFITS AT 8'-0"
- EXTERIOR SOFFITS AT 8'-0"

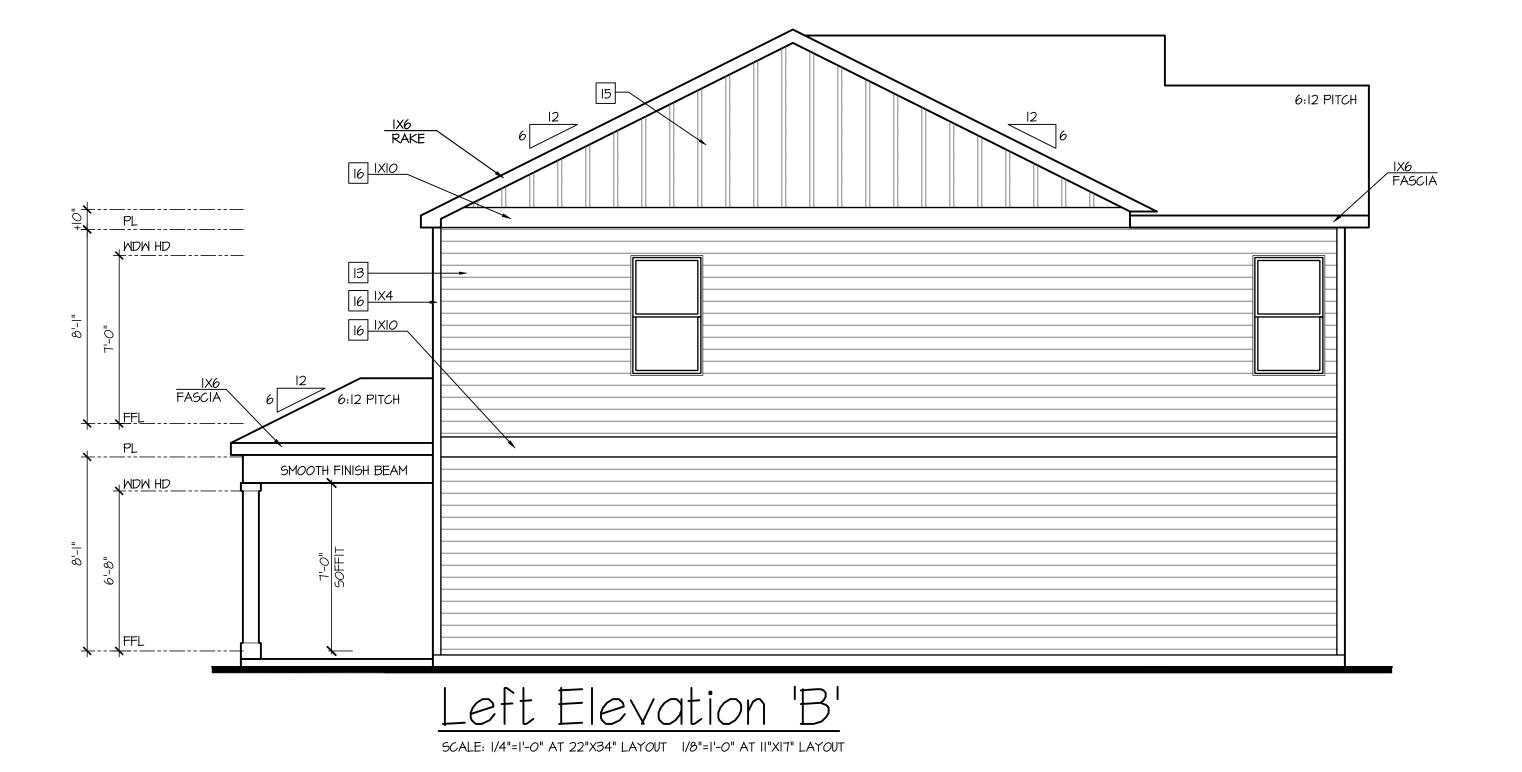

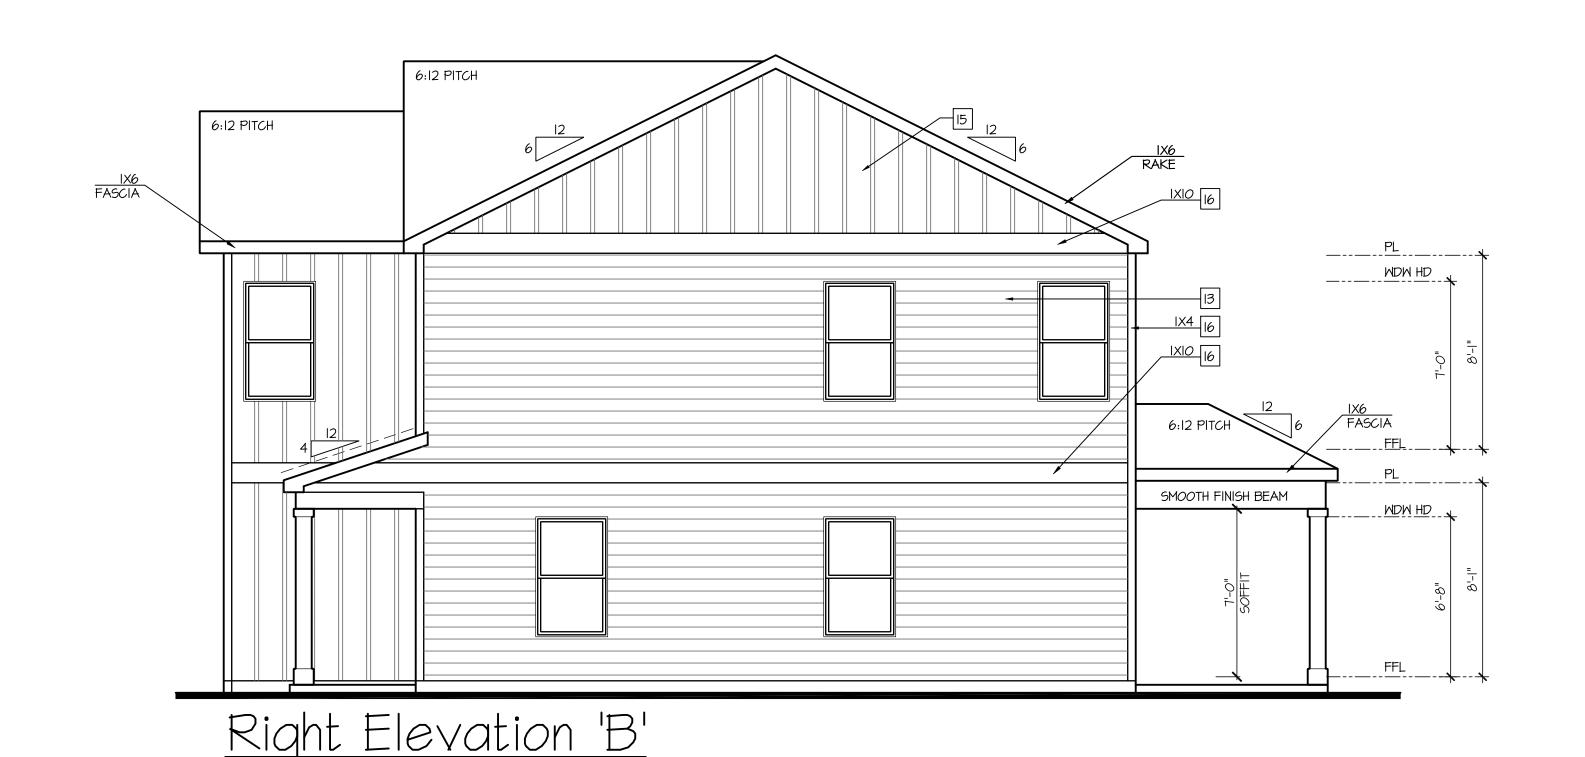



NO: DATE: REVISION:

O5.04.24

PROFESSIONAL SEAL:

PROJECT TITLE:

30' Series

FOR CONSTRUCTION

CLIENTS NAME:



PROJECT NO: GMD14065


'TAYLOR'
EXTERIOR
ELEVATIONS
'3EFF-B'

PRINT DATE:

May 02, 2024

EET NO:

2 B

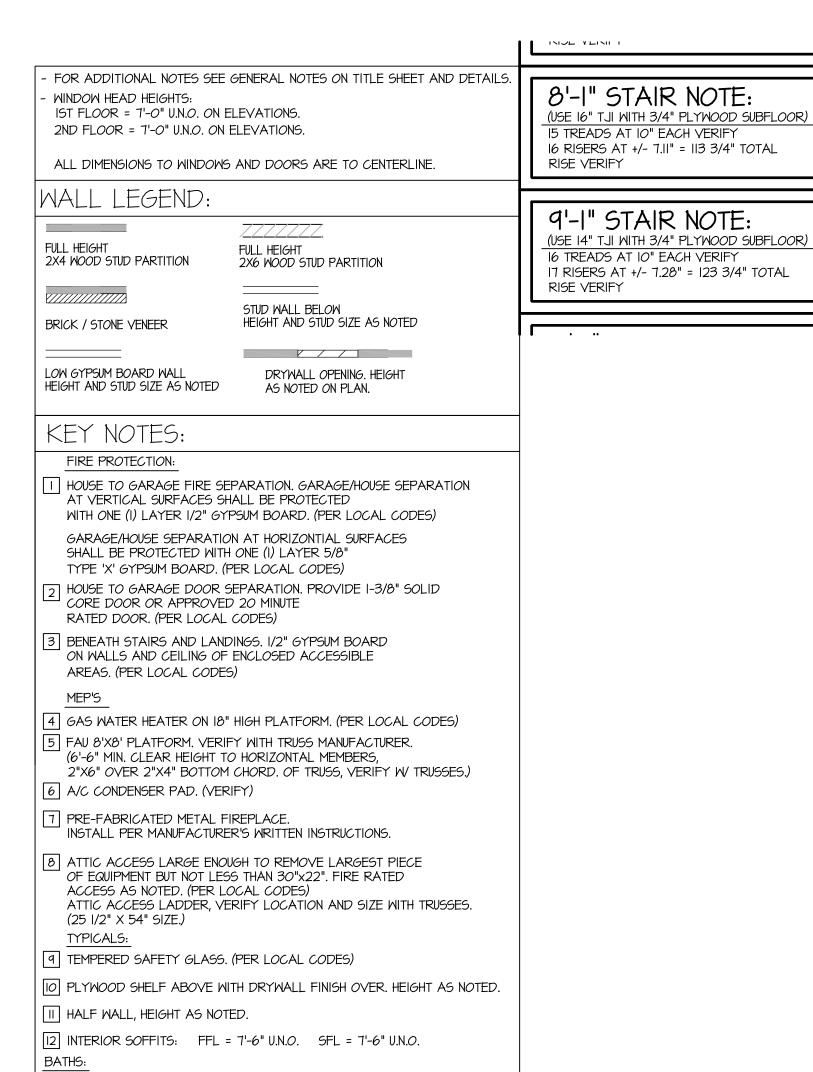

13 SHOWER. TEMPERED GLASS ENCLOSURE.

16 ACRYLIC TUB W/ CERAMIC PLATFORM

18 30" GAS COOKTOP AND HOOD.

19 ELECTRIC OVEN WITH MICROWAVE OVEN.

KITCHEN:

14 TUB-SHOWER COMBO. TEMPERED GLASS ENCLOSURE.


15 CERAMIC TILE SHOWER AND FLOOR. TEMPERED GLASS ENCLOSURE.

30" SLIDE-IN ELECTRICAL RANGE W HOOD AND MICRO ABV. VENT PER MANUFACTURER'S WRITTEN INSTRUCTIONS.

VENT PER MANUFACTURER'S WRITTEN INSTRUCTIONS.

- -- -- ---STEPS MAY OCCUR, SEE CIVIL DRAWINGS. PROVIDE HANDRAIL AND GUARDRAIL PER LOCAL CODE. garage 6'-0" 8'-8" 6'-0" 20'-8"

Opt Side Load Garage B'
SCALE: 1/4"=1'-0" AT 22"X34" LAYOUT 1/8"=1'-0" AT 11"X17" LAYOUT

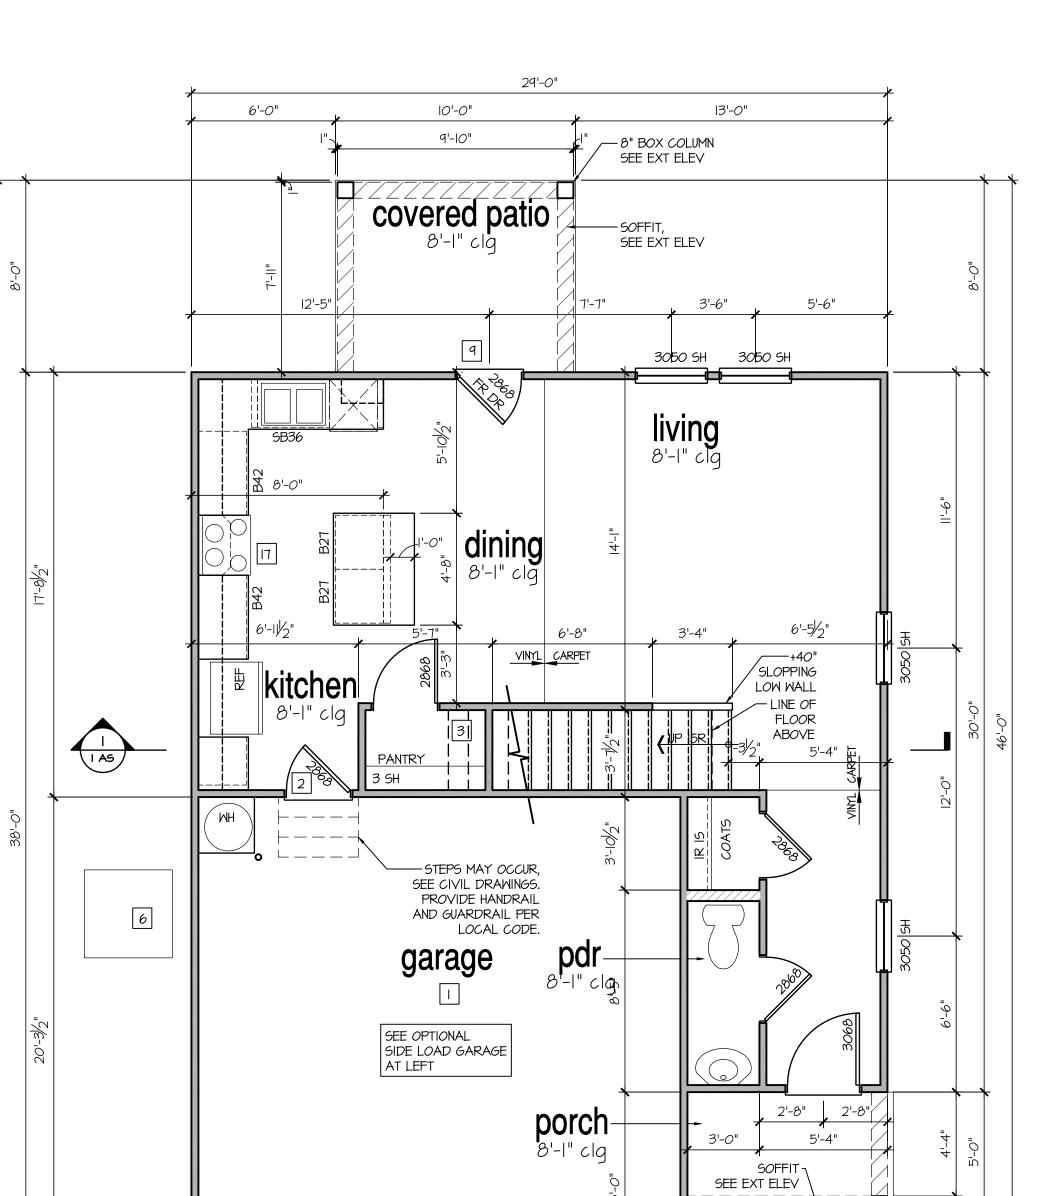

16070 SECTIONAL

16'-0"

20'-8"

SCALE: I/4"=I'-0" AT 22"X34" LAYOUT I/8"=I'-0" AT II"XIT" LAYOUT

29'-0"

2'-4"



NOTES AT OPT 9'-1" PLT:

- WDW HT SET AT 7'-6"


8" BOX COLUMN -

7'-8"

8'-4"

2'-4"

- INTERIOR SOFFITS AT 8'-0"
- EXTERIOR SOFFITS AT 8'-0"

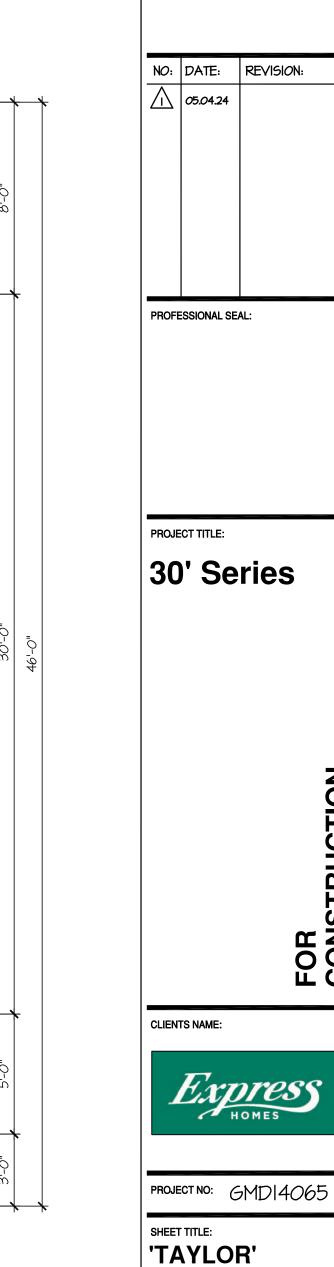

REVISION:

FOR CONSTRUCTION

4 B

May 02, 2024

1st FLOOR

PRINT DATE:

PLAN '3EFF-B'

9'-1" STAIR NOTE: (USE 14" TJI WITH 3/4" PLYWOOD SUBFLOOR) 16 TREADS AT 10" EACH VERIFY 17 RISERS AT +/- 7.28" = 123 3/4" TOTAL

FOR ADDITIONAL NOTES SEE GENERAL NOTES ON TITLE SHEET AND DETAILS.

RISE VERIFY

WINDOW HEAD HEIGHTS: IST FLOOR = 7'-0" U.N.O. ON ELEVATIONS. 2ND FLOOR = 7'-0" U.N.O. ON ELEVATIONS.

ALL DIMENSIONS TO WINDOWS AND DOORS ARE TO CENTERLINE.

WALL LEGEND:

FULL HEIGHT 2X4 WOOD STUD PARTITION

BRICK / STONE VENEER

FULL HEIGHT 2X6 WOOD STUD PARTITION

STUD WALL BELOW HEIGHT AND STUD SIZE AS NOTED

LOW GYPSUM BOARD WALL HEIGHT AND STUD SIZE AS NOTED

DRYWALL OPENING. HEIGHT AS NOTED ON PLAN.

KEY NOTES:

FIRE PROTECTION:

HOUSE TO GARAGE FIRE SEPARATION. GARAGE/HOUSE SEPARATION AT VERTICAL SURFACES SHALL BE PROTECTED

WITH ONE (I) LAYER I/2" GYPSUM BOARD. (PER LOCAL CODES) GARAGE/HOUSE SEPARATION AT HORIZONTIAL SURFACES SHALL BE PROTECTED WITH ONE (I) LAYER 5/8" TYPE 'X' GYPSUM BOARD. (PER LOCAL CODES)

HOUSE TO GARAGE DOOR SEPARATION. PROVIDE I-3/8" SOLID CORE DOOR OR APPROVED 20 MINUTE RATED DOOR. (PER LOCAL CODES)

BENEATH STAIRS AND LANDINGS. I/2" GYPSUM BOARD ON WALLS AND CEILING OF ENCLOSED ACCESSIBLE AREAS. (PER LOCAL CODES)

MEP'S

4 GAS WATER HEATER ON 18" HIGH PLATFORM. (PER LOCAL CODES)

5 FAU 8'X8' PLATFORM. VERIFY WITH TRUSS MANUFACTURER. (6'-6" MIN. CLEAR HEIGHT TO HORIZONTAL MEMBERS, 2"X6" OVER 2"X4" BOTTOM CHORD. OF TRUSS, VERIFY W/ TRUSSES.)

6 A/C CONDENSER PAD. (VERIFY)

7 PRE-FABRICATED METAL FIREPLACE. INSTALL PER MANUFACTURER'S WRITTEN INSTRUCTIONS.

8 ATTIC ACCESS LARGE ENOUGH TO REMOVE LARGEST PIECE

OF EQUIPMENT BUT NOT LESS THAN 30"x22". FIRE RATED ACCESS AS NOTED. (PER LOCAL CODES) ATTIC ACCESS LADDER, VERIFY LOCATION AND SIZE WITH TRUSSES. (25 I/2" X 54" SIZE.) TYPICALS:

1 TEMPERED SAFETY GLASS. (PER LOCAL CODES)

PLYWOOD SHELF ABOVE WITH DRYWALL FINISH OVER. HEIGHT AS NOTED.

III HALF WALL, HEIGHT AS NOTED.

12 INTERIOR SOFFITS: FFL = 7'-6" U.N.O. SFL = 7'-6" U.N.O. BATHS:

13 SHOWER. TEMPERED GLASS ENCLOSURE.

14 TUB-SHOWER COMBO. TEMPERED GLASS ENCLOSURE.

15 CERAMIC TILE SHOWER AND FLOOR. TEMPERED GLASS ENCLOSURE.


6 ACRYLIC TUB W/ CERAMIC PLATFORM


KITCHEN:

[1] 30" SLIDE-IN ELECTRICAL RANGE W HOOD AND MICRO ABV. VENT PER MANUFACTURER'S WRITTEN INSTRUCTIONS.

18 30" GAS COOKTOP AND HOOD. VENT PER MANUFACTURER'S WRITTEN INSTRUCTIONS.

19 ELECTRIC OVEN WITH MICROWAVE OVEN.

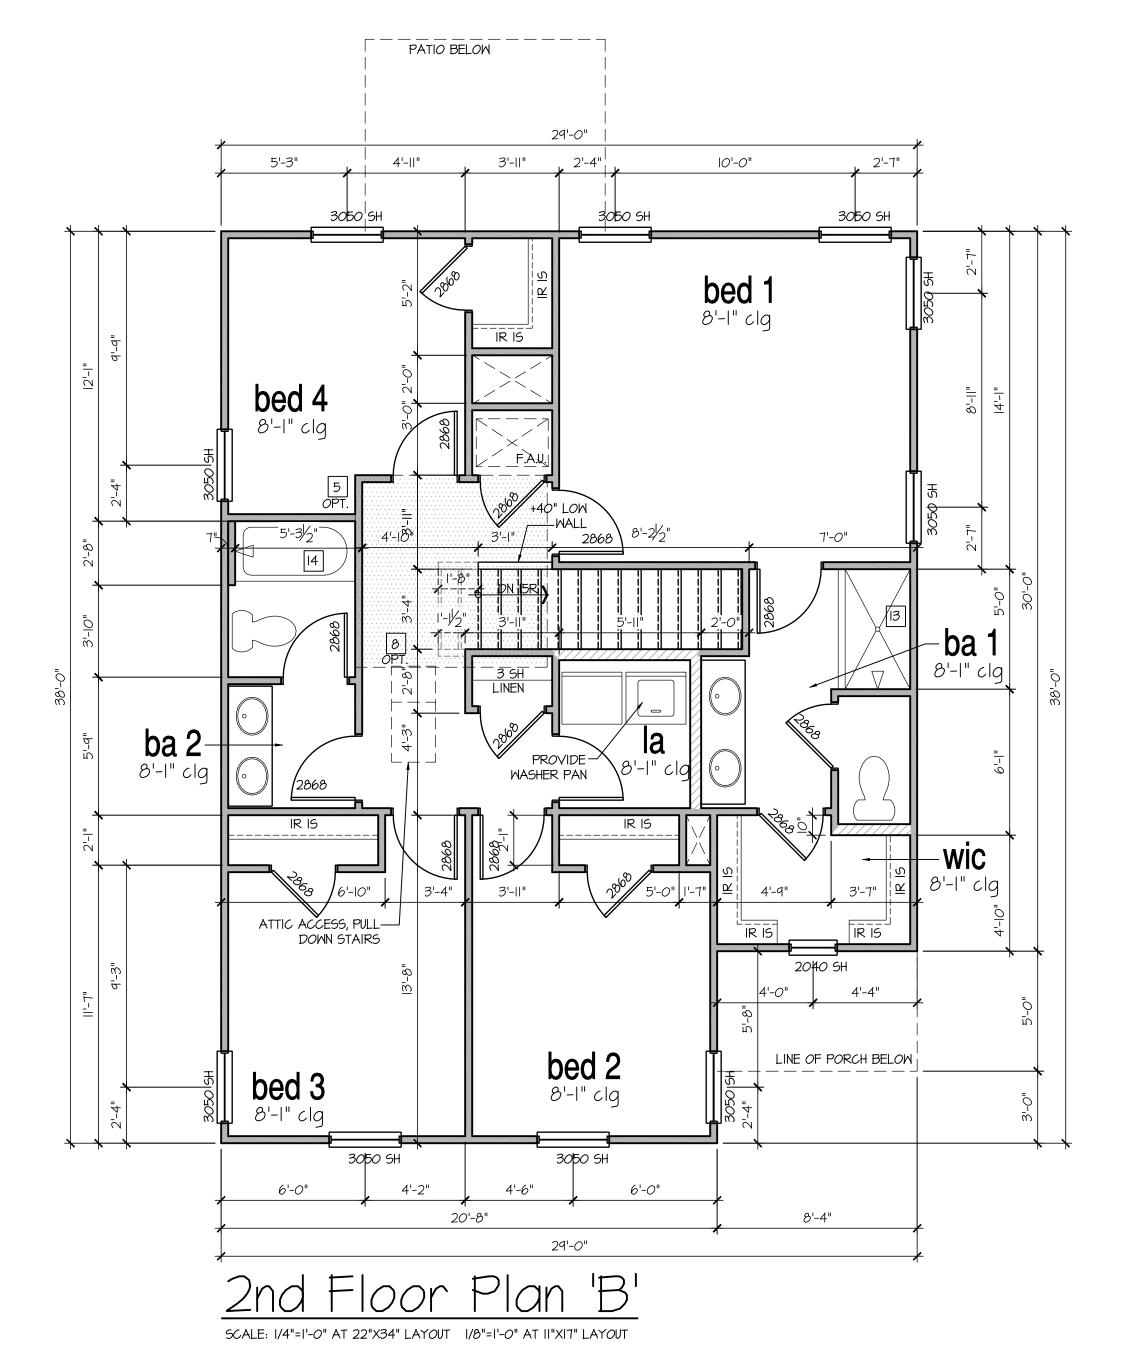

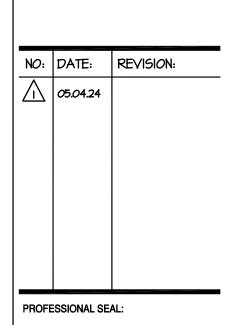

PROJECT TITLE:

30' Series

FOR CONSTRUCTION

CLIENTS NAME:



PROJECT NO: GMD14065

SHEET TITLE: 'TAYLOR' 2nd FLOOR PLAN '3EFF-B'

PRINT DATE:

May 02, 2024

5 B